

TACO BELL

1551 West River Rd. Elyria, OH

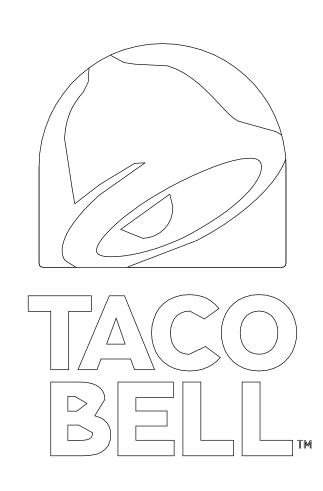


- A. ALL WORK SHALL CONFORM TO THE 2017 EDITION OF THE OHIO BUILDING CODE, AND ALL OTHER APPLICABLE CODES STANDARDS, AND REGULATIONS OF THE CITY OF ELYRIA AND COUNTY OF LORAIN
- B. IT IS INTENDED THAT A COMPLETE OCCUPIABLE BUILDING PROJECT IS PROVIDED.
- C. THE GENERAL CONDITIONS OF THE CONTRACT FOR CONSTRUCTION (A.I.A. A201 LATEST EDITION) ARE A PART OF THESE CONTRACT DOCUMENTS. A COPY IS ON FILE AT THE ARCHITECT'S OFFICE.
- D. DRAWINGS ARE BASED ON A SURVEY, DATED 04.13.22 PREPARED BY GPD GROUP AND IS INCLUDED IN THESE
- THIS BUILDING HAS BEEN DESIGNED IN ACCORDANCE WITH THE RECOMMENDATIONS OF A GEOTECHNICAL INVESTIGATION DATED MARCH 25, 2022 AND REVISED MARCH 29, 2022 BY INTERTEK-PSI. THE REPORT IS PART OF THESE CONTRACT DOCUMENTS, AND THE CONTRACTOR IS RESPONSIBLE FOR CARRYING OUT ITS RECOMMENDATIONS. THOUGH SOME MAY NOT BE SPECIFICALLY DETAILED ON THE PLANS.
- DO NOT SCALE THESE DRAWINGS. VERIFY ALL DIMENSIONS AND CONDITIONS IN THE FIELD. ANY DISCREPANCIES IN THESE DRAWINGS SHALL BE BROUGHT TO THE ATTENTION OF THE ARCHITECT PRIOR TO STARTING WORK.
- G. ALL PROPOSED SUBSTITUTIONS SHALL BE APPROVED BY THE TACO BELL CORPORATE BRAND DESIGNER OR CONSTRUCTION MANAGER, IN WRITING, PRIOR TO INSTALLATION.
- H. RETAIN THE PROJECT GEOTECHNICAL ENGINEER TO PROVIDE OBSERVATION AND TESTING SERVICES DURING THE GRADING (INCLUDING UTILITY TRENCHES) AND FOUNDATION PHASE OF CONSTRUCTION AS RECOMMENDED IN THE GEOTECHNICAL REPORT. ALL TESTING AND INSPECTION REPORTS, INCLUDING FINAL SUMMATION LETTER, SHALL BE SUBMITTED TO THE BUILDING DEPARTMENT AND OWNER. G.C. SHALL CERTIFY PAD ELEVATION PRIOR TO START OF FOUNDATION WORK.
- SUBMIT, PAY FEES AND OBTAIN ALL PERMITS ASSOCIATED WITH THE PROJECT EXCEPT GENERAL BUILDING PERMIT. THIS INCLUDES, BUT IS NOT LIMITED TO ELECTRICAL, MECHANICAL, PLUMBING, FIRE SPRINKLER, HOOD ANSUL, OR OTHER RELATED FIRE PERMITS, ENCROACHMENT PERMIT, ETC. YUM BRANDS WILL PAY FOR "CONNECTION FEES" ASSOCIATED WITH UTILITY PERMITS. PAY FOR TEMPORARY FACILITIES FEES AS REQUIRED TO COMPLETE THE WORK IN A TIMELY MANNER.
- PROVIDE EACH SUBCONTRACTOR WITH A COMPLETE AGENCY-PERMITTED DRAWING SET AT TIME OF CONSTRUCTION.
- K. ALL ABBREVIATIONS INCLUDED FOLLOW INDUSTRY STANDARDS. CONTACT ARCHITECT IF ANY ABBREVIATIONS ARE NOT
- GC SHALL SUPPLY AND INSTALL ALL ASPECTS OF THE PROJECT DESCRIBED IN THIS DRAWING SET UNLESS OTHERWISE NOTED. SEE SCOPE OF WORK FOR EXCEPTIONS.
- M. GRAPHIC AND WRITTEN INFORMATION ON DRAWINGS SHALL BE COORDINATED WITH ALL TRADES PRIOR TO
- ALL MATERIALS STAGED TO BE USED FOR CONSTRUCTION SHALL BE PROTECTED FROM EXCESSIVE MOISTURE. IF THEY ARE EXPOSED TO MOISTURE THEY SHOULD BE ADEQUATELY DRIED AND INSPECTED FOR COMPLIANCEWITH MINIMUM QUALITY STANDARDS BEFORE ENCAPSULATED INTO THE BUILDING.
- O. ALL PAINTS, ADHESIVES, COATINGS AND SEALANTS USED INSIDE THE BUILDING SHALL HAVE A LOW VOC CONTENT.

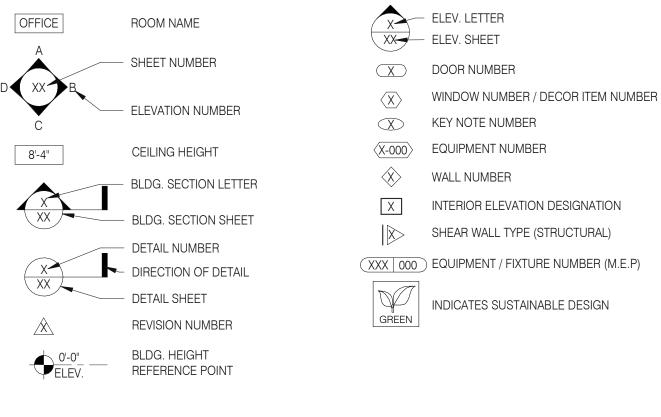

REFER TO STRUCTURAL, MECHANICAL, PLUMBING AND ELECTRICAL SHEETS FOR SPECIFIC SYMBOLS

GENERAL DRAWING SYMBOLS

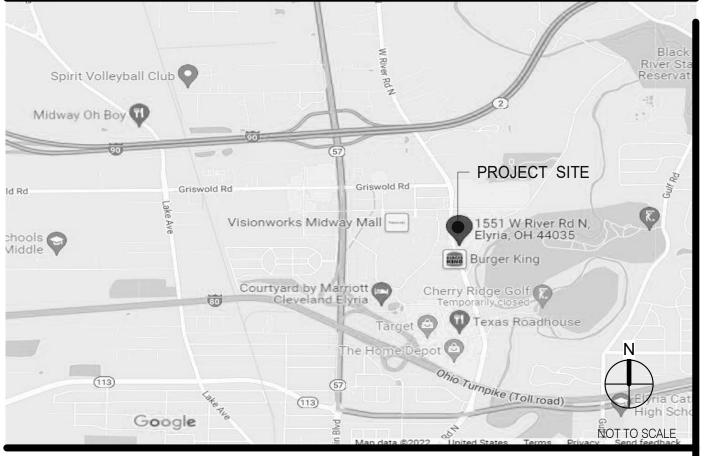

VICINITY MAP

MECHANICAL:	2017 OHIO MECHANICAL CODE	1/1/2			_,,
PLUMBING:	2017 OHIO PLUMBING CODE			. TITLI	E/GEN. CONDITIONS
ELECTRICAL: FIRE:	2017 NATIONAL ELECTRIC CODE 2017 OHIO FIRE CODE			T1.0	TITLE SHEET
ENERGY:	2015 INTERNATIONAL ENERGY CONSE	RVATION CODE		G1.0	GREEN CHECKLIST SHEET
				G2.0	TRASH ENCLOSURE DETAILS
DI III DINIO ADEA	0.007.0.5.000.00			G3.0	PEST PREVENTION GUIDE
BUILDING AREA: SEATING:	2,287 S.F. GROSS 20 INTERIOR, 10 EXTERIOR			G4.0	LIFE SAFETY PLAN
OCCUPANCY:	A2			G4.1	SIGNAGE DETAILS
	N: TYPE VB - UNPROTECTED			TITLE/SI	TE SHEET COUNT: 6
<u>TYPE</u>		<u>ACTOR</u>	<u>OCCUPANTS</u>	OTDI	IOTUDAL
DINING ROOM		15 S.F. (NET)	39	SIR	JCTURAL
QUEUING KITCHEN		5 S.F. (NET) 200 S.F. (GROS	12 SS) 6	S1.0	FOUNDATION PLAN
OFFICE		100 S.F. (GROS		S2.0	WALL FRAMING PLAN
ACCESSORY STORAG		300 S.F. (GROS		S3.0	ROOF FRAMING PLAN
ACCESSORY RESTRO	OOMS & PASSAGE 624 S.F. 0	(GROS	SS) 0	S4.0	STRUCTURAL DETAILS
TOTAL			50	S4.1	STRUCTURAL DETAILS
TOTAL			59	S4.2	STRUCTURAL DETAILS
	PROJECT S		ADV	S4.3	STRUCTURAL DETAILS
	PROJECT		ARI	S4.4	STRUCTURAL SECTIONS
				S4.5	CANOPY PLAN & DETAILS
				S5.0	CANOPY/AWNING BLOCKING ELEV
# PHONE LINES:	25 PAIR CABLE IN 2" CONDUIT			SIRUCI	URAL SHEET COUNT: 10
ELECTRIC SERVICE:	600 AMPS / 3 PHASE / 120-208 VOLT			CIVIL	
GAS:	819,000 BTUH			OIVIL	_
				SEE CIV	IL DRAWINGS FOR SHEET INDEX.
				ARC	HITECTURAL
				A1.0	FLOOR PLAN
				A1.0	DOOR & WINDOW ELEVATIONS & S
	DESIGN (PITE	ΣΙΔ	A1.1 A2.0	EQUIPMENT AND SEATING PLAN
	DESIGN		VIA.	A2.0 A2.1	EQUIPMENT AND SEATING PLAN
				A3.0	ROOF PLAN
				A3.0	EXTERIOR ELEVATIONS
				A4.0 A4.1	EXTERIOR ELEVATIONS
CLIDDENIT ZONINIC D	2 COMMUNITY DURINESS DISTRICT	_		A5.0	BUILDING SECTIONS
CURRENT ZONING B-	-2, COMMUNITY BUSINESS DISTRICT	_	FOR TACO BELL	A5.0 A5.1	BUILDING SECTIONS BUILDING SECTIONS
			USE/APPROVAL ONLY		WALL SECTIONS
		_		A5.2 A5.3	WALL SECTIONS WALL SECTIONS
			BUILDING S.F.: 2,287 S.F.	A5.3 A5.4	WALL SECTIONS WALL SECTIONS
		_	SITE SIZE: 33,467 S.F.	A6.0	CONSTRUCTION DETAILS ROOF
		_	PARKING COUNT: 36	A6.0 A6.1	CONSTRUCTION DETAILS ROOF CONSTRUCTION DETAILS DOOR/W
			INT. SEATING: 20	A6.1 A6.2	CONSTRUCTION DETAILS DOOR/W
		_	EXT. SEATING: 10 KIOSK COUNT: 4	A6.3	FINISH DETAILS
		_	D.M.B.: YES	A6.4	CONSTRUCTION DETAILS INTERIO
			DT DMP: YES	A6.5	CEILING DETAILS
		_	DT DPB: YES	A6.6	HARDIE BOARD DETAILS
REFER TO CIVIL DRAY	WINGS.	_		A7.0	FLOOR FINISH PLAN
				A7.0	REFLECTED CEILING PLAN
				A7.1	FINISH SCHEDULE
				A7.2 A8.0	INTERIOR ELEVATIONS DINING RO
	LEGAL DES	CRIP	ΓΙΟΝ	A8.1	INTERIOR ELEV. ENLARGED REST
			11014	A8.2	INTERIOR ELEVATIONS KITCHEN
				A8.3	INTERIOR ELEVATIONS KITCHEN
OWNED		I ABOU	UTEAT	A9.0	PATIO DETAILS
OWNER		ARCH	IITECT		CTURAL SHEET COUNT: 27
YUM! BRANDS, INC		GPD GROU		AROTHE	OTOTAL OTILLY GOOTT. 27
1900 COLONEL SAN			N STREET, SUITE 2531	4.00	
LOUISVILLE, KY 402 CONTACT: STEVE F		AKRON, OH	1 44311 JOSHUA GRABER	ACC	ESSIBILITY
PHONE: 949.863.386		PHONE: 33		ADA1.0	ACCESSIBILITY REQUIREMENTS
	<u> </u>			ADA1.1	ACCESSIBILITY REQUIREMENTS
CONSTRU	JCTION MANAGER	SIRU	CTURAL ENGINEER	ACCESS	IBILITY SHEET COUNT: 2
YUM! BRANDS, INC		GPD GROU			
1900 COLONEL SAN			N STREET, SUITE 2531	MEC	HANICAL
LOUISVILLE, KY 402 CONTACT: STEVE F		AKRON, OH	1 44311 JOSHUA GRABER	M1.0	MECHANICAL SCHEDULES AND NO
PHONE: 949.863.386		PHONE: 33		M2.0	DUCT AND DIFFUSER PLAN
				M2.1	MECHANICAL ROOF PLAN
CIVIL ENG	SINEER	M/E/P	ENGINEER	M3.0	HOOD DETAILS AND SECTIONS
GPD GROUP		GPD GROU		M4.0	MECHANICAL DETAILS
520 S. MAIN STREE	T, SUITE 2531		N STREET, SUITE 2531	M5.0	CONTROLS DETAILS
AKRON, OH 44311		AKRON, OH		MECHAN	IICAL SHEET COUNT: 6
CONTACT: JOSHUA		CONTACT:	JOSHUA GRABER 0.572.2100	PILIN	ИBING
PHONE: 330.572.210		I HONE. 33	U.U1 E.E I UU		
GEOTECH	INICAL ENGINEER			P1.0	PLUMBING SCHEDULES AND NOTE
	ERVICE INDUSTRIES, INC.			P2.0	WASTE AND CAS PLAN
5555 CANAL RD.	,	1		P3.0	WATER AND GAS PLAN
CLEVELAND, OH 44		1		P4.0	PLUMBING ROUGH-IN PLAN
CONTACT: ZAINEDI		1		P5.0	RISER DIAGRAMS
CONTACT: 216.447.	.1335			P6.0	PLUMBING DETAILS
					IG SHEET COUNT: 6
	PROJECT D	ハベトじし	UKY	FIF(CTRICAL
					SITE ELECTRICAL DI ANI

SEWER CITY OF ELYRIA ENGINEERING 131 COURT ST., SUITE 303 ELYRIA, OH 44035 CONTACT: JOHN SCHNEIDER EMAIL: JSCHNEIDER@CITYOFELYRIA.ORG	TELEPHONE AT&T CONTACT: CUSTOMER SERVICE
WATER CITY OF ELYRIA ENGINEERING 131 COURT ST., SUITE 303 ELYRIA, OH 44035 CONTACT: JOHN SCHNEIDER EMAIL: JSCHNEIDER@CITYOFELYRIA.ORG	
GAS COLUMBIA GAS 780 FRY RD. MIDDLEBURG HTS, OH 44130 CONTACT: BRIAN TOMCHO PHONE: 440.610.9503	
ELECTRIC OHIO EDISON CONTACT: DOUG LINN EMAIL: LINNDM@FIRSTENERGYCORP.COM	

E3.0 E3.2 E4.0 E6.0 E6.1 E8.0 **ELECTRICAL SHEET COUNT: 14**

SPECIFICATIONS

UTILITY CONTACTS

SHEET ISSUED ON DATE INDICATED, NO MODIFICATIONS 520 S. MAIN STREET, SUIT 2531 AKRON, OH 44311 330.572.2100 FAX: 330.572.2102 CONSTRUCTION DETAILS DOOR/WINDOW INTERIOR ELEVATIONS DINING ROOM INTERIOR ELEV. ENLARGED RESTROOMS & OFFICE PLAN MECHANICAL SCHEDULES AND NOTES CONTRACT DATE: SITE NUMBER: PA/PM: DRAWN BY. ELECTRICAL ONE LINE DIAGRAMS AND LEGEND ENLARGED POWER PLAN AND DETAILS INSTALLATION START-UP PRE-COMM CHECK LIST SW2.1 BALANCING AND COMISSIONING SEQUENCE SHEET INDEX PLOT DATE: 8/9/2022 12:49:02 PM

GPD GROUP

CAUTION: IF THIS SHEET IS NOT 22"x34" IT IS A REDUCED PRINT

07.26.22 NTP 08.09.22 IFB

04.13.22 **BUILDING TYPE:** END. 80FT PLAN VERSION: MARCH 2021 **BRAND DESIGNER:** DICKSON 315672 STORE NUMBER: 455386

TACO BELL

2021088.52

1551 West River Rd. Elyria, OH



ENDEAVOR 2.0 TITLE SHEET

PROJECT GENERAL NOTES

SHEET ISSUED ON DATE INDICATED, WITH MODIFICATIONS

STRUCTURAL SECTIONS CANOPY PLAN & DETAILS CANOPY/AWNING BLOCKING ELEVATIONS TRUCTURAL SHEET COUNT: 10

PLUMBING SCHEDULES AND NOTES

E2.2

SITE ELECTRICAL PLAN

ELECTRICAL SCHEDULES

ELECTRICAL SCHEDULES

ELECTRICAL POWER PLAN

ELECTRICAL POWER ROOF PLAN

LIGHTING PLAN AND DETAILS

ELECTRICAL DETAILS - TBCCB

ELECTRICAL DETAILS - TBCCB

COMMUNICATIONS PLAN

ELECTRICAL DETAILS ELECTRICAL DETAILS

PHOTOMETRIC PLAN

SCOPE OF WORK

SCOPE OF WORK SHEET COUNT: 5

IN BOOK FORMAT

ARCHITECTURAL DOOR & WINDOW ELEVATIONS & SCHEDULES EQUIPMENT AND SEATING PLAN **EQUIPMENT SCHEDULE**

LEGAL JURISDICTION: BUILDING AND LAND DEPARTMENT, CITY OF ELYRIA

TELEBUIONE

CHECK LIST NUMBER EXPLANATION:

THE CHECKLIST NUMBERS BELOW ALIGN WITH THE CREDIT NUMBERS IN THE YUM BLUELINE SYSTEM WEBSITE. FOR FURTHER DETAIL GO TO THE FOLLOWING WEB ADDRESS. NOTE: FOLLOW THE "REQUIRED" AND "OPTIONAL" DESIGNATION ON THIS SHEET RATHER THAN THE ONES ON THE YUMBLUELINE WEBSITE. THE SYSTEM HAS BEEN SETUP SO THAT IF YOU DO THE "REQUIRED" ITEMS ON THIS LIST YOUR RESTAURANT WILL MEET THE YUMBLUELINE REQUIREMENTS.

GO TO THE REFERENCE VERSION OF THE YUM BLUELINE WEBSITEAT: "WWW.YUMBLUELINE.COM"
 IN THE "USER" SECTION CHOOSE "GENERAL" FROM THE PULL DOWN MENU
 IN THE "PASSWORD" SECTION TYPE IN "J212J*KLA!"

1		CHON	· ING				CTION ME	D _ INDICATES THAT SOOR	PE IS ALREADY IN THE PROTOTYPE DRAWINGS		1		rio rd and	P = INDICATES THAT SCOPE IS ALREADY IN THE PROTOTYPE DRAWINGS
SERVITY	4 CHSTR	JC. M		્ર	ALL CICK	CONSTR	S. MEJOH	* = INDICATES OPTIONAL		_ c	SIBILITY OF SI	314 ONE TRU	· WHEIOLE	* = INDICATES OPTIONAL ITEMS
the the	COL	COM		- FERS	Offiz.	COL	-30m.			- EN	SIBIL DESI	, 00, 0	1 Op,	
		1										$\langle \rangle \langle \rangle$	7	
			ORMALDEHYDE LIMITS IAXIMUM FORMALDEHYDE EMISSIONS IN PARTS PER MILLION		Р				ROOM, KITCHEN AND SITE. RECYCLING SHOULD *	·			1.3 CONTAMINATED SITES (OPTION IF YOU ARE DEVELOPING A SITE	NAL) E SUCH AS A GAS STATION THAT REQUIRES REMEDIAL WORK CHECK THIS BOX.
			RODUCT CURRENT LIMIT				ACCOMMODATE PLASTIC, PA B. SEE THE "TRASH ENCLOS "LARGE" VERSION SHOULD B	URE STANDARDS" POSTED ON 1	THE PLANS.YUM.COM. UNLESS APPROVED THE				1.4 LOCATION COMMITMENT (REC	OUIRED) LOCATION FOR 10 YEARS OR MORE.
		•	HARDWOOD PLYWOOD VENEER CORE 0.05 HARDWOOD COMPOSITE CORE 0.05			- $ $ $ $	37.2 COOKING OIL RECYCLING (REC	UIRED)					1.5 PAY UTILITIES DIRECTLY (REQU	JIRED)
		•	PARTICLE BOARD 0.09 MEDIUM DENSITY FIBER BOARD 0.11 THIN MEDIUM DENSITY FIBERBOARD 0.13			_ _	COLLECT COOKING OIL AND PROVIDE 37.3 CARDBOARD RECYCLING (OPTI-		OR RECYCLING.				WILL ALLOW TACO BELL TO TRA	TACO BELL WILL PAY THE UTILITIES DIRECTLY RATHER THAN ALLOWING THE LANDLORD TO PAY THEM. THIS ACK UTILITY EXPENSES EASILY.
		1.	\star . VALUES IN THIS TABLE ARE DERIVED FROM THOSE SPECIFIED BY THE CALIFORNIA AIR RESOURCES BOARD, AIR		L	_ L	COLLECT USED CORRUGATED CARD		RD PARTY VENDOR FOR RECYCLING.	k .			2.2 PROXIMITY TO BUS STOP (OPT SITE IS WITHIN 1/4 A MILE OF A	
		2.	TOXIC CONTROL MEASURE FOR COMPOSITE WOOD AS TESTED IN ACCORDANCE WITH ASTM E 1333. THIN MEDIUM DENSITY FIBERBOARD HAS A MAXIMUM THICKNESS OF 5/15"				38. AIR VENTILATION (REQUIRED) 1. PROVIDE AIR VENTILATION 2. PROVIDE FRESH AIR PER	I AND EXHAUST RATES PER YUN YUM BI UELINE	M BLUELINE.		Р		3.0 BICYCLE FACILITIES (REQUIRE) PROVIDE DEDICATED BICYCLE I	D) LOCKABLE PARKING FOR A MINIMUM OF TWO BICYCLES. PROVIDE CHANGING AREA AND LOCKABLE
			OC CONTENT LIMITS FOR ARCHITECTURAL COATINGS (CONT.) RAMS OF VOC PER LITER OF COATING, LESS WATER & LESS EXEMPT COMPOUNDS		_	_	39.1 NO SMOKING (REQUIRED)						STORAGE FOR A MINIMUM OF 1	WO PEOPLE. SINGLE OCCUPANCY TOILET ROOMS WILL SUFFICE AS A CHANGING AREA.
		SF	PECIALTY COATINGS CURRENT VOC LIMIT		L	IJ	II.	OT SMOKING WITHIN THE RESTA IN 25 FEET OF THE RESTAURAN	*	* 			5.1 PARKING (OPTIONAL) DO NOT EXCEED PARKING SPA	CES REQUIRED BY LOCAL ZONING. SEE CREDIT 5. PROVIDE 5% PREFERRED PARKING FOR CARPOOL.
			ROOF COATINGS 50 RUST PREVENTATIVE COATINGS 250					PLAN WITH BID. START WITH TH	HE PROTOTYPE TEMPLATE AND MODIFY AS		Р		7.2 WHITE ROOF (REQUIRED) PROVIDE WHITE PVC SINGLE ME	EMBRANE ROOF MATERIAL.
		Ι.	SHELLACS CLEAR 730 OPAQUE 550				REQUIRED FOR SITE SPECIFIC COND A. PROTECT HVAC SYSTEM B. IMPLEMENT POLITION S	ITIONS. OURCE CONTROL MEASURES					9.0 CONSTRUCTION POLLUTION (A. CONSTRUCTION POLLUTION P	
		:	SPECIALTY PRIMERS, SEALERS & UNDER-COATINGS 100 STAINS 250				C. PROTECT STORED MATER D. PROTECT INSTALLED MAT	IALS ERIALS					B. SILT FENCING C. SITE VEHICULAR ACCES	
			STONE CONSOLIDANTS 450 TRAFFIC MARKING COATINGS 100 TUB & TILE REFINISH COATINGS 420				E. MAINTAIN CONSTRUCTION 42. LOW EMITTING MATERIALS (REQ						D. WHEEL WASHING E. COVERED LOADS F. EXCAVATED SOIL STORA	
			WATERPROOFING MEBRANES 250 WOOD COATINGS 275				FINISH MATERIALS SHALL CC	MPLY WITH THIS SECTION:	D CAULKS USED ON THE PROJECT SHALL MEET THE					RENCH AND PIT DRAIN PROTECTION
			WOOD PRESERVATIVES 350 ZINC-RICH PRIMERS 340				OR AIR QUALITY MANAGEMENT D	ISTRICT RULES APPLY:	E STRINGENT LOCAL OR REGIONAL AIR POLLUTION				I. DUST CONTROL J. EXPOSED SLOPE EROSIC	
		1. 2.	GRAMS OF VOC PER LITER OF LITER OF COATING, INCLUDING WATER & EXEMPT COMPOUNDS THE SPECIFIED LIMITS REMAIN IN EFFECT UNLESS REVISED LIMITS ARE LISTED IN SUBSEQUENT COLUMNS IN THE				SHALL COMPLY WITH LO		RIMERS, SEALANTS, SEALANT PRIMERS AND CAULKS ON CONTROL OR AIR QUALITY MANAGEMENT 1168 VOC LIMITS.				K. WEEKLY CONTRACTOR II 10.2 BUILDING WATER (REQUIRED	
		3.	TABLE. VALUES IN THIS TABLE ARE DERIVED FROM THOSE SPECIFIED BY THE CALIFORNIA AREI RESOURCE BOARD,						HESIVES, AND SEALANT OR CAULKING COMPOUNDS				PROVIDE PLUMBING FIXTURES	AS SPECIFIED IN THE PROTOTYPE DRAWINGS, SPECIFICATIONS AND EQUIPMENT MODEL.
			ARCHITECTURAL COATINGS SUGGESTED CONTROL MEASURE, FEB 1, 2008. MORE INFORMATION IS AVAILABLE FROM THE AIR RESOURCES BOARD.				,	LESS PACKAGING, WHICH DO NO 16 FLUID OUNCES) SHALL COM	OT WEIGH MORE THAN 1 POUND AND DO NOT MPLY WITH SCAQMD.		Р		11.2 PROCESS WATER (REQUIRED) ALL WATER USING EQUIPMENT	SPECIFIED IN THE PROTOTYPE EQUIPMENT SCHEDULE SHALL BE USED FOR ALL GROUND-UP RESTAURANTS.
			COATING CATEGORY CURRENT VOC LIMIT						GS SHALL COMPLY WITH VOC LIMITS IN SCAQMD.				I I	ED) NEW GROUND-UP RESTAURANTS SHALL FOLLOW THE LANDSCAPE STANDARDS POSTED ON THE
		•	FLAT COATINGS 50 NON-FLAT COATINGS 100 NON-FLAT HIGH GLOSS COATINGS 150						TINGS SHALL MEET SCAQMD REQUIREMENTS. DOCUMENTATION TO THE CM. DOCUMENTATION				PLANS.YUM.COM WEBSITE.	D) SEE LANDSCAPE SPECIFICATIONS
			SPECIALTY COATINGS CURRENT VOC LIMIT				SHALL INCLUDE, BUT IS NOT LIMI 1. MANUFACTURER'S PROD	TED TO, THE FOLLOWING: UCT SPECIFICATION.					A. PROGRAMMABLE IRRIGA B. SEPARATE IRRIGATION Z	ATION CONTROLLER. CONES
			ALUMINUM ROOF COATINGS 400 BASEMENT SPECIALTY COATINGS 400				2. FIELD VERIFICATION OF C	N-SITE PRODUCT CONTAINERS	S.				C. PROGRAM MAXIMUM IRF D. HIGH-EFFICIANCY IRRIG, E. RAIN SENSOR	
		•	BITUMINOUS ROOF COATINGS 50 BITUMINOUS ROOF COATINGS PRIMER 350				ARCHITECTURAL ADHEASIVE AP	PLICATIONS	CURRENT VOC LIMIT				15.3 INTERIOR LIGHTING (REQUIRE	
			BOND BREAKER 350 CONCRETE CURING COMPOUNDS 350 CONCRETE / MASONRY SEALERS 100				CERAMIC TILE DRYWALL, PANEL & COVE BASE		65 50				THE CURRENT LIGHTING SPECI 16.2 EXTERIOR LIGHTING (REQUIRE	FICATIONS SHALL BE USED FOR ALL GROUND-UP PROTOTYPE RESTAURANTS.
		•	DRIVEWAY SEALERS 50 DRY FOG COATINGS 150				MULTI-PURPOSE SINGLE PLY ROOFING		70 250		Р			FICATIONS SHALL BE USED FOR ALL GROUND-UP PROTOTYPE RESTAURANTS.
		•	FIRE RESISTIVE COATINGS 350 FLOOR COATINGS 100 FORM-RELEASE COMPOUNDS 250				SPECIALTY APPLICATIONS		CURRENT VOC LIMIT		Р		17.2 SIGN ILLUMINATION (REQUIRE THE CURRENT SIGNAGE SPECIF	ED) FICATIONS SHALL BE USED FOR ALL GROUND-UP PROTOTYPE RESTAURANTS.
		•	HIGH TEMPERATURE COATINGS 420 INDUSTRIAL MAINTENANCE COATINGS 250				PVC WELDING CPVC WELDING		510 490		Р		18.1 EXHAUST HOODS (REQUIRED) THE CURRENT 6'-3" BACK SHELI	F HOOD DESIGN AND EQUIPMENT PLACEMENT AS SHOWN IN THE GROUND-UP PROTOTYPE
		•	LOW SOLIDS COATINGS 120 MAGNESITE CONCRETE COATINGS 450				 ABS WELDING PLASTIC CEMENT WELDING ADHESIVE PRIMER FOR WELDING 		325 250				RESTAURANT SHALL BE USED.	DECLUDED
			MASTIC TEXTURE COATINGS 100 PRETREATMENT WASH PRIMER 350 PRIMERS, SEALERS AND UNDERCOATS 100				 ADHESIVE PRIMER FOR WELDING CONTACT ADHESIVE SPECIAL PURPOSE CONTACT ADI 		80 250		Р		19.1 LICENSED HVAC ENGINEER (F USE A LICENSED HVAC ENGINE	ER FOR SYSTEM SITE ADAPTATION.
<u> </u>	_	_ .	REACTIVE PENETRATING SEALERS 350				STRUCTURAL WOOD MEMBER AD TOP & TRIM ADHESIVE		140 250		P		19.2 OPTIMIZE HVAC DESIGN (REQ OPTIMIZE HVAC DESIGN SYSTEI	UIRED) M PER YUM BLUELINE STANDARDS
		43	3.1 CONTROLLED BUILDING MATERIAL (REQUIRED) A. IF FLUORESCENT LAMPS ARE USED THEY SHALL NOT EXCEED 80 PICOGRAMS PER LUMEN HOUR. B. MAINTAIN THE TACO BELL LAMPS POLICY OF ONLY USING LED LAMPS IN ALL BUILDING, SITE AND SIGN				SUBSTRATE SPECIFIC APPLICAT	ONS	CURRENT VOC LIMIT				20.0 HVAC EFFICIENCY (REQUIRED USE THE STANDARD HIGH EFFI) CENCY (MINIMUM EER 12.0) RTU AS SPECIFIED AND INSTALL PER THE CURRENT PROTOTYPE GROUND UP
			LIGHTING.				METAL TO METAL PLASTIC FOAMS DOROUG MATERIAL & (EXCEPT MG)) (100)	30 50				RESTAURANT.	
			5.1 THERMAL COMFORT (REQUIRED) ISURE THAT THE HVAC SYSTEM PROVIDES THE FOLLOWING COMFORT CONDITIONS, ON AVERAGE:				POROUS MATERIALS (EXCEPT WOWOODFIBERGLASS	יטט)	30 80		P		21.0 ECONOMIZER PERFORMANCE USE A FACTORY PROVIDED ECC PROTOTYPE PLAN.	E (REQUIRED) DNOMIZER WITH DIFERENTIAL CONTROLS INTEGRAL TO AND COMPATIBLE WITH THE RTU'S SPECIFIED IN THE
			STORE OCCUPATION MODE TEMP SETPOINTS MAX RELATIVE HUMIDITY OCCUPIED DINING COOLING 72.78 F			- $ $ $ $ $ $	SEALANT VOC LIMITS	COMPOLINIDO IN ODAMO SES : "	ITED)		P		22.1. HOT WATER EFFICIENCY (REC	
			OCCUPIED DINING COOLING 73-78 F 60% KITCHEN COOLING 68-73 F DINING HEATING 68-73 F 60%		∟	 └-	(LESS WATER AND LESS EXEMPT SEALANT	COMPOUNDS IN GRAMS PER LÍ	CURRENT LIMIT				23.1 REFRIGERANTS (REQUIRED)	PECIFIED IN THE TACO BELL PROTOTYPE.
			KITCHEN HEATING 66-71 F				ARCHITECTURAL		250				DO NOT USED BANNED ŔEI	FRIGERANTS. IF YOU USE ANY MODERN RTU YOU WILL NOT USE BANNED REFRIGERANTS
			UNOCCUPIED COOLING (MINIMUM) 80 F OR OFF HEATING (MAXIMUM) 60 F				MARINE DECKNON-MEMBRANE ROOFROADWAY		760 300 250					CIFIED WALK-IN COOLER/FREEZER. SEE CREDIT 24 CIFIED REACH-IN FREEZER. SEE CREDIT 24
			6.1 THERMAL VERIFICATION (REQUIRED) A. AT THE 11 MONTH WARRANTEE THE CM SHALL ADMINISTER THE "THERMAL COMFORT VERIFICATION				SINGLE PLY ROOF MEMBRANE OTHER		450 420				C. USE THE CURRENT SPE	CIFIED ICE MAKERS. SEE CREDIT 24
			SURVEY" WITH A RESPONSE RATE OF 75% MINIMUM. B. IF 20% OR MORE OF THE RESPONDERS ARE DISSATISFIED THEN CORRECTIVE ACTIONS SHALL TAKE CORRECTIVE ACTION UNTIL LESS THAN 20% ARE DISSATISFIED.				SEALANT PRIMER		CURRENT LIMIT					MENT (REQUIRED) CIFIED FRYER IN THE PROTOTYPE. CIFIED 3-COMP SINKIN THE PROTOTYPE.
			CORRECTIVE ACTION ONTIL LESS THAN 20% ARE DISSATISFIED. C. IF CORRECTIVE ACTION IS REQUIRED GO BACK AND INSURE THAT THE STORE MEETS #28 THERMAL COMFORT STANDARDS.				ARCHITECTURAL NON-POROUS		250		Р		28.1 BASIC LIGHTING & THERMAL (CONTROLS (REQUIRED)
	$\neg \vdash$		8.1 LEED TEAM MEMBER (REQUIRED) ACH CONSULTANT SHALL HAVE A LEED AP MEMBER ON EACH PROJECTS SITE SPECIFIC TEAM.				PORUS MODIFIED BITUMINOUS MARINE DECK		775 500 760			└ 	B. PROVIDE TEMPERATURE	E THERMOSTATSSPECIFIED IN THE PROTOTYPE E SENSOR LOCATIONS AND SPECIFICATIONS ON PLAN TION OF VENTILATION EQUIMENT OPERATIONS
	_ <u>-</u>	_ ₄₉	9.1 COMMISSIONING (REQUIRED)				OTHER		75				D. PROVIDE LIGHTING CON	TION OF VENTILATION EQUIMENT OPERATIONS ITROLS FOR INTERIOR ZONES TROLS FOR EXTERIOR ZONES.
			OMMISSIONING REQUÌRES UNDÉRSTANDING THE OWNERS DESIGN INTENT PRIOR TO STARTING SITE SPECIFIC ESIGN SO THEY CAN INSURE THAT THEIR DESIGN MEETS WITH THE OWNER'S REQUIREMENTS. COMMISSIONING ALSO						*	·			28.3 OCCUPANCY SENSORS (OPTIO	DNAL)
			ALSO INTENDED TO INSURE THAT THE CONTRACTOR EXECUTES THE DESIGN PER THE OWNER'S REQUIREMENTS. A. THE CONSULTANT SHOULD MODIFY THE OWNER'S PROTOTYPE REQUIREMENTS WITH THE SITE SPECIFIC I								P		PROVIDE ULTRASONIC/INFAREL 33.1 RECYCLED CONTENT (REQUIR	O) OCCUPANCY SENSORS FOR 25% OR MOVE OF INTERIOR LIGHTING. RED)
			INFORMATION AND INSURE THAT THE SITE SPECIFIC DESIGN MEETS OR EXCEEDS THE OWNER'S REQUIREMENTS PRIOR TO STARTING DESIGN.										USE MATERIALS THAT HAVE A N	MINIMUM OF 10% RECYCLED MATERIALS. (NOTE: GETTING THE CALCULATIONS IN PROCESS)
			B. THE CONSULTANT, GENERAL CONTRACTOR AND CM SHOULD USE SHEET G1 AS THE CHECKLIST TO INSURE THE SITE SPECIFIC PROJECT RESULTS MEETS OR EXCEEDS THE OWNER'S REQUIREMENTS.										A. THE CONTRACTOR SHA BLUELINE. 75% IS PREFERF	LL RECYCLE A MINIMÚM OF 50% OF ALL CONSTRUCTION WASTE AND PROVIDE RECORDS PER YUM
													B. THE GENERAL CONTRA	CTOR SHALL PROVIDE A CONSTRUCTION WASTE MANAGEMENT PLAN TO THE CONSTRUCTION SUBMITTAL. THEY CAN USE THE STARTER FORM POSTED ON THE PLANS.YUM.COM WEBSITE

GPD GROUP

520 S. MAIN STREET, SUIT 2531 AKRON, OH 44311
330.572.2100 FAX: 330.572.2102
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05.06.22 Issued for Permit 07.26.22 NTP 08.09.22 IFB CONTRACT DATE: BUILDING TYPE: END. 80FT PLAN VERSION: MARCH 2021 BRAND DESIGNER: DICKSON 315672 SITE NUMBER: STORE NUMBER: 455386

TACO BELL

DRAWN BY.:


1551 West River Rd. Elyria, OH

2021088.52



ENDEAVOR 2.0 GREEN CHECKLIST SHEET

IN THE GREEN PLAYBOOK SECTION.

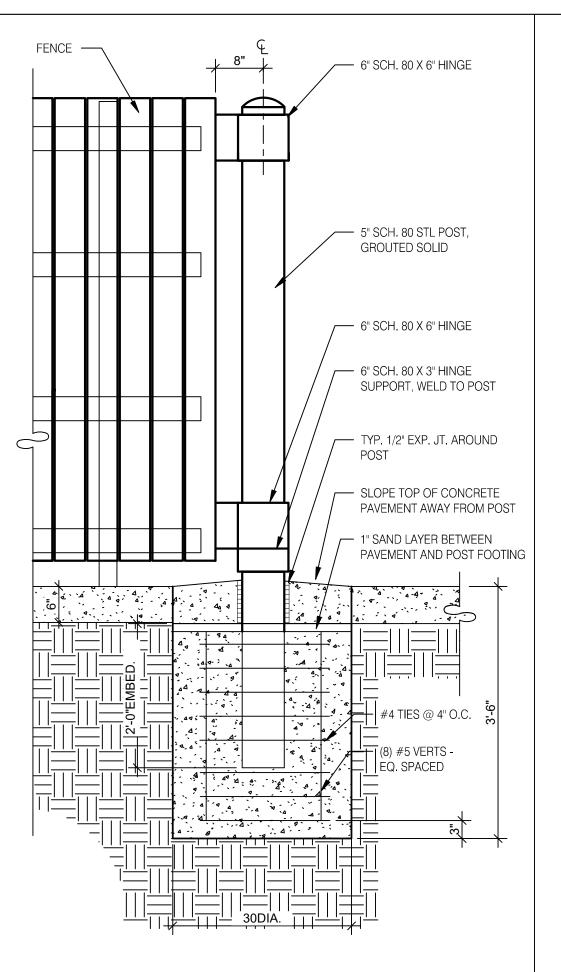

GATE POST FOOTING 3/4" = 1'-0" H

GATE HARDWARE: ALL HARDWARE AND ACCESSORIES SHALL BE HEAVY

GATE STOP: MUSHROOM TYPE OR FLUSH PLATE WITH ANCHORS SET IN


CONCRETE TO ENGAGE THE CENTER DROP ROD OR PLUNGER BAR.

GATE NOTES: (4) EQUAL WIDE x 6-0" HIGH MTL. GATES, TYPE 'B' 1 1/2"

GRIND SMOOTH ALL CONNECTIONS, TYP. PRIME AND PAINT ALL STEEL


DECKING, 22GA. W/ T.S. 1 X1 1875 BAR CROSS BRACING WELD AND


COMPONENTS.

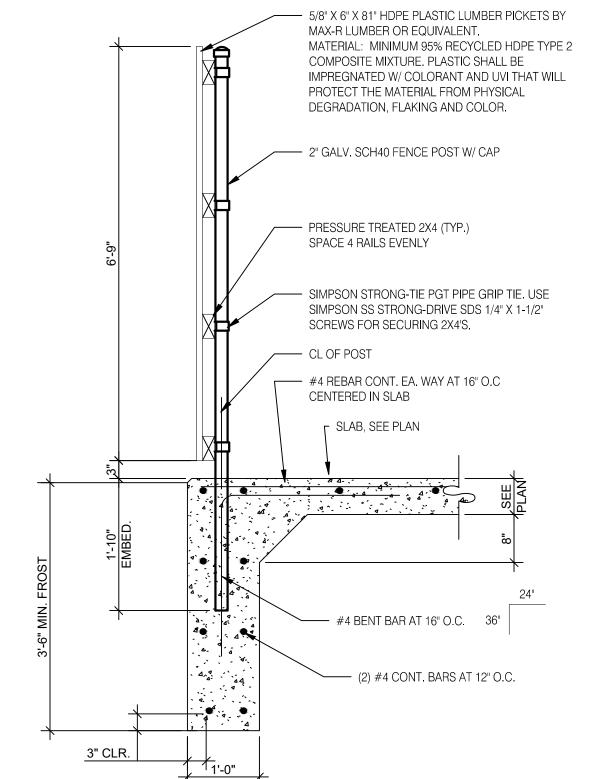

		FENCE SECTION 3/4" = 1'-0"						
SYMBOL	AREA	MANUFACTURER	COLOR					
1	GATE FRAME COLOR	SHERWIN WILLIAMS	SW 7055 ENDURING BRONZE					
2	PIPE BOLLARDS	SHERWIN WILLIAMS	CAUTION YELLOW					
3	HDPE LUMBER	MAX. R	LIGHT BROWN TEXTURE					

FRONT ELEVATION N.T.S.

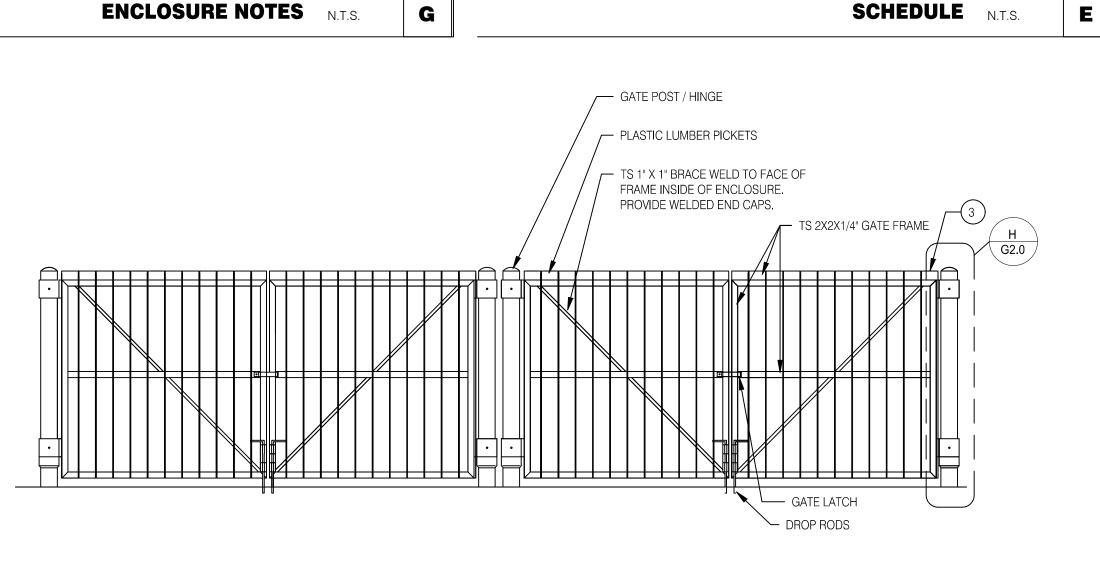


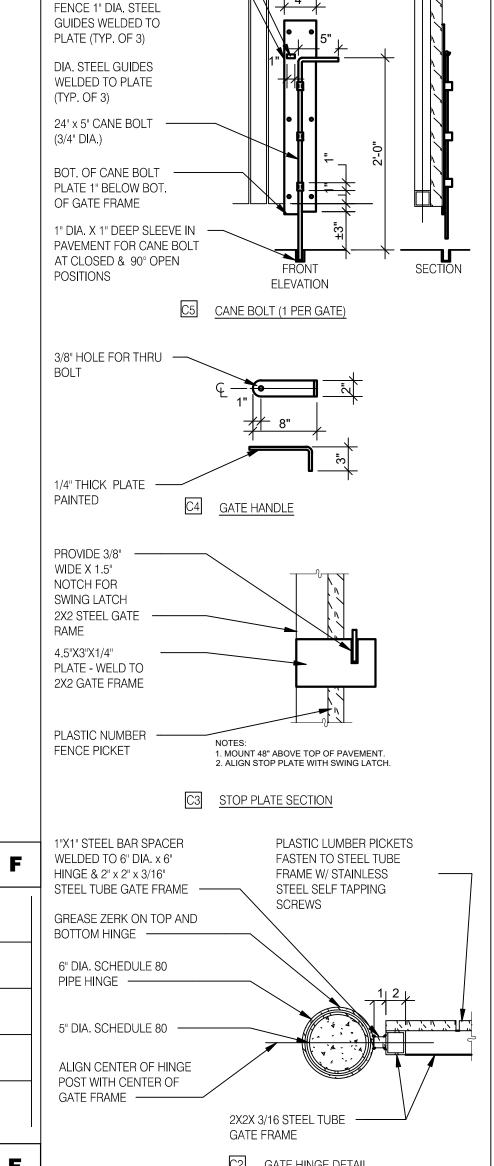

CANE BOLT


4" x 24" x 1/4" PLATE BOLTED TO FRAME &


REST

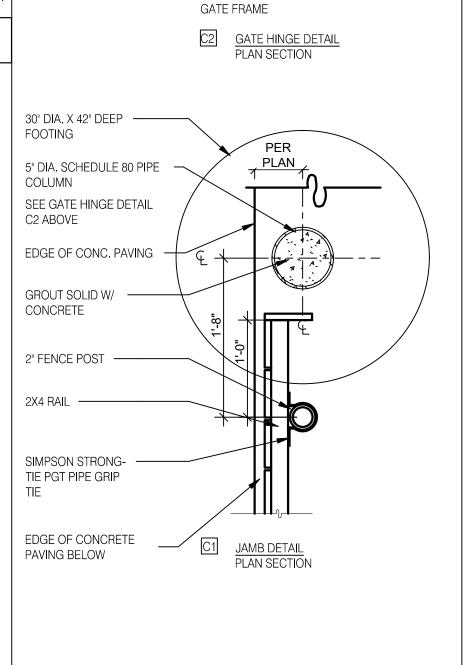


GATE DETAILS N.T.S.

C

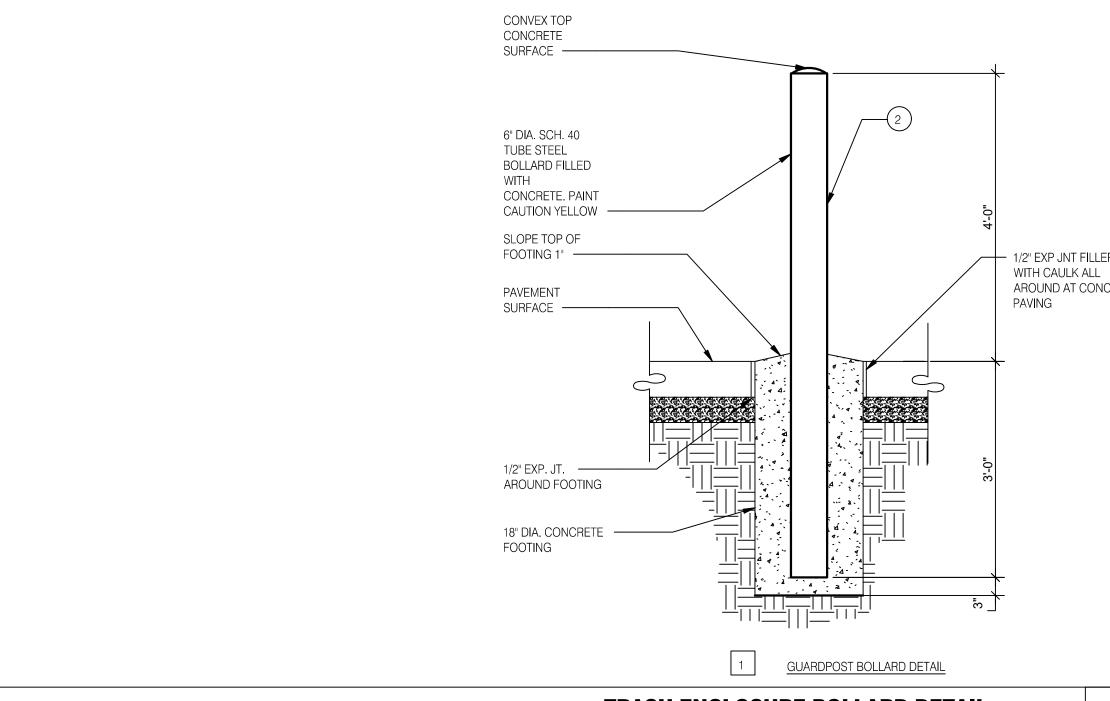

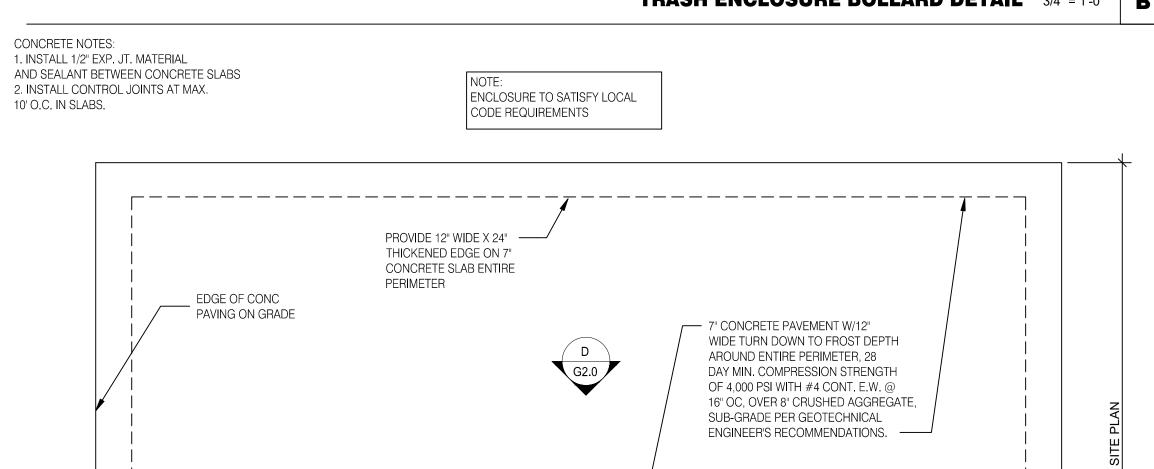

Copyright; Glaus, Pyle, Schomer, Burns & DeHaven, Inc. 2021 · 1/2" EXP JNT FILLER AROUND AT CONC TRASH ENCLOSURE BOLLARD DETAIL 3/4" = 1'-0"

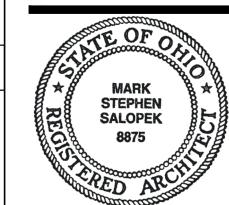

Akron, OH 44311

330.572.2100 Fax 330.572.2101

Mark S. Salopek License #8875 Expiration Date December 31, 2023

	DATE	REMARKS
CON	ITRACT DAT	E: 04.13.22

END. 80FT **BUILDING TYPE:** PLAN VERSION: MARCH 2021 **BRAND DESIGNER:** DICKSON SITE NUMBER: 315672 455386 STORE NUMBER PA/PM: DRAWN BY.

TACO BELL

2021088.52

JOB NO.:


1551 West River Rd. Elyria, OH



ENDEAVOR 2.0

TRASH ENCLOSURE DETAILS

TRASH LAYOUT 3/8" = 1'-0"

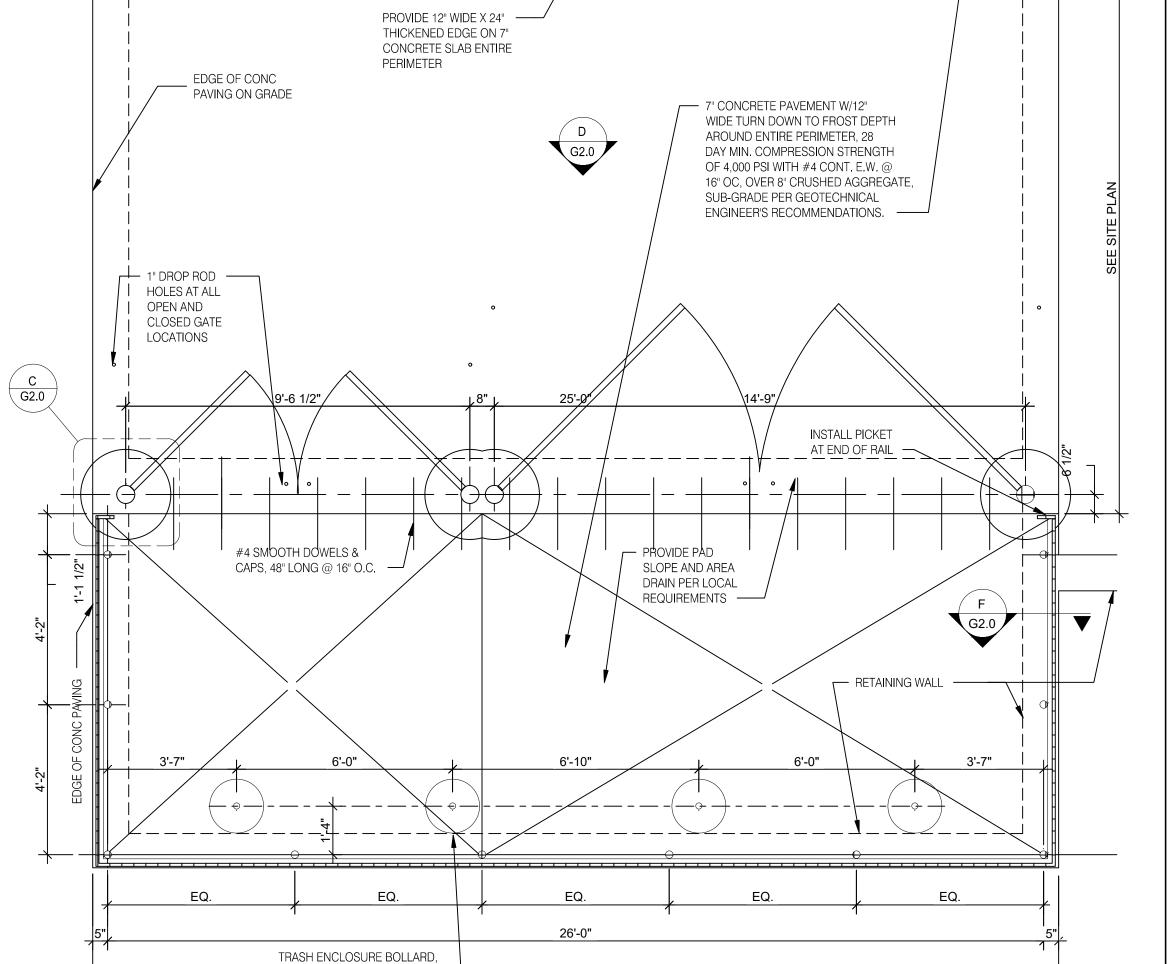

26'-10"

TYP. SEE DETAIL B/G2.0

NOTE: DO NOT SEAL EXTERIOR

WEEP HOLES @ BOTTOM OF

WALLS OR WINDOWS.

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COAT IS APPLIED TO ALL BLOCK WALLS. FOR SMOOTH BLOCK WALL SURFACES, PAINT FILLER IS USED. SEALING IS ADEQUATE, SUCH THAT THERE ARE NO VISIBLE CRACKS. • WALL FILLERS - AVOID PEARLITE, FIBERGLASS, ROCK WOOL. HIGH DENSITY FOAM PREFERRED.

 PIPES ARE PROPERLY RUST-PROOFED WITH NH3, PRIOR TO FOAM INSULATION OF THE WALLS. PENETRATIONS ARE PROPERLY SEALED/CAULKED. PIPE PENETRATIONS ARE CUT AND SEALED ON THE SAME DAY SO THAT OPENINGS OR JUNCTIONS REMAIN CLEAN. • TO DETER BIRD OR RODENT NESTING SITES, EXTERIOR PIPES AND CONDUITS ARE NOT ARRANGED IN GROUPS.

• ITEMS MOUNTED TO WALLS WITH LESS THAN A 1/4" GAP SHOULD BE SEALED TO THE WALL. • ACCESS IS ALLOWED TO KEY UTILITY JUNCTIONS BEHIND WALLS; KNOCK OUT PANELS ARE PRESENT. • BUILDING

CONSTRUCTION MINIMIZES THERMAL TRANSFER OF STRUCTURAL MEMBERS.

 CONCRETE CEILINGS ARE SMOOTH AND FREE OF PITS THAT MAY HARBOR INSECTS. • DROP CEILINGS ARE NOT PRESENT, BECAUSE OF POTENTIAL FOR FOOD/MOISTURE ACCUMULATION. (OBVIOUSLY NOT A "MUST" BUT, IT SURE MAKES IT EASIER) MAKING THEM MORE ACCESSIBLE FOR INSPECTION WOULD AT LEAST BE BETTER.

 HIGH PRESSURE SODIUM BULBS ARE USED WHERE HIGH-INTENSITY LIGHT IS NEEDED. SODIUM LIGHTS LAST LONGER AND ARE LESS ATTRACTIVE TO INSECTS THAN FLUORESCENT LIGHTS. • FLUORESCENT LIGHTING IS AVOIDED - IT'S HARD TO KEEP CLEAN. • SKYLIGHTS ARE AVOIDED BECAUSE THEY CAN LEAK. • WALL SCONCE UNITS ARE STRATEGICALLY PLACED SO THAT THEY DO NOT COLLECT DEBRIS.

 SKYLIGHTS ARE AVOIDED BECAUSE THEY CAN LEAK.
 DOUBLE-PANE AND WELL INSULATED WINDOWS ARE PREFERRED. • CAULKING IS USED FOR SMALL CRACKS AND CREVICES FOUND AROUND WINDOWS. • IF SCREENING IS USED, A MINIMUM OF 18 MESH IS RECOMMENDED; 30 MESH IS PREFERRED. • SCREENS ARE REINFORCED AT POINTS OF STRESS.

 ALL FAN/HOOD HOUSINGS ARE SEALED, ADEQUATE SEALS EXIST BETWEEN FAN HOUSINGS AND ROOF, ALL FANS ARE ACCESSIBLE FOR CLEANING; ALL FANS MOUNTED HIGH ENOUGH FOR CLEANING. • ALL HOODS HAVE SCREENS AND FILTERS THAT ARE PROPERLY SIZED AND HAVE THE PROPER MESH. • ALL FILTERS ARE EASILY CHANGED AND/OR CLEANED. • ALL FILTERS ARE INCLUDED ON THE MSS. • ALL DUCT WORK IS POSITIVELY PITCHED; THERE ARE NO HORIZONTAL DUCTS FROM HOODS. • ALL DUCT WORK IS ACCESSIBLE. • CONDENSATE

 EXHAUST FANS ARE MAXIMUM DISTANCE FROM AIR INTAKE.
 THERE IS NO AIRFLOW DIRECTLY ONTO FOOD PREP AREAS. • INBOUND AIR IS FILTERED AND DEHUMIDIFIED OR AIR-CONDITIONED.

SOURCES OF WATER DISCHARGE DO NOT CREATE STANDING WATER.
 ENTIRE FLOOR IS SEALED.

I. CONSTRUCTION GAPS AND PENETRATIONS

 ALL PIPE PENETRATIONS ARE PROPERLY SEALED THE SAME DAY THEY ARE CUT.
 EXPANSION JOINTS PRESENT ARE SEALED WITH PROPER JOINT COMPOUND. • ALL CRAWL SPACES ARE CLEAN AND FREE OF CLUTTER (E.G., WOOD DEBRIS) AFTER CONSTRUCTION. • ALL CRAWL SPACES AND BASEMENTS HAVE PROPER DRAINAGE AND VENTILATION. • ADEQUATE DRAINAGE IS AVAILABLE AND EQUIPPED WITH PUMPS FOR EXCESS WATER

STOREROOMS HAVE METAL SHELVING; NO WOODEN SHELVING PRESENT.
 STOREROOMS HAVE ADEQUATE

LIGHTING. • STOREROOMS ORGANIZED & NOT CLUTTERED.

 TOILETS ARE FLOOR MOUNTED WITH AUTOMATIC FLUSHING.
 HAND WASH HAS AUTOMATIC VALVES. BATHROOM WALLS ARE MONOLITHIC, SEALED, AND CLEANABLE. • BATHROOM FLOORS ARE MONOLITHIC. TILES AND VINYL SHEETING ARE AVOIDED. • FLOOR DRAINS ARE PRESENT TO ALLOW RINSING.

IS PROVIDED FOR EMPLOYEES. • EMPLOYEE LOCKERS ARE AVOIDED, BUT IF INSTALLED ARE ELEVATED WITH ACCESS BEHIND AND UNDER.

OFFICE AREA'S DESIGN PROMOTES ACCESSIBILITY AND MINIMIZES CLUTTER. • OPEN STORAGE SPACES AREA

PEST EXCLUSION: SEALING OR SCREENING ALL POTENTIAL ENTRY POINTS INTO THE BUILDING TO KEEP PESTS FROM COMING INSIDE. PEST ISOLATION (CONCEPT): PEST PROOF INSIDE THE BUILDING TO CONFINE PESTS AND KEEP THEM FROM MOVING INTO NEW AREAS. AN EXAMPLE MIGHT BE COMPARTMENTALIZING A BUILDING (LIKE

PEST ISOLATION (CONCEPT): PEST PROOF INSIDE THE BUILDING TO CONFINE PESTS AND KEEP THEM FROM MOVING INTO NEW AREAS. AN EXAMPLE MIGHT BE COMPARTMENTALIZING A BUILDING (LIKE SHIP BULKHEADS) TO ISOLATE AN INFESTATION IN ONE AREA AND MAKE PESTS EASIER TO ERADICATE

SHIP BULKHEADS) TO ISOLATE AN INFESTATION IN ONE AREA AND MAKE PESTS EASIER TO ERADICATE.

SEALING HARBORAGES: WELL SEALED BUILDINGS ARE LESS ATTRACTIVE TO PESTS, AS FEWER HIDING PLACES ARE AVAILABLE AND MAKE PESTS EASIER TO ELIMINATE.

PEST OPENINGS MUST BE LESS THAN

PIGEON 1.5 - INCH SPARROW 4/5 - INCH

RAT - YOUNG 1/3 - INCH MOUSE - ADULT 2/5 - INCH MOUSE - YOUNG 1/5 - INCH

GERMAN COCKROACH - ADULT 1/5 - INCH

GERMAN COCKROACH 1ST INSTAR NYMPH 1/16 - INCH HOUSE FLY 1/12 - INCH

MOSQUITO 1/20 - INCH

EXTERIOR PEST PROOFING: PEST EXCLUSION HAS BEEN SHOWN TO BE EFFECTIVE, ESPECIALLY FOR BIRDS AND RODENTS, EXAMPLES OF PEST EXCLUSION ARE INSTALLING METAL KICK PLATES ON DOORS, SCREENING VENTS AND EAVES, SEALING OPENINGS WHERE PIPES AND UTILITY LINES ENTER BUILDINGS, AND INSTALLING METAL RODENT GUARDS ON OVERHEAD LINES OR VERTICAL PIPES.

INTERIOR PEST PROOFING: WHILE INTERIOR SEALING OF OPENINGS AROUND PIPES AND LINES HAS BEEN PROVEN EFFECTIVE FOR MICE AND RATS, MANY STUDIES HAVE SHOWN THAT IT IS NOT VERY EFFECTIVE AGAINST COCKROACHES. IT IS VERY LABOR INTENSIVE AND BUILDING OR MAINTENANCE STAFF MAY NOT HAVE THE KNOWLEDGE OF PEST HABITS TO DO THIS INTERIOR PEST PROOFING CORRECTLY. IN FACT, SEALING OPENINGS INSIDE A STRUCTURE CAN ACTUALLY BE DETRIMENTAL BECAUSE VOIDS MAY NO LONGER BE ACCESSIBLE TO TREATMENT, BUT MAY STILL BE ACCESSIBLE TO COCKROACHES.

IV. INTERIOR PEST PROOFING

 ALL DOORS ARE FITTED TO CLOSE AUTOMATICALLY.
 ALL DOOR CASINGS ARE PROTECTED WITH SHEET METAL TO PREVENT MICE AND RATS FROM WIDENING CRACKS BY GNAWING.

 ALL WOODEN DOORS HAVE A 12-INCH SHEET METAL (26-GAUGE) KICK PLATE ATTACHED TO THE OUTSIDE OF THE DOOR, WITH THE LOWER EDGE NOT MORE THAN 1/4 -INCH FROM THE FLOOR. • HOLLOW METAL DOOR SEAMS ARE SEALED BY SPOT WELDING TO PREVENT INSECT ENTRY. • ALL SCREEN DOORS OPEN OUTWARDLY AND ARE FITTED WITH A SCREEN MESH OF NO LARGER THAN 1/18 INCH TO PREVENT ENTRY OF SMALL INSECTS INTO THE BUILDING. • DOUBLE DOORS ARE INSTALLED IN REGIONS WHERE FLYING INSECTS ARE PERVASIVE. • (IF FEASIBLE) • EXTERIOR LIGHTS AROUND DOORS HAVE 'BUG LIGHTS' INSTALLED OR LIGHTING IS AT LEAST 30-40 FEET AWAY FROM EXTERIOR DOORS SO THAT THEY DO NOT

ATTRACT FLYING INSECTS ONTO THE PREMISES. (IF FEASIBLE) • AIR DOORS OR PLASTIC CURTAINS (STRIP DOORS) ARE INSTALLED IN DELIVERY ENTRY WAYS TO PREVENT THE ENTRY OF FLYING PESTS. AIR VELOCITY OF AIR DOORS IS A MINIMUM OF 1600 FT/MIN. (IF FEASIBLE)

• ALL EXTERIOR DOORS TO BE STEEL OR STOREFRONT WITH ALUMINUM METAL. WOODEN DOORS TO EXTERIOR NOT ALLOWED.

 OPERABLE WINDOWS, FITTED WITH AT LEAST 18-INCH MESH SCREENING. SCREENING IS REINFORCED AT POINTS OF STRESS. • ALL CRACKS AND CREVICES AROUND WINDOWS ARE THOROUGHLY CAULKED.

C. FOUNDATION:

 ALL CRACKS AND HOLES ARE PATCHED-UP WITH CEMENT. ALL OPENINGS GREATER THAN 1/4 INCH ARE SEALED TO EXCLUDE MICE; ALL OPENINGS GREATER THAN 1/2 INCH ARE SEALED AGAINST RATS. • CLIMBING BY RATS AND MICE IS DETERRED BY A 12-INCH BAND OF HARD GLOSSY PAINT, OR POLISHED METAL, AROUND THE OUTSIDE OF BRICK WALLS, UP TO ABOUT 3.5 FT. ABOVE THE GROUND. • FOR TEMPORARY EXCLUSION, UNTIL MORE PERMANENT REPAIRS CAN BE MADE, STEEL WOOL IS TIGHTLY PLUGGED INTO CRACKS AND HOLES TO PREVENT ENTRY OF RODENTS.

D. PEST PROOFING MATERIALS 1. BACKING/FILLING MATERIALS: • MATERIALS SUCH AS COPPER MESH, PLUMBER'S OAKUM, HARDWARE CLOTH AND/OR FOAM RUBBER ARE (FIRST) USED TO FILL GAPS THAT EXCEED THE MAXIMUM SIZE RECOMMENDED FOR A SEALING PRODUCT. • THESE MATERIALS ARE PLACED IN THE OPENING FIRST, AND THEN CAULKED OR SEALED OVER.

2. SCREENING MATERIALS

 STEEL WOOL IS USED TO PLUG SMALL OPENINGS WHERE PESTS MAY ENTER OR MOVE WITHIN STRUCTURES. STEEL WOOL IS USEFUL WHERE AIR MOVEMENT IS DESIRED, BUT THERE IS LOW HUMIDITY ONLY. STEEL WOOL WILL RUST, SO IT SHOULD NOT BE USED IN AREAS OF HIGH MOISTURE. • COPPER MESH IS USED IN LOCATIONS WITH HIGH HUMIDITY OR MOISTURE (STEEL WOOL WILL RUST). • WINDOW SCREEN (18 MESH MINIMUM) IS USED TO EXCLUDE INSECTS (NOT WILDLIFE) FROM SOFFIT VENTS IN ATTICS, CRAWL SPACE VENTS, AND FRESHAIR INTAKE VENTS FOR THE STRUCTURE. • HARDWARE CLOTH IS HEAVIER THAN WINDOW SCREENING AND IS USED TO EXCLUDE RODENTS, BATS, BIRDS, AND WILDLIFE FROM ATTICS AND CRAWL SPACES. IT CAN ALSO BE USED TO PREVENT WILDLIFE FROM TUNNELING UNDER STRUCTURES.

CONSTRUCTION CHECKLIST:

TOILET GUARDS

LATCH GRATES

ROOF VENTS

FLOOR TRAPS WITH

MESH OVER SEWER

DURING CONSTRUCTION 3 MANDATORY AND 1 OPTIONAL VERIFICATION STEPS ARE REQUIRED:

1. (PREFERRED BUT NOT REQUIRED) PEST PROVIDER IS BROUGHT IN DURING SITE SELECTION FOR PRELIMINARY EVALUATION. TACO BELL HAS 4 NATIONAL PROVIDERS OF PEST MANAGEMENT & PREVENTION. 2. AFTER DEMO, PMP ESTABLISHES A PLAN FOR EXCLUSION (SEALING OF BUILDING). IT IS IMPORTANT THIS STEP HAPPENS AFTER ALL OF THE WALLS ARE OPEN TO IDENTIFY ALL PENETRATIONS AND AREAS OF RISK. 3. AFTER EXCLUSION WORK IS COMPLETE, BUT BEFORE WALLS ARE CLOSED UP, PMP CONDUCTS A 2ND EVALUATION.

4. AFTER WALLS ARE CLOSED UP AND TYPICALLY A FEW DAYS BEFORE A STORE OPENS, A FINAL WALK-THRU IS CONDUCTED TO ENSURE THAT ALL DEVICES ARE IN PLACE AND THE INTEGRITY OF THE EXCLUSION PLAN IS

*ADDITIONAL VISITS MAY BE REQUIRED PER PEST VENDOR RECOMMENDATION.

 1/4" MESH ______ OVERLAP **EXTERIOR PIPE** SMOOTH METAL GUARD CEILING/WALL/FLOOR **EXTERIOR PIPES** <u>VENTS</u> STUF-IT COPPER GAUZE WITH PLASTER OTHER AREAS RAT **PROOFING IS REQUIRED**

RAT PROOFING DETAILS

PIPE PENETRATIONS

FOR ALL ASPECTS OF PEST PREVENTION ACTIVITIES, WE ARE MOVING TOWARDS SEASONALLY AND GEOGRAPHICALLY ATTENUATED (SAGA) © AND ENVIRONMENTALLY AND SOCIALLY RESPONSIBLE PEST PREVENTION PROGRAMMING © TO ACHIEVE MANAGEABLE, SITE-SPECIFIC SCOPES OF WORK. **GUIDING PRINCIPLE 1 - SITE SELECTION** YOU HAVE TO TRY TO LOOK AT EVERY PHYSICAL ASPECT OF THE BUILDING AND ITS ENVIRONMENT. TO THIS END, IT IS PREFERABLE TO ESTABLISH A RELATIONSHIP WITH A LOCAL MEMBER OF YOUR PEST PREVENTION PROVIDER'S MANAGEMENT TEAM AND ASK THEM TO GIVE SOME GENERAL GUIDANCE DURING THE SITE SELECTION PROCESS. THEY MAY BE AWARE OF NEIGHBORHOOD LEVEL PEST PREVENTION CONCERNS AND HAVING THEM INVOLVED FROM THE BEGINNING ALLOWS THEM TO PROPERLY CREATE/MODIFY THE PRE AND POST CONSTRUCTION SERVICE PLANS, FROM BOTH GLOBAL AND LOCAL PERSPECTIVES, LOCATION

UNWANTED ORGANISMS.

QA/FOOD SAFETY RESOURCES ARE AVAILABLE TO COORDINATE OR PERFORM ASSESSMENTS AS NEEDED.

EXPERTS (IF AVAILABLE) OR ASSESSED BY TACO BELL CORPORATE QA/FOOD SAFETY STAFF.

OF THE RELEVANT INFORMATION NEEDED ABOUT ANY PARTICULAR STORE IS ALREADY IN TACO BELL'S

HANDS IN THE FORM OF PEST ACTIVITY DATA. ADDITIONAL INFORMATION CAN BE GATHERED FROM LOCAL

INTEGRATED PEST PREVENTION (IPP) CAN BE DEFINED AS, "THE ART AND SCIENCE OF PREVENTING THE

INTRODUCTION OF UNWANTED ORGANISMS INTO COMPLEX MICROENVIRONMENTS AND THE ASSOCIATED MITIGATION EFFORTS REQUIRED WHEN PREVENTION FAILS". IPP ENCOMPASSES THE CONCEPTS, STRATEGIES

AND TACTICS NEEDED TO EFFECTIVELY PROTECT HUMAN HEALTH AND PROPERTY FROM THE PRESENCE OF

EVERY PEST, WHETHER MICROBIOLOGICAL, INVERTEBRATE OR MAMMALIAN NEED A FOOD SOURCE, WATER,

SAFE HARBORAGE (SUITABLE ENVIRONMENT – TEMPERATURE, HUMIDITY, HIDING PLACES). THEY ALSO NEED

PREVENT AN INTRODUCTION FROM BECOMING AN INFESTATION (ARTHROPODS OR VERTEBRATES) OR THE

IN GENERAL, WHEN YOU THINK ABOUT EXCLUDING PEST FROM A BUILDING, YOU CAN THINK OF THE PESTS

AS WATER. WE DON'T WANT UNNECESSARY WATER GETTING INTO THE BUILDING SO WE ADD APPROPRIATE

BARRIERS. FROM VAPOR BARRIERS TO CONCRETE CURBS, WE BLOCK OR REDIRECT WATER. SAME WITH

PREVENT INTRUSION, FOR RODENTS, THE SAME CONCEPTS APPLY BUT THE BUILDING MATERIALS/PRACTICES

PESTS; FOR INSECTS WE CAN USE MATERIALS LIKE ELASTOMERIC SEALANTS AND HARD SURFACES TO

A WAY INTO THE RESTAURANT. IN MOST CASES, CONTROLLING EVEN 1 OF THE REQUIREMENTS CAN

GROWTH OF PATHOGENIC ORGANISMS (BACTERIA/FUNGI ETC.). WHILE WE CANNOT ELIMINATE ALL

INTRODUCTIONS FROM EMPLOYEES, CUSTOMERS AND DELIVERIES, WE CAN VIRTUALLY ELIMINATE

INTRUSIONS DUE TO CONSTRUCTION AND DESIGN FAULTS AND, OPERATIONAL BEHAVIOR.

HAD TO BE MORE ROBUST (CEMENTITIOUS MATERIALS WITH METAL REINFORCEMENT).

THE CRITICAL FACTORS, IRRESPECTIVE OF BROAD GEOGRAPHICAL LOCATION, WOULD BE; STAND ALONE VS. MALL LOCATION, COMBINATION FACILITY*, THE AGE OF THE FACILITY**, AND GENERAL NEIGHBORHOOD

CHARACTERISTICS ARE CLEARLY THE DRIVING FORCE IN POTENTIALLY PREDICTABLE PEST PROBLEMS. MUCH

FACTORS THAT WE CANNOT CONTROL, BUT CAN ANTICIPATE/MITIGATE:

a. WEATHER / CLIMACTIC ZONE

b. LOCALIZED SPECIAL PEST ISSUES (PAST PEST HISTORY) c. BUILDING LOCATION - PARTICULARLY A CONCERN IN URBAN AREAS. LITTER, AGING UTILITIES, SUBWAYS AND FOOT TRAFFIC LEVELS MUST BE ACCOUNTED FOR.

d. BUILDING AGE e. BUILDING PLACEMENT

NEIGHBORHOOD (PHYSICAL AND SOCIOECONOMIC) CONDITIONS

* COMBINATION FACILITY CAN MEAN AN INLINE LOCATION OR MULTI-USE FACILITY (FOR EXAMPLE, ADDING A BAR TO A RESTAURANT OR PLACING A RESTAURANT IN A TRAVEL CENTER ADDS COMPLEXITIES DUE TO INCREASED PEST OPPORTUNITIES.)

**THE AGE OF THE BUILDING INTRODUCES ISSUES LIKE: CONSTRUCTION MATERIALS AND BUILDING

GUIDING PRINCIPLE 2 – BUILDING DESIGNED FOR EXCLUSION, INSPECTION, CLEANING AND TREATMENT USING PROPER TECHNIQUES TO KEEP PESTS OUT IS EASY ENOUGH BUT TIME AND USE EVENTUALLY TAKE THEIR TOLL ON THE ENTIRE STRUCTURE. THE RESULTS CAN BE RAPID DETERIORATION AND PEST INTRUSION/INFESTATION. 1. USE HIGH QUALITY CONSTRUCTION MATERIALS TO PREVENT THE INTRUSION OF MOISTURE AND PESTS (SPECIFICS AVAILABLE IF REQUIRED). MOISTURE INVITES THE FULL SPECTRUM OF PESTS TO ENTER AND BECOME ESTABLISHED IN THE BUILDING, RESULTING IN A THREAT TO PUBLIC HEALTH AND DAMAGE TO THE ASSET. THIS APPLIES TO MOISTURE WITHIN THE BUILDING AS WELL AS ENVIRONMENTAL MOISTURE. COUNTERS, BEVERAGE MACHINES, DRAINS, SINKS ALL HAVE TO BE WELL SEALED TO PREVENT MOISTURE FROM PENETRATING INTO CRACKS, CREVICES OR VOIDS.

1. THE PESTS OF PRIMARY FOOD SAFETY/PUBLIC HEALTH CONCERN ARE LARGELY CRYPTIC IN NATURE, THEY EITHER LIKE TO HIDE (RODENTS), MUST HIDE (COCKROACHES) OR SIMPLY REQUIRE QUIET, DARK, OUT OF THE WAY PLACES TO BREED (COCKROACHES AND FLIES). RESTAURANT STAFF AND PEST PREVENTION PARTNERS MUST BE ABLE TO MOVE EQUIPMENT AROUND TO SEE WHAT IS HAPPENING

2. THE FLOORS, DRAINS AND WALLS HAVE TO BE DURABLE AND EASILY CLEANED A. AVOID TILE WHEN POSSIBLE (GROUT LINES) I. WHEN TILE MUST BE USED, EPOXY GROUT IS PREFERRED B. DRAINS MUST BE POSITIONED TO BE EASILY INSPECTED AND CLEANED C. EQUIPMENT MUST BE EASY TO MOVE TO CLEAN THE FLOOR D. EQUIPMENT MUST BE DESIGNED TO BE EASILY CLEANED.

3. TREAT WALL VOIDS AND DIFFICULT TO INSPECT STRUCTURAL AREAS WITH BORACARE (DISODIUM OCTABORATE TETRAHYDRATE) TO ASSIST IN THE PREVENTION OF ARTHROPOD INFESTATIONS.

4. TREAT AREAS PRONE TO INFECTION WITH MOLD-CARE (DIDECYL DIMETHYL AMMONIUM CHLORIDE).

5. BASEMENTS A. FOLLOW THE SAME EXCLUSION PRINCIPLES IN GENERAL TERMS B. ADDITIONAL PEST DEVICES MUST BE ADDED/ACCOMMODATED C. AIRFLOW IS CRITICAL. SINCE FOOD RELATED ITEMS WILL BE STORED IN THESE AREA, WE MUST NOT ALLOW MOISTURE TO FOSTER THE DEVELOPMENT OF MICROORGANISMS (BOTH PATHOGENIC AND NON-PATHOGENIC).

6. EXTERIOR DESIGN TO ELIMINATE INTRODUCTION POINTS AND HARBORAGE AREAS A. NO TREES OVERHEAD OR TOUCHING THE BUILDING B. NO SHRUBS, BUSHES, VINES TOUCHING OF IN CLOSE PROXIMITY TO THE BUILDING C. STRATEGICALLY PLACE WASTE (COMPOST/RECYCLING/LANDFILL) RECEPTACLES AWAY FROM THE BUILDING WHEREVER POSSIBLE AND HAVE THEM IN WELL-LIT AREAS (IF APPROPRIATE).

7. LIGHTING SHOULD BE INDIRECT WHENEVER POSSIBLE TO PREVENT NIGHT FLIERS FROM BEING DRAWN TO THE BUILDING.

8. AVOID SEMI-ENCLOSED (PARTIAL SOFFIT) AREAS WHERE BIRDS AND MAMMALS CAN HARBOR.

(APPENDIX FOLLOWS)

APPENDIX

PEST MANAGEMENT, IN A STANDALONE SETTING IS ACTUALLY QUITE SIMPLE WHEN PROPERLY EXECUTED BY ALL PARTICIPANTS. AS IT RELATES TO BUILDING DESIGN AND CONSTRUCTION, THERE ARE JUST A FEW PRINCIPLES THAT IF ADDRESSED WITH GREATLY DIMINISH PEST ISSUES.

1. DON'T PROVIDE ANY UNNECESSARY ATTRACTANTS WHEN POSSIBLE AND, MITIGATE WHEN UNAVOIDABLE. 2. IF THE BUILDING IS TIGHT, THEN PESTS CANNOT COME IN EASILY. 3. MAKE SURE THAT THERE IS ENOUGH AIRFLOW INTO THE BUILDING FROM ABOVE TO FACILITATE POSITIVE PRESSURE AT THE DOORS. 4. IF THE PESTS CAN'T GET INTO THE BUILDING, THERE WON'T BE AN INTRODUCTION. 5. IF THEY DO GET IN THE BUILDING BUT, HAVE NOWHERE TO HIDE. THERE WON'T BE AN INFESTATION. A. EQUIPMENT, WHEN POSSIBLE SHOULD BE TIGHTLY SEALED. I. EXAMPLE, MANY TIMES, STAINLESS "CURTAINS" ARE PLACED TO SHIELD THE UNDERSIDE OF EQUIPMENT FROM VIEW. THIS WILL NOT KEEP ANYTHING OUT. B. WHEN NOT POSSIBLE, MAKE IT EASY TO OPEN FOR INSPECTION AND TREATMENT. ALSO, CONSIDER THE NEED FOR MONITORING DEVICES NEAR ENTRY POINTS. I. EXAMPLE, IF A PIECE OF EQUIPMENT MUST HAVE A HOLE AT THE BOTTOM, MAKE SURE THAT A DEVICE CAN BE PLACED APPROPRIATELY IN OR UNDER IT. KEEP

I. EXTERIOR SANITARY DESIGN

A. BUILDING PERIMETER:

AND INSPECTED.

• THERE ARE NO OUTSIDE PITS OR DEPRESSIONS. THE PERIMETER SLOPES AWAY FROM THE BUILDING. • A 2-FOOT GRAVEL BARRIER IS PRESENT WITH DRAINS IN CRITICAL DRAINAGE AREAS. • EXPANSION JOINTS AROUND PERIMETER ARE FILLED WITH CORRECT JOINT FILLER. • THERE ARE NO OUTSIDE STORAGE AREAS THAT COULD PROVIDE HARBORAGE FOR PESTS. • NO CHAIN LINK FENCES ARE PRESENT NEAR THE FACILITY. • BUILDING DESIGN ALLOWS FOR EASY WEED ACCESS/REMOVAL AND LAWN MAINTENANCE.

VISUAL INSPECTION IN MIND TOO. C. AVOID DIFFICULT TO CLEAN EQUIPMENT. IF IT ISN'T EASY, PEOPLE WON'T CLEAN

IT. D. IN SUMMARY, IF YOU CAN, KEEP THEM OUT. IF YOU CAN'T MAKE SURE THE EQUIPMENT CAN BE EASILY CLEANED

 EXTERIOR SMOKING AREA IS PROVIDED FOR EMPLOYEES SUCH THAT THE DEBRIS FOUND IN THESE AREAS DOES NOT ATTRACT PESTS INTO THE FACILITY. • BUILDING DESIGN DETERS BIRDS FROM NESTING OR LOAFING.

B. UTILITY LINES: • UTILITY LINES, ELECTRICAL CONDUITS, AND PLUMBING ENTRANCES INTO THE BUILDING ARE COMPLETELY SEALED, PREVENTING PEST ENTRY. • PIPES OR WIRING ARE NOT GROUPED INTO GANGS AND ARE NOT HOUSED IN METAL TUBES. • UTILITY SYSTEMS ARE EASILY ACCESSIBLE AND EASILY OPENED FOR THOROUGH CLEANING. • RODENTS ARE DETERRED FROM CLIMBING PIPES ON THE BUILDING EXTERIOR BY FITTED METAL RAT GUARDS. GUARDS ARE MADE OF 26-GAUGE SHEET METAL, FITTED CLOSE TO THE WALL AT THE REAR, AND PROJECTING 12 INCHES OUTWARD FROM THE PIPE. • OUTSIDE VERTICAL PIPES ARE COATED WITH GLOSSY PAINT TO PREVENT RODENTS FROM CLIMBING THEM. • WHERE POSSIBLE, UTILITY LINES ARE TRENCHED, RATHER THAN SUSPENDED.

C. PARKING AND ROADWAYS: • ALL PARKING AND TRAFFIC AREAS ARE PAVED. • DRAINS ARE PLACED IN ALL DOCK AND DUMPSTER AREAS. • DRAINS ARE FREE OF DEBRIS.

D. LANDSCAPING: • PERIMETER FOLIAGE CLEARS BUILDING BY 18" MINIMUM AND NOT TALLER THAN 24 INCHES. • TREES ARE AT LEAST 30 FEET AWAY FROM BUILDING PERIMETER. • GROUND COVER DOES NOT INCLUDE PINE STRAW OR THATCHED GRASS. • GROUND COVER SUCH AS GARDEN STONES AND SPARSE LIVE PLANT COVER ARE USED.

 BUILDING PERIMETER IS WELL LIGHTED. • EXTERIOR LIGHTS ARE LOCATED AT LEAST 30-40 FEET AWAY FROM EXTERIOR DOORS, SO THAT THEY DO NOT ATTRACT FLYING INSECTS INTO THE BUILDING. (IF FEASIBLE) • OUTSIDE LIGHTS ARE SHIELDED TO SHINE DOWN ONTO THE BUILDING PERIMETER AND DO NOT SHINE OUT/AWAY FROM THE FACILITY. SHADOW BOX FIXTURES PREFERRED. • BULBS LESS ATTRACTIVE TO INSECTS SUCH AS HIGH PRESSURE SODIUM ARE USED. • INSECT LIGHT TRAPS ARE LOCATED SUCH THAT THEY DO NOT DRAW INSECTS INTO THE FACILITY.

F. SANITARY DUMPSTER AND TRASH STORAGE:

 TRASH STORAGE IS LOCATED AWAY FROM INCOMING GOODS AND ISOLATED FROM FACILITY. • TRASH STORAGE IS LOCATED IN A WALLED SPACE, WITH OPEN AREA AND MINIMAL AVAILABLE HARBORAGE FOR RODENTS, BIRDS, OR INSECTS. • TRASH STORAGE IS LOCATED DOWNWIND (PREVAILING WINDS) WHEN POSSIBLE. • TRASH STORAGE IS SEPARATED FROM FACILITY BY FIRE-RATED SEPARATION WALLS. • HOT WATER RINSE IS AVAILABLE AND PROPER DRAIN(S) ARE PRESENT. • HAND-SANITIZER PROVIDED FOR RE-ENTRY INTO THE FACILITY. • SANITATION DUMPSTER IS ADEQUATE FOR VOLUME, HAS A RAIN COVER, AND IS SEALED WITH NO LEAKS. • SIGN (FOR EMPLOYEES) IS PRESENT IN DUMPSTER AREA - KEEP THIS AREA CLEAR AND CLEAN. • SIGN (FOR EMPLOYEES) IS PRESENT IN DUMPSTER AREA -

DO NOT FEED STRAY ANIMALS/BIRDS.

G. RECYCLING STORAGE OUTSIDE STORAGE IS WELL DRAINED; PAVING IS DESIRABLE.
 PLASTIC/GLASS - DEDICATED CONTAINERS ARE PROVIDED; AREA FOR DRY STORAGE IS PROVIDED. • HOT WATER AVAILABLE WITH FLOOR DRAINS FOR CLEANING.

 SINGLE MEMBRANE OR SMOOTH ASPHALT IS PREFERRED; AVOID BALLASTED ROOFING OR HOT MOP ROOFS. ACCESSES TO ROOF ARE CONVENIENTLY LOCATED, COVERED AND SEALED WHEN CLOSED. • CURBING (RUN-OFF STOP) IS DESIGNED TO A 12-18 INCHES HEIGHT MINIMUM. • MINIMAL FLAT SURFACES ARE AVAILABLE FOR NESTING/LOAFING SITES. • ROOF DESIGNED TO DETER STORAGE OF ANY KIND. • NO SKY LIGHTS ARE PRESENT; OR ONLY DOUBLE DOMED SKYLIGHTS ARE USED AND ARE WELL SEALED. • THERE ARE NO BRIGHT COLORS ATTRACTIVE TO INSECTS (YELLOW, RED), OR BIRDS (WHITE). • ONLY QUALITY FLASHING IS USED. • EQUIPMENT AND METAL DUCTWORK ARE PROPERLY MOUNTED WITH ALL JOINTS SEALED.

• ALL ROOF DRAIN PIPES PROPERLY TREATED WITH NH3 TO AVOID RUSTING. • OPEN PIPES AND VENTS ARE SCREENED WITH 1/4 -INCH SCREENING OR CAPPED TO KEEP PESTS OUT. • ROOF DRAIN PIPES ARE INSULATED TO PREVENT FREEZING. • ROOF DRAINS ARE ROUTED TO THE SANITARY SEWER; DOWN-SPOUTS CARRY WATER AWAY FROM BUILDING. • CANOPY RUNOFF IS ROUTED AND DOES NOT RUN OFF ANY EDGE. • NO DEPRESSIONS OR SITUATIONS EXIST THAT CREATE STANDING WATER.

F. DOORS: • VESTIBULES ARE PRESENT AT EACH EMPLOYEE AND FACILITY ENTRY-WAY WHENEVER POSSIBLE. • PEDESTRIAN DOORS OPEN TO THE (OUTSIDE) OF THE FACILITY ONLY.

 PEDESTRIAN DOORS ARE CONSTRUCTED WITH GALVANIZED OR STAINLESS STEEL FRAME. • PEDESTRIAN DOORS HAVE PROPER DOOR-SWEEPS INSTALLED. BRUSHES ARE USED; RUBBER IS NOT. • PEDESTRIAN DOORS ARE (FOAM) INSULATED, NO FIBERGLASS INSULATION IS USED. • WOODEN DOORS ARE NOT PRESENT. • PEDESTRIAN DOORS HAVE A DOOR CLOSER; THERE ARE NO SCREW-DOWN THRESHOLDS OR "DOOR STOPS". • SWEEP-TYPE WEATHER STRIPPING IS USED AND NO PENETRATING LIGHT DETECTED.

II. INTERIOR SANITARY DESIGN A. FOUNDATION:

 THE CRAWL SPACE OR BASEMENT IS EASILY ACCESSED. • PRESSURE TREATED WOOD IS USED IN ANY LOCATION. NEAR OR BELOW GRADE. • NO VISIBLE CRACKS OR HOLES PRESENT IN THE WALLS. ALL OPENINGS GREATER THAN 1/4 INCH ARE SEALED. • 12-INCH BAND OF HARD GLOSSY PAINT IS APPLIED AROUND OUTSIDE BRICK OR STONE WALLS TO DETER CLIMBING RATS AND MICE. • ALL UTILITIES BELOW GRADE ARE EASILY ACCESSED AND ARE LABELED

B. FLOOR DRAINS:

 ALL FLOOR DRAINS ARE DESIGNED WITH TRAPS WITH AT LEAST 3 INCHES OF WATER SEAL, AND THEY ARE FITTED. WITH SECONDARY STRAINERS TO PREVENT PEST ENTRY. • FLOOR DRAINS EXIST IN PRODUCTION AREA EVERY 400 SQ. FT. • FLOOR DRAINS ARE CONSTRUCTED OF STAINLESS STEEL FOR EASIER CLEANING. • OVERHEAD PIPING AND DRAINS (IN CRAWL SPACE) ARE WELL SEALED AND DO NOT LEAK. • WHERE INSECTS MAY BE A PERSISTENT PROBLEM, INSECT SCREENS ARE INSTALLED IN FRONT OF FILTER MEDIA. • SCREENS ARE EASY TO REMOVE FOR CLEANING, AND THEY ARE NON-CORROSIVE, 18- MESH SCREEN. • VENTS ARE COVERED WITH METAL GRILLWORK AND ARE BACKED BY RUST RESISTANT SCREENING. • FLOOR DRAINS INCLUDED ON MASTER SANITATION SCHEDULE - MINIMUM 1 WEEK CLEANING.

POURED CONCRETE IS PREFERRED FOR INSIDE WALLS, HIGH DENSITY FILLED CONCRETE BLOCK 1ST 6-8 FT. IS ACCEPTABLE IN OTHER AREAS. • IF METAL SIDING IS UTILIZED THE BOTTOM 8' OF THE WALL IS POURED CONCRETE SO AS TO PROVIDE A SEAL TO THE CONCRETE WITH THE OVERLAPPING SIDING. • NO VOIDS ARE PRESENT; ALL VOIDS INSULATED WITH PROPER MATERIAL THAT DETERS PESTS. • WALL AND FLOOR JUNCTURES ARE SEALED WHERE POSSIBLE. • IF STEEL STUDS ARE USED, OPENINGS EXIST THAT ALLOW EASY FLOW OF DUST APPLICATIONS. • FILLER

07.26.22 NTP 08.09.22 IFB 04.13.22 **CONTRACT DATE: BUILDING TYPE:** END. 80FT PLAN VERSION: MARCH 2021

SITE NUMBER: 315672 STORE NUMBER: 455386 PA/PM: DRAWN BY JOB NO.: 2021088.52

DICKSON

BRAND DESIGNER:

TACO BELL


1551 West River Rd.


Elyria, OH



ENDEAVOR 2.0 PEST PREVENTION GUIDE



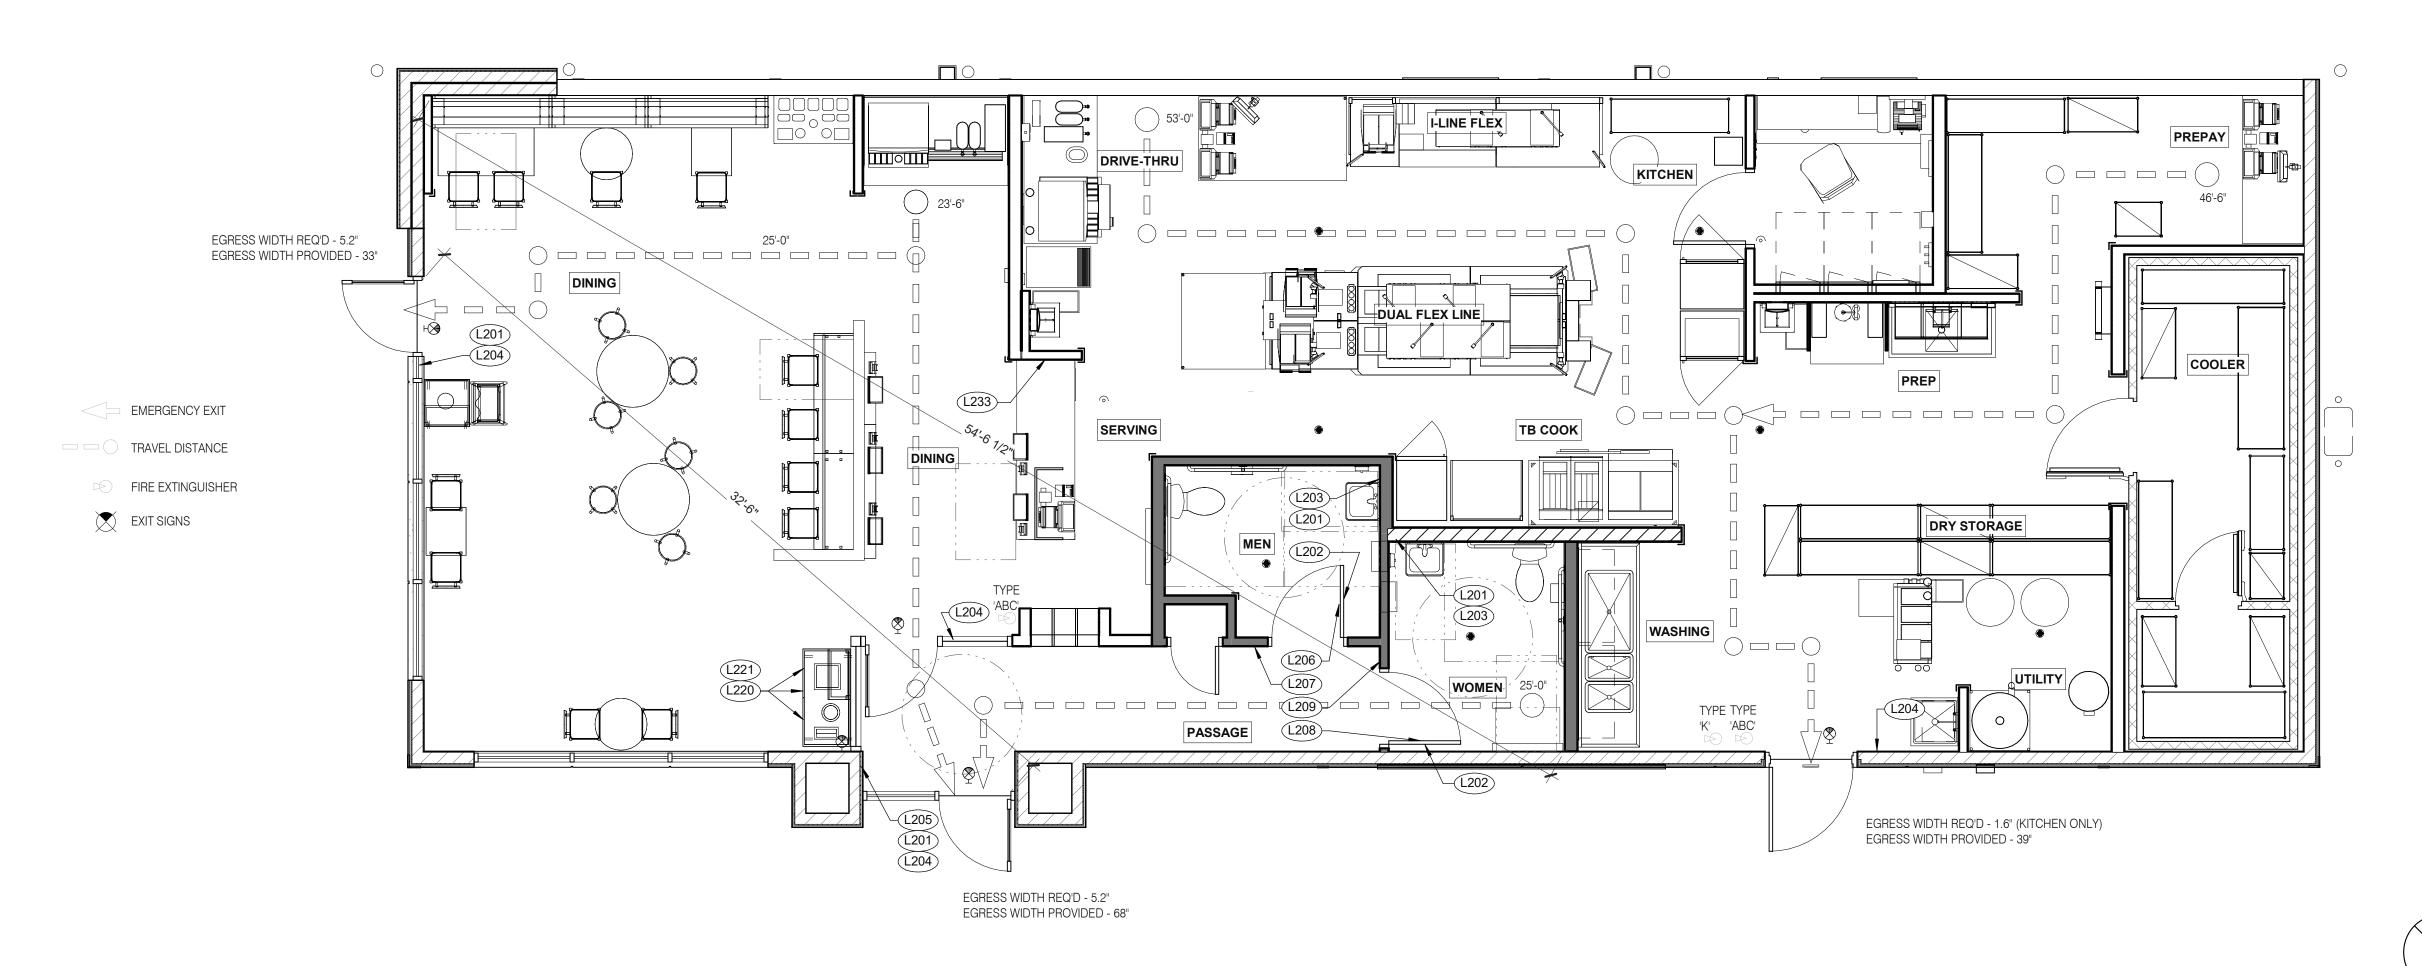

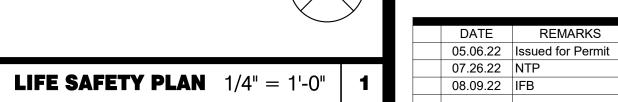

CONTRACT DATE: 04.13.22
BUILDING TYPE: END. 80FT
PLAN VERSION: MARCH 2021
BRAND DESIGNER: DICKSON
SITE NUMBER: 315672
STORE NUMBER: 455386
PA/PM: SM
DRAWN BY.: RS
JOB NO.: 2021088.52

TACO BELL

1551 West River Rd. Elyria, OH



ENDEAVOR 2.0 LIFE SAFETY PLAN


G4.0


NOT USED

TAG	SIGN DESCRIPTION	SIGN VERBIAGE	SIZE	MOUNTING HEIGHT	QTY	LOCATION IN RESTAURANT
L201	Smoking	No Smoking or electronic cigarette use. This is a smoke free establishment	1/16 x 9 x 6	48" MIN. A.F.F. 60" MAX. A.F.F.	4	1 in each restroom, 1 at each door
L202	Clean Restroom	To our customers:We check our restrooms every 30 minutes to make sure they are always ready for you. If we have missed something, please tell our manager on duty. Thank you	1/16 x 6 x 9	60" A.F.F.	2	1 inside each restroom (back of restroom door)
L203	Hand Wash Notice	Employees must wash hands before returning to work	1/16 x 6 x 6	60" A.F.F.	2	1 inside each restroom near sink
L204	Exit (w/ Braille)	Exit	1/16 x 6 x 6	60" A.F.F.	4	1 at each exit, mounted on wall, according to ADA guidelines
L205	Occupancy	Maximum occupancy xxx persons	1/16 x 6 x 6	8'-0" to center of sign	1	Above customer exit. Only 1 is needed
L206	Men's Restroom Triangle (W/B)	INFOGRAPHIC of male	1/4 x 12 x 12	60" A.F.F.	1	Mounted on men's restroom door
L207	Men's Restroom (w/ Braille)	INFOGRAPHIC of male and braille to read: Men's restroom	1/4 x 10 x 6.5	60" A.F.F.	1	Mounted on wall next to restroom door, refer to plans and ADA guidelines for exact location
L208	Women's Restroom Circle (W/B)	INFOGRAPHIC of female	1/4 x 12 x 12	60" A.F.F.	1	Mounted on women's restroom door
L209	Women's Restroom (w/ Braille)	INFOGRAPHIC of male and braille to read: Women's restroom	1/4 x 10 x 6.5	60" A.F.F.	1	Mounted on wall next to restroom door, refer to plans and ADA guidelines for exact location
L233	If you need assistance? ADA	Please ask if you need assistance. And ADA infographic	1/16 x 3 x 6	60" A.F.F.	1	At front counter

TAG	SIGN DESCRIPTION	SIGN VERBIAGE	SIZE	MOUNTING HEIGHT	QTY	LOCATION IN RESTAURANT	LOCATION EQUIVALENT
L220	Landfill / Compost / Recycle	Landfill / Compost / Recycle	1/16 x 8.5 x 3	SEE 4/G4.0	SET OF 3	Mount on front doors of trash receptacle at top. MUST ALSO ORDER L222. Match label with shape on top of trash receptacle	L221 (use if restaurant is NOT COMPOSTING)
L221	Landfill / Plastic, Metal, Glass / Paper	Landfill / Plastic, Metal, Glass / Paper	1/16 x 8.5 x 3	SEE 4/G4.0	SET OF 3	Mount on front doors of trash receptacle at top. MUST ALSO ORDER L223. Match label with shape on top of trash receptacle	L220 (use if restaurant is COMPOSTING)

520 S. MAIN STREET, SUIT 2531 AKRON, OH 44311 330.572.2100 FAX: 330.572.2102 Copyright; Glous, Pyle, Schomer, Burns & Delfoven, Inc. 2021

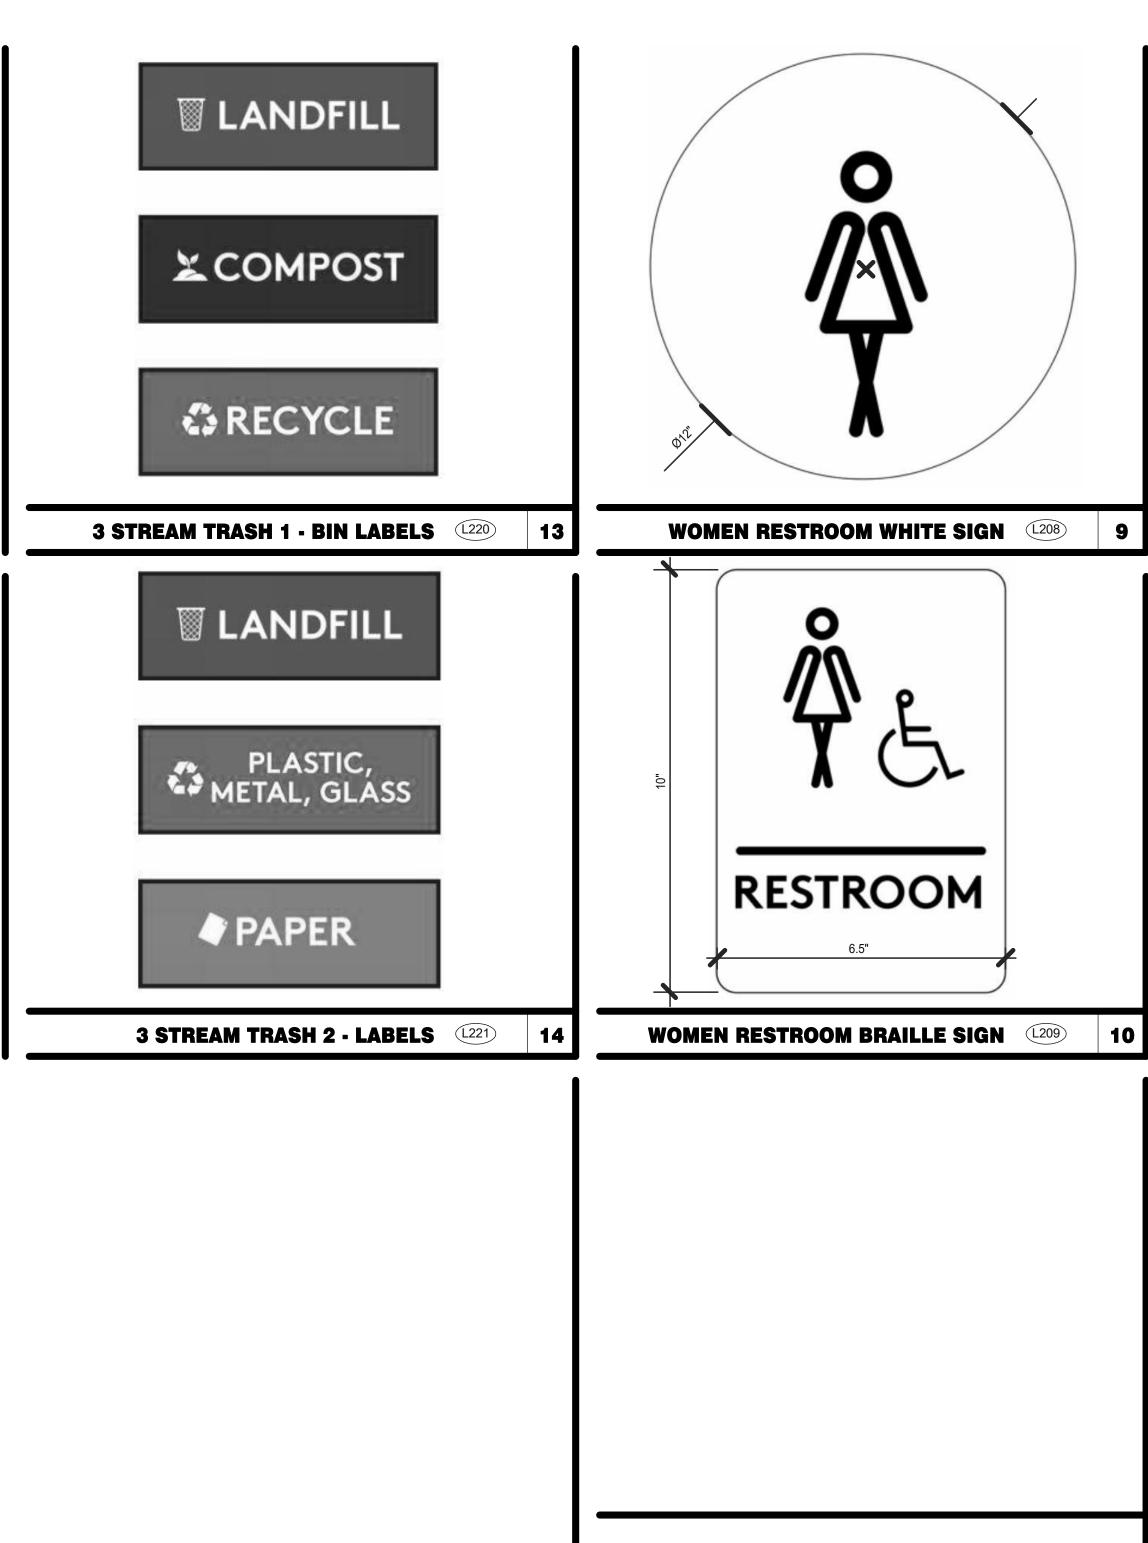


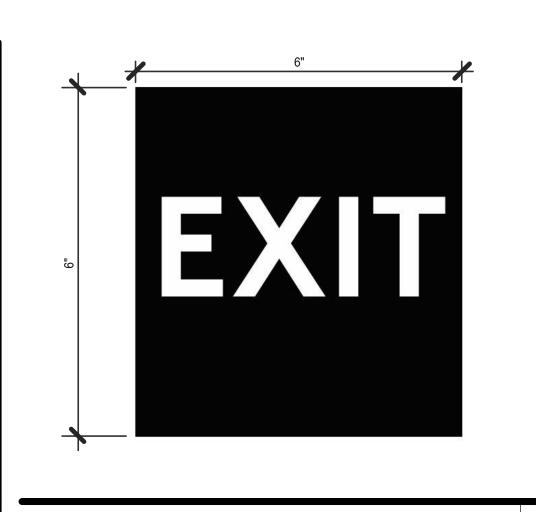







NO SMOKING SIGN (L201)

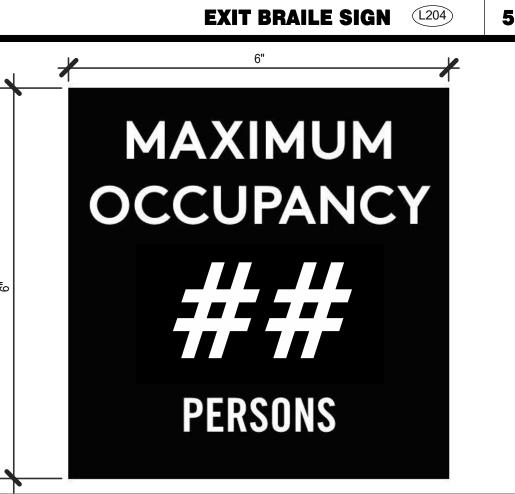

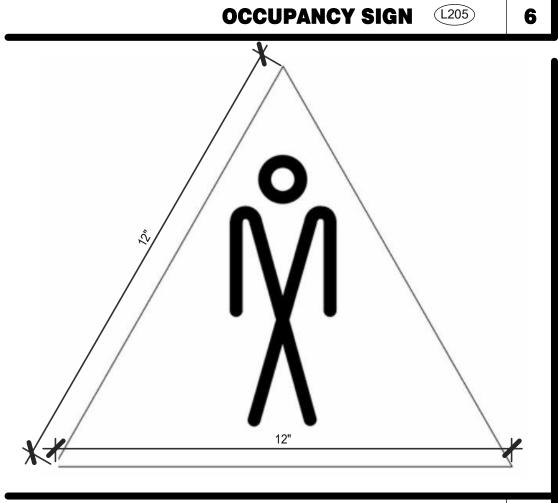



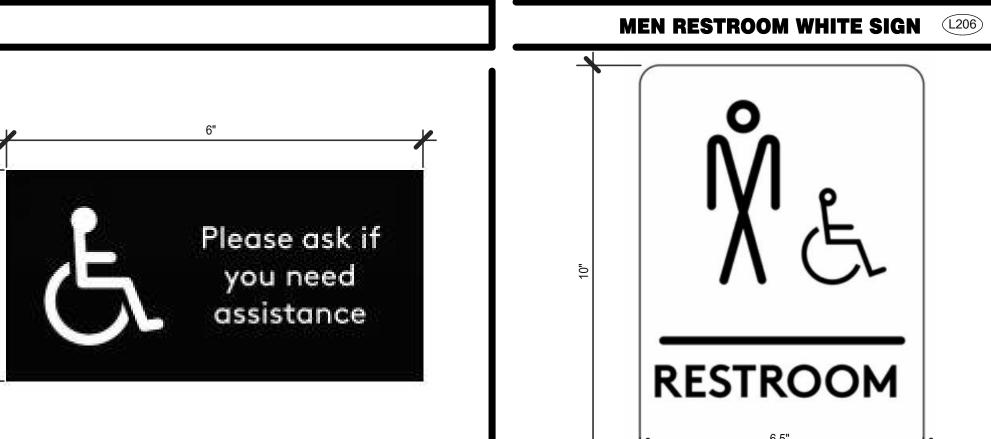

12

IF YOU NEED ASSISTANCE (L233)





	DATE	REMARKS					
	05.06.22	Issued for Permit					
	07.26.22	NTP					
	08.09.22	IFB					
CON	ITRACT DAT	ΓΕ: 04.13.22					
BUIL	DING TYPE	END. 80FT					
PLA	N VERSION:	: MARCH 2021					
BRA	ND DESIGN	IER: DICKSON					
SITE	NUMBER:	315672					
STO	RE NUMBE	R: 455386					
PA/F	PM:	SM					
DRA	WN BY.:	RS					
JOB	NO.:	2021088.52					
	TACO BELL						

TACO BELL

1551 West River Rd. Elyria, OH



ENDEAVOR 2.0 SIGNAGE DETAILS

G4.1

42300.0008



DATE	REMARKS
05.06.22	Issued for Permit
07.26.22	NTP
08.09.22	IFB

CONTRACT DATE: 04.13.22 **BUILDING TYPE:** END. 80FT PLAN VERSION: MARCH 2021 BRAND DESIGNER: DICKSON SITE NUMBER: 315672 STORE NUMBER: 455386 PA/PM: SM DRAWN BY.: JOB NO.: 2021088.52

TACO BELL

1551 West River Rd. Elyria, OH



ENDEAVOR 2.0 SCOPE OF **WORK**

PLOT DATE: 8/9/2022 12:48:55 PM

Manufacturer


Coffee Brewer

Floor and Wall Tile

Bunn

Creative Materials

520 S. MAIN STREET, SUIT 2531 AKRON, OH 44311
330.572.2100 FAX: 330.572.2102

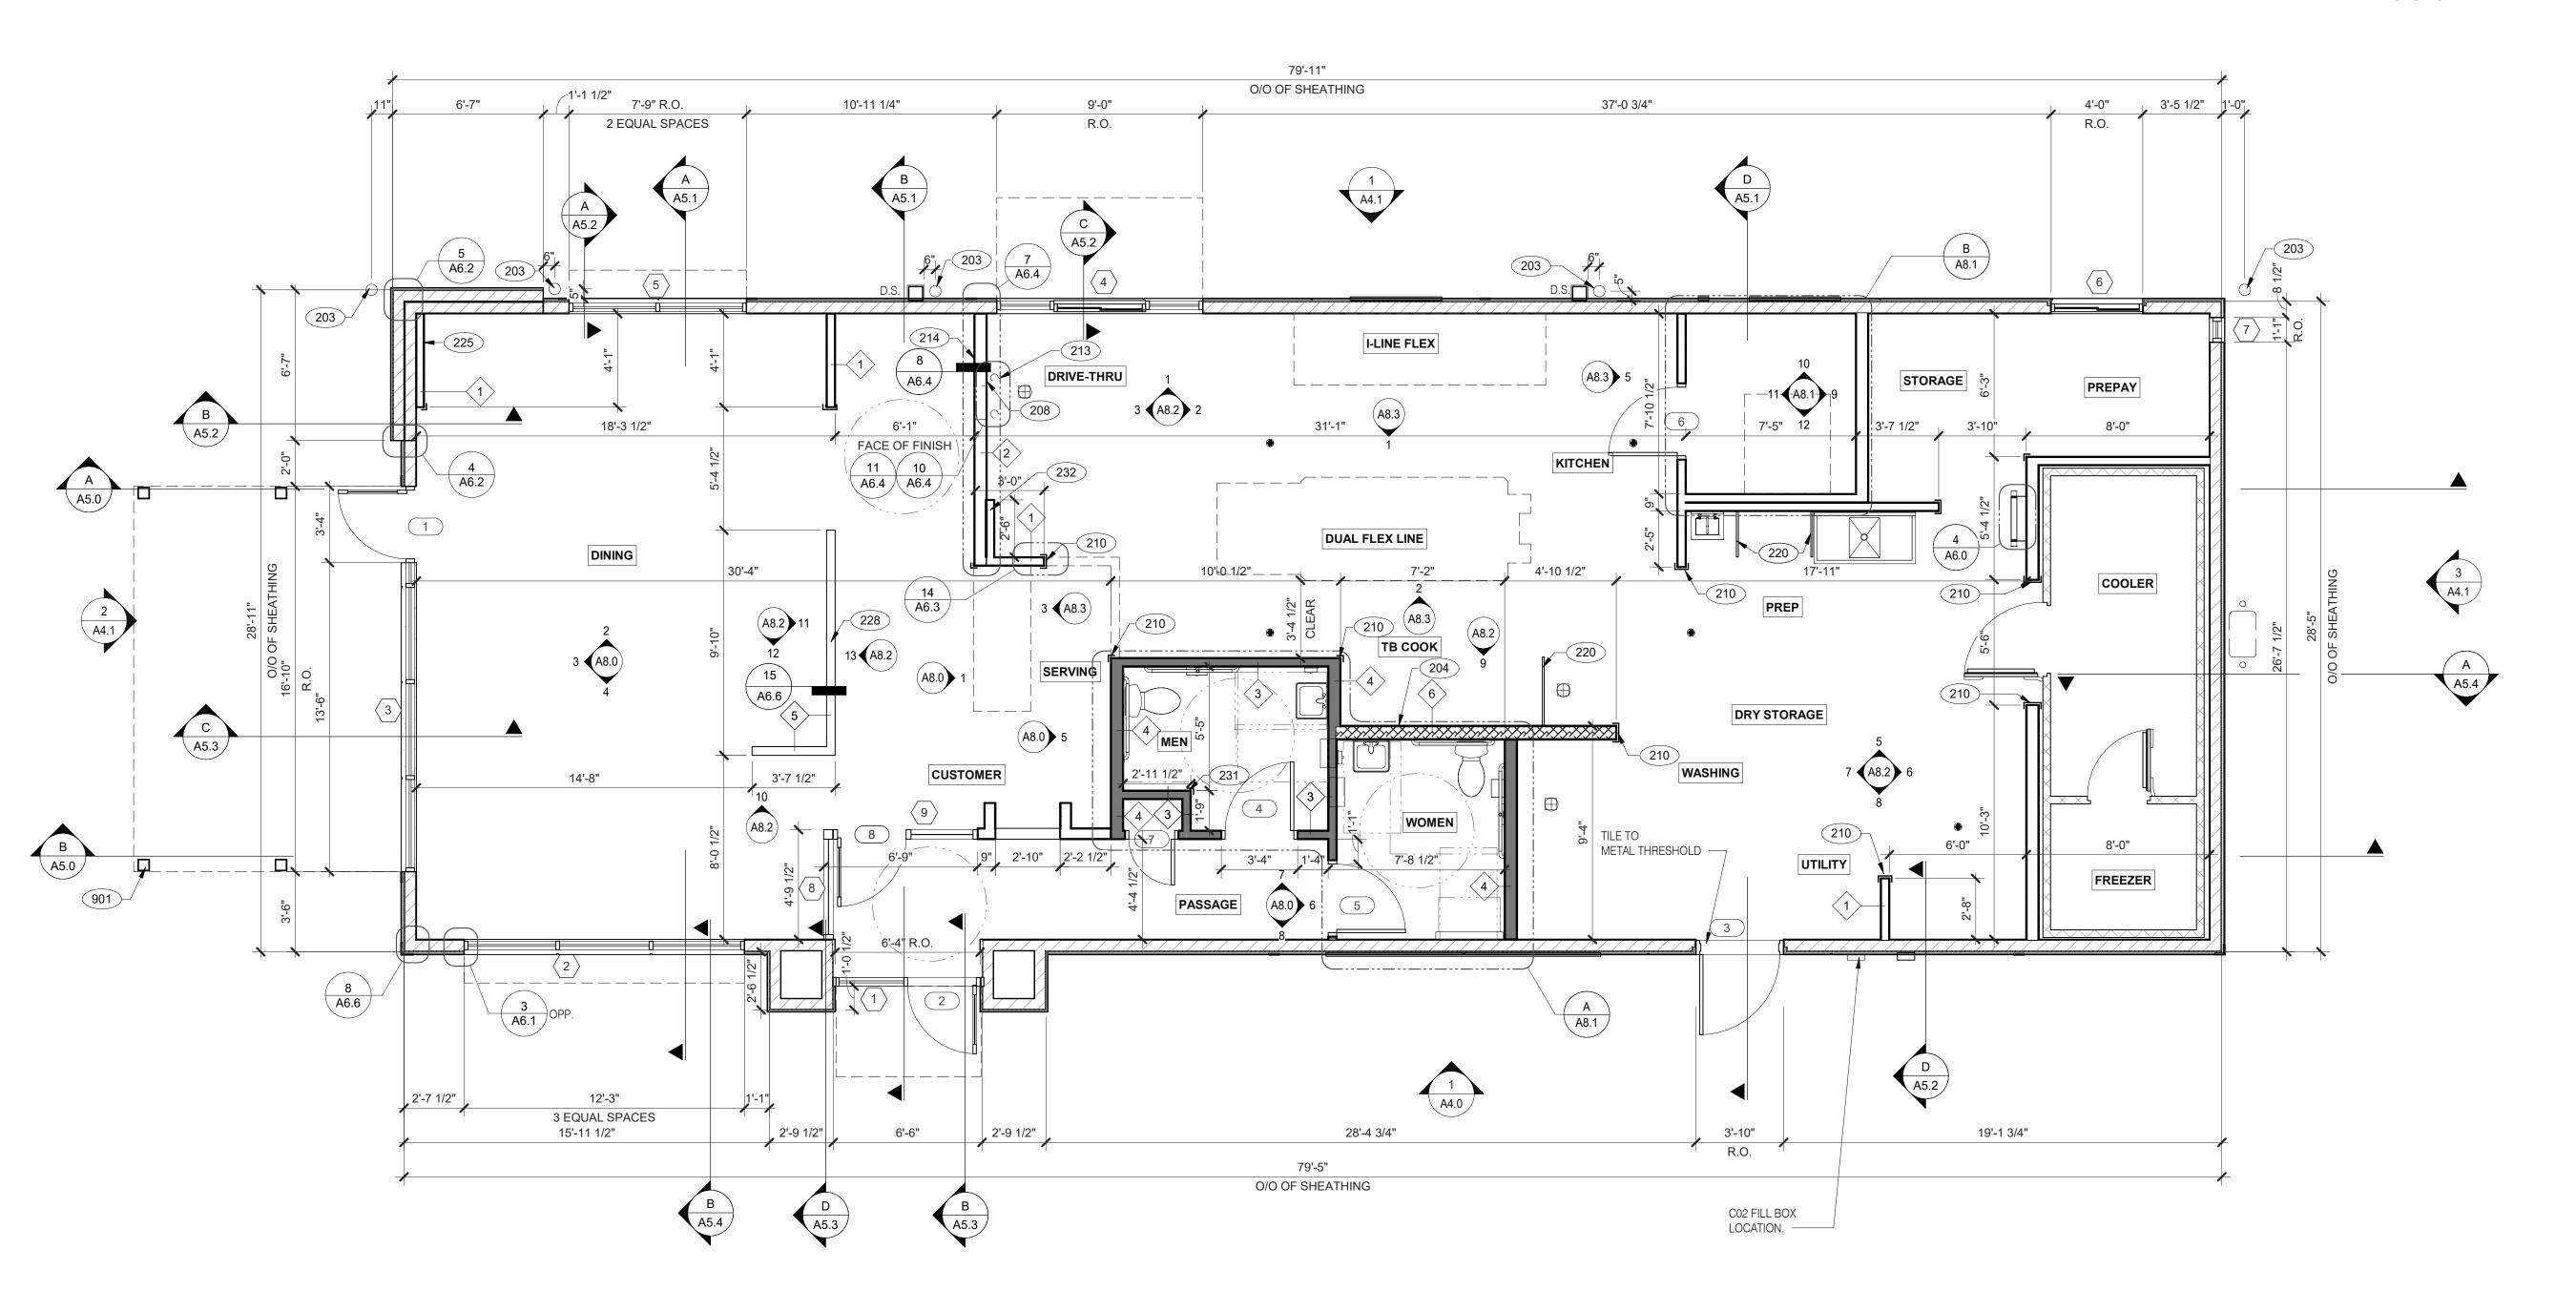

07.26.22 NTP 08.09.22 | IFB CONTRACT DATE:

BUILDING TYPE: END. 80FT PLAN VERSION: MARCH 2021 BRAND DESIGNER: DICKSON SITE NUMBER: 315672 STORE NUMBER: DRAWN BY.

TACO BELL

2021088.52

1551 West River Rd. Elyria, OH



ENDEAVOR 2.0 FLOOR PLAN

2X6 WD STUDS AT 16" O.C. W/ SHEATHING AS SCHEDULED (SEE TYPICAL INTERIOR WALL W/ 3-1/2" UNFACED DIMENSIONS NOTED AS "CLEAR" OR "HOLD" ARE MIN. REQUIRED. NET CLEARANCE FROM FACE OF WALL / WAINSCOT STRUCT. DWGS.) AND R-19 KRAFT-FACED FIBERGLASS BATT FIBERGLASS BATT INSULATION. FINISH. VERIFY FINAL EQUIPMENT SIZES W/ VENDOR PRIOR TO INT. WALL FRAMING. INSULATION U.O.N. GC SHALL PROVIDE 2 LAYERS OF GRADE 'D' 60 3 2X4 WOOD STUDS 4 2X6 WOOD STUDS Ib BUILDING PAPER. WINDOWS / DOORS: A. SEE SHEET A1.1 FOR WINDOW TYPES AND DOOR SCHEDULE. LOW WALL: B. ALL DOOR AND WINDOW OPENING DIMENSIONS ARE TO ROUGH OPENING. WD STUDS AT 16" O.C. AS INDICATED 2X4 WD STUDS AT 16" O.C. AS SCHEDULED (SEE DETAIL 15/A6.6) $\langle 5 \rangle$ 2X4 WOOD STUDS (1) 2X4 WOOD STUDS A. PROVIDE 1/2" THICK CEMENTITOUS BD. FROM FLOOR SLAB TO 12" A.F.F. MIN. IN LIEU OF GYP. BD. AT ALL WALLS EXCEPT SHEARWALL SURFACES, U.O.N. INTERIOR NON-COMBUSTIBLE WALL WITH 20 GA. S.S. PANEL BEHIN 2 > 2X6 WOOD STUDS ALL JOINTS, GAPS OR SPACES LEADING TO ALL HOLLOW OR INACCESSIBLE SPACES SHALL BE SEALED WITH "NSF HOOD. EXTEND MIN. 18" BEYOND END OF HOOD. M. STUD FRAMING INTERNATIONAL" APPROVED SEALANTS. REFER TO DETAIL 2/M3.0 FOR EXTENT OF S.S. PANEL. C. ALL BACK OF HOUSE AND OFFICE WALLS SHALL HAVE 1/2" CDX PLYWOOD SUBSTRATE, U.O.N. < 6 > 6" METAL STUD ALL INTERIOR NON-BEARING WALLS GO TO BOTTOM OF TRUSS, U.O.N. REFER TO STRUCTURE. DASHED LINE INDICATES INTERIOR SUBSTRATE A. SEE A2.0 FOR SEATING PLAN AND DETAILS. WALL SUBSTRATES: B. SEE A7.0 FOR FLOOR FINISHES. C. SEE A8.0 - A8.3 FOR WALL FINISHES. 1/2" GYPSUM WALLBOARD FROM FLOOR SLAB TO 6" ABOVE CEILING HEIGHT U.O.N. SEE 6 & 8/A6.3 (NOTE: THE CEMENT BOARD SPECIFICATION IS DESIGNED TO ALLOW THE G.C. FLEXIBILITY.) D. SEE A7.1 FOR CEILING FINISHES. - KITCHEN WALLS AND DINING ROOM CLOSET: 1/2" CEMENT WALLBOARD FROM T.O. SLAB T.O. 12" A.F.F. AT 12" A.F.F., USE 1/2" CDX PLYWOOD W/FRP SURFACE FINISH TO 6" ABOVE CEILING HEIGHT U.O.N. IF DOUBLE SIDE SHEAR WALL PLYWD IS SPECIFIED THE PLYWOOD SHALL BE CONTINUOUS FROM SILL PLATE TO TOP PLATE. SEE 4/A6.3. A. PROVIDE THREE FIRE EXTINGUISHERS - (2) 10 lb. BC AND (1) 10 lb. ABC - TO COMPLY WITH LOCAL FIRE CODE. LOCATE - RESTROOM WALLS: PER DIRECTION OF FIRE MARSHALL OR LOCAL AUTHORIZING AGENT. FOR ADDITIONAL INFORMATION SEE SHEET A2.0 5/8" CEMENT WALLBOARD FROM T.O. SLAB OR T.O. CONCRETE CURB TO 48" A.F.F., WITH 5/8" HI-IMPACT BRAND XP WALLBOARD, TYPE X CORE FROM T.O. CEMENT BOARD TO 6" ABOVE CEILING HEIGHT DRAWINGS ARE BASED UPON WOOD FRAMING. UTILIZATION OF METAL STUDS ON NON-BEARING INTERIOR U.O.N. NO SUBSTITUTIONS ALLOWED. FINISH AS SCHEDULED. PARTITONS, BULKHEADS AND SOFFITS IS ACCEPTABLE. - <u>ALL OTHER FRAME WALL CONDITIONS:</u>

WALL LEGEND

PIPE BOLLARD. SEE CIVIL DRAWINGS.

HOOD WALL, SEE WALL LEGEND.

208 KEEP CLEAR FOR UTILITIES & SYRUP LINES.

210 S.S. CORNER GUARD/WALL CAP [TM-2], TYP. ALL CORNERS IN BACK OF HOUSE FROM REAR WALL TO THE KITCHEN SIDE OF

THE SERVICE COUNTER. SEE DETAIL 14/A6.3.

213 SYRUP LINE CHASE (ABOVE). 14"x14" HORIZONTAL OPENING FOR SYRUP TUBES.

COORDINATE WALL PENETRATION WITH COUNTER INSTALLER. SEAL CHASE TO COUNTER.

220 SPLASH GUARD. SEE DETAIL 9/A6.3.

FUR OUT WALL AS INDICATED WITH 2X4 WOOD STUDS AT 16"

228 LOW WALL, BY G.C. COORDINATE WITH STRUCTURAL DRAWINGS

CORNER GUARD TILE SCHLUTER. SEE DETAIL 15/A6.3.

FURR OUT WALL W/ 2X4 WOOD STUDS BEHIND HAND SINK. 901 CANOPY COLUMN. SEE STRUCTURAL DRAWINGS.

A. $\,$ ALL DIMENSIONS NOTED ARE TO FACE OF CONCRETE FOUNDATION, FACE OF SHEATHING ON EXTERIOR WALLS, AND

FACE OF FINISH ON INTERIOR WALLS U.N.O.

FLOOR PLAN NOTES

D

KEY NOTES

FLOOR PLAN 1/4" = 1'-0"

TYPICAL EXTERIOR WALL:

1/2" CEMENT WALLBOARD FROM T.O. SLAB OR T.O. CONCRETE CURB TO 48" A.F.F., WITH 1/2" GYPSUM WALLBOARD FROM T.O. CEMENT BOARD TO 6" ABOVE CEILING HEIGHT U.O.N. FINISH AS SCHEDULE

1. DIMENSIONS ON THIS DRAWING ARE TO ROUGH OPENING. ADJUST FRAME DIMENSION TO MAINTAIN 3/8" SEALANT JOINT.

2. SEE SCHEDULE FOR GLASS TYPES.

3. REFER TO FLOOR PLAN, ELEVATIONS AND WALL SECTIONS FOR ROUGH OPENING DIMENSIONS.

4. ALL STOREFRONT MATERIAL AND GLAZING SHALL BE SUPPLIED AND INSTALLED BY G.C., U.O.N.

NATIONAL ACCOUNTS SUPPLIER

NTERIOR DOORS, FRAMES & HARDWARE

OCKNET CONSTRUCTION@LOCKNET.COM 800 JOHN C. WATTS DR. NICHOLASVILLE, KY 40356

JIM CAMPBELL D. 614-358-7806

HAMILTON PARKER

E-MAIL: JIM CAMPBELL@HAMILTON PARKER.COM 55-432-4613 FAX: 877-887

STOREFRONT SPECIFICATION

OLD CASTLE G-3000

GLAZING VITROGLAZINGS SOLARBAN 90 SOLAR CONTROL LOW-E GLASS

(D) SAFETY GLASS BY MFR.

SEE EXTERIOR ELEVATIONS FOR STOREFRONT COLOR

GLASS SCHEDULE

(A) 1" INSULATED GLASS

B 1" INSULATED TEMPERED GLASS

C 1/4" TEMPERED GLASS

SHADING COEFFICIENT SPECIFICATION PER LOCAL CODE REQUIREMENTS. DAYTIME VISIBILITY INTO DINING ROOM SHALL BE MAINTAINED.

3'-0" 7'-0" 1 3/4" A AL AL X

ALL STOREFRONT GLAZING SHALL BE LOW "E" SOLAR GLASS**

LAMINATE DOORS 4, 5, 6 & 7 AND PAINT FRAMES 3, 4, 5, 6 & 7. SEE INTERIOR ELEVATION, SHEET A8.0, A8.1 & A8.2.

CAUTION: IF THIS SHEET IS NOT 22"x34" IT IS A REDUCED PRINT

GPD GROUP

520 S. MAIN STREET, SUIT 2531

AKRON, OH 44311
330.572.2100 FAX: 330.572.2102

2. ALL HARDWARE SHALL BE US32D U.O.N.

3. ALL HM FRAMES SHALL BE 16 GA. STEEL U.O.N.

4. ALL LOCKS SHALL BE FALCON 6 PIN INTERCHANGEABLE CORE SUPPLIED AND INSTALLED BY THE G.C. ALL EXTERIOR LOCKS SHALL BE PROVIDED WITH CONSTRUCTION CORES. ALL PERMANENT CORES SHALL BE KEYED ALIKE.

5. PERMANENT CORES SHALL BE SHIPPED TO THE RESTAURANT GENERAL MANAGER.

6. MOUNT DOOR CLOSERS ON RESTROOM OR KITCHEN SIDE ONLY.

LOCKNET SECURITY DOOR. COMPLETE DOOR, FRAME, AND HARDWARE PACKAGE PROVIDED BY RSCS FACILITIES CONNECTIONS.

PROVIDE PUSH/PULL PLATES. IF REQUIRED BY LOCAL CODE, STOREFRONT DOOR PANIC HARDWARE SHALL BE: DOR-O-MATIC 2092 RIM PANIC HARDWARE AND EXTERIOR PULLS WITH QUALITY #520 DOOR PULL.

9. MOUNT KICKPLATE ON PUSH SIDE ONLY.

10. MAXIMUM DOOR OPERATING PRESSURE: 5 LBS INTERIOR, 8.5 LBS EXTERIOR.

11. ADA COMPLIANT ACCESSIBILITY SIGNAGE, INCLUDE BRAILLE AS REQUIRED BY LOCAL JURISDICTION - (1) MEN, (1) WOMEN. SEE G4.0.

12. RESTROOM SIGN REQUIRED. SEE G4.0.

13. INSTALL WITH APPLIED DOORS STOPS AND WEATHER STRIPS.

14. FRAMES SHALL BE PAINTED. SEE INTERIOR OR EXTERIOR ELEVATIONS.

15. PROVIDE LATCH AND STRIKE PLATE HARDWARE BY DOOR MFR. TO BE COMPATIBLE WITH LOCK.

16. NOT USED.

17. NOT USED.


18. GC TO TRIM DOOR SWEEP TO FIT DOOR.

DOOR SCHEDULE NOTES NOTES

CLOSERS KICK THRESHOLD DOOR STOP LOCKS MISCELLANEOUS DOOR SIZE BUTTS **DETAIL LOCATIONS ROOM NAME** DOOR NOTES NO. 1 2 3 4 1 2 3 4 5 6 7 1 2 3 1 2 3 1 2 3 1 2 3 4 5 6 * LESS THAN DOOR WIDTH 3'-0" 7'-0" 1 3/4" A AL AL X 10/A6.1 8, 10, 13, 15 2 ENTRANCE 10/A6.1 8, 10, 13, 15 |X| |X|X|3 KITCHEN 1 3/4" C HM HM 7/A6.1 | 11/A6.1 | 8/A6.1 | 6, 7, 10, 14, 18 X X 6/A6.4 6/A6.4 4 MEN 6, 9, 10, 11, 12, 14 X X X X XX X X X 6/A6.4 6/A6.4 6, 9, 10, 11, 12, 14 6/A6.4 6/A6.4 6/A6.4 6/A6.4 7 CLOSET 2'-0" 7'-0" 1 3/4" F WD HM 9 BOTH SIDES, 14

DOOR SCHEDULE

10, 13

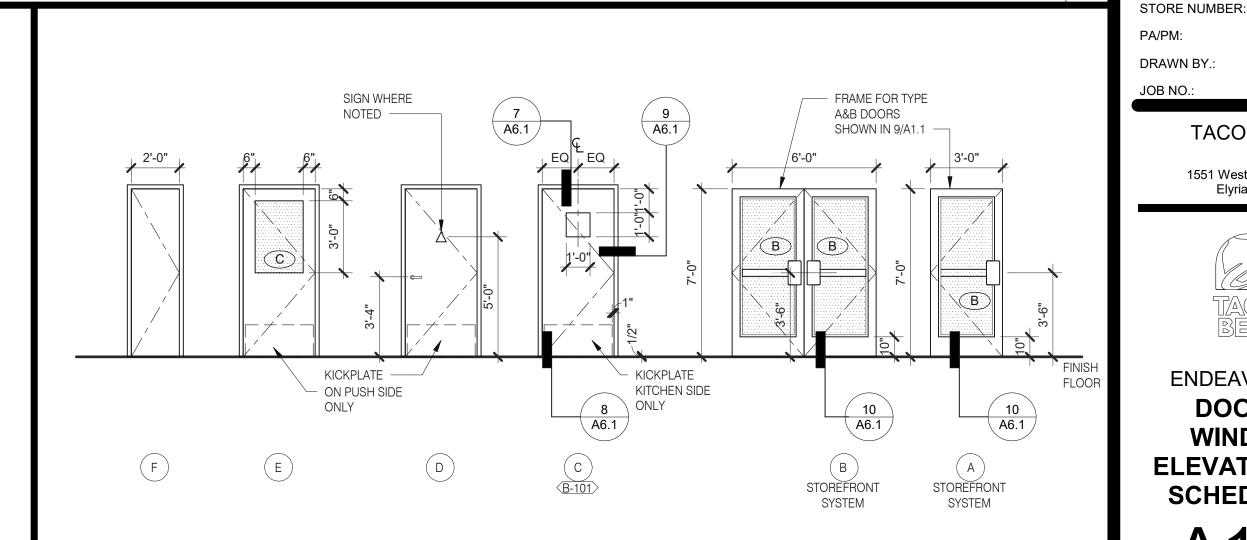

NOTE: ELEVATIONS DRAWN AS VIEWED FROM EXTERIOR OF BUILDING.

8 PASSAGE

WINDOW TYPES 1/4" = 1'-0" **9**

NOTE: ELEVATIONS DRAWN AS VIEWED FROM EXTERIOR OF BUILDING OR OUTSIDE ROOM. **DOOR TYPES**

ELEVATIONS & SCHEDULES

ENDEAVOR 2.0

DOOR &

WINDOW

07.26.22 NTP

08.09.22 IFB

END. 80FT

2021088.52

MARCH 2021

CONTRACT DATE:

BUILDING TYPE:

PLAN VERSION:

SITE NUMBER:


BRAND DESIGNER:

TACO BELL

1551 West River Rd. Elyria, OH

PLOT DATE: 8/9/2022 12:46:56 PM



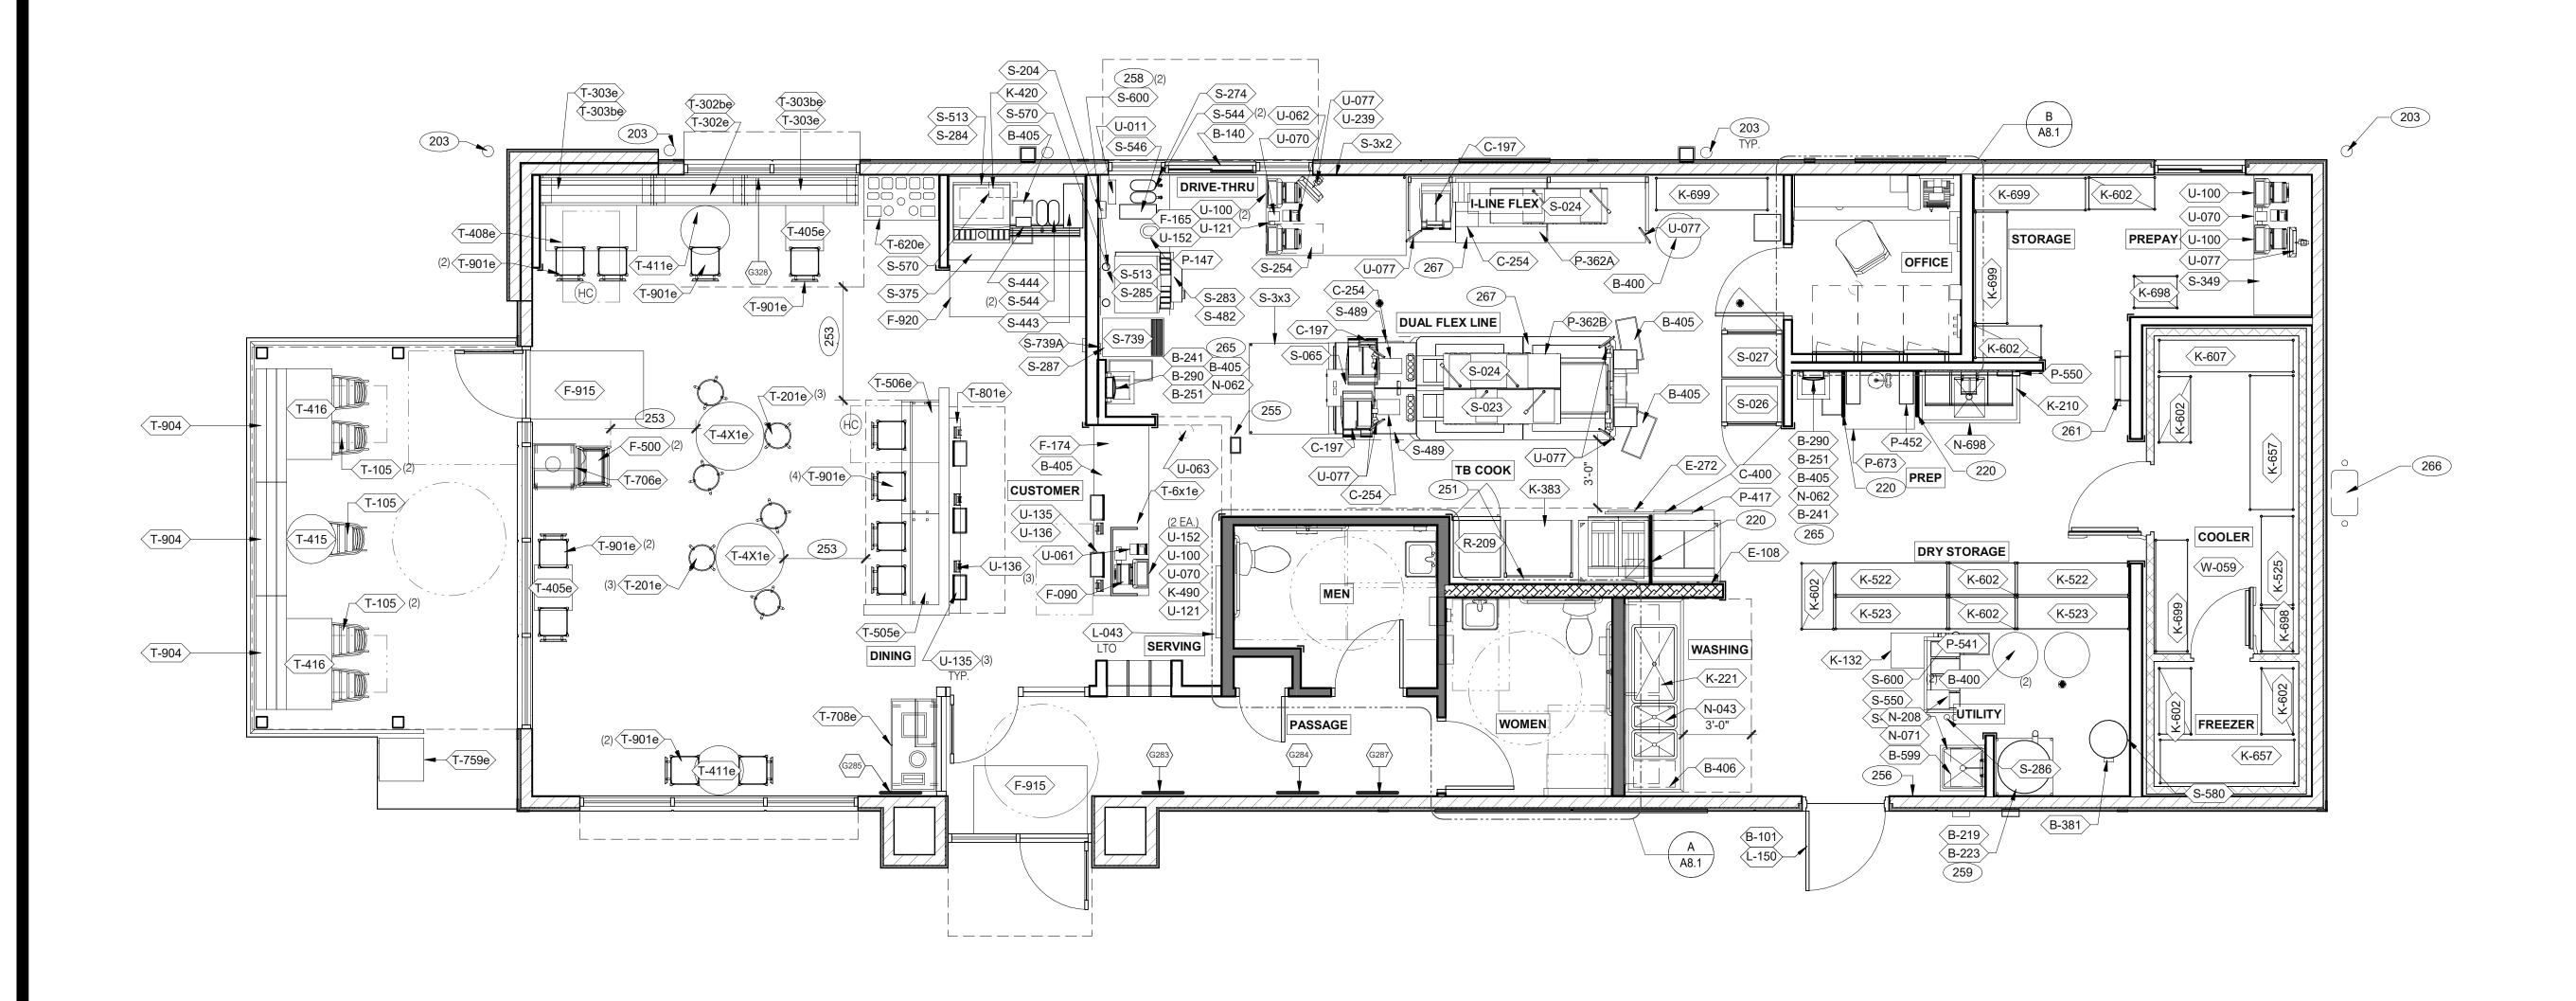



BRAND DESIGNER: DICKSON SITE NUMBER: 315672 STORE NUMBER: PA/PM: DRAWN BY.: 2021088.52

04.13.22

END. 80FT

07.26.22 NTP 08.09.22 IFB

TACO BELL

1551 West River Rd. Elyria, OH



ENDEAVOR 2.0 EQUIPMENT AND SEATING PLAN

PLOT DATE: 8/9/2022 12:47:03 PM

EQUIPMENT AND SEATING PLAN 1/4" = 1'-0"

WHEN AISLE SERVES MORE THAN 50 SEATS).

255 ALERT LIGHT BOX FOR 3-COMP POWER SOAK.

HOOD FIRE SUPPRESSION SYSTEM (ANSUL R-102 OR EQUAL).

253 MAINTAIN 36" MIN. CLEAR ACCESSIBLE AISLE EGRESS PATHS TO EXIT

DOORS, 32" AT DOORWAYS AND CASED OPENINGS. (42" AISLE REQUIRED

KEY NOTES

203 PIPE BOLLARD. SEE CIVIL DRAWINGS.

220 SPLASH GUARD. SEE DETAIL 9/A6.3.

TAG	QTY	ITEM DESCRIPTION	TAG
T-4X1e	2	SS TABLE - 36 DIA X 30	T-706
T-6x1e	1	GO MOBILE COUNTER	T-708
T-105	5	RETRO CHAIR - 18	T-759
T-201e	6	BARREL BARSTOOL - 29 PURPLE WOOD SEAT	T-801
T-302be	1	BENCH BACK REST - 60"	T-901
T-302e	1	BENCH SEAT - 48"	T-904
T-303be	2	BENCH BACK REST - 60"	
T-303e	2	BENCH SEAT - 60"	
T-405e	2	LAMINATE TABLE - 24 X 20 X 30 - 2 TOP	
T-408e	1	LAMINATE TABLE ADA - 24 X 48 X 30 - 4 TOP	
T-411e	2	SS TABLE - 24 DIA X 30 - 2 TOP	
T-415	1	SS TABLE - 24 DIA X 30 - 2 TOP	
T-416	2	LAMINATE TABLE ADA - 24 X 48 X 30 - 4 TOP	
T-505e	1	COUNTER TOP - 48" X 20" X 30"	

1 COUNTER TOP - 60" X 20" X 30"

1 CONDIMENT COUNTER - RECTANGLE

TAG	QTY	ITEM DESCRIPTION
Г-706е	1	WASTE ENCLOSURE - SINGLE
Г-708е	1	WASTE ENCLOSURE - 3 STREAM
Г-759е	1	WASTE ENCLOSURE - SINGLE
Г-801е	1	KIOSK 1/2 TOWER
Г-901е	12	CHAIR - LAMINATE SEAT
Γ-904	6	BENCH SEAT - 60"

FURNITURE PACKAGE - BY FURNITURE VENDOR U.O.N.

$\langle x \rangle$	QTY.	NAME	FAMILY	FRAME OR MURAL	SIZE	LOCATION
G328	1	GM - LP MURAL	Е	M01	CUSTOM	SEE A8.0
G283	1	GM - CW	Е	F01	28x40	SEE A8.0
G284	1	GM - BELL	Е	F02	28x40	SEE A8.0
G285	1	GM - ORG	Е	F01	28x40	SEE A8.0
G287	1	GM - CW2	E	F01	28x40	SEE A8.0
(G608)	1	GM - EXT1	Е	M03	TBD	SEE A4.0
		ON THREE SECTIONS O ONE LARGE FRAM				
G523		GM - SKIP THE LINE	E	M02	48x96	SEE A4.1
(G524)		GM - ORDER AHEAD	Е	M02	48x96	SEE A4.1

ARTWORK SCHEDULE

	GENERAL NOTES	C1	256 258 259 261 265	PULL STATION @ 3'-8" A.F.F. COORDINATE LOCATION OF HORIZONTAL PVC SYRUP CHASE THRU WALL TO COUNTER. 6" HIGH WATER HEATER PLATFORM. ROOF LADDER WITH BILCO LADDER UP SAFETY POST. AUTOMATIC HAND SOAP AND SANITIZER DISPENSERS PROVIDED BY ECOLAB.
STORAGE TYPE		LINEAR FT.	267	GAS METER. FOR DUAL-FLEX LINE AND I-FLEX LINE SUB-EQUIPMENT SEE SHEET A8.3.
DRY STORAGE		57		
COLD STORAGE		26		
FROZEN STORAGE		12		
			_	

SHELVING QUANTITIES

1. REFER TO SC SHEETS FOR SCOPE OF WORK RESPONSIBILITY

2. (HC)- SYMBOL DENOTES A HANDICAP ACCESSIBLE TABLE.

		FOLIPME	NT S	SCHEDULE				
						J V		
NSTA NI CO		S S S S S S S S S S S S S S S S S S S		O. INSTA		UMBING ECTRIC,		
B CONTRACTOR BUILDING ELEMENTS	MFR. & MODEL NUMBER 교	료 <mark>형</mark> REMARKS	TAG ;	# ITEM DESCRIPTION	MFR. & MODEL NUMBER		REMARKS	
3-049 1 X ROOF LADDER	PRECISION LADDER #PH-G2-6X3-0			S SERVING/DRIVE-THRU 1 DRIVE-THRU PICK-UP WORKSTATION 30X42	SPG		OPTIONAL:METRO	
3-050	PRECISION LADDER #PH-G-2-6X3-0 RSBS FACILITIES CONNECTION	SECURITY DOOR PER QUOTE LOCKNET TAN STEEL. INCLUDES: STEEL FRAME	S-3x3	1 DRIVE-THRU PICK-UP WORKSTATION 30X48 1 X WARMER, EVO	SPG CARTER HOFFMAN		OPTIONAL:METRO MOUNT ON PRODUCTION LINE OVER SHELF	
3-140 1 X DT WINDOW	QUICKSERV#SC4030BR - SELF CLOSING,	FINISH TO MATCH STOREFRONT, DARK BRONZE	S-024	2 X WARMER, EVO	CARTER HOFFMAN	X	MOUNT ON PRODUCTION LINE OVER SHELF	
3-219 1 X WATER HEATER DUNNAGE RACK	R/H HANDLE, OPENS RIGHT NEW AGE INDUSTRIAL CORP., INC #98147			1 X HEAT CABINET - FULL HEIGTH - (1) RH 1 X HEAT CABINET - FULL HEIGHT - (1) RH	CRESCOR #H137S27D1TB CRESCOR #H137S27D1TB	-	W/8 SHELVES EACH W/ 8 RACKS	
3-223 1 X 98% HIGH EFFICIENCY 199 MBH, 100 GAL. GAS WATER HEATER	A.O. SMITH BTH-199 100 CYCLONE HE			1 X DESSERT TOWER 1 X DRIVE-THRU TIMER SYSTEM	HATCO #GRBW-24D HME #C11422TB	X		
3-241 4 X SOAP DISPENSER (WALL MOUNT) 3-251 2 X SANITIZER DISPENSER (WALL MOUNT)	KAY 3741 KAY 3741		S-254	1 CONDIMENT RACK	PRONTO #CHPWO446			
3-253 2 X PAPER TOWEL DISPENSER/TRASH 12 GAL.	BOBRICK #B-3944		S-283	1 X DRIVE-THRU BEVERAGE WORKSTATION 1 X DRINK STAGER WITHOUT STRAW HOLDER	SPG WST1242YA WST788E		OPTIONAL: METRO	
3-265 2 X MIRROR, 18 x 36 3-275 2 X TOILET PAPER DISPENSER	BOBRICK #B-165-1836 BOBRICK #B-2890			BEVERAGE DISPENSER - SELF-SERVE BEVERAGE DISPENSER - DRIVE THRU	CORNELIUS 611057625 SERVEND	XX	SEE SCOPE OF WORK (PEPSI) SEE SCOPE OF WORK (PEPSI)	
3-290 2 X PAPER TOWEL DISPENSER 3-300 2 X GRAB BAR 1-1/2 DIA. X 42 S.S. FIN.	BOBRICK #B-262 BOBRICK #B6806X42		S-286	1 X WATER FILTER SYSTEM 1 X ISS-TABLE, D/T, TB, 24 IN X36 IN PREASSEMBLED	SHURFLO #WB6-M3-22-003 FBD #1273610021	XX	FRANCHISEES CAN USE SELECTO #TB5/620-5	
3-305 2 X GRAB BAR 1-1/2 DIA. X 48 S.S. FIN. 3-310 2 X GRAB BAR VERTICAL 1-1/2 DIA. X 18 S.S. FIN.	BOBRICK #B6806X48 BOBRICK #B6806X18		S-349	DRIVE-THRU PICK-UP WORKSTATION 30X42	SPG		OPTIONAL:METRO	
3-320 1 CHANGING STATION				1 X DRINK STATION 1 X LID DISPENSER	CARTER-HOFFMAN CAL-MIL ADA TB103	X	S/S, INSULATED DRAIN TROUGH, WEIGHT RATED	
3-381 1 X CO2 CARBON DIOXIDE SENSOR/WARNING 3-400 3 X WASTE BASKET - 32 GALLON	LogiCO2 CO2 MK9 SENSOR RUBBERMAID #2632 (GREY)			1 X NAPKIN DISPENSER 1 CUP DISPENSER	TOR XPRESSNAP #5555100 A.J. ATUNES #DACS60		W/ ANGLED MOUNTING BRICKET OMNITEAM CDB-DTA	
3-405	RUBBERMAID 28 QT #2956 (BLACK)		S-489	2 SCALE	EDLUND	V V	10#X.10Z, ELECTRONIC, EDLUND #DS-10 CSTM; WSM #113464	
3-410 1 X SANITARY NAPKIN RECEPTACLE	RUBBERMAID #6140			2 ICE MAKER (PLACED ON TOP OF DRINK MACHINES) 1 PEPSI BOOSTER TANK	*		W/ROOF MOUNTED CONDENSERS HOSHIZAKI FRANCHISEES CAN USE HOSHISAKI KMS-1230 SEE SCOPE OF WORK (PEPSI)	
3-599 1 X MOP SINK SHELVING C COOKING EQUIPMENT	SPG #WST806Y			4 ICE TEA URN 1 X ICED TEA BREWER	BUNN/TDO-N-3.5	XX		
C-079 1 X DUAL FRYER		X X COMES WITH GAS HOSE KIT (OPTIONAL: PITCO #TB-SSHLV14-2/FD VS7)	S-550	1 BAG-IN-BOX SYRUP RACK	CORNELIUS/REMCOR BNP12B8P	X	FLO-3REG-2CRB (BY PEPSI)	
C-107 1 X RETHERMALIZER C-197 3 X TOASTER, SPLIT LID	PITCO #TB-SRTG14-2 X	X X POWERED BY PRODUCTION LINE - (OPTIONAL: STAR #PSC14DTB)	S-570 S-580	2 CARBONATOR 1 CO2 BULK TANK	CORNELIUS/REMCOR MVE #11805373	XX	SHELF MOUNTED BELOW EACH DRINK (BY PEPSI)	
C-254 3 X CHEESE MELTER (SINGLE)	A.J.ANTUNES #CM-100 X	X POWERED BY PRODUCTION LINE	S-600	4 BUNDLED SYRUP LINES 1 X FROZEN BEVERAGE DISPENSER, REMOTE	CORNELIUS/REMCOR TUBE BUNDLE		SEE SCOPE OF WORK (PEPSI) MUST ORDER REMOTE CONDENSER S-739A FREEZE TRANSFORMER	
C-400 2 X RETHERMALIZER TIMER	FAST #TBZAP12120V		S-739A	1 X FREEZE TRANSFORMER		X		
E-108 1 X STROTEVENT 106 IN. H X 111 IN. L BACK SPLASH			S-740	1 X FROZEN BEVERAGE CONDENSER, REMOTE	FBD #12-3003-0006	X X	40 IN X 17 IN X 21 IN 208 SINGLE PHASE 2 WIRE 15 AMP, 105LB	
E-272 1 X TIMER OUTLET	#BACKSPLASH106X111FLA							
F OFFICE/EMPLOYEE/MUSIC/MISCELLANEOUS				U SECURITY/COMMUNICATIONS/FIRE PROTECTION/POS				
F-014 1 X FILE CABINET (2 DRAWER HIGH) 18X36X27H	HON #582LL			1 BASE STATION - D/T COMM. SYSTEM	HME #C40000-5-HS3-TB			
F-021 1 X CHAIR - OFFICE F-022 1 X LICENSE FRAME (BLACK)	HON #4609AB10 CREATIVE PALETTE TB30	IN OFFICE AREA, SEE SHEET A8.2 X IN OFFICE AREA		1 X SECURITY SYSTEM 1 CREDIT CARD READER	ADT #3BCZTB	X		
F-026 1 X DESK LAMP	TBD	IN OFFICE AREA, SEE SHEET A8.2	U-062 2	2 DRIVE-THRU CREDIT CARD READER	VERIFONE P400	X		
F-030 1 X COAT HOOK F-040 1 OFFICE COMPUTER		X IN OFFICE AREA X IN OFFICE AREA, SEE SHEET A8.2		2 ALARM SENSOR 3 RECIEPT PRINTER	EPSON	X	2 FOR F/C AND 1 D/T 5.71 IN X 7.68 IN X 5.83 IN	
F-050 1 CREDIT CARD SATELLITE ROUTER JUNCTION F-060 1 MONITOR - OFFICE	YUM			2 ATOM SERVER B TABLET 10.1"	EN POINTE TECHNOLOGIES EN POINTE TECHNOLOGIES - TABLET	X	12V DC 60W SYSE3029ARS011-CSP	
F-080 1 OFFICE PRINTER/COPIER/FAX/SCANNER	POS PROVIDED	X X		5 POS/ORDER ENTRY TERMINAL	E611101	V	2 FOR F/C AND 1 D/T	
F-090 5 UPS (UN-INTERUPTABLE POWER SUPPLY) F-102 1 X MONEY COUNTER	T GOT TIO VIBEB	X IN OFFICE AREA	U-121	3 CASH DRAWER BRACKETS	#SU186075Y	-	2 PER CASH DRAWER	
F-131 1 SPEAKERS F-165 3 X FRONT LOAD SAFE				5 KIOSK TABLET 5 VERIFONE (CREDIT CARD MACHINE	SSP SSP	X		
F-174 1 SAFE WITH TOUCH SCREEN CONTROLS		X X	U-152	2 CASH DRAWER	IBM, NCR & PAR		2 FOR F/C AND D/T	
F-211	B&B SYSTEMS #02100100 LYON WORKPLACE 12" X 18" X 78" GREY	IN OFFICE AREA, SEE SHEET A8.2 X	0-239 7	2 MONITOR CEILING MOUNTED BRACKET	IBM, NCR & PAR			
F-270 1 X FIRST AID KIT F-500 1 STACKABLE HIGH CHAIR	PROSTAT FIRST AID LCC #2617	X IN OFFICE AREA						
F-504 1 DVR & MONITOR				W WALK-IN COOLERS/FREEZERS				
F-915 2 FLOOR MAT F-920 1 RUBBER MAT	CREWSAFE, ENTRANCE I #41150012 CREWSAFE, WSM#800507	RUBBERIZED - 3'-5', RIBBED, CHARCOAL, WSM #800503 RUBBERIZED - BLACK 2X8, 1/4 NON SLIP CORRUGATED TOP & RUBBER NO-SLIP BACK ENTRANCE		1 X WALK-IN	ICS/NORLAKE #105181	XX	COMBO, TB, #105181, BUDGETARY 19-4X7X9-2 OAD, MEDIUM BUILDING PROTOTYPE, INCLUDES LED	
IVANORIZATIONO/OUTINA/OARTO				D DEEDLOED ATION				
K WORKSTATIONS/SHELVING/CARTS	SPG / ISS (Alternate: METRO)	#WST1434Y		R REFRIGERATION	DELFIELD #GBF1P-SH-TB2		OPTION: LEFT HINGED VERSION - DELFIELD #GBF1P-SH-IK-TB2	
K-132 1 CART, CLOSING MADE SIMPLE K-210 1 PREP SINK WORKSTATION 50 TRACK	SPG / ISS (Alternate: METRO)	#WST255E, Wall Trax System for 1-Comp Sink, 16X50X40 + ACC	N-209	1 FRY STATION REACH-IN FREEZER (RIGHT HINGED)	DELFIELD #GDFTF-5H-1B2	^	OPTION. LEFT HINGED VERSION - DELFIELD #GBFTF-SH-IK-TB2	
K-221 1 X 3 COMP SINK WORKSTATION 96 TRACK K-383 1 FRY WORKSTATION 30D x 78H x 36 in.	SPG / ISS (Alternate: METRO) SPG / ISS (Alternate: METRO)	#DS1F, Wall Trax System for 3 Comp Sink, (3) 18X24 GRIDS + ACC #WST1724E, 36 in. Crispy Frystation						
K-420 1 SHELF, BEV PLATFORM 18X24	SPG / ISS (Alternate: METRO)	#WST34Y: F/CARBONATOR, &/OR RECIRC PUMP						
K-490 2 SHELVING 18x24x24, 2-TIER K-522 2 SHELVING, 18x60x76, 5-TIER, SMALL PACKAGING	SPG / ISS (Alternate: METRO) SPG / ISS (Alternate: METRO)	#WST440Y #WST1548Y						
K-523 2 SHELVING, 18x60x76, 3-TIER, CUP & LID K-525 1 48X18 5 - TIER RACK SHELVING	SPG / ISS (Alternate: METRO)	#WST1580Y						
K-602 8 SHELVING, 18x36x86, 5-TIER, DRY STORAGE	SPG / ISS (Alternate: METRO)	#WST238Y						
K-607 1 SHELVING K-657 2 X SHELVING 24x72x86, 5-TIER	SPG / ISS (Alternate: METRO) SPG / ISS (Alternate: METRO)	#SU247285Y: WALK-IN COOLER 24X72X86						
K-698 2 SHELVING 18X24X74, 5-TIER K-699 4 SHELVING 18x60x74, 5-TIER	SPG / ISS (Alternate: METRO) SPG / ISS (Alternate: METRO)	#SU186075Y #SU186075Y						
L LIGHTING/SIGNAGE/MENUBOARDS	, , ,	1 1 1						
-043 1 DIGITAL MENU BOARD	STRATACACHE, LG 43" DISPLAY		\neg					
-150 1 X SECURITY DOOR DANGER SIGN	ADVERCO#ADVCUSTOM	ORDERED DIRECT FROM YRFS						
N SINKS/DISHWASHER			_					
N-043 1 X 3-COMP POWER SOAK 102 N-062 2 X STAINLESS STEEL WALL MOUNTED SINK WITH FAUCET	AERO #HS-MOD X	X GEN IV POWERSOAK INCLUDES T&S FAUCET #B-2475-PS-OH (FRANCHISE OPTION: GEN III)	_					
N-071 1 X MOP SINK FAUCET N-130 1 X 1 COMP PREP SINK FAUCET	T&S B-2465 X	FRANCHISE OPTION N-134: T&S B-2465						
N-130 1 X 1 COMP PREP SINK FAUCET N-141 2 X WALL MOUNTED LAVATORY	AMERICAN STANDARDS BRAND X	WHITE VITREOUS CHINA WALL MOUNTED LAVATORY WITH ACCESSORIES. N-141 IS METERED FAUCET, FAUCET, LAVATORY, CENTERSET MIXING,						
N-146 2 X FAUCET (RESTROOMS)	T&S FAUCET B-0831-WA X	#B-0890-WS 2" TWIST TYPE FOR N-698						
I-171 1 LEVER WASTE DRAIN I-208 1 X MOP SINK	X AERO #3MP-2121-6/1P X	INCLUDES (2) 24X36 WALL PANELS						
I-698 1 X 1 COMP PREP SINK 53W X 27D X 35 1/2H	1=50 #2=121115	INCLUDES (2) 24A30 WALL FAINELS						
P FOOD PREPARATION								
2-147 1 BUNN COFFEE BREWER	MCA BLK Single Serve #35400.0005							
2-315 1 X REVERSE OSMOSIS SYSTEM	3M #56123-06, FSTM-075	INSTALL OVER FLOOR SINK						
P-362A 1 X FLEX LINE, L-R P-362B 1 X FLEX DUAL LINE	FRANKE X							
P-417 1 X 8-CHANNEL TIMER	FAST #KTRACK2X4TB							
P-452 2 X HOT WATER SYSTEM P-541 1 STORAGE BINS	B4B SYSTEMS #03070100	X Each System= Water Heater #43600.0014, Bracket #13125.0003, Shelf#12599.0000, Scale Inhibitor #39000.0001						
P-550 1 X KNIFE RACK	EDLUND #KR-699							
P-673 1 WORK TABLE								



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DATE REMARKS
05.06.22 Issued for Permit
07.26.22 NTP
08.09.22 IFB

CONTRACT DATE: 04.13.22
BUILDING TYPE: END. 80FT
PLAN VERSION: MARCH 2021
BRAND DESIGNER: DICKSON
SITE NUMBER: 315672
STORE NUMBER: 455386
PA/PM: SM
DRAWN BY.: RS
JOB NO.: 2021088.52

TACO BELL

1551 West River Rd. Elyria, OH




ENDEAVOR 2.0
EQUIPMENT
SCHEDULE

A2.1





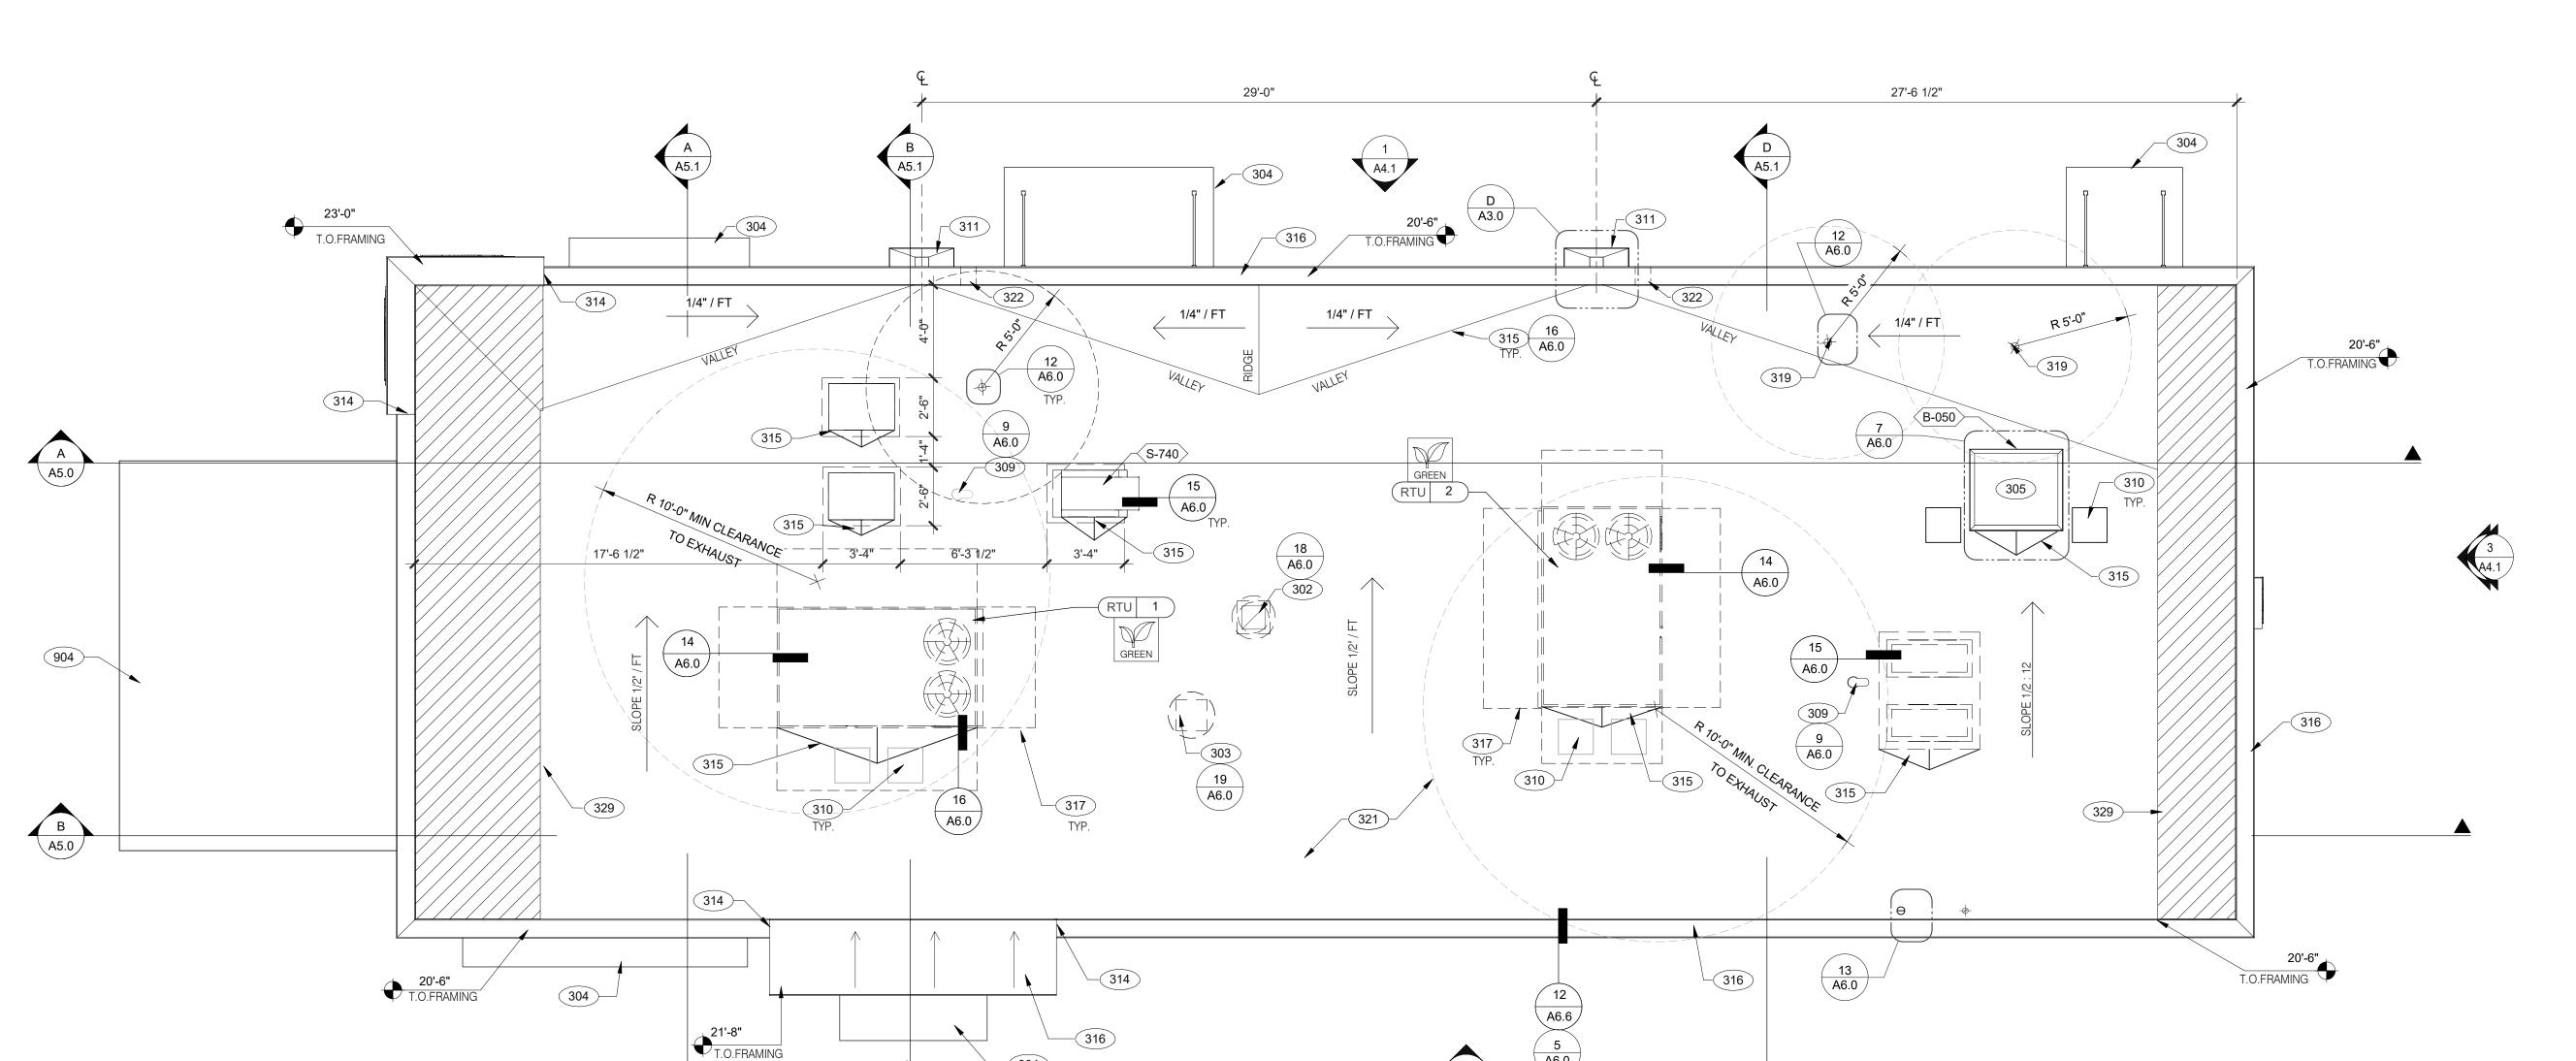



WASTE VENT THROUGH ROOF. THE TOP OF WASTE VENTS SHALL BE 12"

LOCAL JURISDICTION. SEE DETAIL 12/A6.0 FOR FLASHING ASSEMBLY.

'DURO-LAST' SINGLE PLY ROOF MEMBRANE OVER MINIMUM R-35 RIGID INSULATION BOARD OVER 5/8" APA RATED EXTERIOR GRADE PLYWOOD OVER TRUSSES. INSTALL PER MANUFACTURER'S SPECIFICATIONS.

PATIO CANOPY, PROVIDED AND INSTALLED BY G.C. SEE SHEET A9.0 FOR

OVERFLOW SCUPPER. SEE DETAIL D/A3.0.

KICKERS, SEE STRUCTURAL DRAWINGS

HIGHER THAN THE CLOSEST PARAPET CAP U.N.O. OR NOT ALLOWED BY

BRAND DESIGNER: DICKSON
SITE NUMBER: 315672
STORE NUMBER: 455386
PA/PM: SM
DRAWN BY.: RS

07.26.22 NTP 08.09.22 IFB

TACO BELL

2021088.52

1551 West River Rd. Elyria, OH




ENDEAVOR 2.0 ROOF PLAN

A3.0

PLOT DATE: 8/9/2022 12:47:12 PM

KEY NOTES

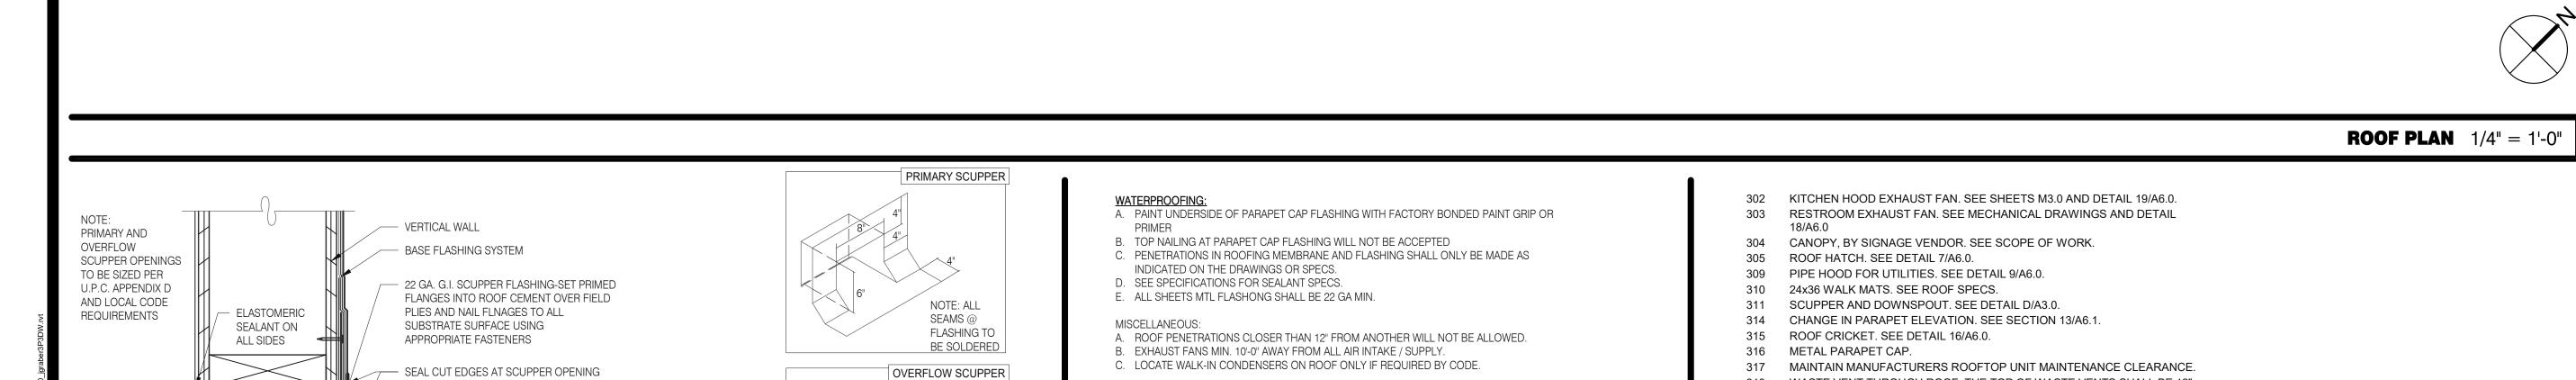

ROOF PLAN NOTES

C

SEAMS @

* DESIGN AND SIZE PER LOCAL REQUIREMENTS

SCUPPER FLASHING

FLASHING TO

BE SOLDERED

D

USING WOVEN GLASS FABRIC EMBEDDED

- ROOFING SYSTEM

CONDUCTOR


HEAD

INTO AND COVERED WITH FLASHING CEMENT

CAP SHEET

FLASHING SHEET

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A. SEE SHEET A1.1 "WINDOW TYPES" FOR WINDOW ELEVATIONS.

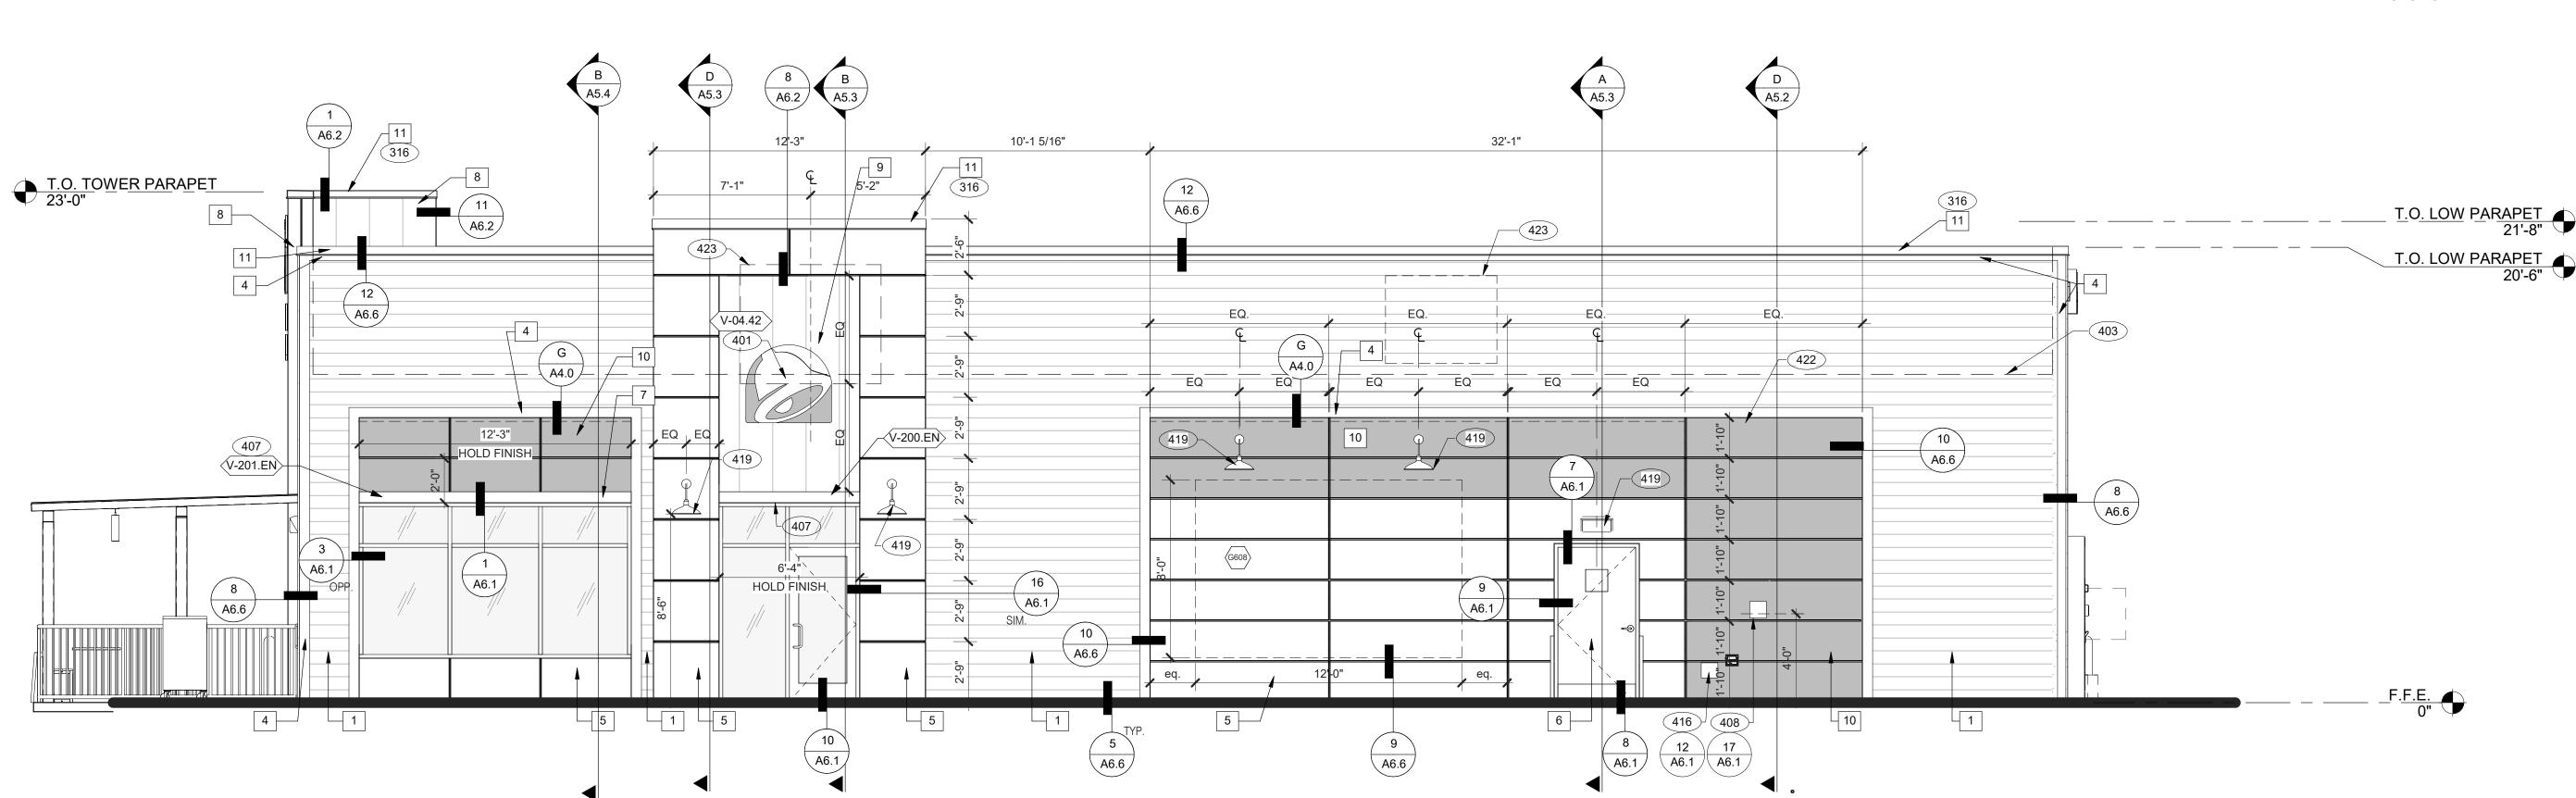C. APPLY NEOPRENE GASKET (CONT.) BETWEEN BUILDING AND CANOPY.

A. REQUIRED CLEAR OPENING WIDTH TO ENSURE COORDINATION WITH STANDARD

B. SEALANT AT ALL WINDOW AND DOOR FRAMES AND JAMB. DO NOT SEAL SILL @ WINDOWS.

NOTE: NO EXTERIOR SIGNS ARE WITHIN THE SCOPE OF WORK COVERED BY THE BUILDING PERMIT

GENERAL NOTES

APPLICATION. THE GENERAL CONTRACTOR SHALL BE RESPONSIBLE FOR COORDINATING THE

INSTALLATION OF ALL EXTERIOR SIGNS AND INSTALLATION OF REQUIRED BLOCKING AND

A. SEALANT AT ALL WALL AND ROOF PENETRATIONS.


ELECTRICAL CONNECTIONS FOR FINAL APPROVED SIGNS.

SIGNAGE/BUILDING ELEMENTS DIMENSIONS.

SEALERS (REFER TO SPECS)

FRONT ELEVATION 1/4" = 1'-0"

APPLICATOR MUST DO THEIR DUE DILIGENCE WITH PREPARATION. PRIMER: 1 COAT SW A24W8300 FINISH: 2 COATS SW A82-100 SERIES, MATCH COLORS FROM MATERIAL SCHEDULE. A-100 EXTERIOR LATEX SATIN.

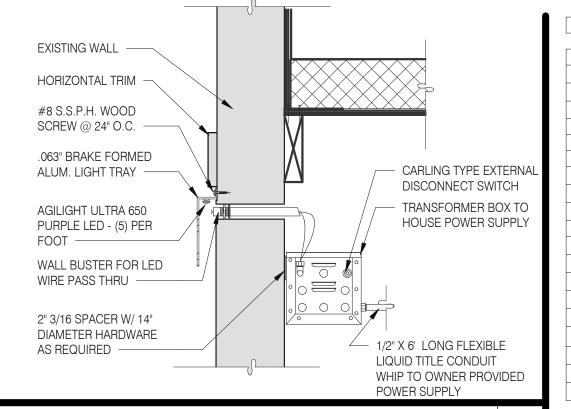

LED WALL WASHER DETAIL

TOWER V-09.14W 2 14" WHITE CHANNEL LETTERS VERTICAL V-04.42 2 42" SWINGING BELL PURPLE LOGO FACE LIT SIDE ENTRY V-04.42 1 42" SWINGING BELL PURPLE LOGO FACE LIT V-200.EN 1 SIDE ENTRY AWNING 6' 3" L X 6" H X 3' 0" D, BLACK DRIVE THRU V-101.DT 1 DT AWNING (OVER DT) 9' 0" L X 6" H X 4' 0" D, BLACK V-1X1.DT 1 DT AWNING (OVER DT) 5' 0" L X 6" H X 4' 0" D, BLACK REAR V-04.24 1 24" SWINGING BELL PURPLE LOGO FACE LIT V-09.12W 1 12" WHITE CHANNEL LETTERS EYEBROW AWNINGS V-201.EN 1 SIDE ENTRY EYEBROW (WINDOW) 12' 2' L 6" H X 1' 4" D, BLACK	
V-09.14W 2 14" WHITE CHANNEL LETTERS VERTICAL V-04.42 2 42" SWINGING BELL PURPLE LOGO FACE LIT SIDE ENTRY V-04.42 1 42" SWINGING BELL PURPLE LOGO FACE LIT V-200.EN 1 SIDE ENTRY AWNING 6' 3" L X 6" H X 3' 0" D, BLACK DRIVE THRU V-101.DT 1 DT AWNING (OVER DT) 9' 0" L X 6" H X 4' 0" D, BLACK V-1X1.DT 1 DT AWNING (OVER DT) 5' 0" L X 6" H X 4' 0" D, BLACK REAR V-04.24 1 24" SWINGING BELL PURPLE LOGO FACE LIT V-09.12W 1 12" WHITE CHANNEL LETTERS EYEBROW AWNINGS V-201.EN 1 SIDE ENTRY EYEBROW (WINDOW) 12' 2' L 6" H X 1' 4" D, BLACK	
V-04.42 2 42" SWINGING BELL PURPLE LOGO FACE LIT SIDE ENTRY V-04.42 1 42" SWINGING BELL PURPLE LOGO FACE LIT V-200.EN 1 SIDE ENTRY AWNING 6' 3" L X 6" H X 3' 0" D, BLACK DRIVE THRU V-101.DT 1 DT AWNING (OVER DT) 9' 0" L X 6" H X 4' 0" D, BLACK V-1X1.DT 1 DT AWNING (OVER DT) 5' 0" L X 6" H X 4' 0" D, BLACK REAR V-04.24 1 24" SWINGING BELL PURPLE LOGO FACE LIT V-09.12W 1 12" WHITE CHANNEL LETTERS EYEBROW AWNINGS V-201.EN 1 SIDE ENTRY EYEBROW (WINDOW) 12' 2' L 6" H X 1' 4" D, BLACK	
SIDE ENTRY V-04.42	A4.1
V-04.42 1 42" SWINGING BELL PURPLE LOGO FACE LIT V-200.EN 1 SIDE ENTRY AWNING 6' 3" L X 6" H X 3' 0" D, BLACK DRIVE THRU 1 DT AWNING (OVER DT) 9' 0" L X 6" H X 4' 0" D, BLACK V-101.DT 1 DT AWNING (OVER DT) 5' 0" L X 6" H X 4' 0" D, BLACK V-1X1.DT 1 DT AWNING (OVER DT) 5' 0" L X 6" H X 4' 0" D, BLACK REAR V-04.24 1 24" SWINGING BELL PURPLE LOGO FACE LIT V-09.12W 1 12" WHITE CHANNEL LETTERS EYEBROW AWNINGS V-201.EN 1 SIDE ENTRY EYEBROW (WINDOW) 12' 2' L 6" H X 1' 4" D, BLACK	A4.1
V-200.EN 1 SIDE ENTRY AWNING 6' 3" L X 6" H X 3' 0" D, BLACK DRIVE THRU V-101.DT 1 DT AWNING (OVER DT) 9' 0" L X 6" H X 4' 0" D, BLACK V-1X1.DT 1 DT AWNING (OVER DT) 5' 0" L X 6" H X 4' 0" D, BLACK REAR V-04.24 1 24" SWINGING BELL PURPLE LOGO FACE LIT V-09.12W 1 12" WHITE CHANNEL LETTERS EYEBROW AWNINGS V-201.EN 1 SIDE ENTRY EYEBROW (WINDOW) 12' 2' L 6" H X 1' 4" D, BLACK	
DRIVE THRU V-101.DT	A4.0
V-101.DT 1 DT AWNING (OVER DT) 9' 0" L X 6" H X 4' 0" D, BLACK V-1X1.DT 1 DT AWNING (OVER DT) 5' 0" L X 6" H X 4' 0" D, BLACK REAR V-04.24 1 24" SWINGING BELL PURPLE LOGO FACE LIT V-09.12W 1 12" WHITE CHANNEL LETTERS EYEBROW AWNINGS V-201.EN 1 SIDE ENTRY EYEBROW (WINDOW) 12' 2' L 6" H X 1' 4" D, BLACK	A4.0
V-1X1.DT 1 DT AWNING (OVER DT) 5' 0" L X 6" H X 4' 0" D, BLACK REAR V-04.24 1 24" SWINGING BELL PURPLE LOGO FACE LIT V-09.12W 1 12" WHITE CHANNEL LETTERS EYEBROW AWNINGS V-201.EN 1 SIDE ENTRY EYEBROW (WINDOW) 12' 2' L 6" H X 1' 4" D, BLACK	
V-1X1.DT 1 DT AWNING (OVER DT) 5' 0" L X 6" H X 4' 0" D, BLACK REAR V-04.24 1 24" SWINGING BELL PURPLE LOGO FACE LIT V-09.12W 1 12" WHITE CHANNEL LETTERS EYEBROW AWNINGS V-201.EN 1 SIDE ENTRY EYEBROW (WINDOW) 12' 2' L 6" H X 1' 4" D, BLACK	A4.1
V-04.24 1 24" SWINGING BELL PURPLE LOGO FACE LIT V-09.12W 1 12" WHITE CHANNEL LETTERS EYEBROW AWNINGS V-201.EN 1 SIDE ENTRY EYEBROW (WINDOW) 12' 2' L 6" H X 1' 4" D, BLACK	A4.1
V-09.12W 1 12" WHITE CHANNEL LETTERS EYEBROW AWNINGS V-201.EN 1 SIDE ENTRY EYEBROW (WINDOW) 12' 2' L 6" H X 1' 4" D, BLACK	
EYEBROW AWNINGS V-201.EN 1 SIDE ENTRY EYEBROW (WINDOW) 12' 2' L 6" H X 1' 4" D, BLACK	A4.1
V-201.EN 1 SIDE ENTRY EYEBROW (WINDOW) 12' 2' L 6" H X 1' 4" D, BLACK	A4.1
	A4.0
V-202.EN 1 FRONT EYEBROW (WINDOW) 16' 9" L X 6" H X 1' 4" D, BLACK	A4.1
V-203.EN 1 DT EYEBROW (WINDOW) 7' 8" L X 6" H X 1' 4" D, BLACK	A4.1

(x)	QTY.	NAME	FAMILY		SIZE	LOCATION
G608	1	GM - EXT1	Е	M03	TBD	SEE A4.0
		THIS MURAL WILL BE MATERIAL AND ASSE				
(G523)	1	GM - SKIP THE LINE	Е	M02	48x96	SEE A4.1
(G524)	1	GM - ORDER AHEAD	Е	M02	48x96	SEE A4.1

	,		
EXTERIOR ARTWORK SCHEDULE	С	PAINT NOTES	

316	METAL PARAPET CAP.

DASHED LINE INDICATES ROOF BEYOND.

METAL CANOPIES BY VENDOR. REQUIRES ELECTRICAL, SEE ELECTRICAL

408 CO2 FILLER VALVE & COVER.

419 EXTERIOR LIGHT FIXTURE. SEE ELECTRICAL DRAWINGS.

PURPLE LIGHT WALL WASHER, PROVIDED BY SIGNAGE VENDOR, REQUIRES ELECTRICAL, SEE ELECTRICAL PLANS.

316	METAL PARAPET CAP.	
101	DI III DINIC SICNI DV VENDOD, DEGLIDES EL ECTDICA	CEEEL

401 BUILDING SIGN BY VENDOR. REQUIRES ELECTRICAL, SEE ELECTRICAL

416 HOSE BIBB BOX AT 18" A.F.F. SEE PLUMBING DRAWINGS.

423 OUTLINE OF RTU BEYOND.

ELEVATIONS

05.06.22 Issued for Permit

04.13.22

END. 80FT

DICKSON

315672

455386

2021088.52

MARCH 2021

07.26.22 NTP

08.09.22 IFB

CONTRACT DATE:

BUILDING TYPE:

PLAN VERSION:

SITE NUMBER:

PA/PM:

DRAWN BY.:

JOB NO.:

STORE NUMBER:

TACO BELL

1551 West River Rd.

Elyria, OH

BRAND DESIGNER:

PLOT DATE: 8/9/2022 12:47:19 PM

SYMBOL	ITEM/MATERIAL	MANUFACTURER	MATERIAL SPEC	COLOR	CONTACT INFORMATION
1	SIDING	JAMES HARDIE	ARTISAN V-GROOVE 144"L X 8.25"W; 7" EXPOSURE COMES PRIMED FOR PAINT	WORLDLY GRAY (SW7043), SEMI-GLOSS	SEE C / A 7.2
2	SCUPPERS	-	-	WORLDLY GRAY (SW7043), SEMI-GLOSS	
3	DOWN SPOUTS	-	-	WORLDLY GRAY (SW7043), SEMI-GLOSS	
4	HARDIE TRIM	JAMES HARDIE	HARDIE TRIM 5/4 SMOOTH 1"x5.5"	CYBERSPACE (SW7076), SEMI-GLOSS	SEE C / A 7.2
5	HARDIE REVEAL PANEL	JAMES HARDIE	REVEAL PANEL SYSTEM	CYBERSPACE (SW7076), SEMI-GLOSS	SEE C / A 7.2
6	HOLLOW METAL DOOR	-	-	SW PURPLE TB2603C, SEMI-GLOSS	
7	AWNINGS	SIGNAGE VENDOR	-	BLACK BY THE SIGNAGE VENDOR	
8	CORNER TOWER	WESTERN STATE	T-GROOVE 24GA PAINTED 18" PANEL	WEATHERED RUSTIC	SEE C / A 7.2
9	RECESS OF SIDE ENTRY PORTAL	WESTERN STATE	T-GROOVE 24GA PAINTED 18" PANEL	WEATHERED RUSTIC	SEE C / A 7.2
10	HARDIE REVEAL PANEL	JAMES HARDIE	REVEAL PANEL SYSTEM	SW PURPLE TB2603C, SEMI-GLOSS	SEE C / A 7.2
11	METAL PARAPET CAP	-	24GA GALVANIZED	CYBERSPACE (SW7076) KYNAR 500 COATING	

EXTERIOR FINISH SCHEDULE

KEY NOTES



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401

- 203 PIPE BOLLARD. SEE CIVIL DRAWINGS.
- ROOFTOP UNIT. INSTALL PLUMB AND LEVEL. SEE MECHANICAL DRAWINGS
- METAL PARAPET CAP.

ELECTRICAL PLANS.

- BUILDING SIGN BY VENDOR. REQUIRES ELECTRICAL, SEE ELECTRICAL
- DASHED LINE INDICATES ROOF BEYOND.
- METAL CANOPIES BY VENDOR. REQUIRES ELECTRICAL, SEE
- ASSUME D/T LANE SURFACE IS 6" BELOW THE FINISH FLOOR. REFER
- TO GRADING & SITE PLAN. 413 OVERFLOW SCUPPER. REFER TO D/A3.0.
 - EXTERIOR LIGHT FIXTURE. SEE ELECTRICAL DRAWINGS.
- PURPLE LIGHT WALL WASHER, PROVIDED BY SIGNAGE VENDOR,
- REQUIRES ELECTRICAL, SEE ELECTRICAL PLANS. OUTLINE OF RTU BEYOND.
- 424 ALIGN REVEAL WITH VERTICAL MULLION.



401 V04.42

√V09.14W

401


√V-203.EN

T.O. LOW PARAPET 20'-6"

A6.2

\ A4.0 \\ A6.1 \

10'-0 1/2"

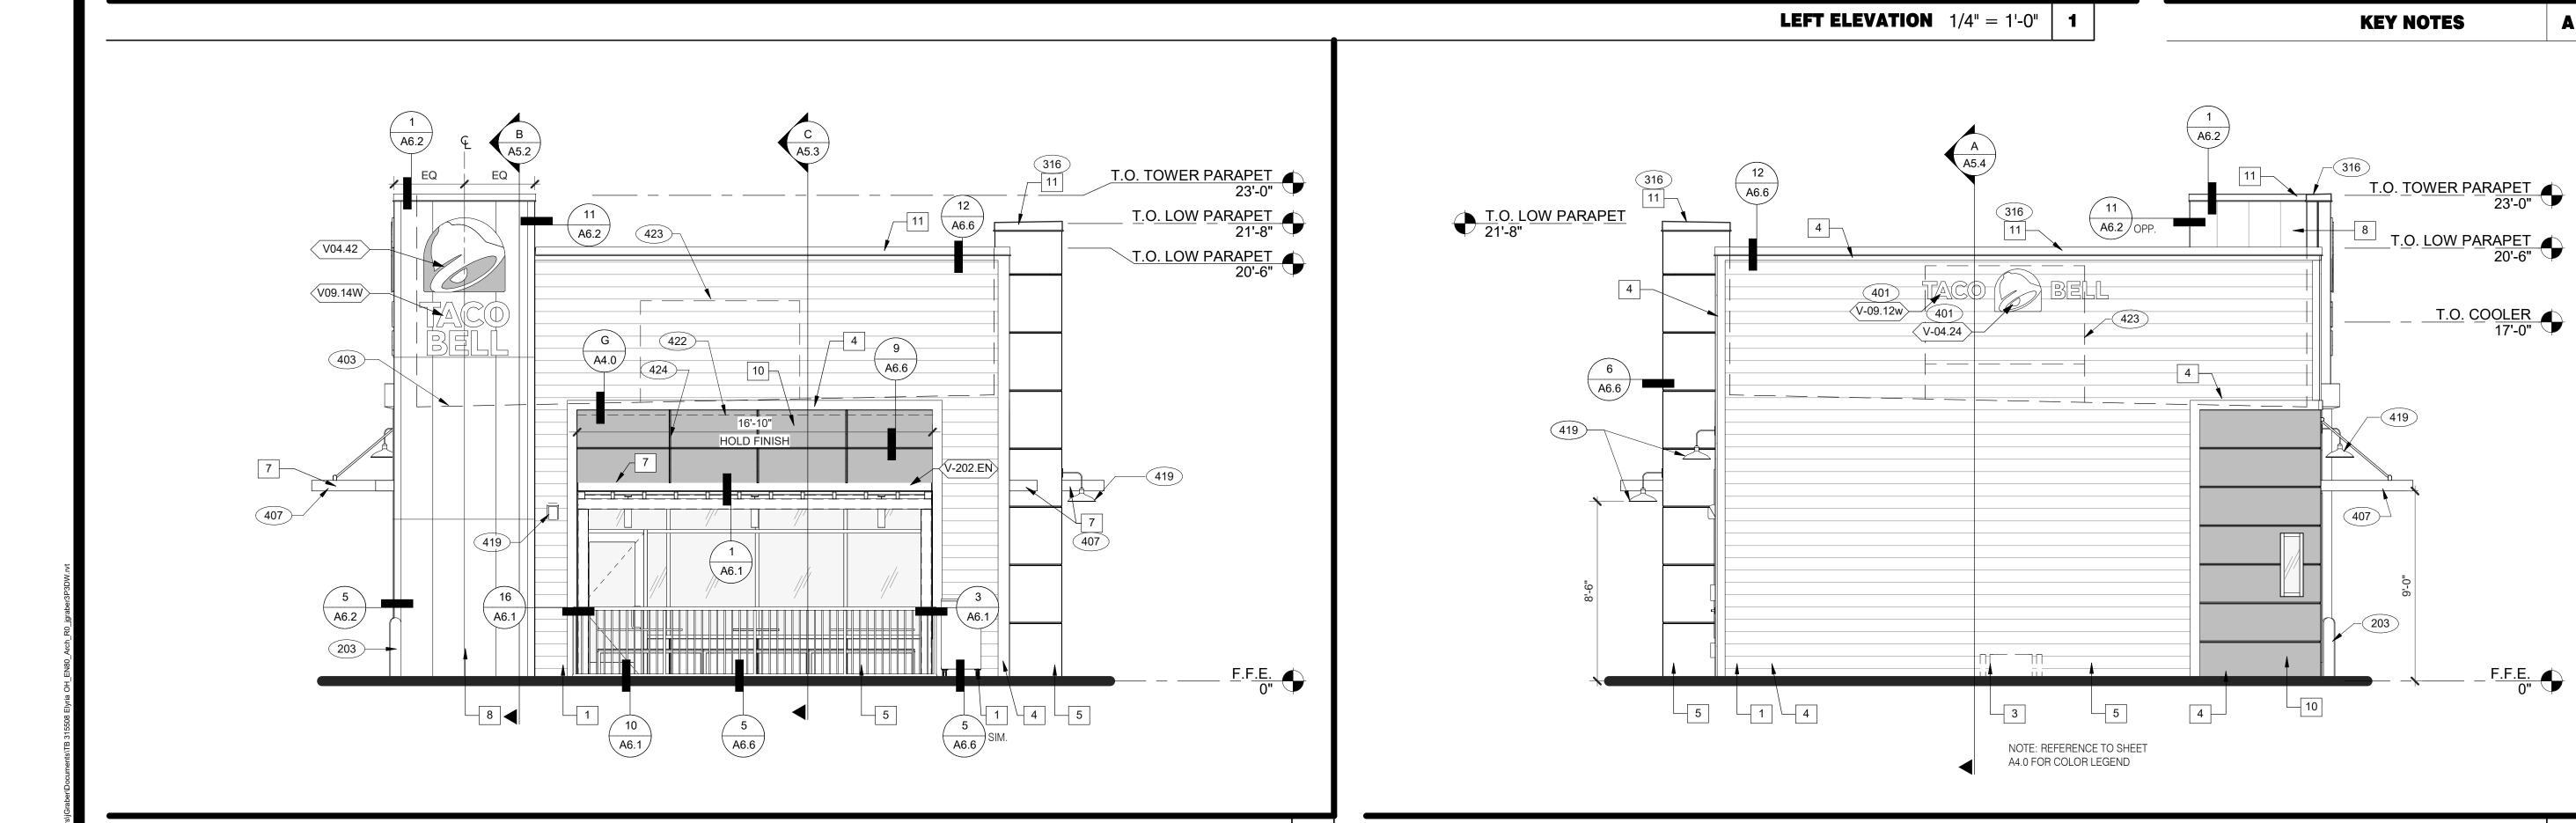

FRONT ELEVATION 1/4" = 1'-0" **2**

(C) (A5.2)

316

A6.6

10

22'-6 1/2"

\ A6.6 /

EQ.

√V-1x1.DT

5

EQ.

EQ-

EQ-

4'-0"

(G523)

EQ.

(413)

√ A6.6 */*

3'-8"

4'-0"

EQ

5

A6.6

- 409

EQ \ A6.6

07.26.22 NTP 08.09.22 IFB

CONTRACT DATE: END. 80FT BUILDING TYPE: PLAN VERSION: MARCH 2021 BRAND DESIGNER: SITE NUMBER: STORE NUMBER: DRAWN BY.: 2021088.52

TACO BELL

1551 West River Rd. Elyria, OH





ENDEAVOR 2.0 EXTERIOR ELEVATIONS

PLOT DATE: 8/9/2022 12:47:26 PM

REAR ELEVATION 1/4" = 1'-0"



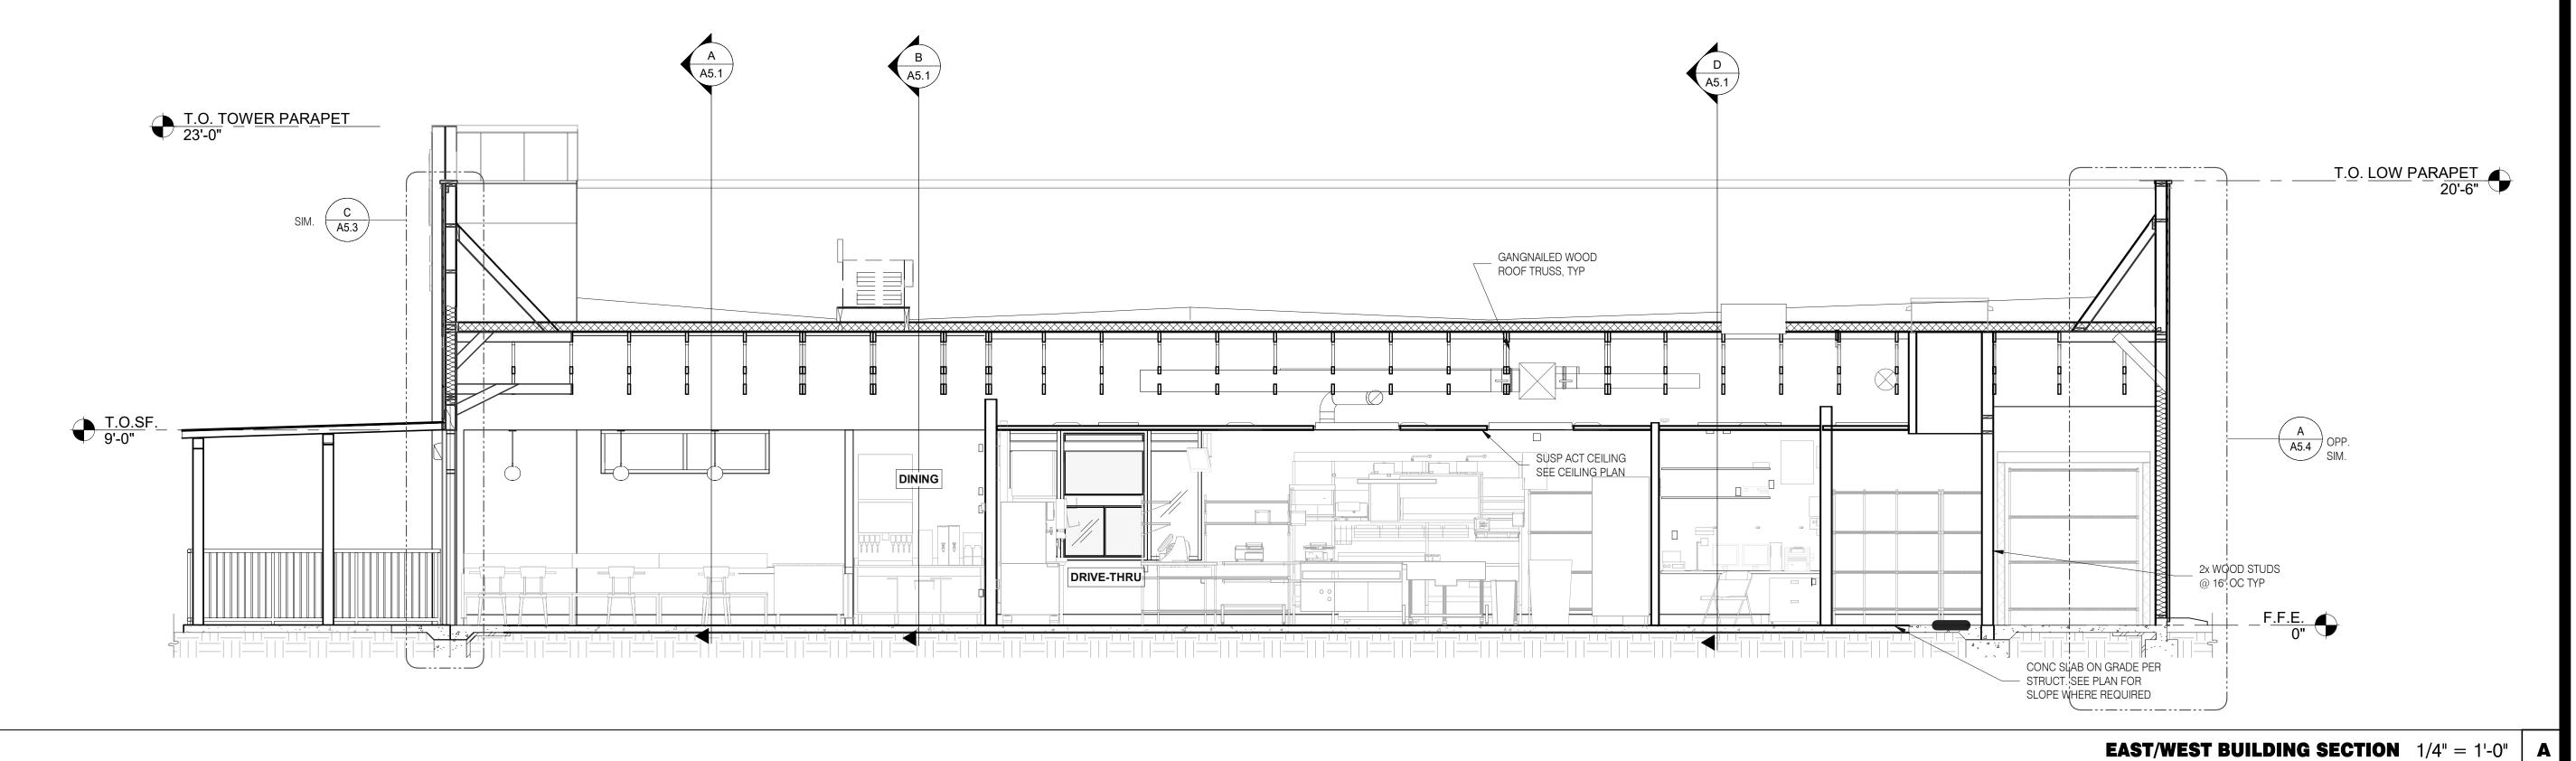

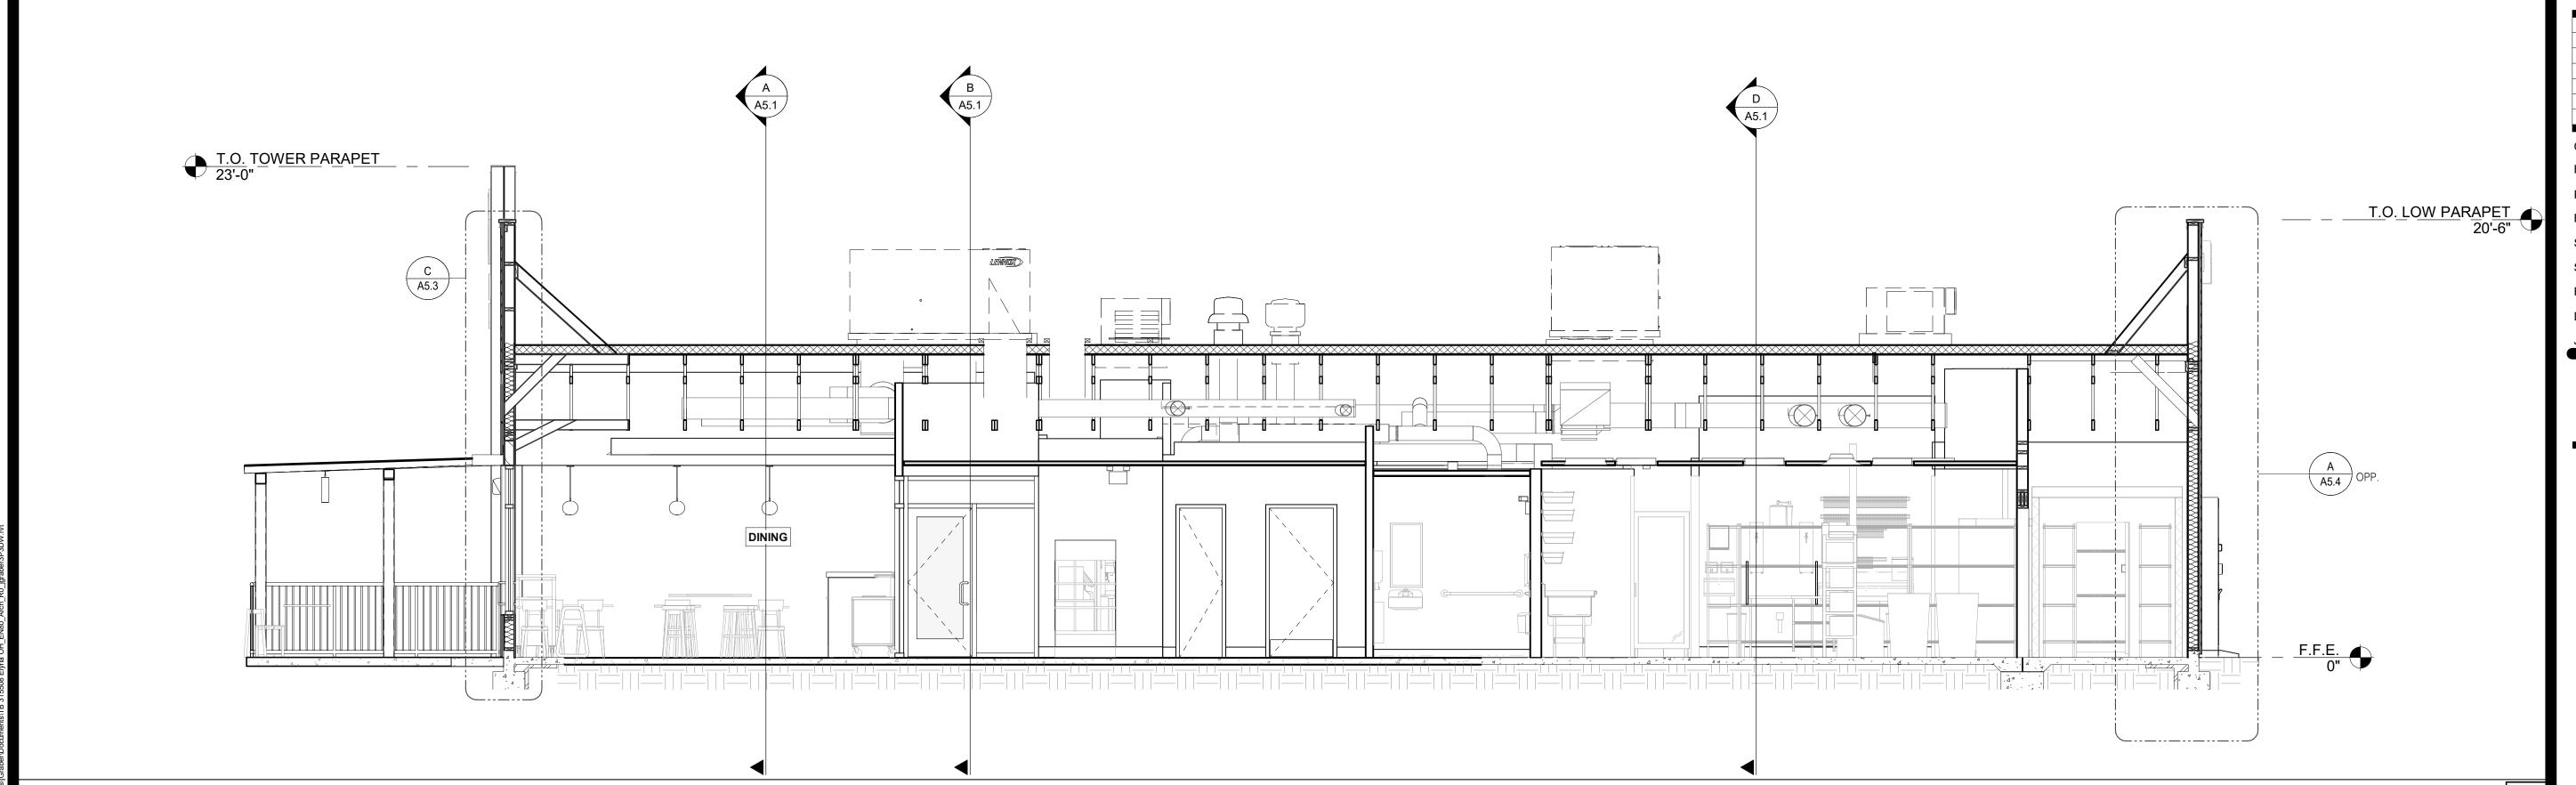

	DATE	REMARKS
	05.06.22	Issued for Permit
	07.26.22	NTP
	08.09.22	IFB

CONTRACT DATE: 04.13.22
BUILDING TYPE: END. 80FT
PLAN VERSION: MARCH 2021
BRAND DESIGNER: DICKSON
SITE NUMBER: 315672
STORE NUMBER: 455386
PA/PM: SM
DRAWN BY.: RS
JOB NO.: 2021088.52

TACO BELL


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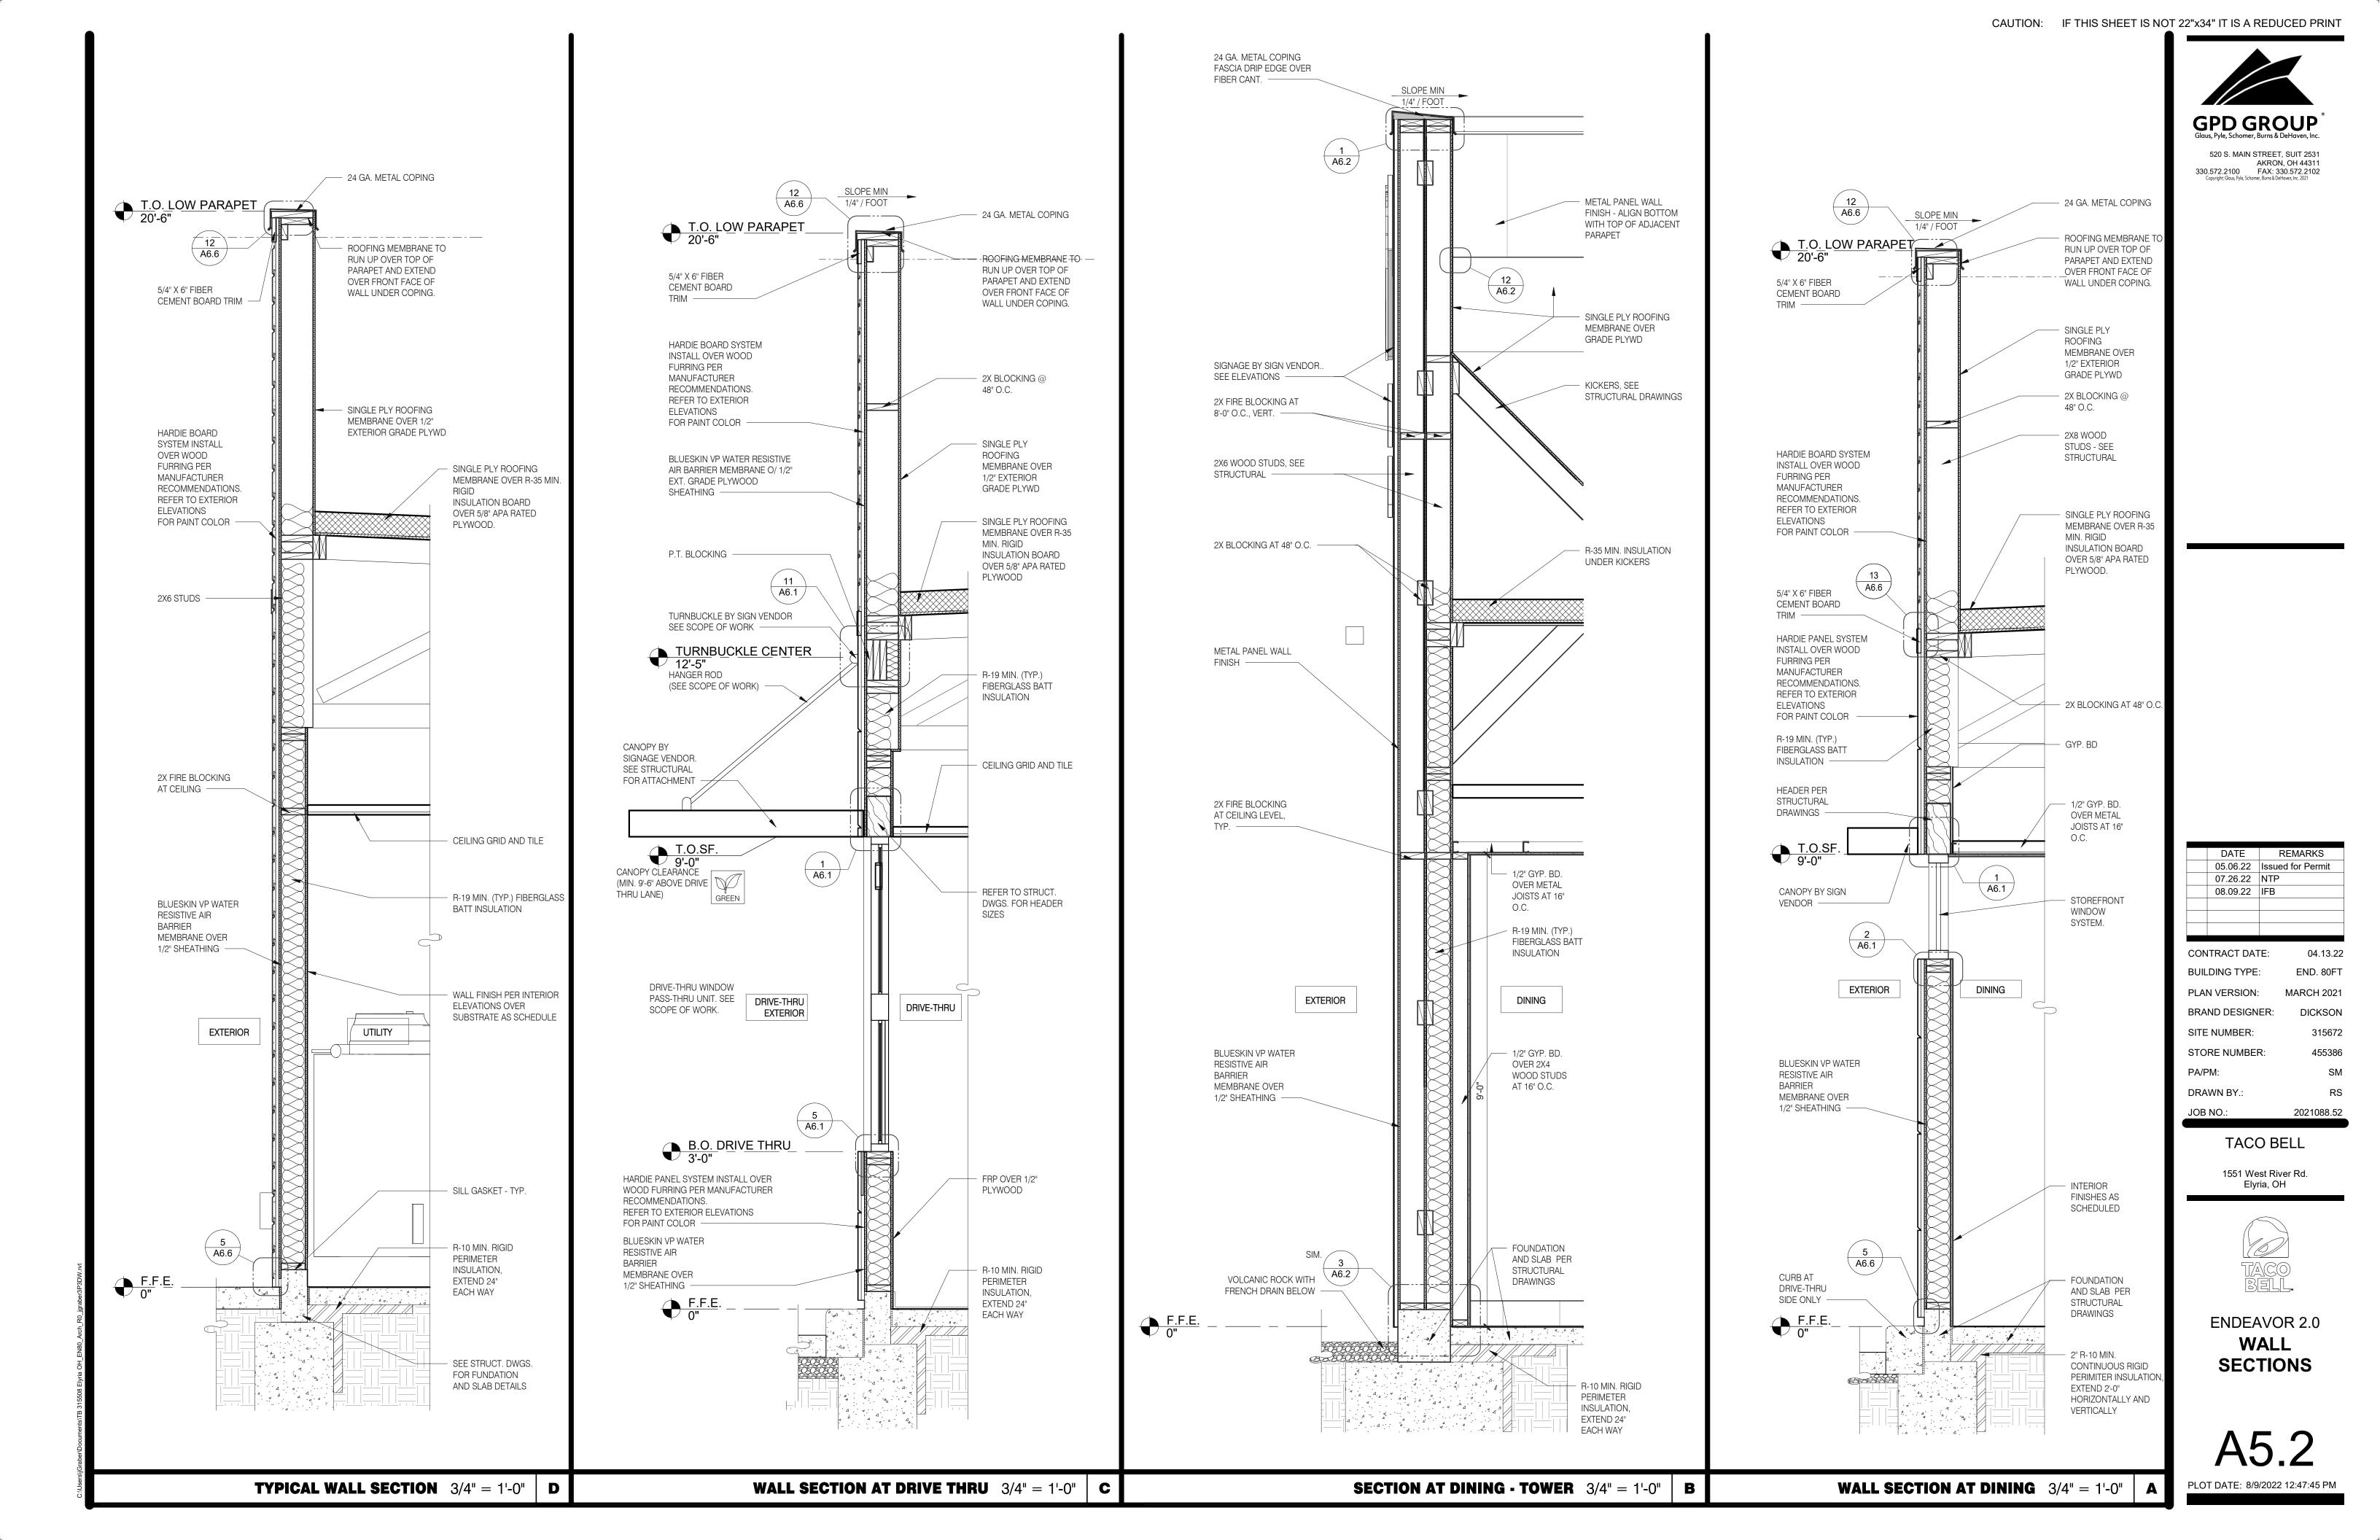



BUILDING SECTIONS


A5.0

EAST/WEST BUILDING SECTION 1/4" = 1'-0" B



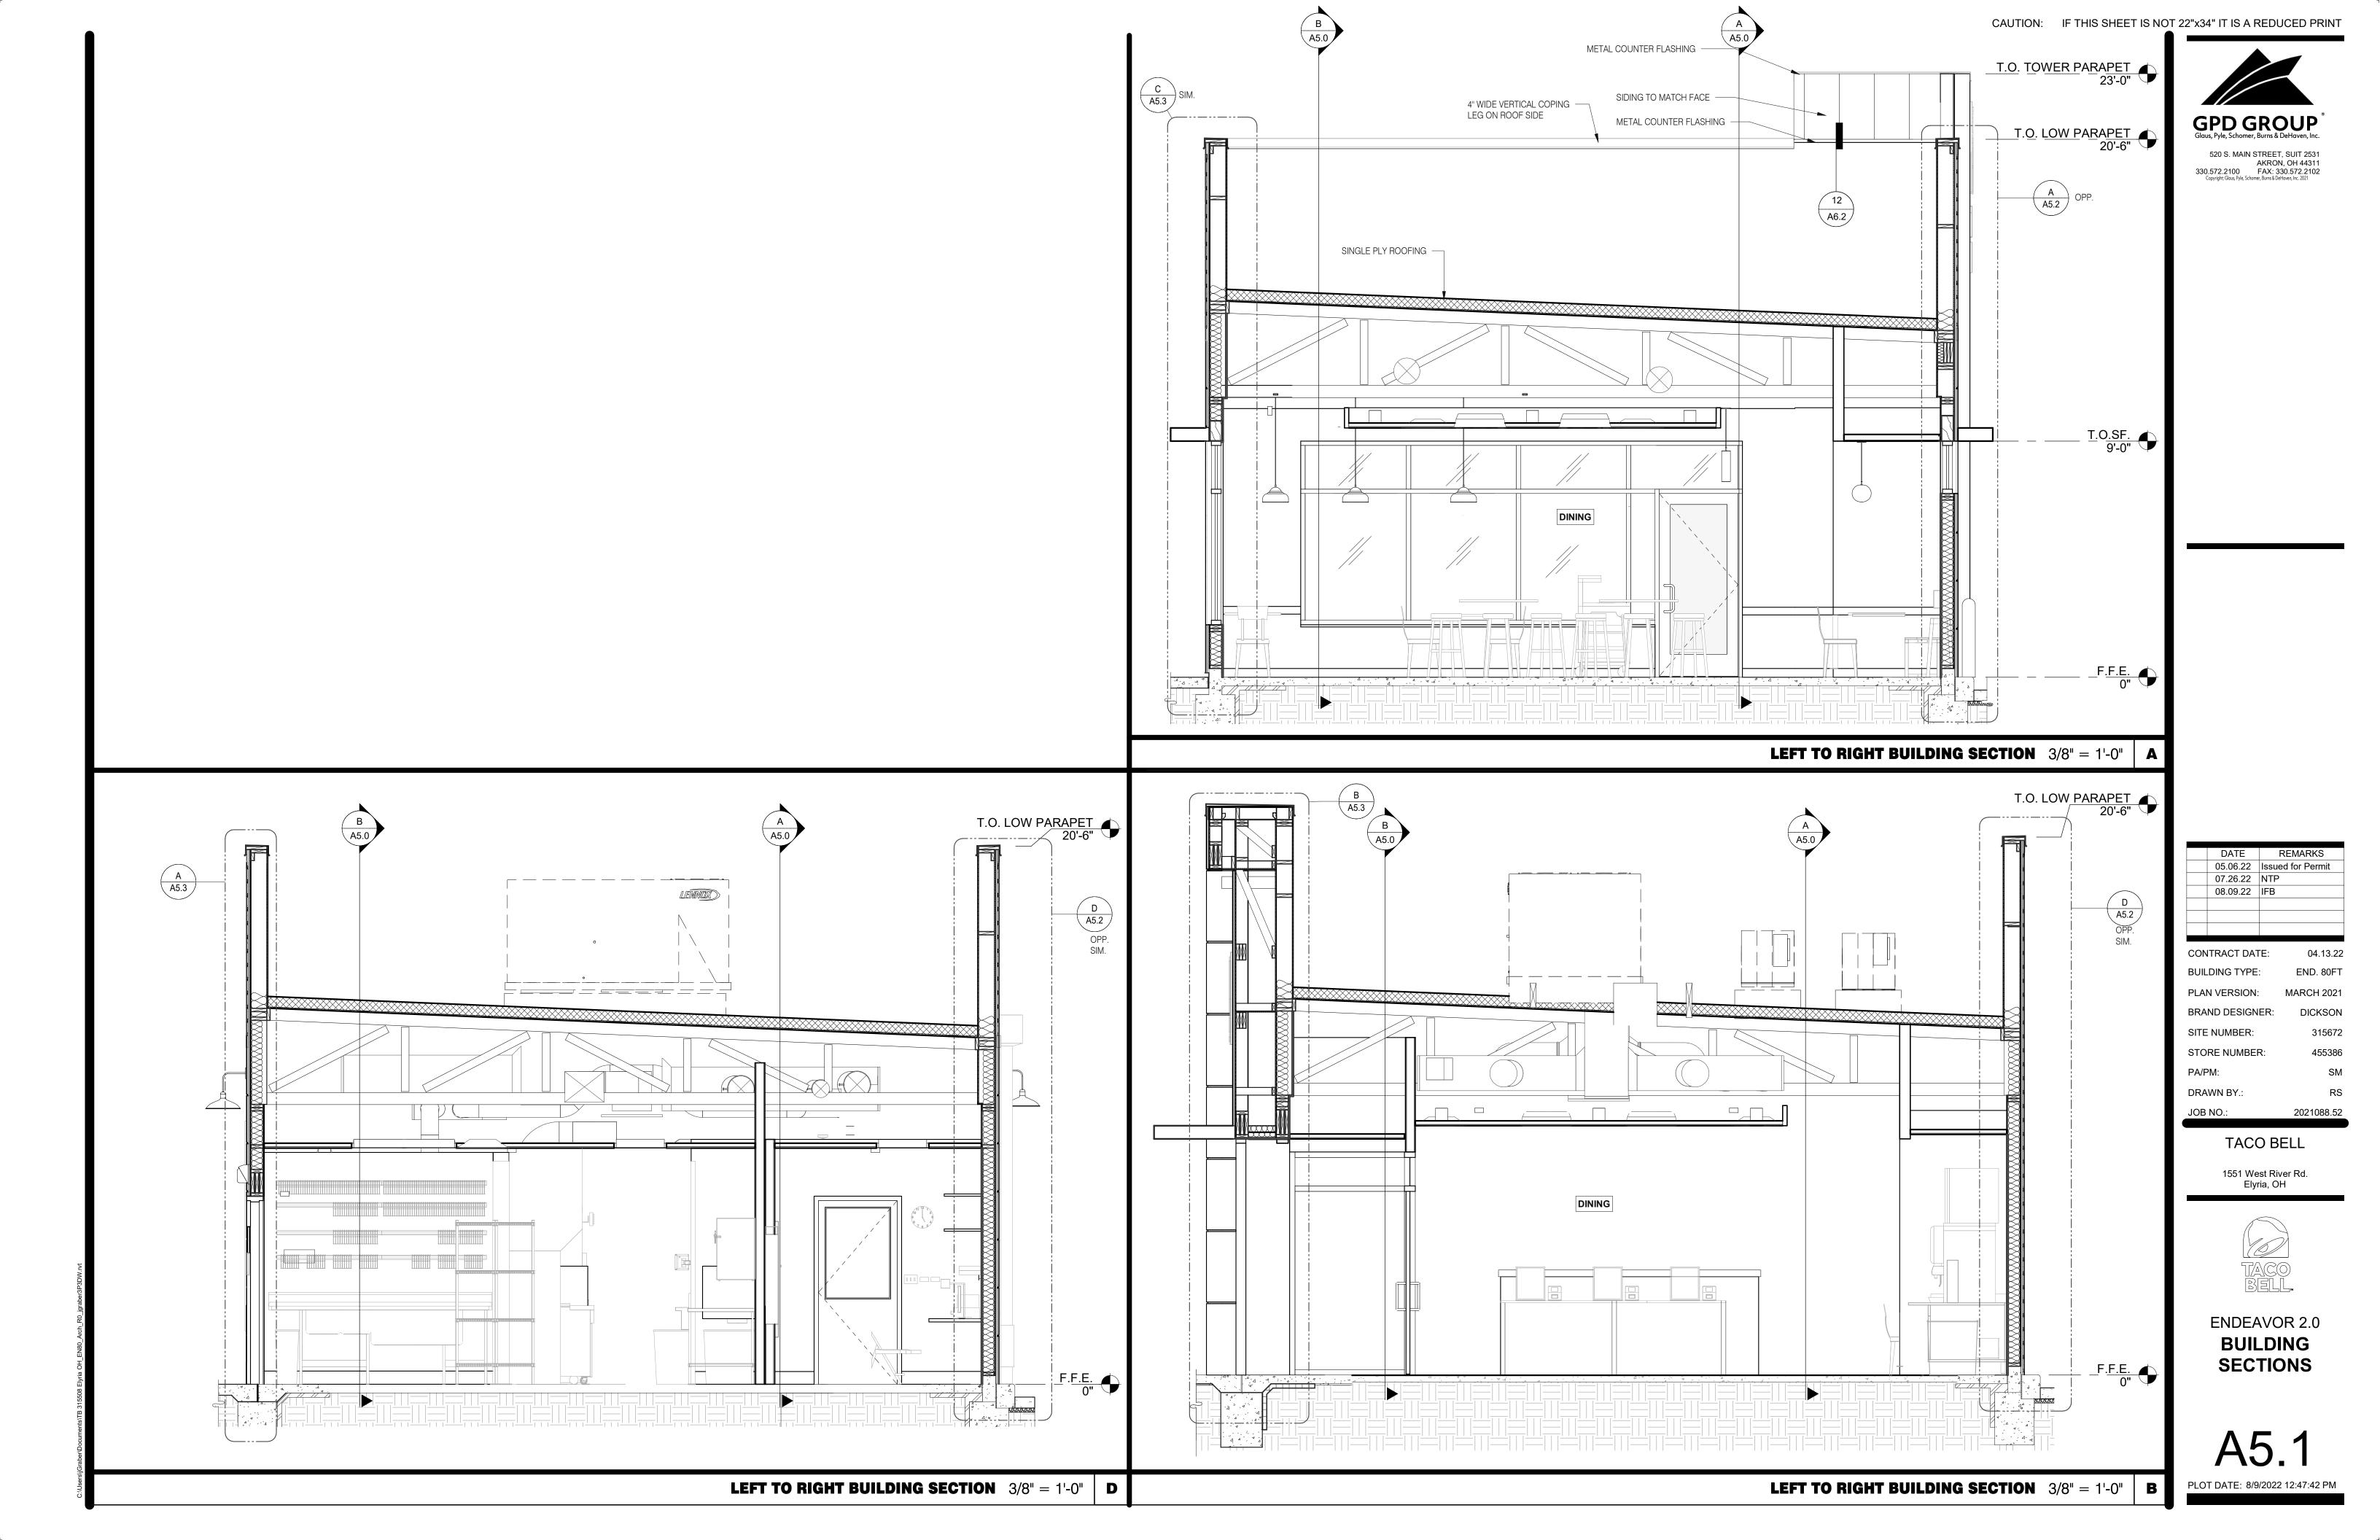

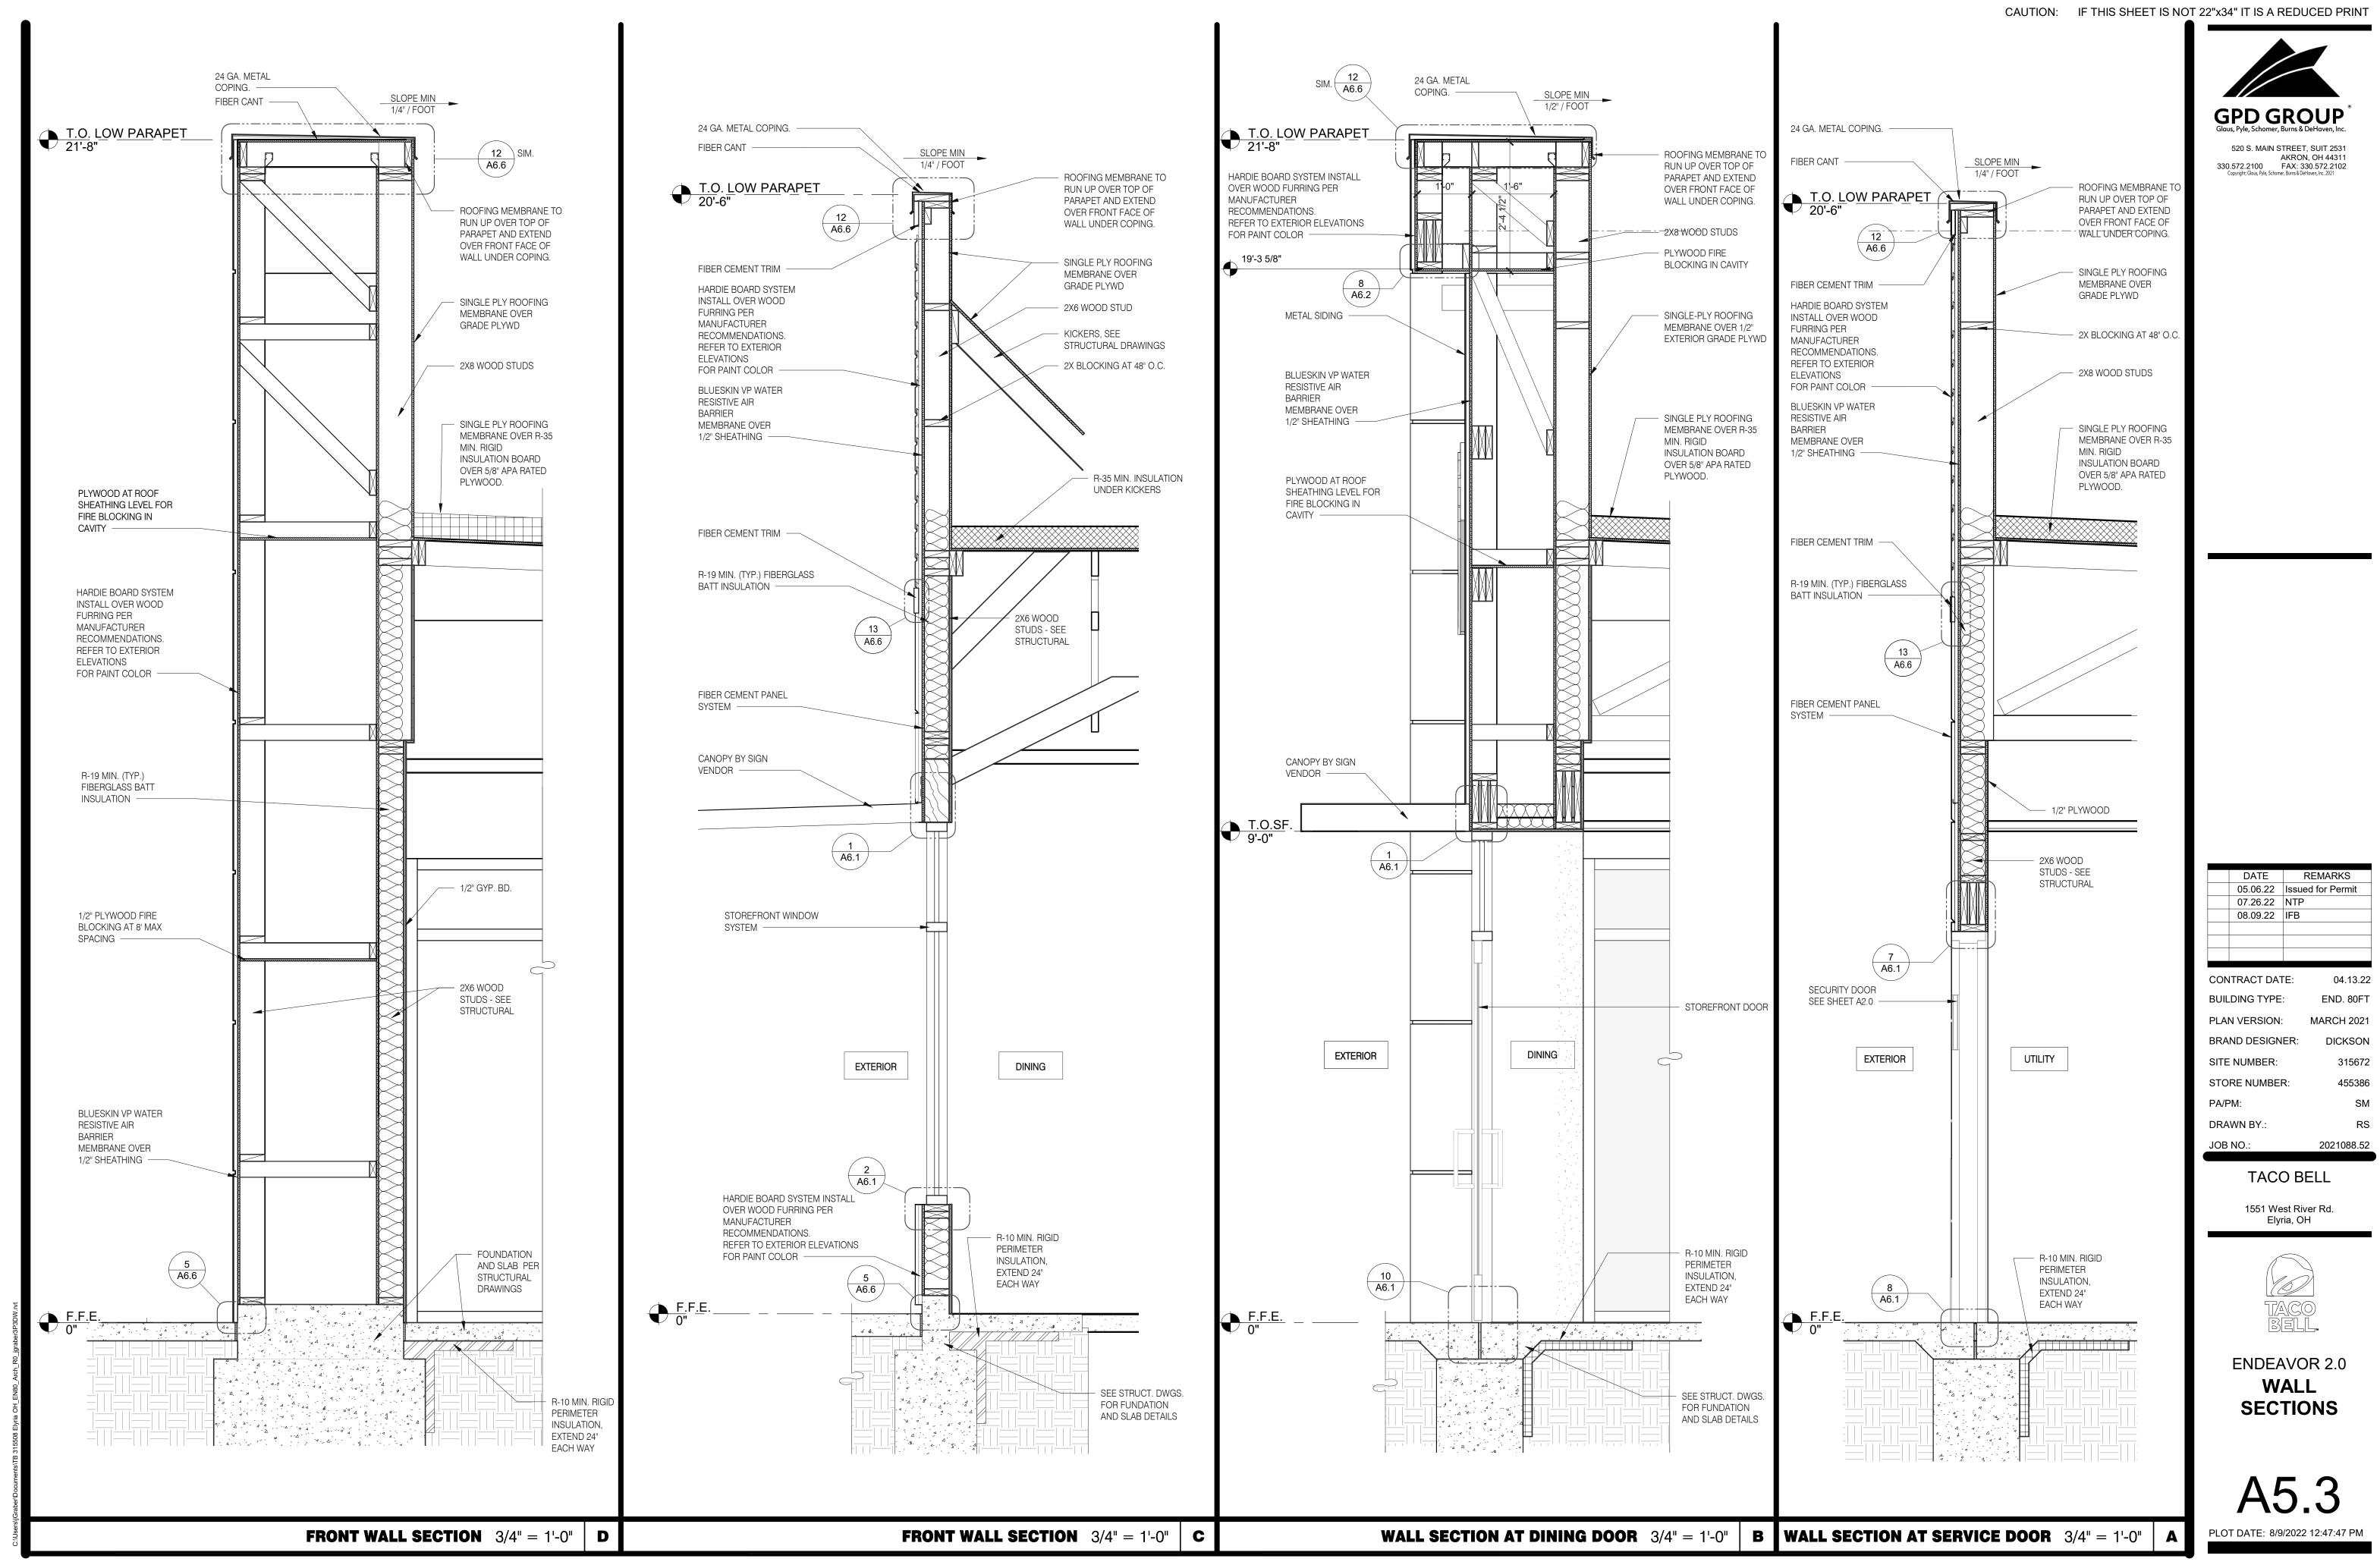

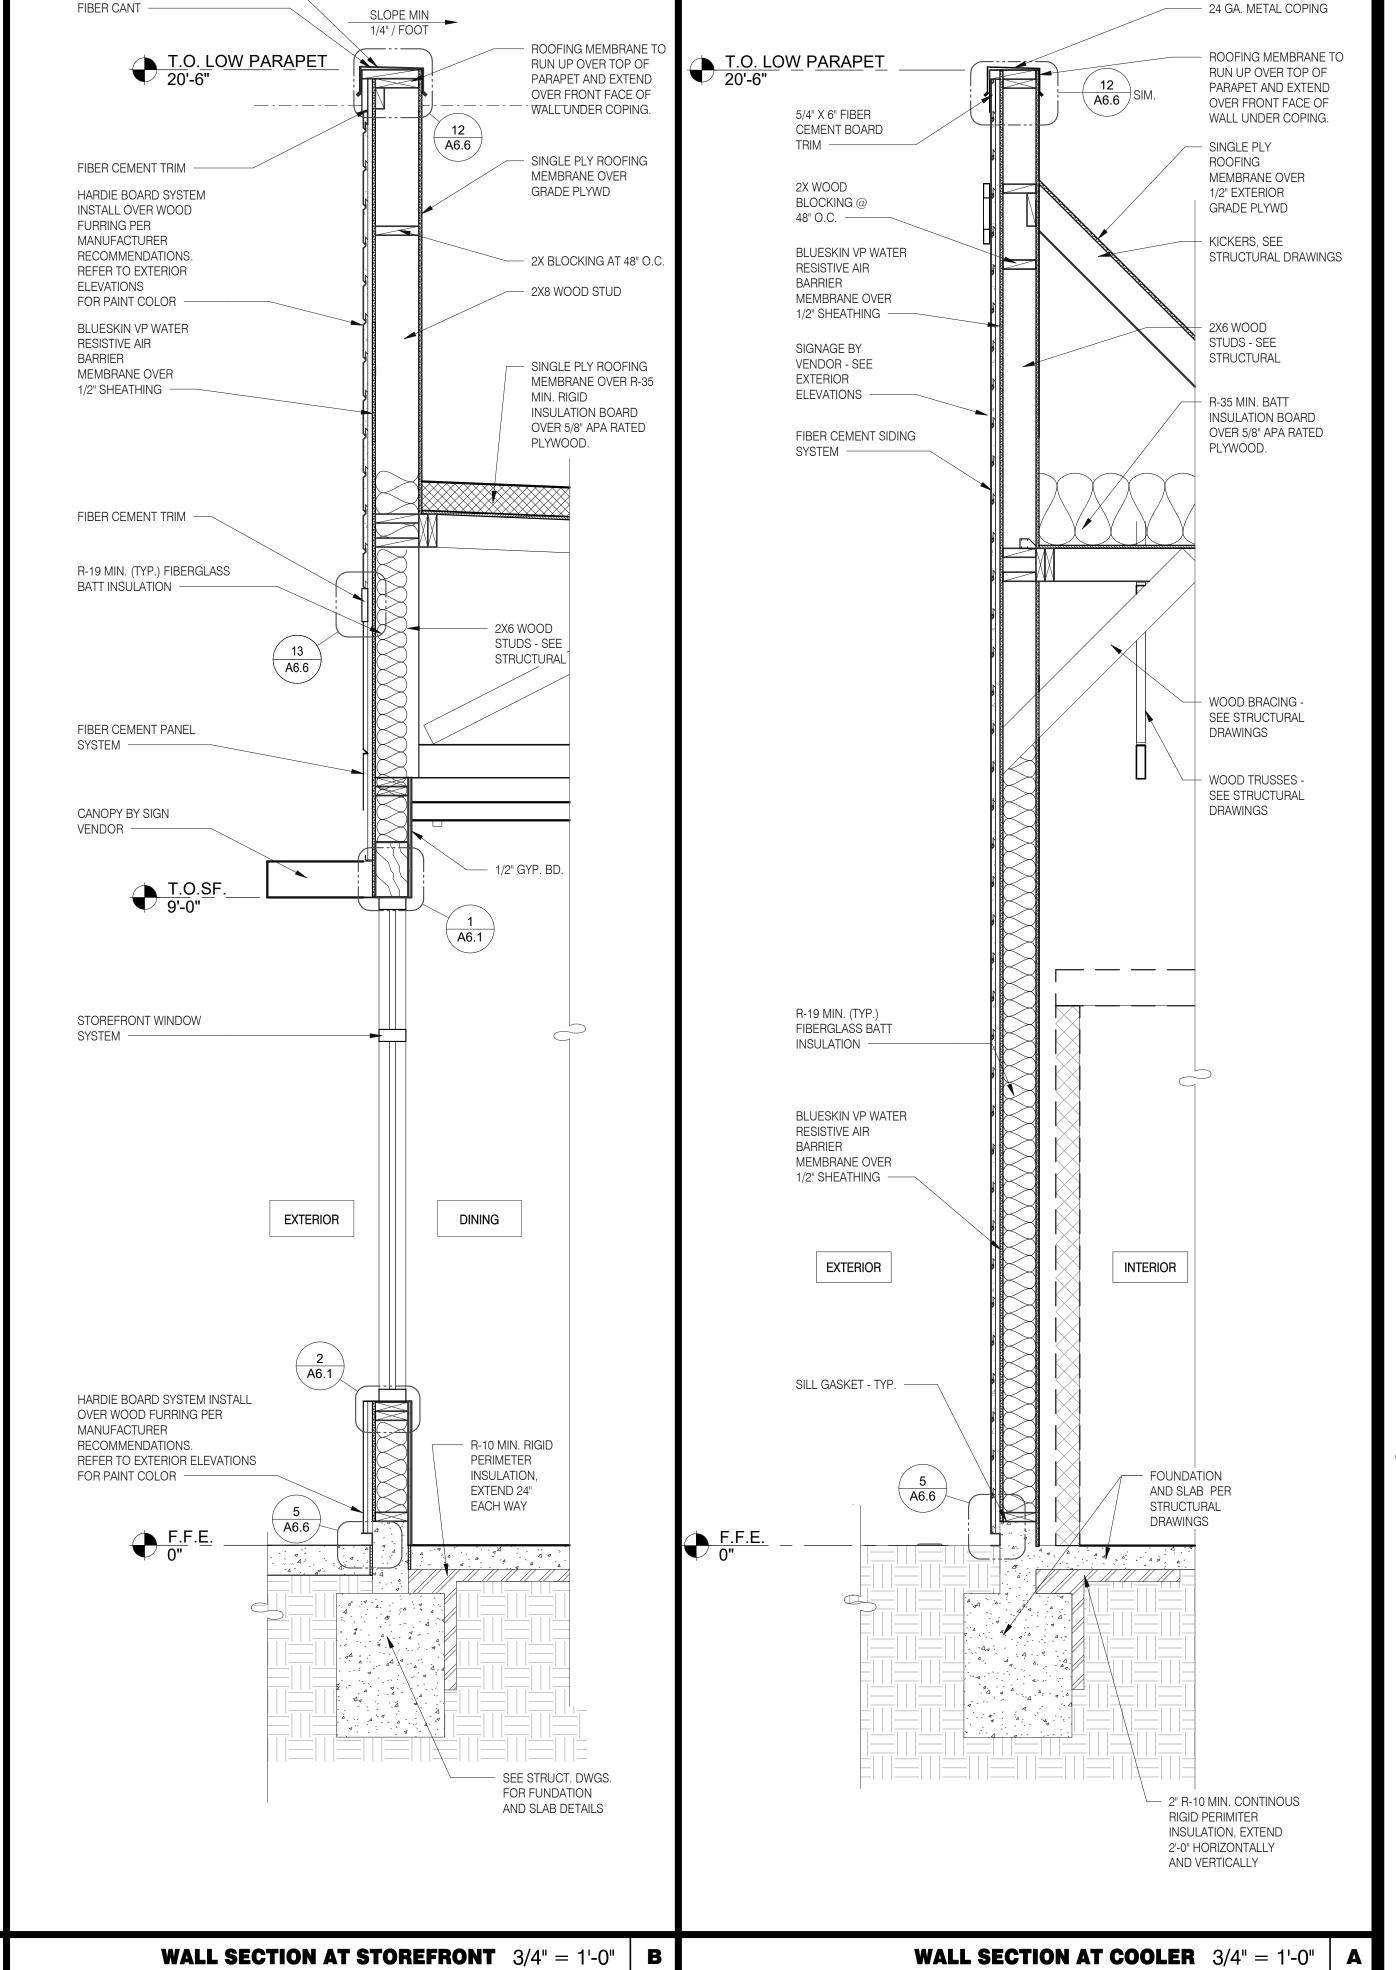

24 GA. METAL COPING. —

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	DATE	REMARKS
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CONTRACT DATE: 04.13.22
BUILDING TYPE: END. 80FT
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STORE NUMBER: 455386
PA/PM: SM
DRAWN BY.: RS
JOB NO.: 2021088.52

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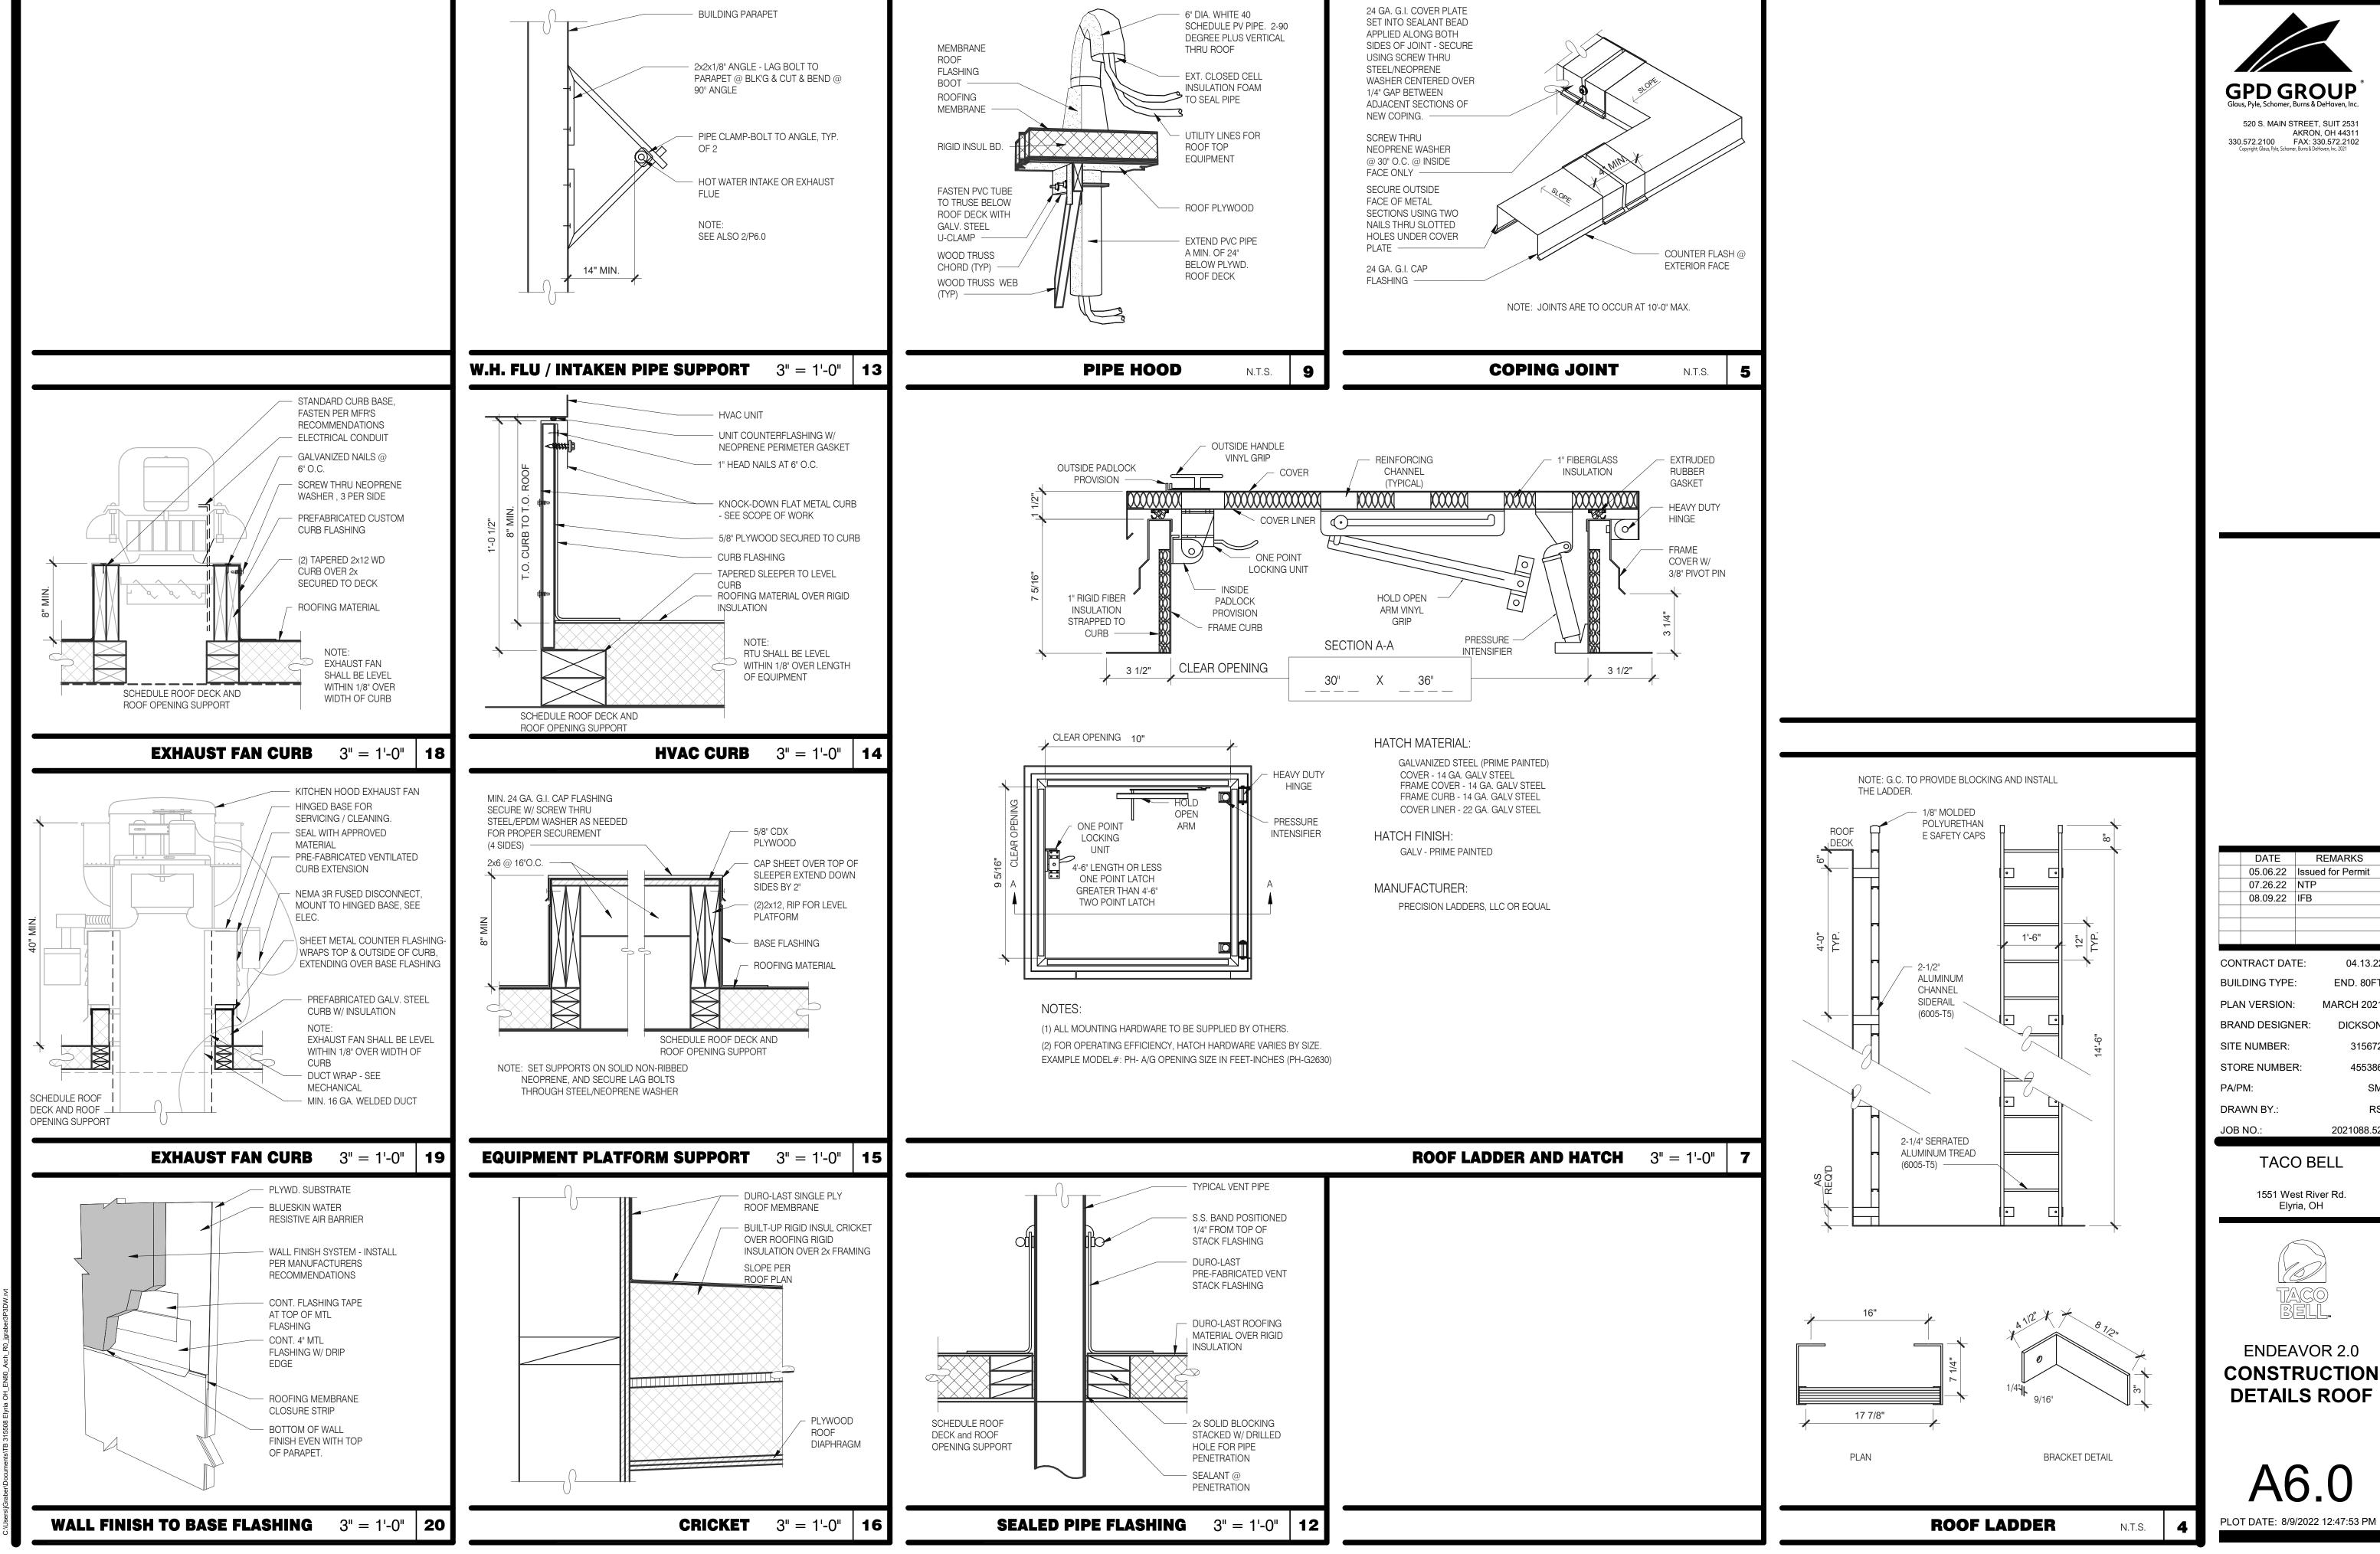
1551 West River Rd. Elyria, OH



WALL SECTIONS

Δ5 Δ


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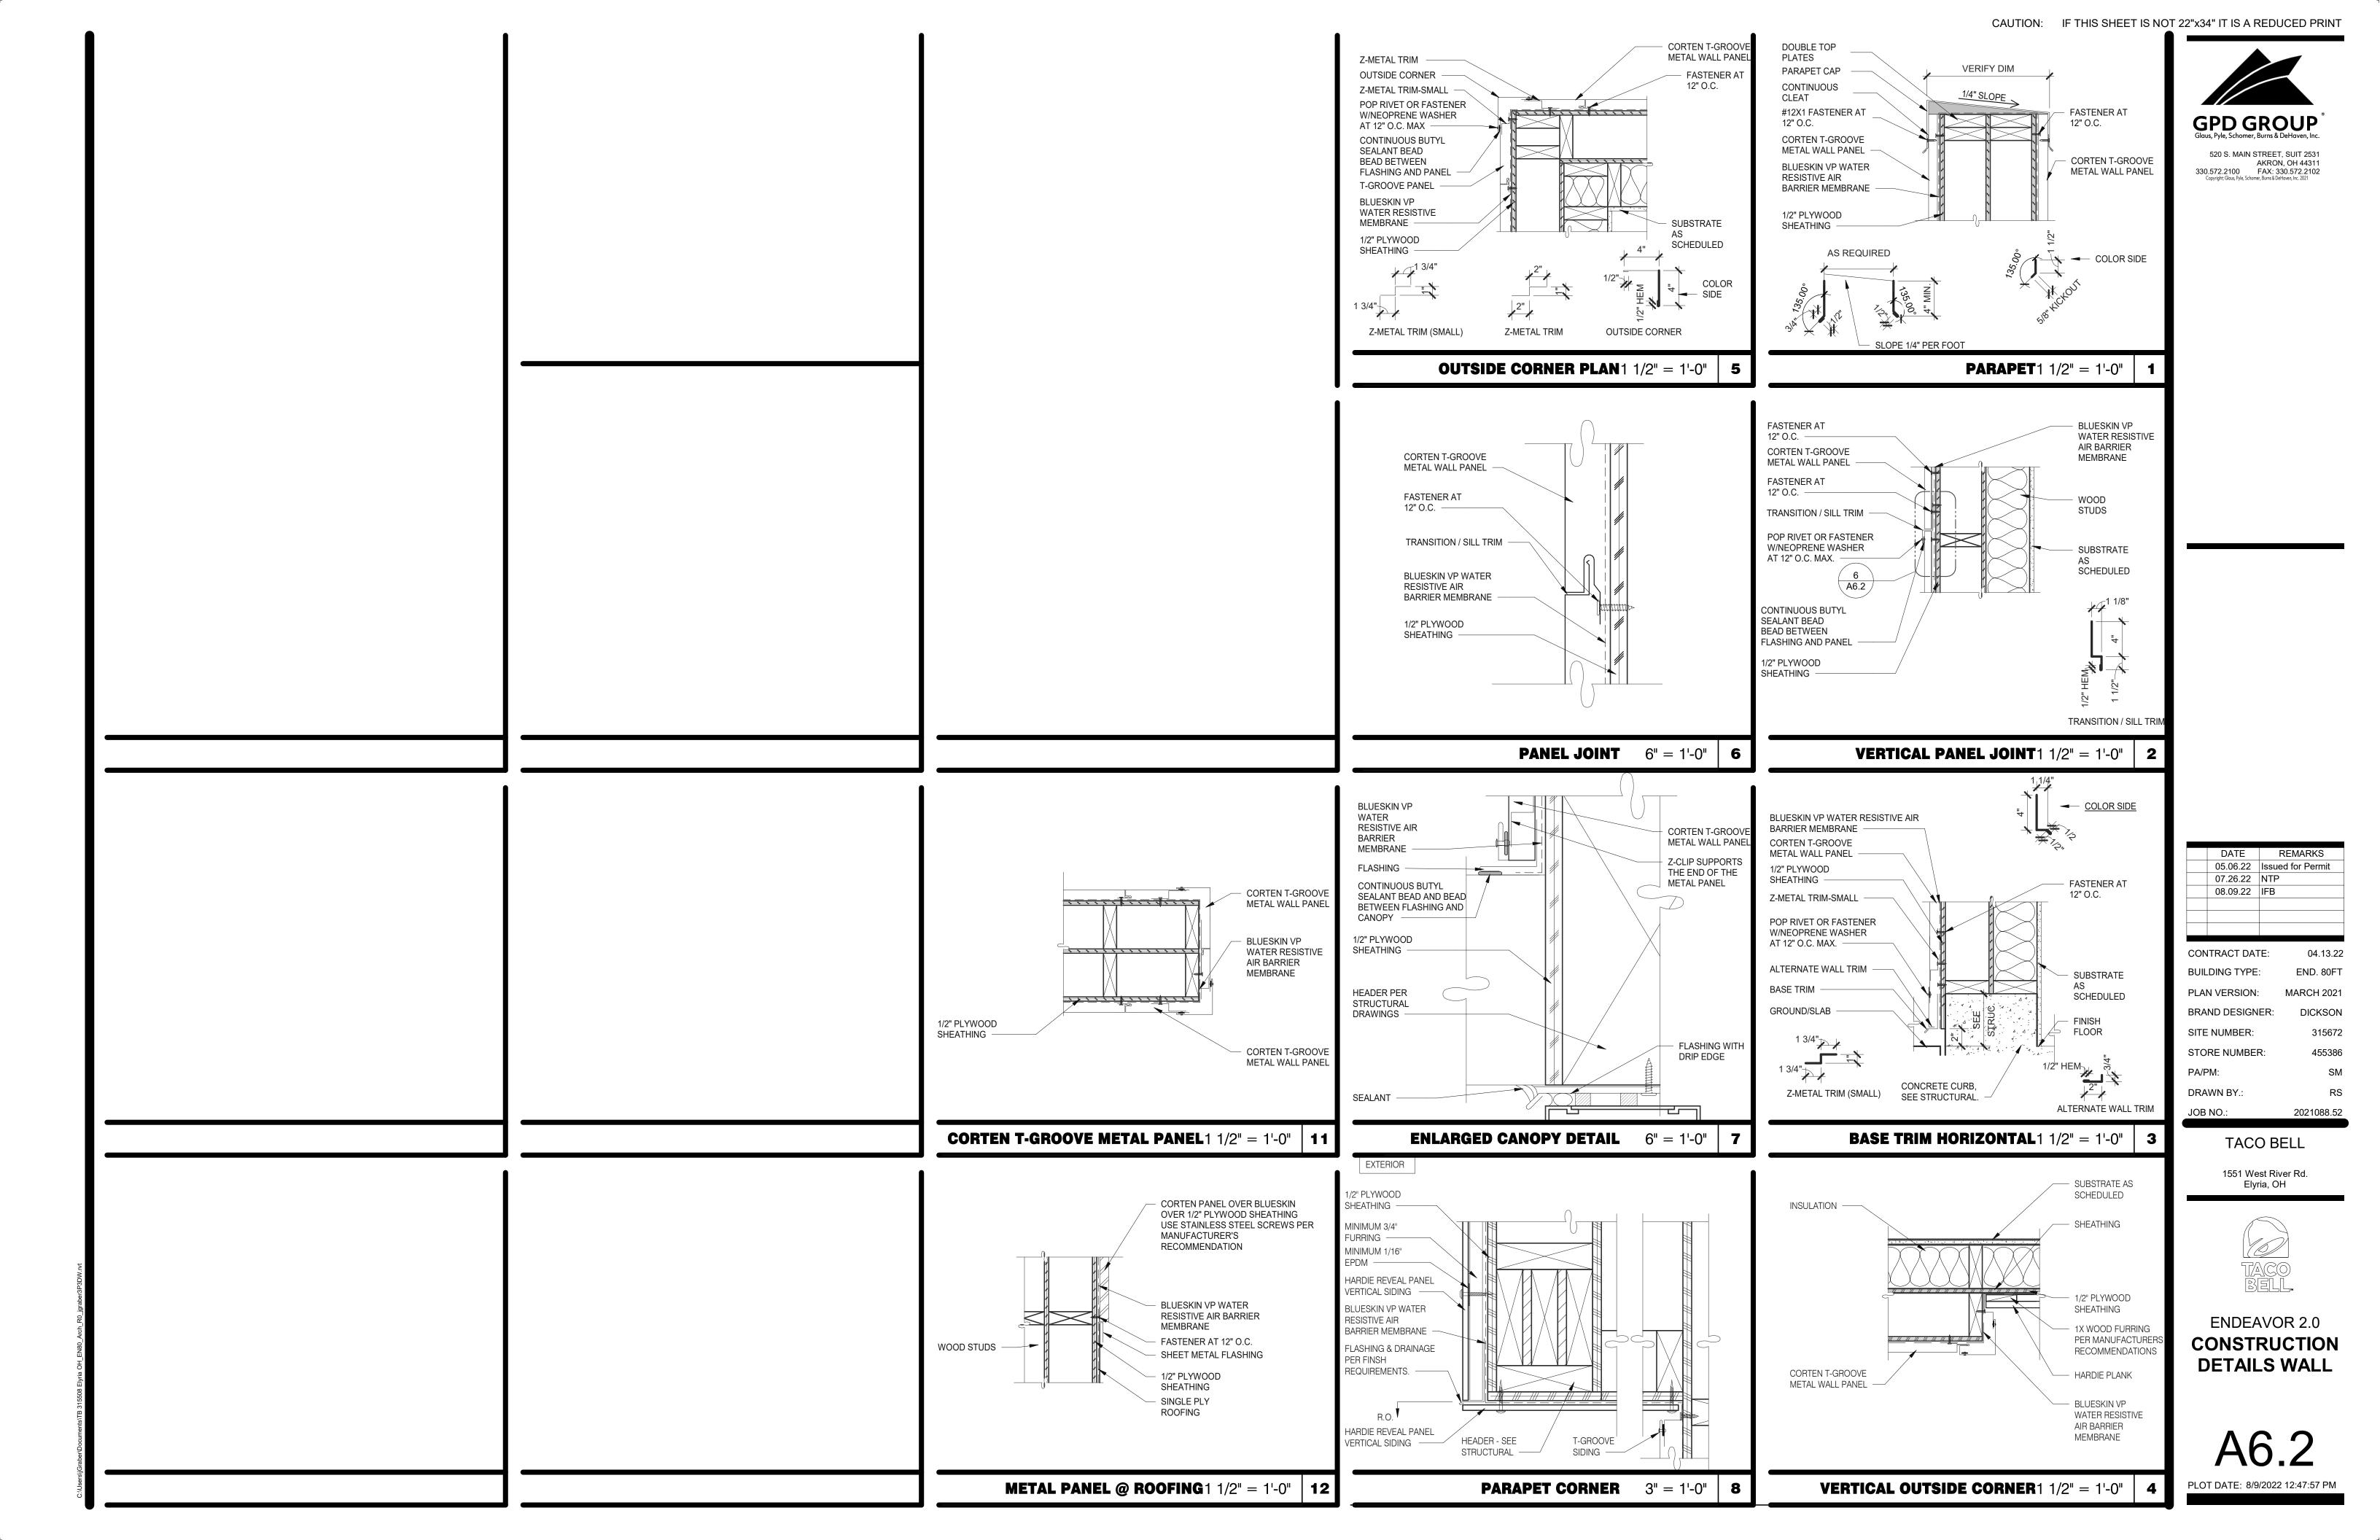



CAUTION: IF THIS SHEET IS NOT 22"x34" IT IS A REDUCED PRINT

04.13.22 END. 80FT MARCH 2021 DICKSON 315672 2021088.52

CONSTRUCTION **DETAILS ROOF**



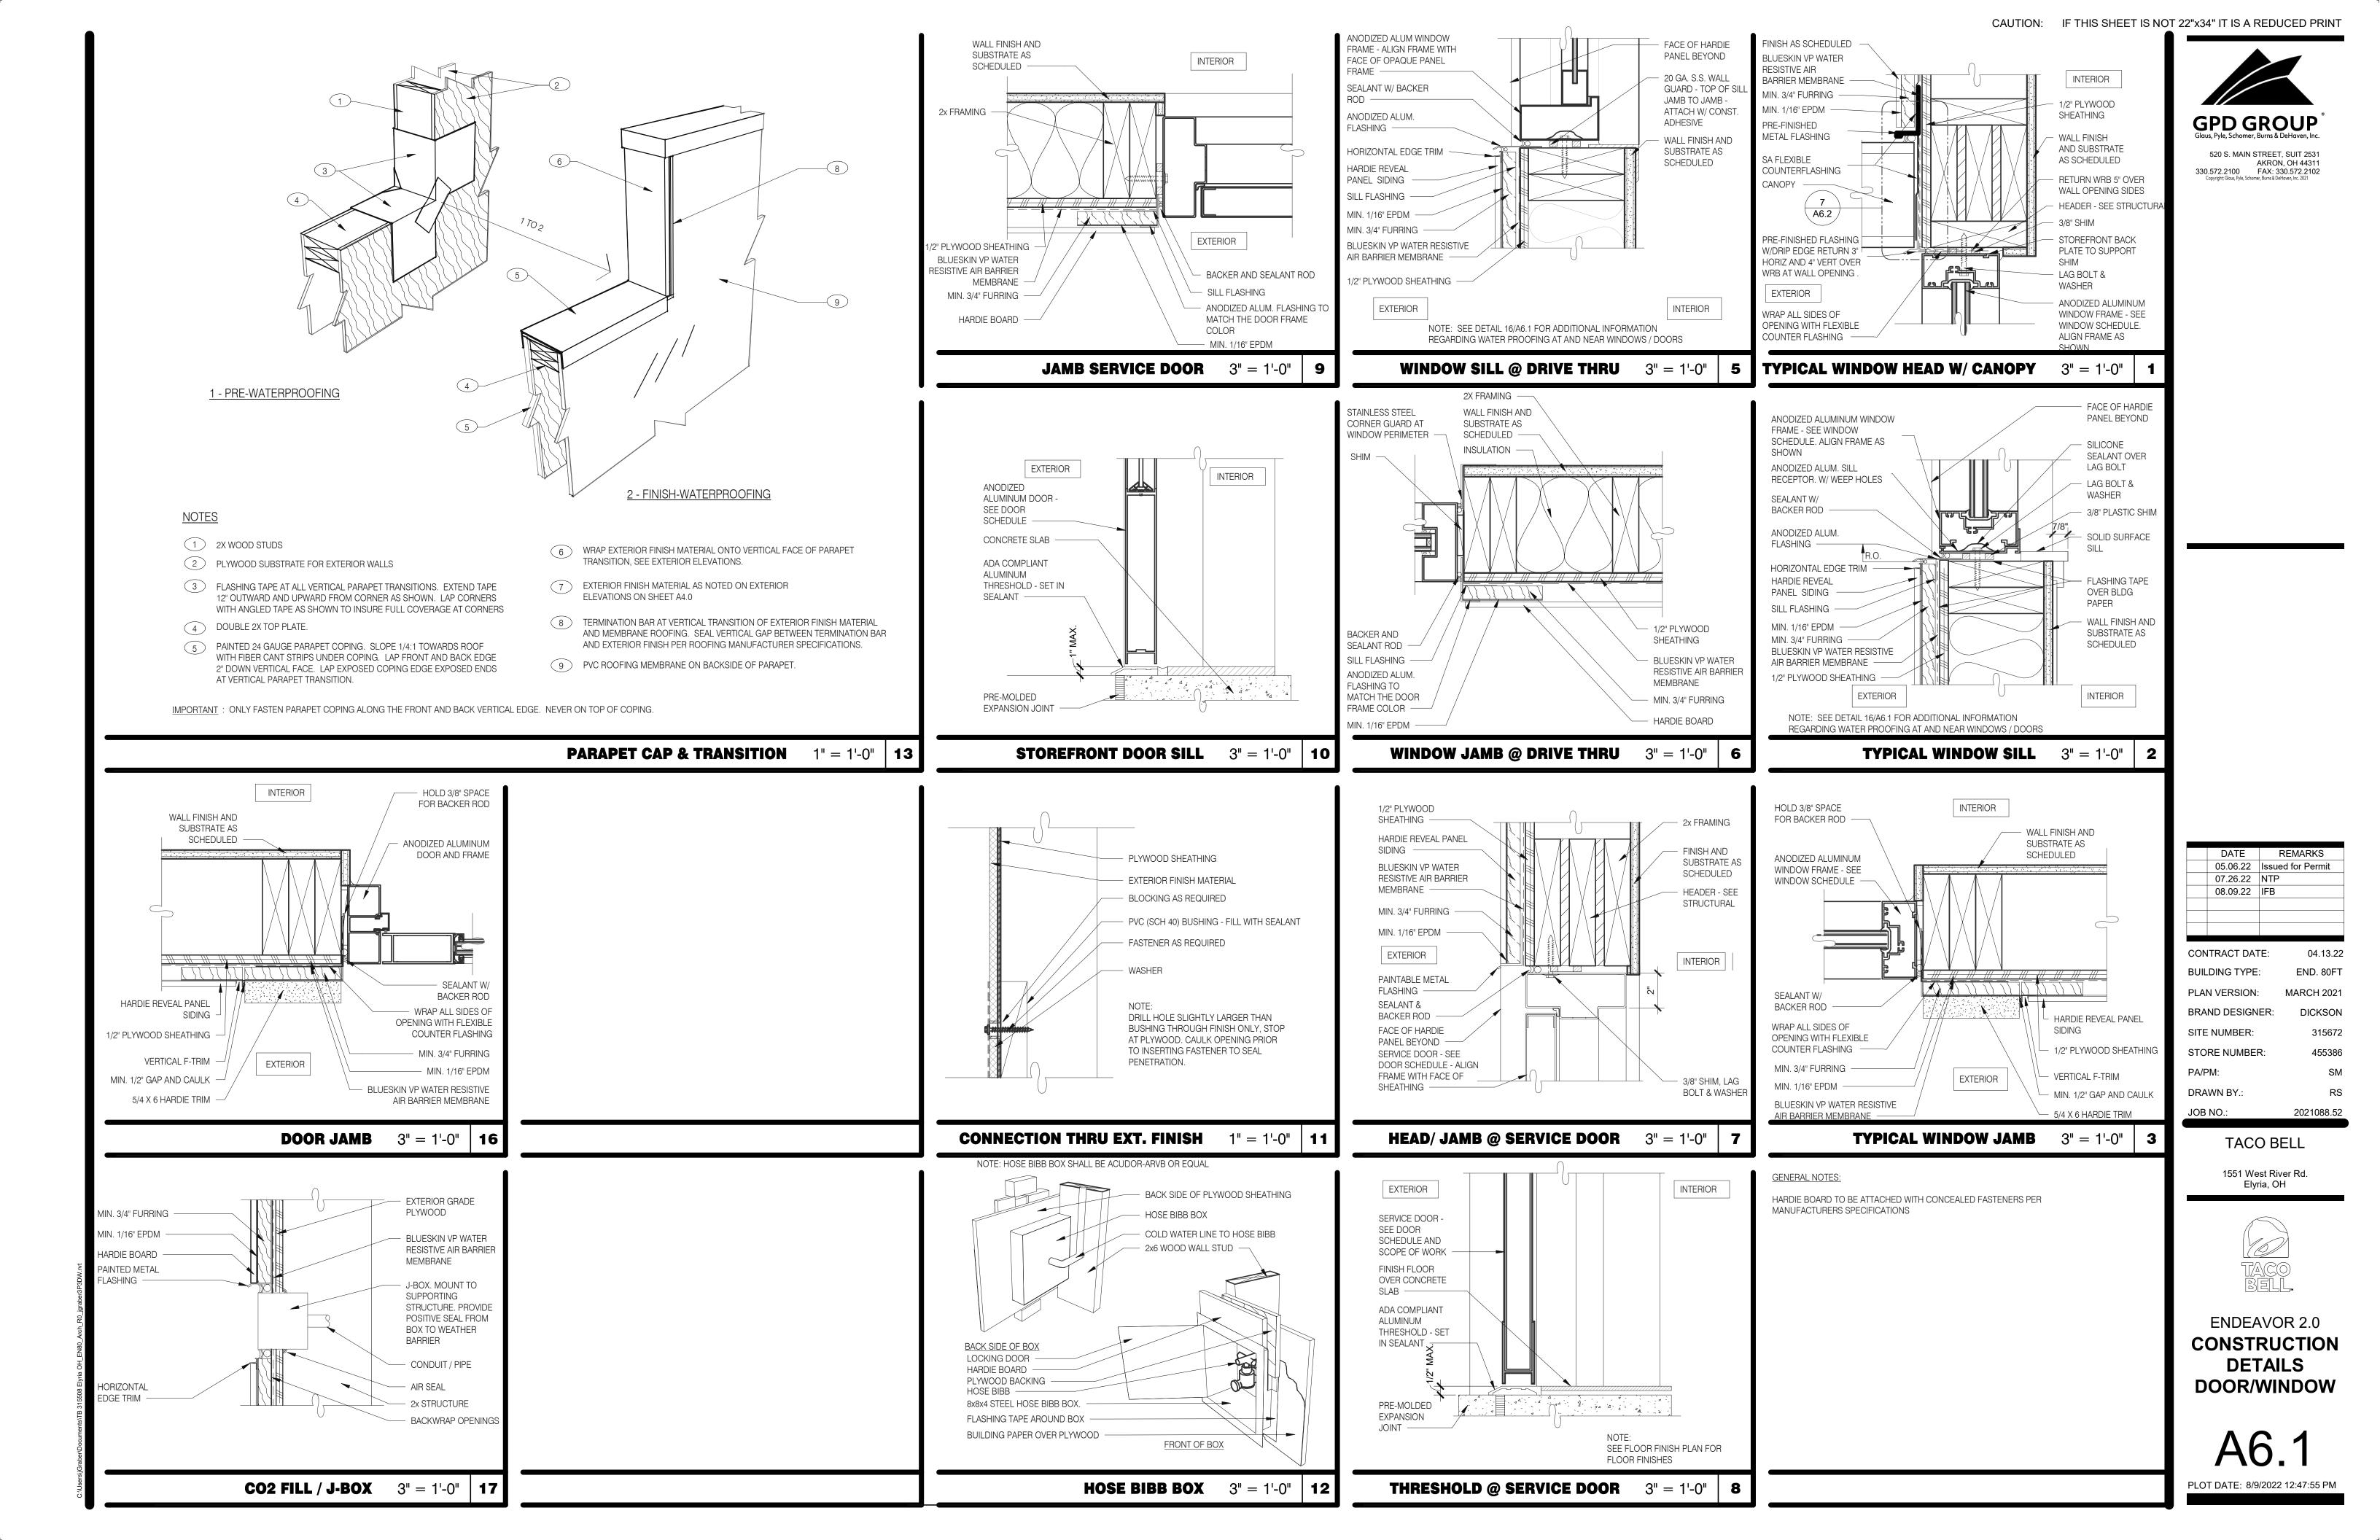

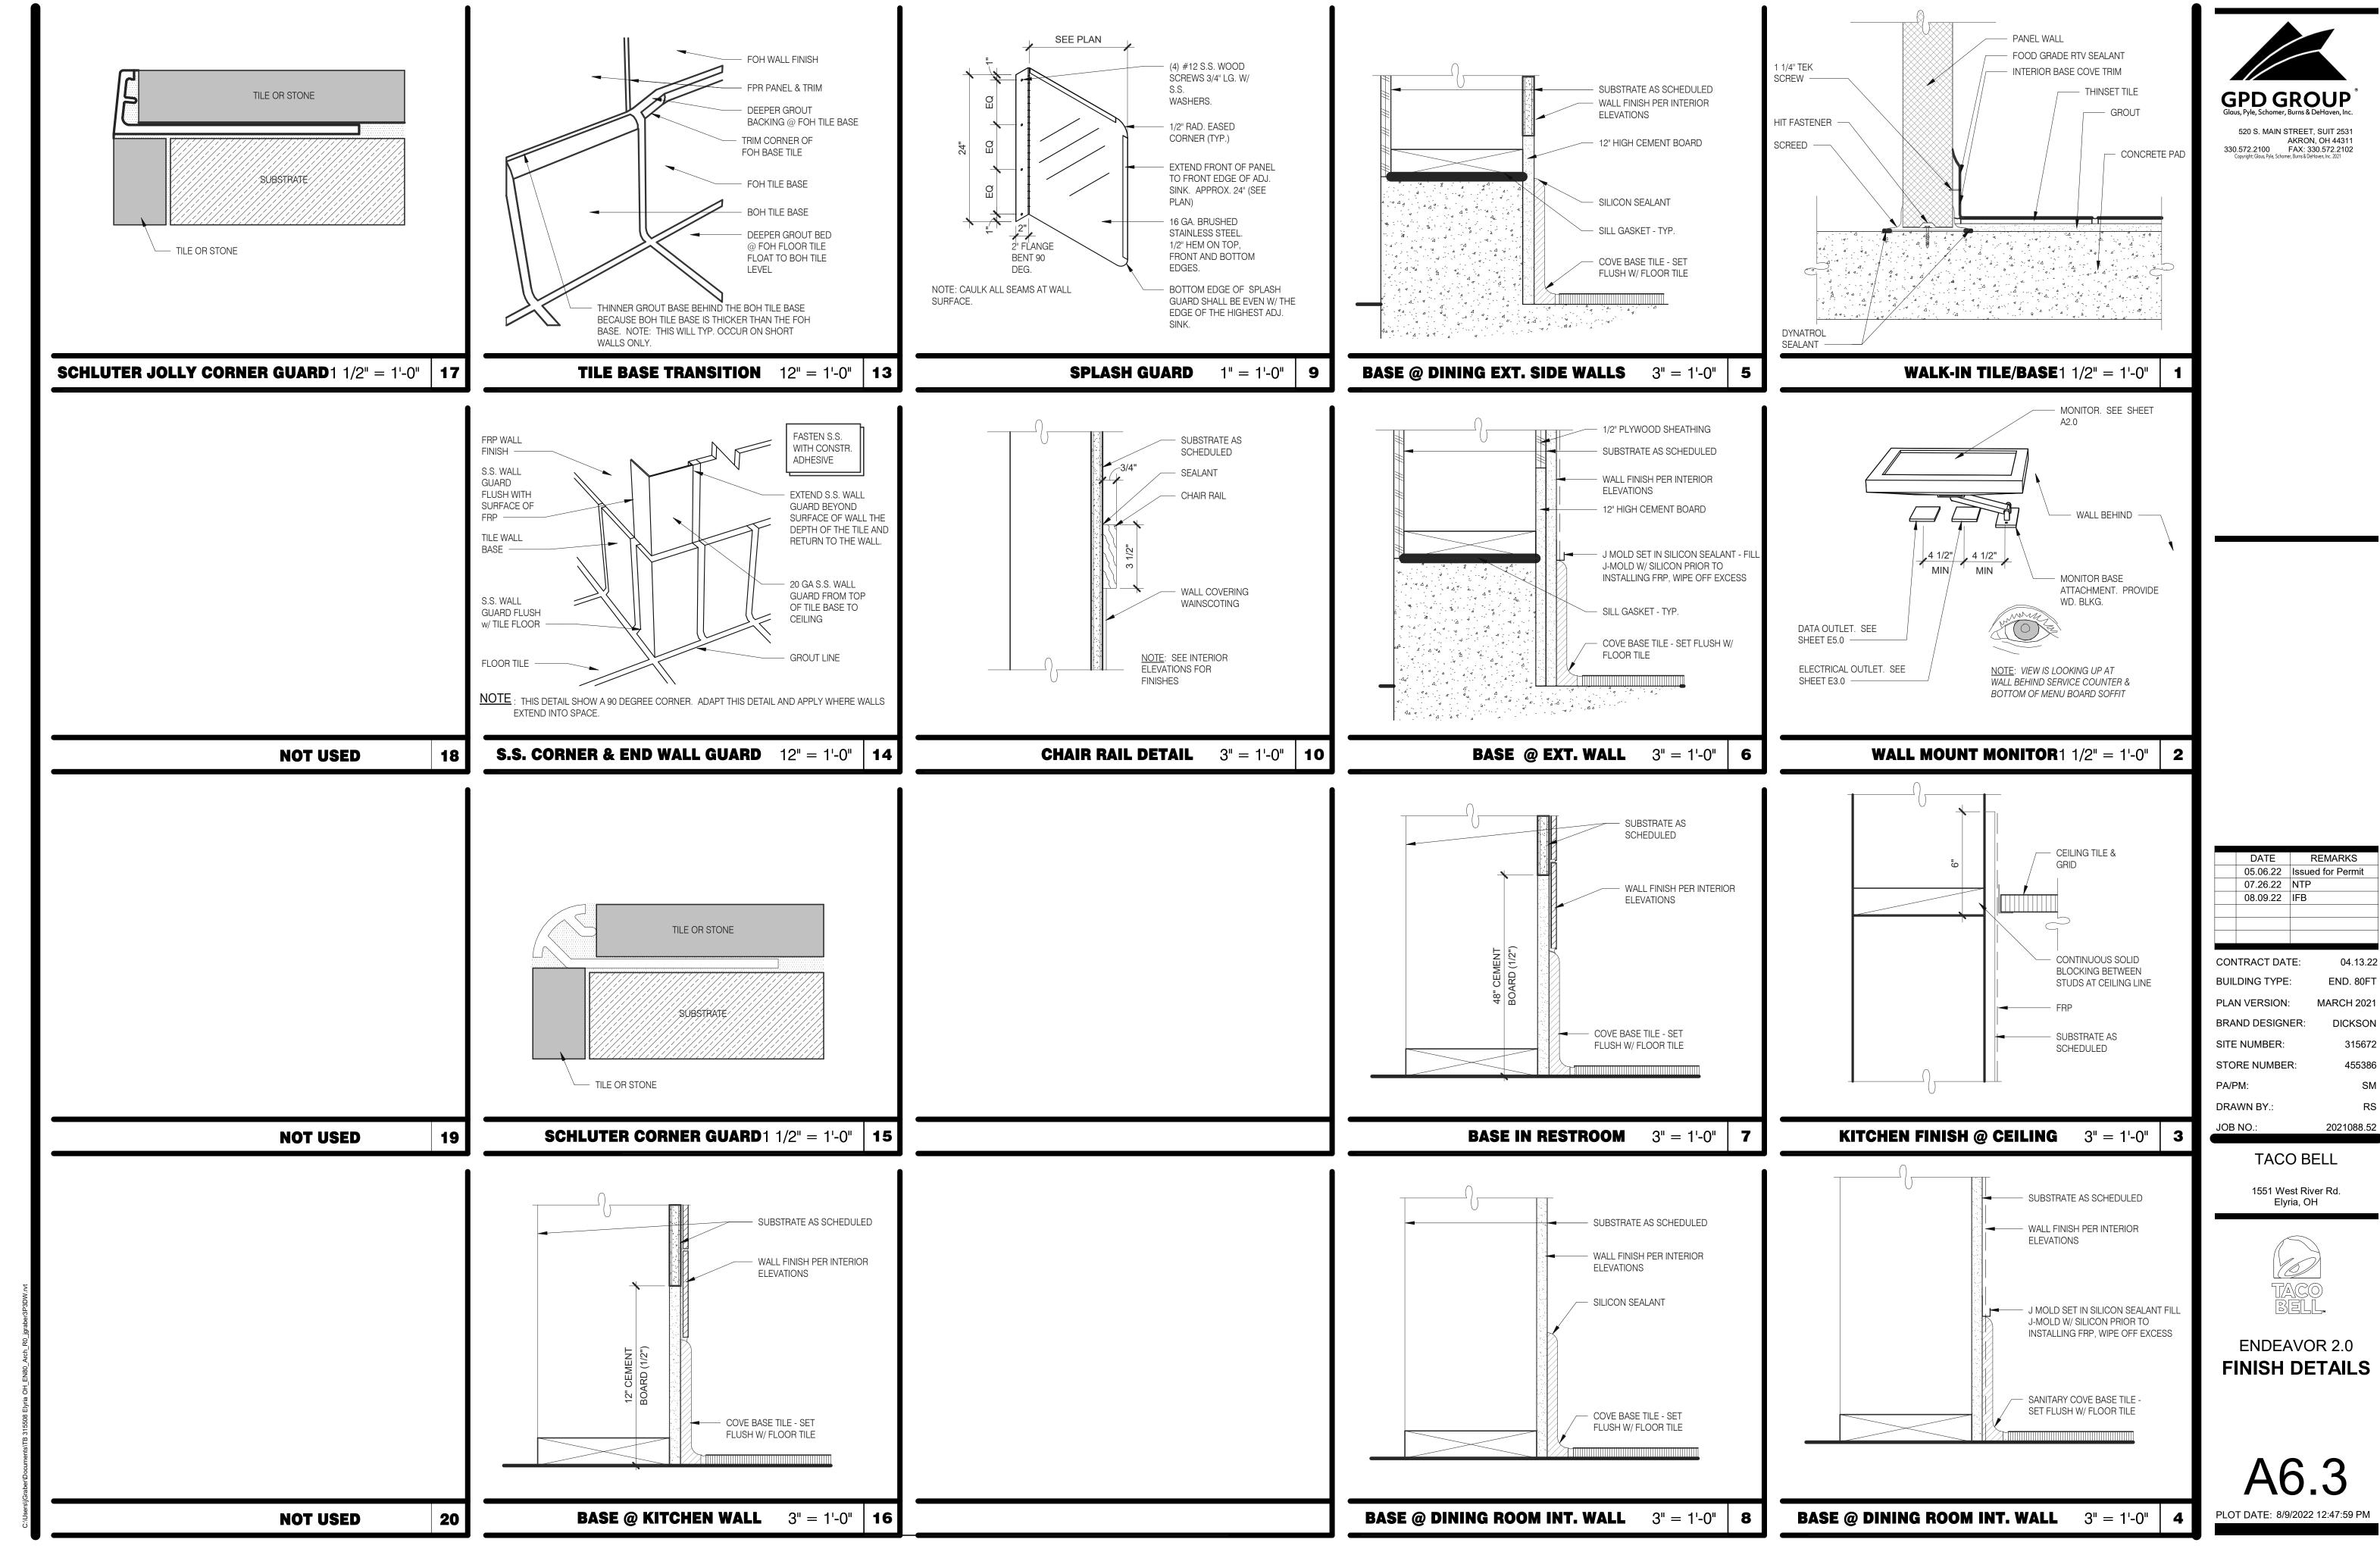

CAUTION: IF THIS SHEET IS NOT 22"x34" IT IS A REDUCED PRINT



05.06.22 Issued for Permit 07.26.22 NTP 08.09.22 IFB CONTRACT DATE: 04.13.22							
08.09.22 IFB		05.06.22	Issued for Permit				
		07.26.22	NTP				
CONTRACT DATE: 04.13.22		08.09.22	IFB				
CONTRACT DATE: 04.13.22							
CONTRACT DATE: 04.13.22							
CONTRACT DATE: 04.13.22							
CONTRACT DATE: 04.13.22							
	CONTRACT DATE: 04.13.22						

CONTRACT DATE: 04.13.22
BUILDING TYPE: END. 80FT
PLAN VERSION: MARCH 2021
BRAND DESIGNER: DICKSON
SITE NUMBER: 315672
STORE NUMBER: 455386
PA/PM: SM
DRAWN BY.: RS
JOB NO.: 2021088.52

TACO BELL


1551 West River Rd. Elyria, OH




ENDEAVOR 2.0
CONSTRUCTION
DETAILS
INTERIOR


A6.4

PLOT DATE: 8/9/2022 12:48:00 PM

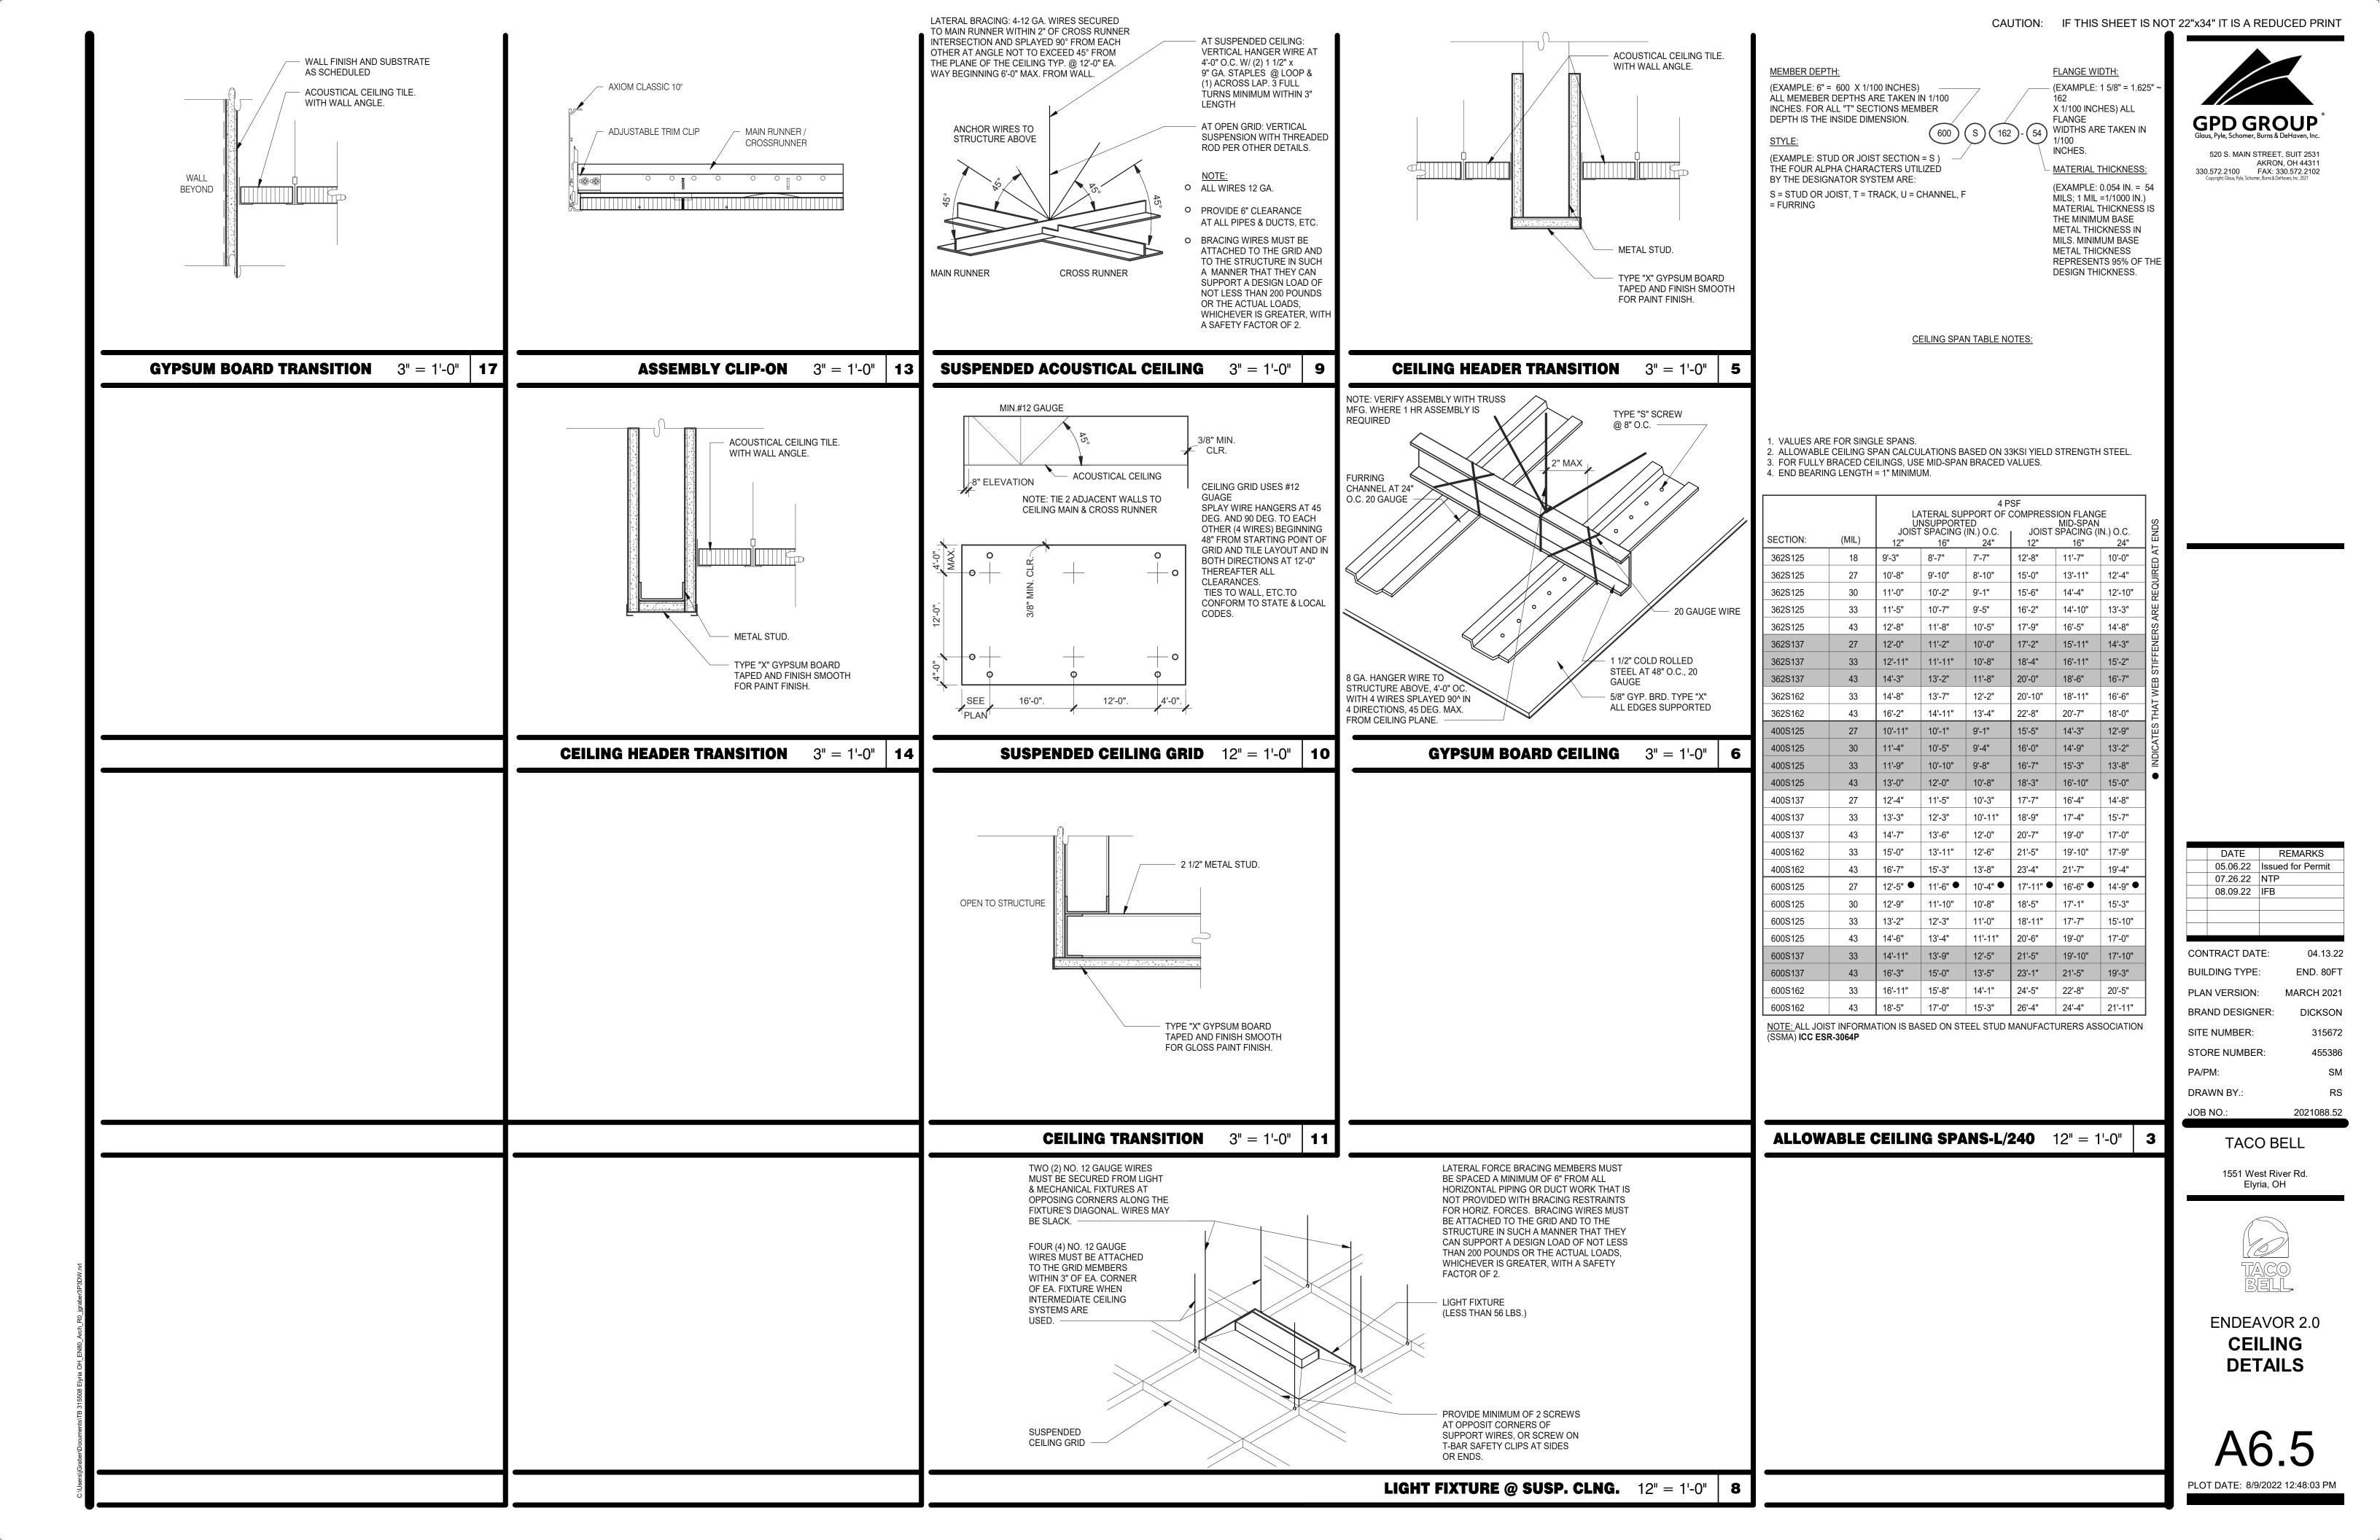

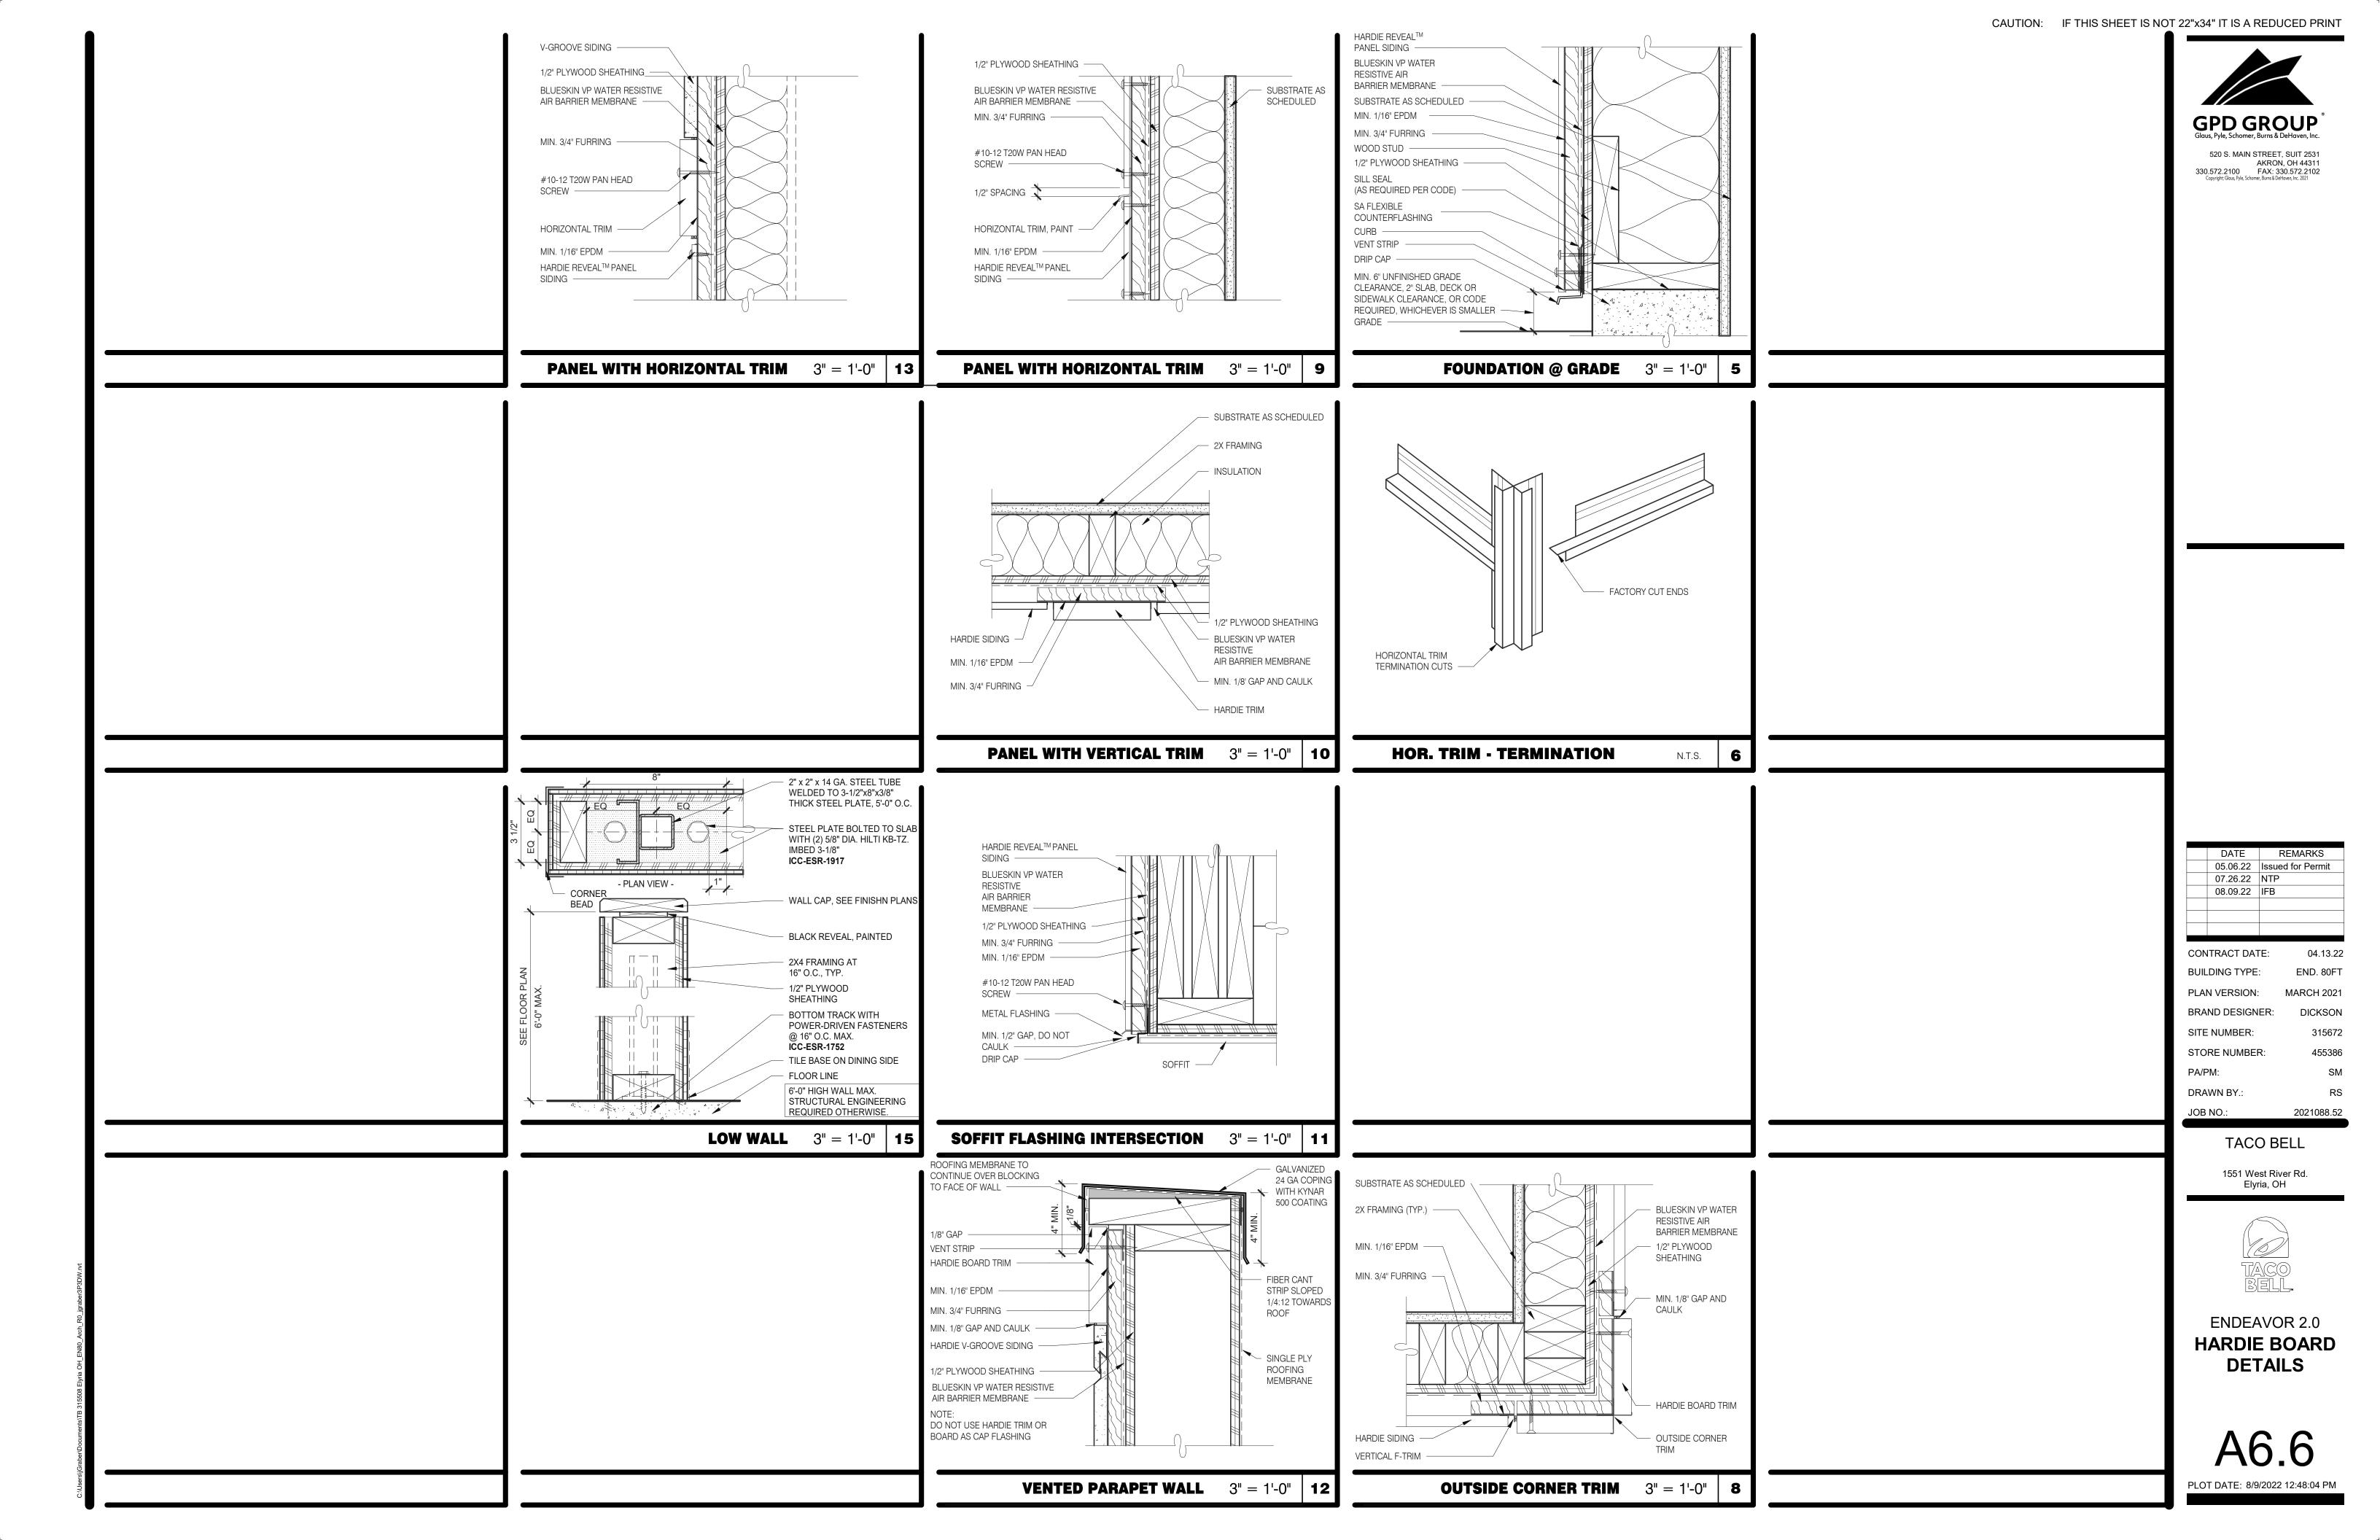



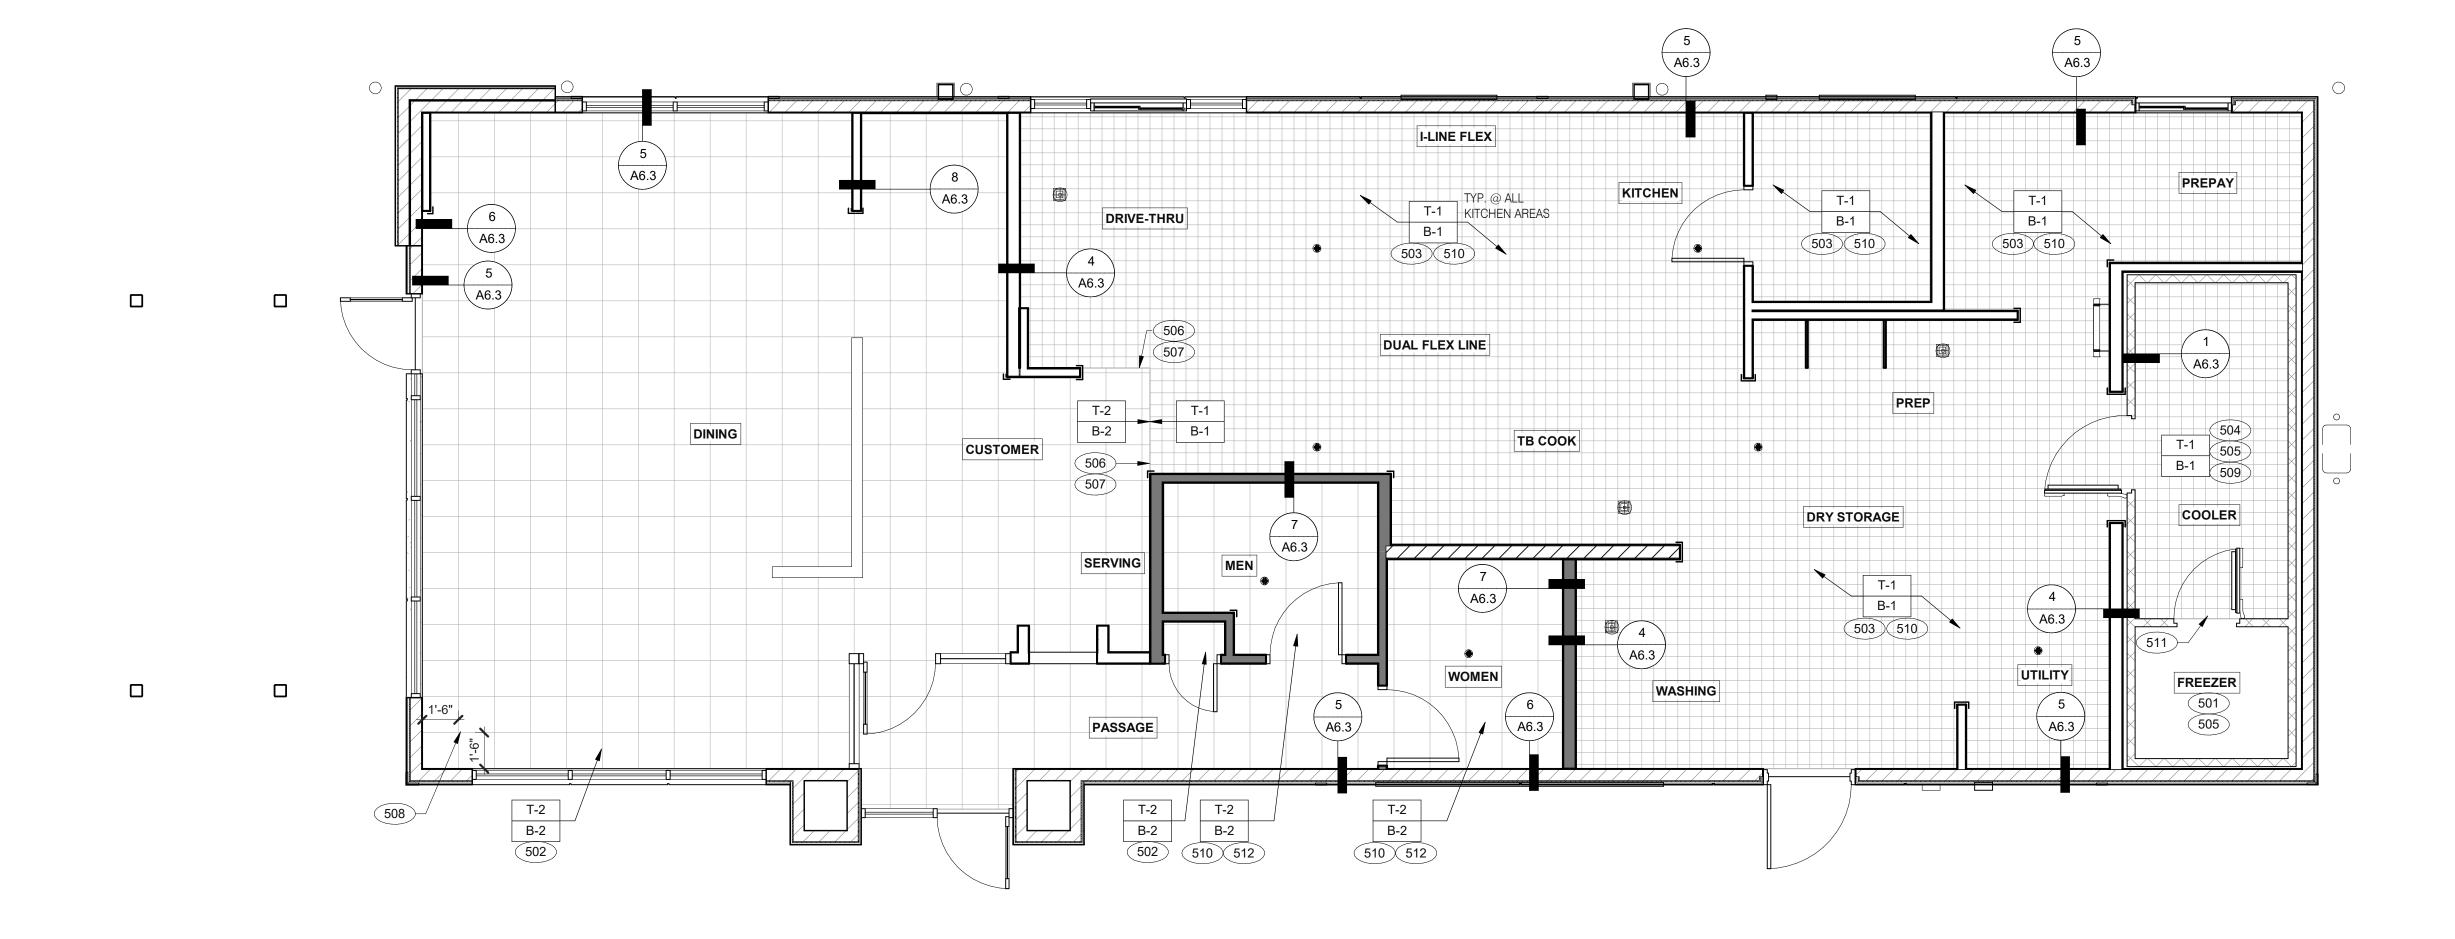



SITE NUMBER:

PA/PM:

STORE NUMBER:

07.26.22 NTP 08.09.22 IFB

04.13.22

DICKSON

315672

455386

2021088.52

DRAWN BY.: JOB NO.: FLOOR FINISH PLAN 1/4" = 1'-0"

DENOTES FINISH MATERIAL. REFER TO SHT A7.2 FOR FINISHES

B. TILE JOINT (U.O.N.): 1.QUARRY FLOOR TILE: 1/4" 2.PORCELAIN FLOOR TILE: 3/16" 3.GLAZED WALL TILE: 1/8"

4.BASE, TRIM AND ACCESSORIES: MATCH ADJOINING TILE UNITS

C. TILE INSTALLATIONS REQUIRE MANUFACTURERS STANDARD MOLDED CORNERS AT BOTH INSIDE AND OUTSIDE CORNERS.

D. ALL BASE TILE SHALL BE SANITARY COVE STYLE WITH 3/8" MIN RADIUS UNLESS NOTED OTHERWISE.

E. SEE SCOPE OF WORK SHEETS FOR RESPONSIBILITIES.

F. PROVIDE CLEAR SILICONE CAULK WHERE FRP STOPS AT TOP OF COVE BASE.

G. TILE CHIPPING AROUND CORE DRILL HOLES FOR SEATING FIXTURE WILL NOT BE ACCEPTED.

501 FACTORY FLOOR FINISH (GALV STL) W/INTEGRAL COVE BASE.

502 6" COVE TILE BASE. SEE DETAILS 5 & 8/A6.3. 503 6" SANITARY COVE TILE BASE. SEE DETAILS 4, 6/A6.3.

504 PROVIDE FLOOR TILE INSIDE WALK-IN COOLER (NO TILE OR BASE IN

FREEZER). FLOAT FLOOR TILE IN COOLERS TO DRAIN TO KITCHEN. COORDINATE WITH COOLER WALL CONFIGURATION.

NO BASE TILE BEHIND W-059 FOR WALK-IN COOLER/FREEZER. 506 ALIGN FLOOR TILE TRANSITION WITH FACE OF WALL.

507 FLOAT FLOOR TILE FOR FLUSH TRANSITION.

508 START POINT FOR FLOOR TILE.

509 METAL BASE IN COOLER; SEE SCOPE OF WORK. SEE DETAIL 1/A6.3.

510 REFER TO STRUCTURAL DRAWINGS FOR CONCRETE FLOOR SLOPES AROUND FLOOR DRAINS.

511 STEP-UP AT FREEZER THRESHOLD.

C

512 SANITARY TILE BASE IN RESTROOM.

ENDEAVOR 2.0 FLOOR FINISH PLAN

TACO BELL


1551 West River Rd.


Elyria, OH

PLOT DATE: 8/9/2022 12:48:07 PM

FLOOR FINISH NOTES NOT USED D

KEY NOTES

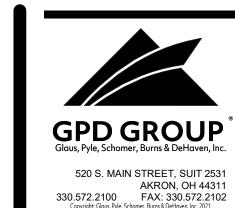

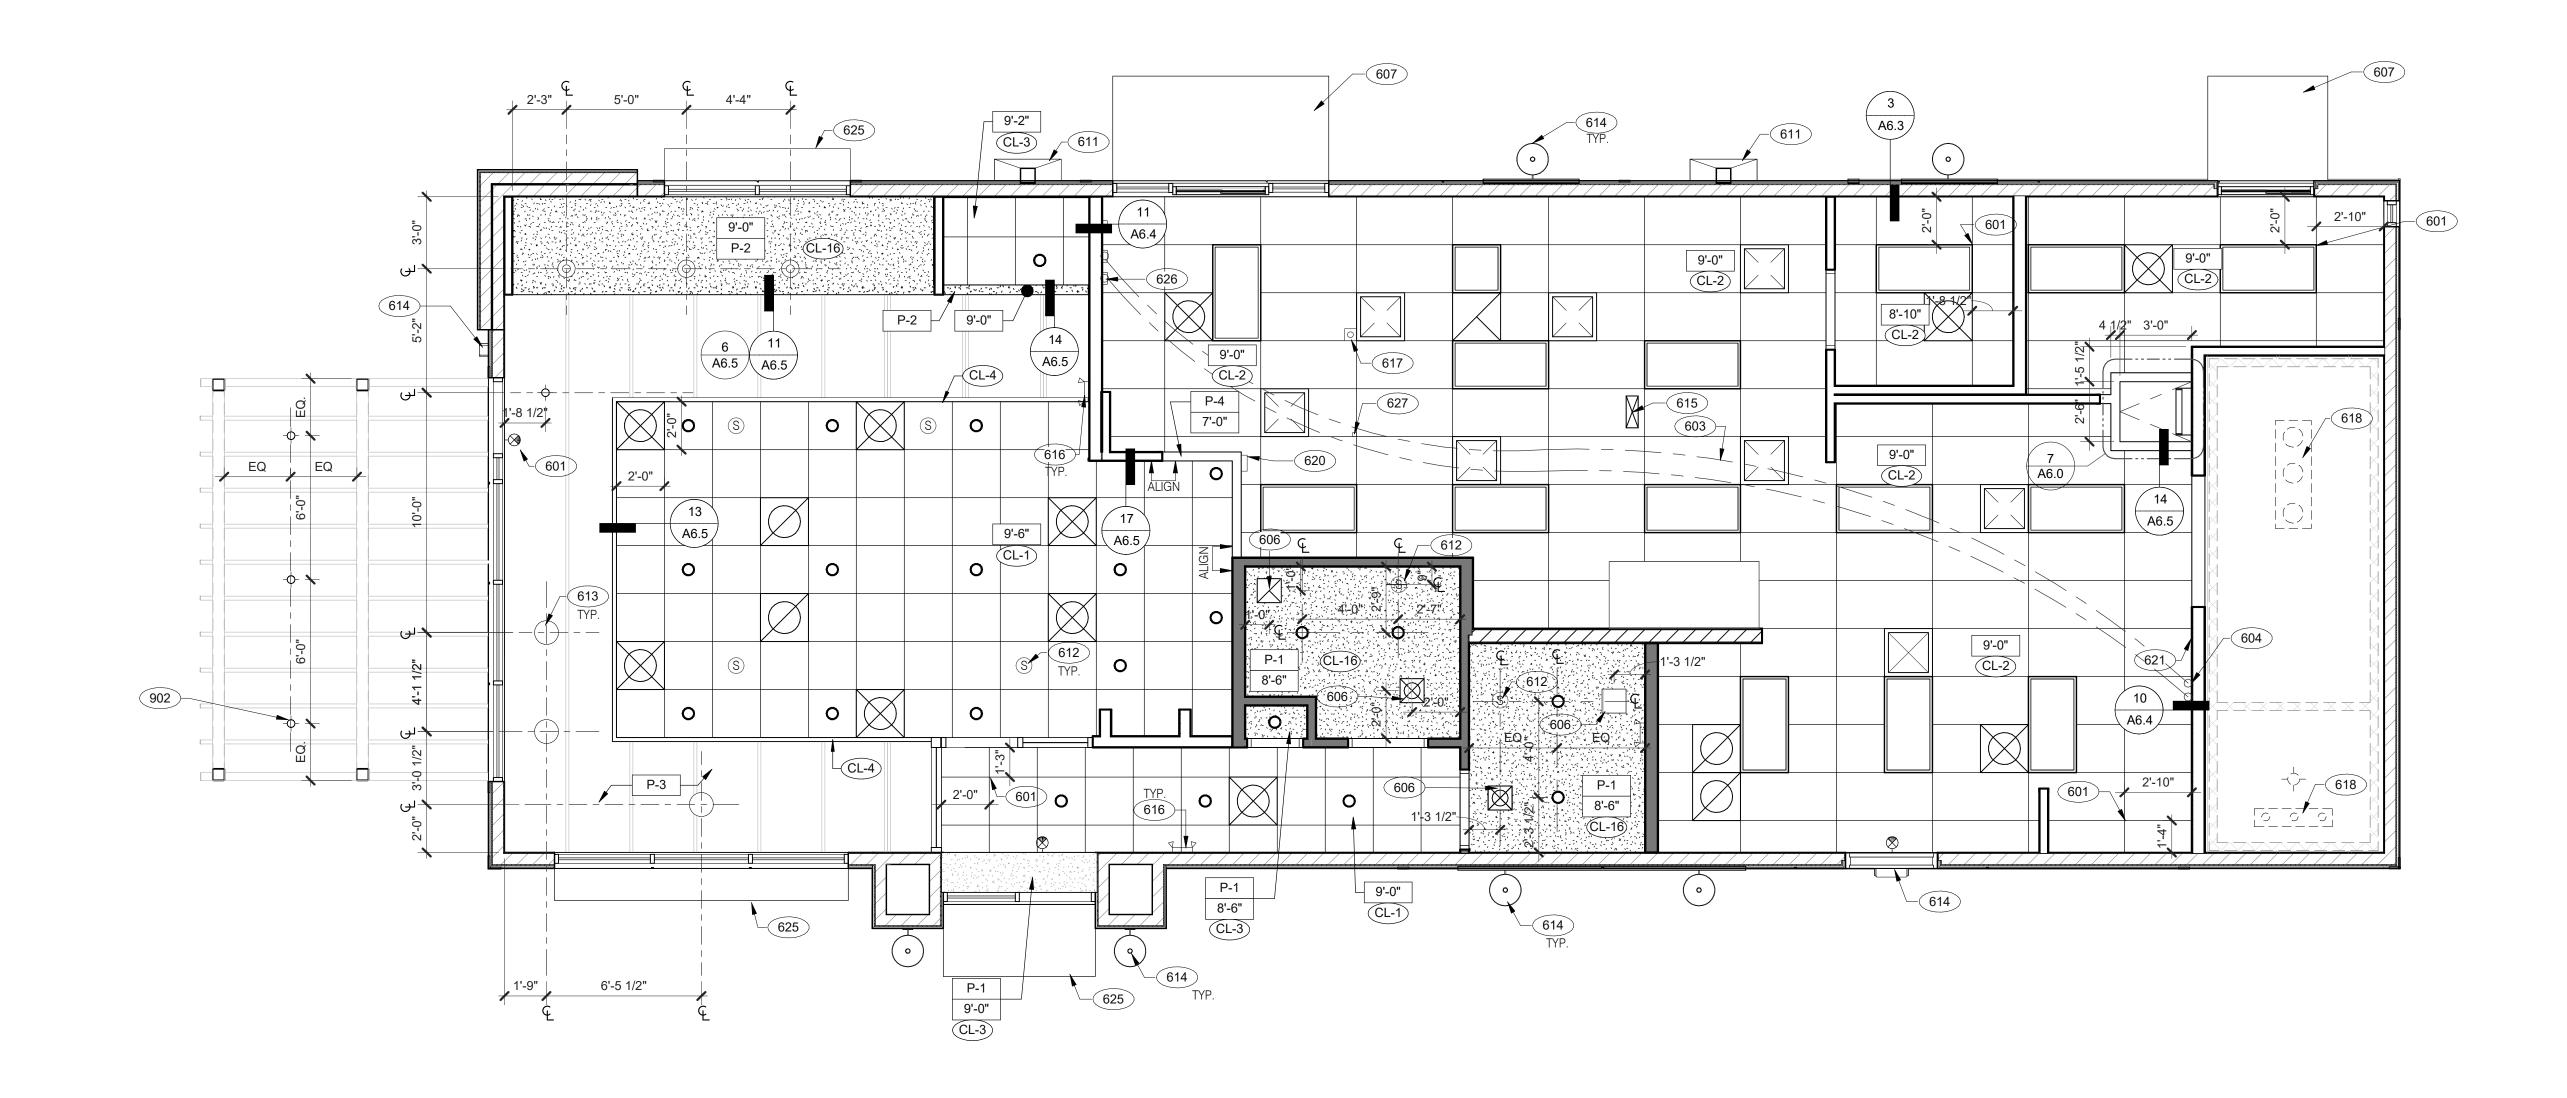



SITE NUMBER: 315672 STORE NUMBER: 455386 PA/PM: DRAWN BY.:

DICKSON

2021088.52

BRAND DESIGNER:

07.26.22 NTP 08.09.22 IFB

TACO BELL

1551 West River Rd.

Elyria, OH



ENDEAVOR 2.0 REFLECTED **CEILING PLAN**

PLOT DATE: 8/9/2022 12:48:11 PM

REFLECTED CEILING PLAN 1/4" = 1'-0"

EXIT LIGHT (WALL MOUNTED) 1'-0" x 4'-0" LED TROFFER EXIT LIGHT (CEILING MOUNTED) 2'-0" x 4'-0" EXTERIOR WALL LED TROFFER **FIXTURE** SPEAKER - CENTER 2'-0" x 4'-0" LED LIGHT ON CEILING TILE **FIXTURE** 12" EXHAUST FAN DOWNLIGHT @ WALK-IN

(BY WALK-IN MFR.) PENDANT FIXTURE.

ON CEILING TILE

EMERGENCY LIGHT

HVAC RETURN GRILLE DOWNLIGHT - CENTER

CEILING SYMBOL LEGEND

HVAC SUPPLY DIFFUSER STROBE LIGHT

BACK DOOR SECURITY OCCUPANCY SENSOR.

CEILING MOUNTED

ELECTRICAL: A. SEE ELECT. DWGS. FOR FIXTURE SCHED.

DIMENSIONS:

CEILING GRID AT STARTING POINT. NON-INSULATED BUNDLED SYRUP LINES FOR DRINK SYSTEM. SEE SCOPE A. ALL DIMENSIONS ARE TO FACE OF FINISH U.O.N.

CEILING FINISHES: A. REFER TO ROOM FINISH SCHEDULE (SHT A7.2) FOR CLG. FINISHES.

SUSPENDED CEILING: A. ACOUSTICAL PANEL INSTALLATION: INSTALL ACOUSTICAL PANELS WITH EDGES IN CLOSE

CONTACT WITH METAL SUPPORTS AND IN TRUE ALIGNMENT. B. ALLOWABLE VARIATIONS FROM FLAT AND LEVEL SURFACE: 1/8" IN 10'-0" MAX. C. ALLOWABLE VARIATIONS FROM PLUMB OF GRID MEMBERS: AS CAUSED BY ECCENTRIC LOADS,

D. INSTALL SYSTEM AFTER MAJOR ABOVE CLG. WORK IS COMPLETE. COORD LOCATIONS OF HANGERS WITH RELATED WORK.

GYPSUM BOARD CEILING: A. SUBSTRATE SHALL BE 1/2" THICK GYP BD.

E. SEE SPECS FOR ADDITIONAL INFORMATION.

B. ACOUSTICAL SEALANT: APPLY TO GYP. BD. PANELS AS INDICATED IN SPECS. GYP. BD. FINISHING AND DECORATING: REFER TO DWGS FOR TEXTURE AND FINISHES.

626

RESTROOMS).

613 PENDANT LIGHTING.

DRAWINGS.

618 FAN COIL FOR WALK-IN.

BOX 7'-11" A.F.F.

625 AWNING, SEE SCOPE OF WORK.

611 VERTICAL DOWNSPOUT.

DRIVE-THRU CANOPY.

612 SPEAKER. CENTER ON CEILING TILE, UON.

615 UTILITY CHASE BY 3RD PARTY VENDOR TO CEILING.

902 EXTERIOR LIGHTS, REFER TO ELECTRICAL LIGHTING PLANS.

ALERT LIGHT BOX FOR 3-COMP POWER SOAK MOUNTED AT CENTERLINE OF

30"X30" ACCESS OPENING IN REAR WALL ABOVE CEILING. FINISH WITH GYP.

6" DIAMETER PVC STUB THROUGH CEILING, SEE DETAIL 10/A6.4.

614 EXTERIOR WALL LIGHT FIXTURES, SEE ELEVATIONS AND ELECTRICAL

STAINLESS STEEL SYRUP CHASE ON WALL. SEE DETAIL 11/A6.4.

WATER INLET CHASE FOR CHEESE MELTER SCREWED TO HEATED AIR

616 EMERGENCY DUAL HEAD FIXTURE. SEE ELECTRICAL DRAWINGS.

617 SECURITY STROBE LIGHT, REFER TO ELECTRICAL DRAWINGS.

FOR ROUGH FRAMING OPENINGS SEE AIR DEVICE SCHEDULE (TYP. ALL

KEY NOTES

REFLECTED CEILING PLAN NOTES D C

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	DATE	REMARKS
	05.06.22	Issued for Permit
	07.26.22	NTP
	08.09.22	IFB
CONTRACT DATE: 04.13		

BUILDING TYPE: END. 80FT PLAN VERSION: MARCH 2021 BRAND DESIGNER: DICKSON SITE NUMBER: 315672 455386 STORE NUMBER: PA/PM: DRAWN BY.:

TACO BELL

2021088.52

1551 West River Rd. Elyria, OH



ENDEAVOR 2.0 FINISH SCHEDULE

PLOT DATE: 8/9/2022 12:48:13 PM

SYMBOL	MANUFACTURER	STYLE	COLOR	SIZE	GROUT	COMMENTS
	WANTACTOTILIT	OTTLE	OCLOTT	OIZL.	anoo1	COMMENTO
CL-1	USG	ACT SYSTEM, USG RADAR, CLIMAPLUS PERFORMANCE SQ EDGE	#107 TAUPE	2X2	N/A	USG DONN BRAND DX/DXL 15/16 TEE SYSTEM, INTERMEDIATE DUTY #107 TA
CL-2	USG	ACT SYSTEM, USG CLEAN ROOM ACOUSTICAL PANELS, CLIMAPLUS PERFORMANCE, SQ EDGE	#050 WHITE	2x4	N/A	CLASS 100 (ISO 5) PANELS, USG DONN BRAND DX/DXL 15/16 TEE SYSTEM, INTERMEDIATE DUTY #050 WHITE
CL-3	USG	ACT SYSTEM, USG CLEAN ROOM ACOUSTICAL PANELS, CLIMAPLUS PERFORMANCE, SQ EDGE	#050 WHITE	2X2	N/A	CLASS 100 (ISO 5) PANELS, USG DONN BRAND DX/DXL 15/16 TEE SYSTEM, INTERMEDIATE DUTY #050 WHITE
CL-4	USG	USG COMPASSO STANDARD	#002 SILVER SATIN	10"H PROFILE		SEE PLANS AND DETAILS FOR MORE INFO
CL-16	N/A	GYPSUM BOARD	PAINTED PER RCP			
CHAIR RAIL						
CR-1	SW	SW7043	WORLDLY GRAY	3 1/2" X 3/4"		SEMI-GLOSS
FLOOR BASE B-1	CMC	QUARRY	PURITAN GREY #507	6X6	MAPEI #9 GRAY, 1/8" JOINT WIDTH	KERAPOXY GROUT IEG CQ
B-2	CMC	MOTIF GREY	GREY	6X12	MAPEI, #2 PEWTER, 1/8" JOINT WIDTH	
FLOORING T-1	CMC	QUARRY	PURITAN GREY #507	6X6	MAPEI #9 GRAY, 1/8" JOINT WIDTH	KERAPOXY GROUT IEG CQ
T-2	CMC	MOTIF GREY	GREY	18X18	MAPEI, #2 PEWTER, 1/8" JOINT WIDTH	
FRP/LAMINATE FRP-1	MARLITE	SMOOTH SURFACE	S100 S/2/S WHITE	4' X 9' X .90		COORDINATE ALL TRIM PIECES WITH FRP MFG
L-1	WILSONART	4783K FINISH 7	WHITE TIGRIS			OFFICE SHELVING LAMINATE
L-2	WILSONART	Y0664K-12	MOCHA ASH			SOFTGRAIN FINISH, RR/UTILITY DOORS VERTICAL GRADE PRODUCT CODE #362 IS .028" AND HORIZONTAL GRADE PRODUCT CODE #372 IS .039"
CORNER GUARDS CG-1	C.S GROUP	ACROVYN VA SERIES	VA-034N #934 PEARL	3/4" X 3/4"		FOR PAINT MATCH P-1
CG-2	C.S GROUP	ACROVYN VA SERIES	VA-034N #262 DRIFTWOOD	3/4" X 3/4"		FOR PAINT MATCH CR-1 & WC-1
METAL TRANSITION						
MT-1	SCHLUTER	JOLLY	A 100 AT - SATIN NICKEL ANODIZED ALUMINUM	3/8"	N/A	TILE EDGE TRIM DETAIL 17/A6.3
MT-3	SCHLUTER	RONDEC - ALUMINUM		3/8"	N/A	TILE EDGE TRIM DETAIL 17/A6.3
SOLID SURFACE SS-1	CORIAN	LAVA ROCK	LAVA ROCK			COUNTERTOPS/24" DIAMETER TABLE TOP
WALL COVERING WC-1	WOLF GORDON	'RAMPART' HIGH IMPACT WALL COVERING	FOUNDATION/ PIGMENT (GOH 12172606)		RAILROAD INSTALLATION: THERE SHOULD BE NO SEAMS ALONG WALLS	1 ROLL: 80 L.F.
VALL PAINT		OUUTAG			N/A	
P-1 P-2	SHERWIN WILLIAMS SHERWIN WILLIAMS	SW7021 TB2603C	SIMPLE WHITE PURPLE	N/A N/A	N/A N/A	PAINT FINISH: WALLS: EGGSHELL
P-3	SHERWIN WILLIAMS	SW7076	CYBER SPACE	N/A N/A	N/A	TRIM/BOH: SEMI-GLOSS (CHAIR RAIL)
P-4	SHERWIN WILLIAMS	SW7005	PURE WHITE	N/A	N/A	CEILING: FLAT
VALL TILE						
W-1	CMC	FORM	ICE DECO MIX	8X8	MAPEI #47 CHARCOAL, 1/8" JOINT WIDTH	RESTROOM ACCENT WALL TILE
W-2	CMC	FORM	ICE	8X8	MAPEI #47 CHARCOAL, 1/8" JOINT WIDTH	RESTROOM WALL TILE
_3	CMC	SALVAGEWOOD	WHITEWASH	3X36	MADEL#01 ALABASTER	RUNNING BOND INSTALLATION OFFSET 25%

FINISH LEGEND

RUNNING BOND INSTALLATION OFFSET 25%

CMC

WESTERN STATES METAL ROOFING
JESSICA TRIER
INSIDE SALES REPRESENTATIVE P: (602) 495-0048
D: (602) 422-2696
W: www.metalroofing.com
JESSICA@METALDECK.COM

<u>CORIAN</u>

W-3

DAVID GREENING NA COMMERCIAL SALES FOOD SERVICE/ RETAIL SEGMENT SALES LEADER CORIAN DESIGN (614) 975-6700

DAVID.P.GREENING@DUPONT.COM

JAMES HARDIE MATT PETERSEN CELL: (707)536-6271 MATTHEW.PETERSEN@JAMESHARDIE.COM CREATIVE MATERIALS CORP. ALLISON PICHE

SALVAGEWOOD

CLIENT SERVICES SUPERVISOR ONE WASHINGTON SQUARE, ALBANY, NY 12205 P: (518) 452-9694 D: (518) 713-5395 APICHE@CREATIVEMATERIALSCORP.COM

SHERWIN WILLIAMS
SUNNY PATEL NATIONAL ACCOUNT EXECUTIVE

2100 W. ORANGEWOOD AVE. SUITE 100 ORANGE, CA 92868 (619) 990-1920 SUNDEEPKUMAR.PATEL@SHERWIN.COM

WOLF GORDON JESSICA ROSE (213)999-1141 JESSICA.ROSE@WOLFGORDON.COM USG CORPORATION TRAVIS TOMANEK CORPORATE ACCOUNT MANAGER (440) 541-3972 TTOMANEK@USG.COM

WHITEWASH

MARLITE DAN EGBERS REGION SALES MANAGER -SPECIFICATIONS MARLITE, INC. P: (800) 377-1221 M: (330) 260-7633 1 MARLITE DRIVE, DOVER, OH 44622

www.marlite.com degbers@marlite.com


<u>MAPEI</u> LISA FYKE ARCHITECTURAL REPRESENTATIVE MAPEI CORP. (909) 247-5324 LFYKE@MAPEI.COM


3X36


MAPEI #01 ALABASTER, 1/8" JOINT WIDTH

D

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703 LTO MENUBOARD.

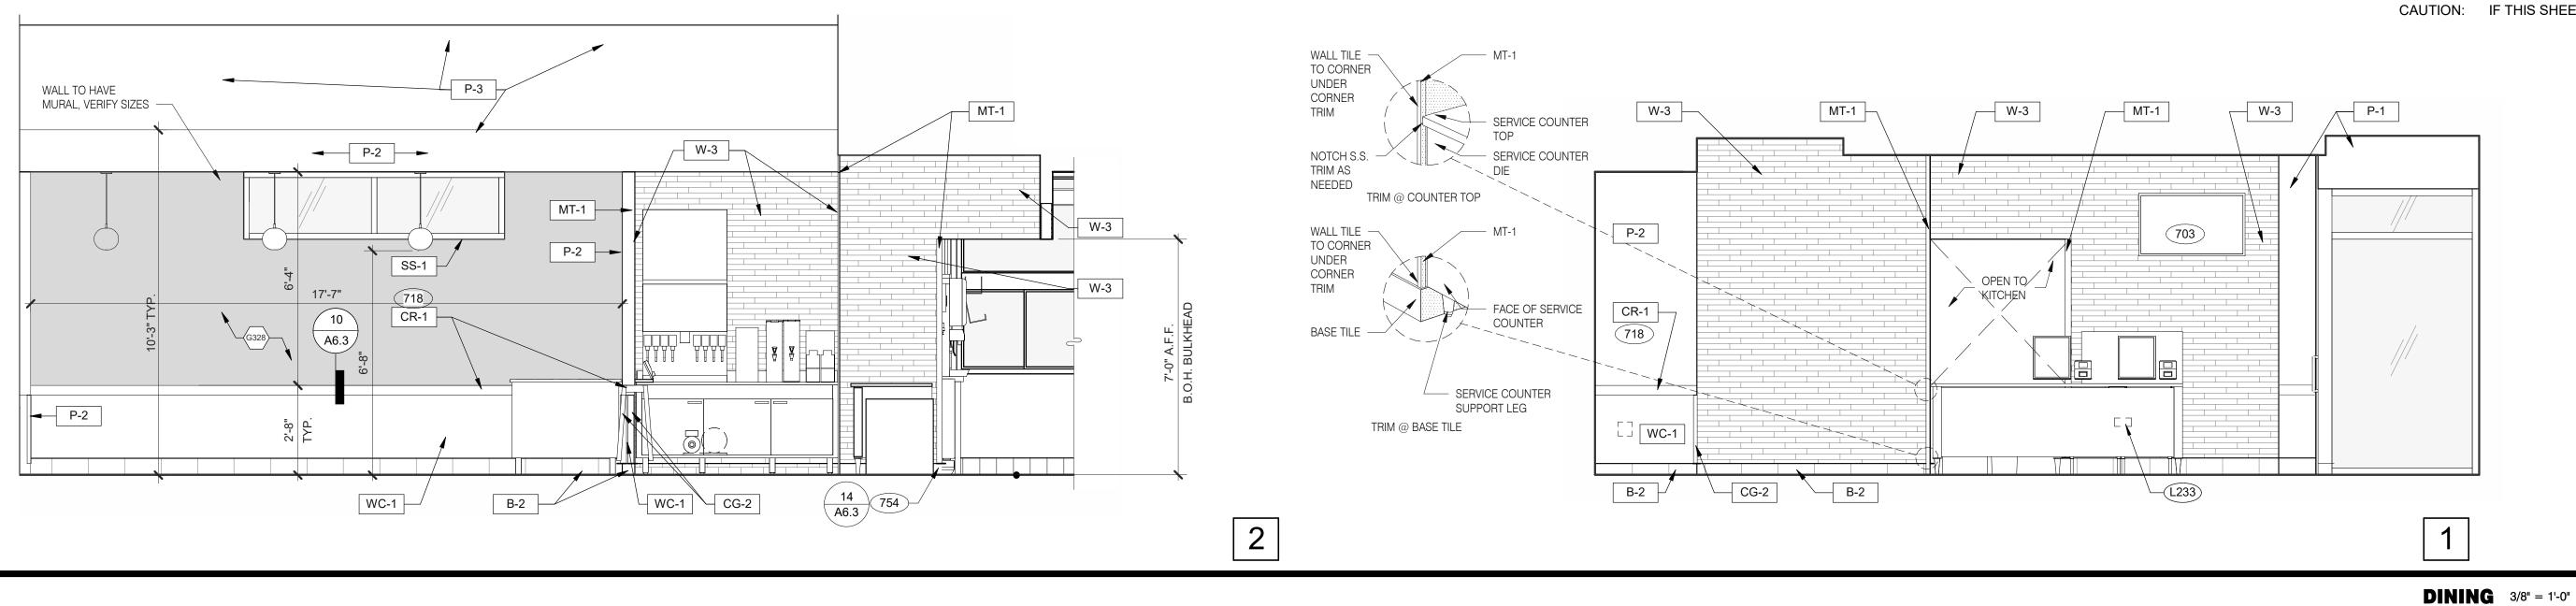715 SS CORNER/END WALL CHANNEL GUARD, FULL HEIGHT. SEE DETAIL 14/A6.3

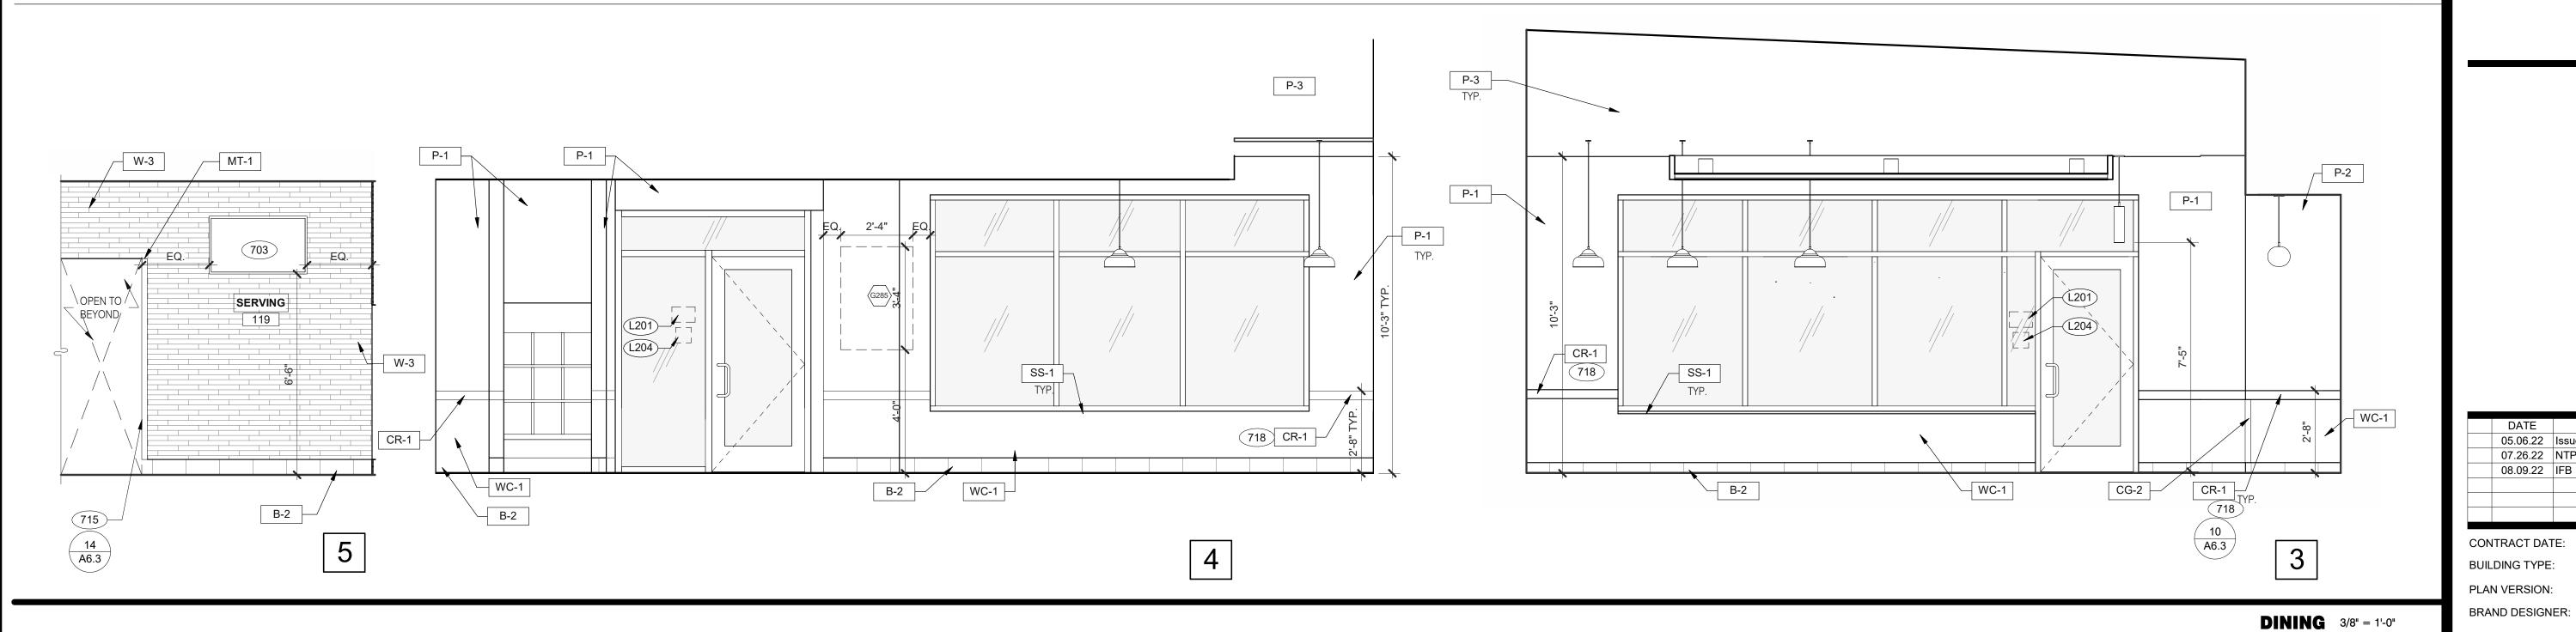718 CHAIR RAIL.

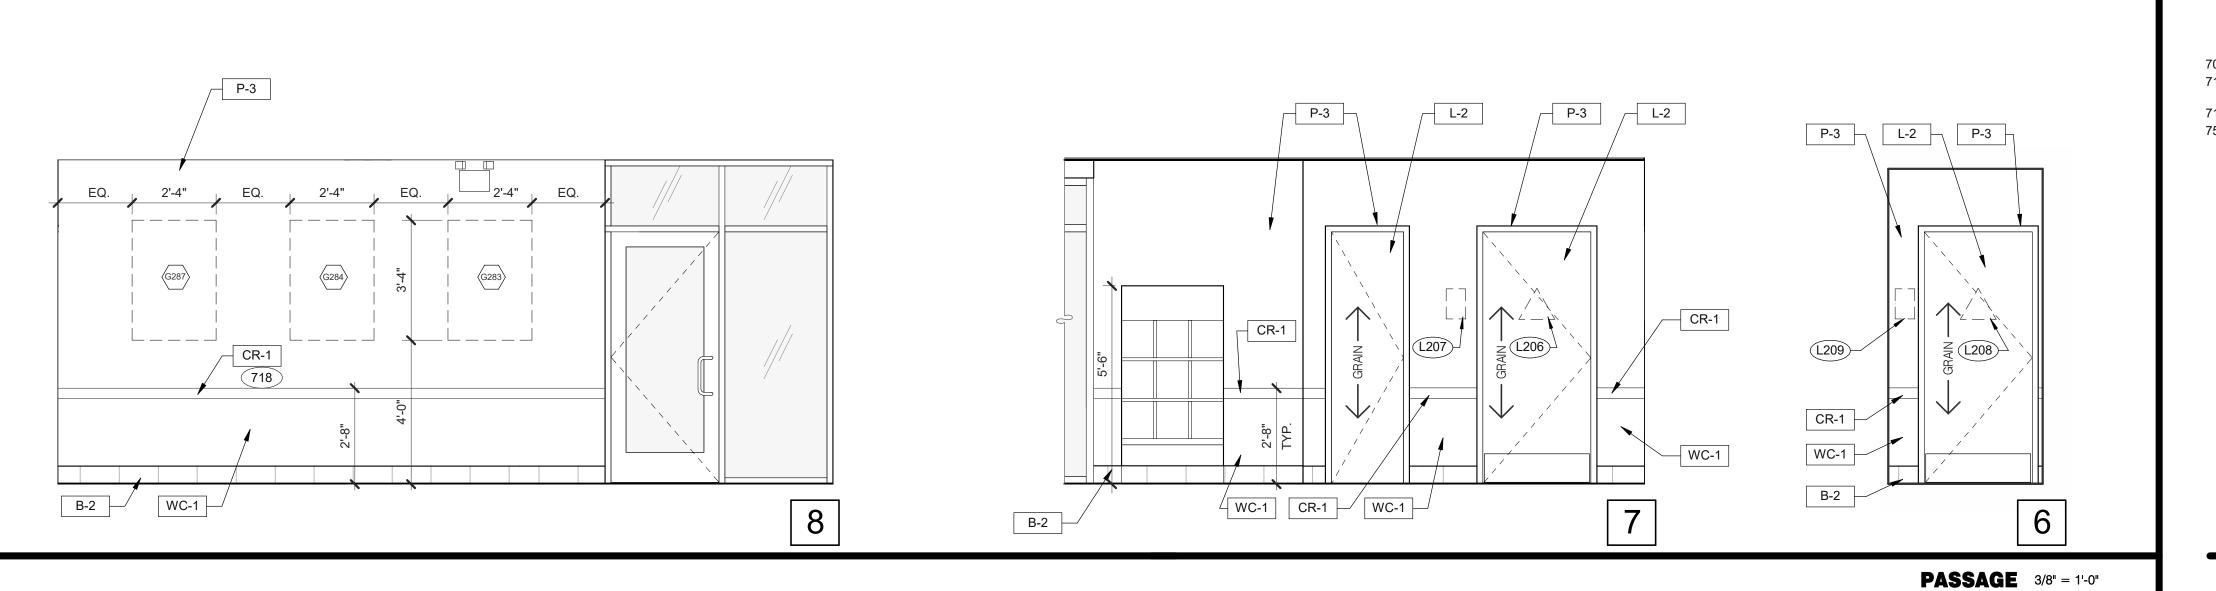754 SS CORNER/END WALL CHANNEL GUARD, FULL HEIGHT.



TACO BELL

1551 West River Rd. Elyria, OH

07.26.22 NTP 08.09.22 IFB

SITE NUMBER:

PA/PM:

DRAWN BY.:

STORE NUMBER:


END. 80FT

2021088.52

MARCH 2021

ENDEAVOR 2.0 INTERIOR ELEVATIONS DINING ROOM

PLOT DATE: 8/9/2022 12:48:19 PM **KEYNOTES**

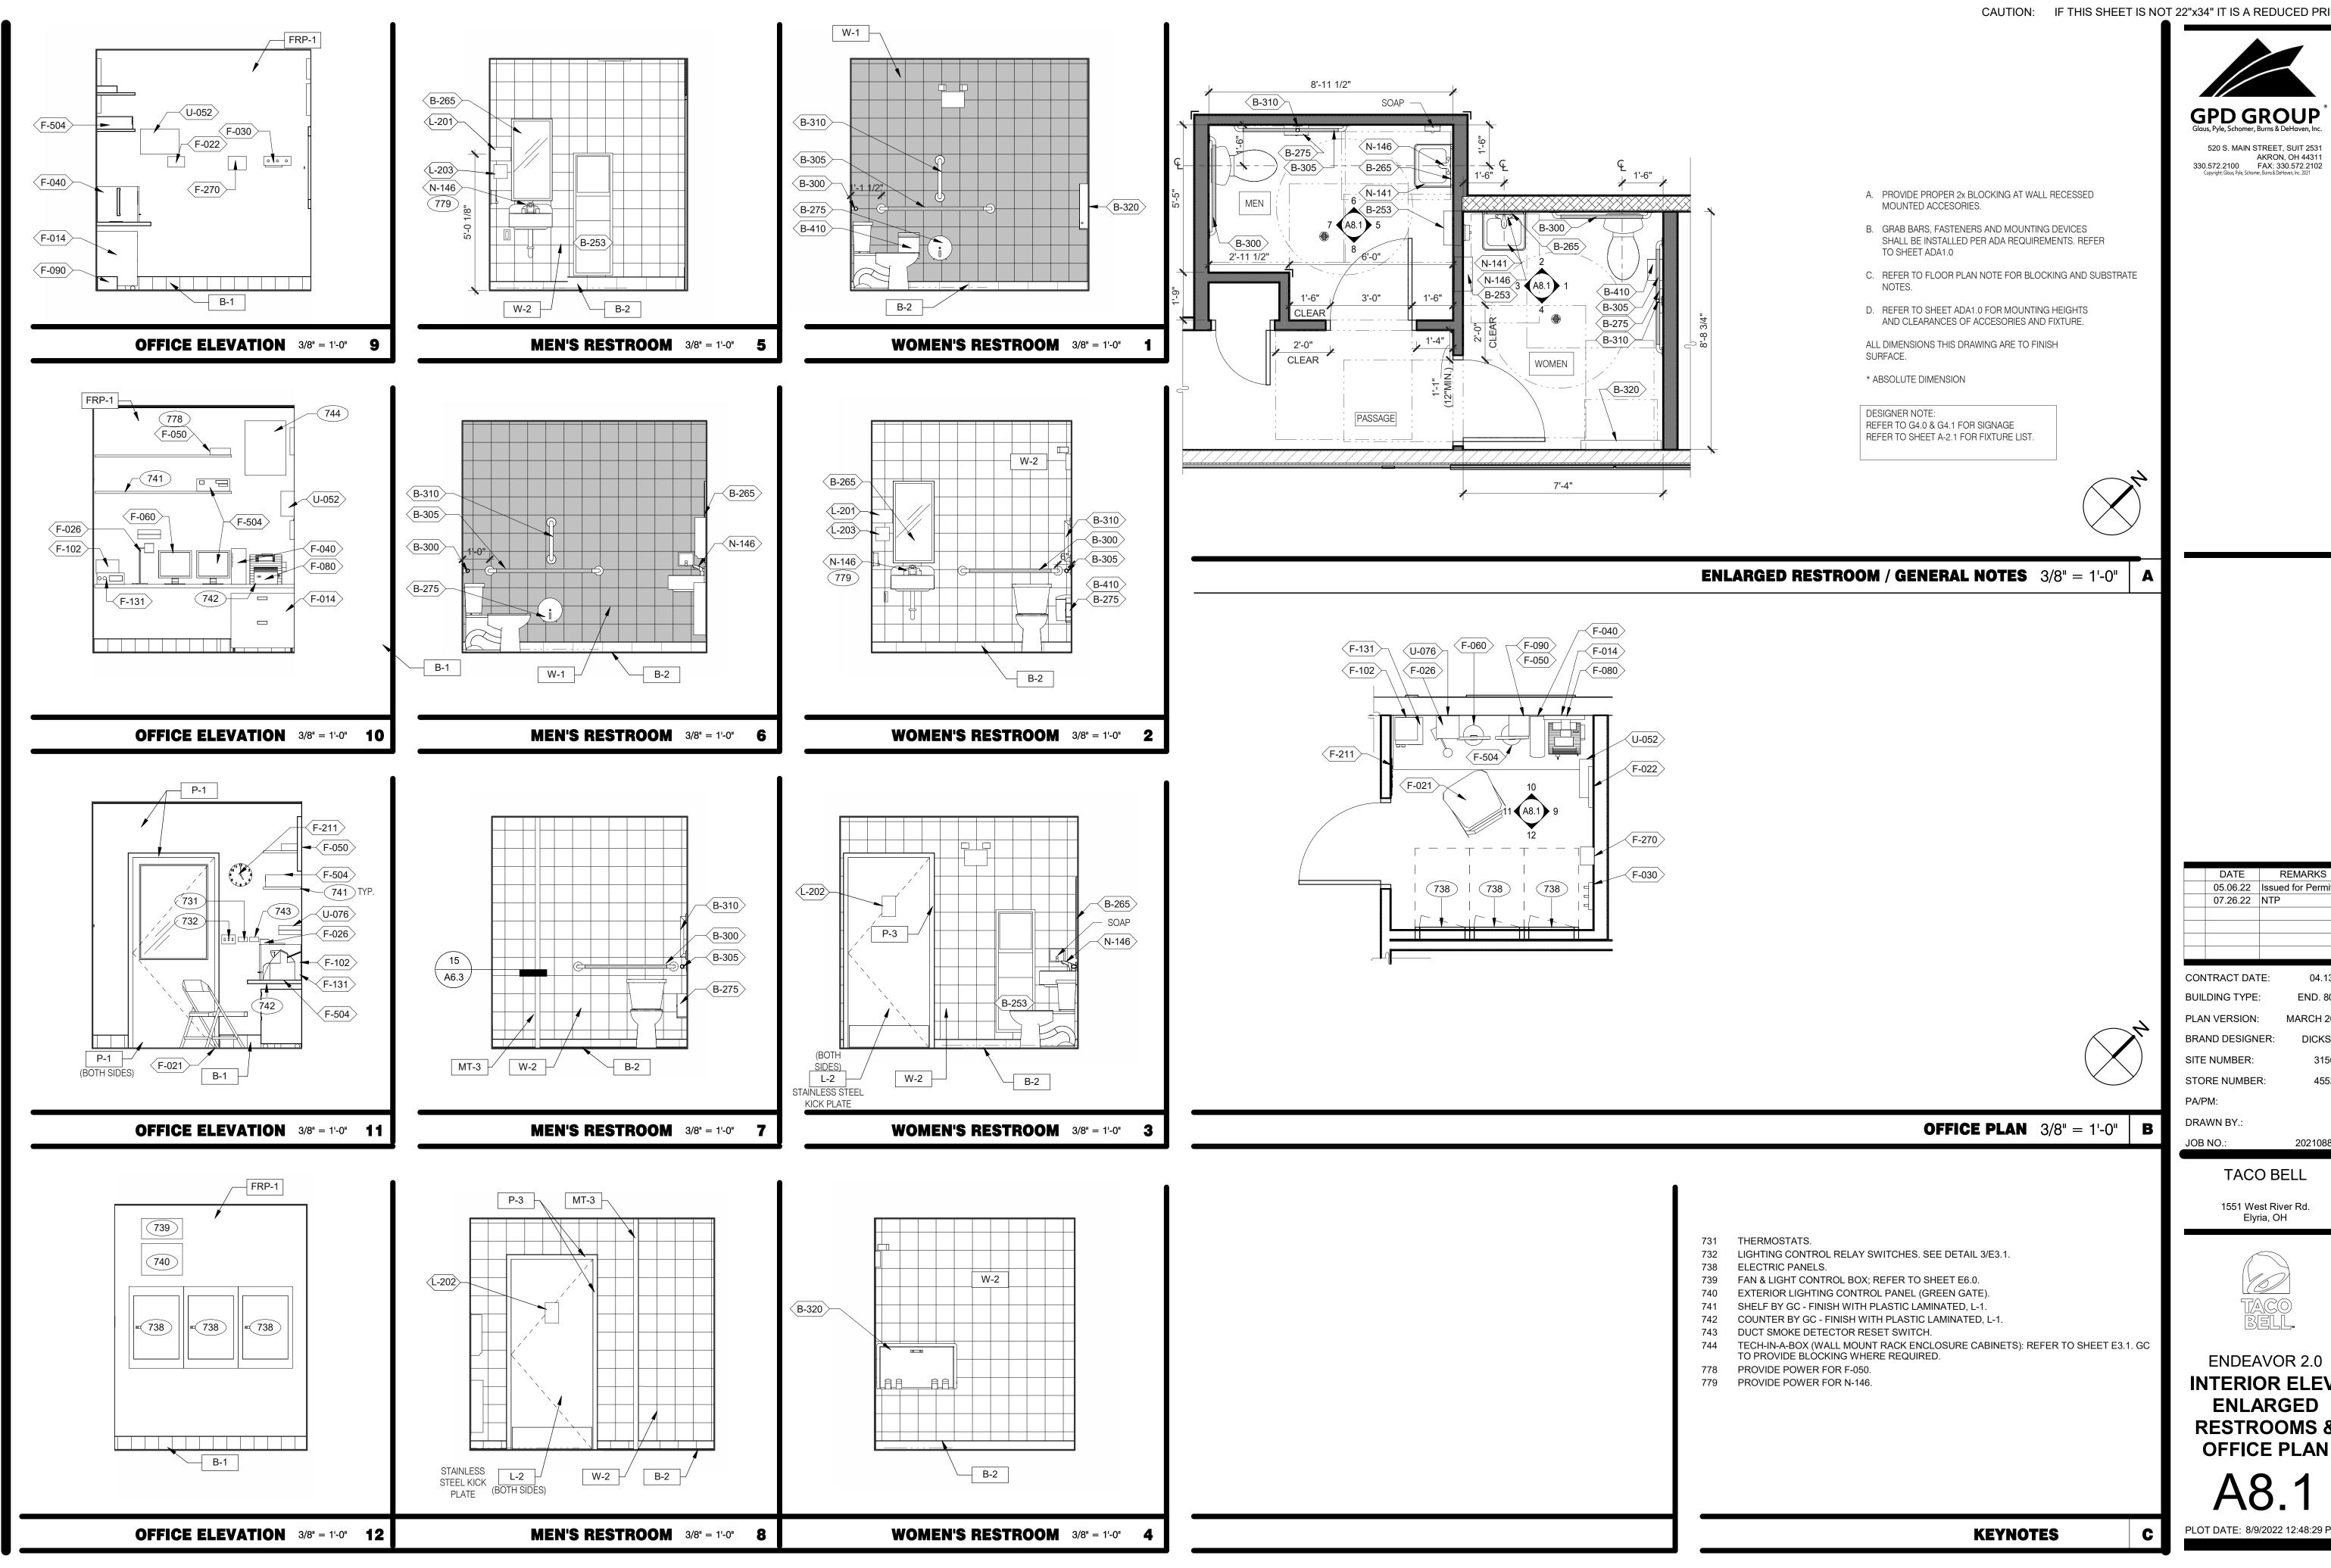

520 S. MAIN STREET, SUIT 2531 AKRON, OH 44311
330.572.2100 FAX: 330.572.2102

DATE	REMARKS	
05.06.22	Issued for Permit	
07.26.22	NTP	
		1

CONTRACT DATE: **BUILDING TYPE:** END. 80FT PLAN VERSION: MARCH 2021 BRAND DESIGNER: DICKSON SITE NUMBER: STORE NUMBER: PA/PM:

> 2021088.52 TACO BELL

1551 West River Rd.





Elyria, OH


ENDEAVOR 2.0 INTERIOR ELEV. **ENLARGED RESTROOMS &**


PLOT DATE: 8/9/2022 12:48:29 PM

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DATE	REMARKS
05.06.22	Issued for Permit
07.26.22	NTP
08.09.22	IFB

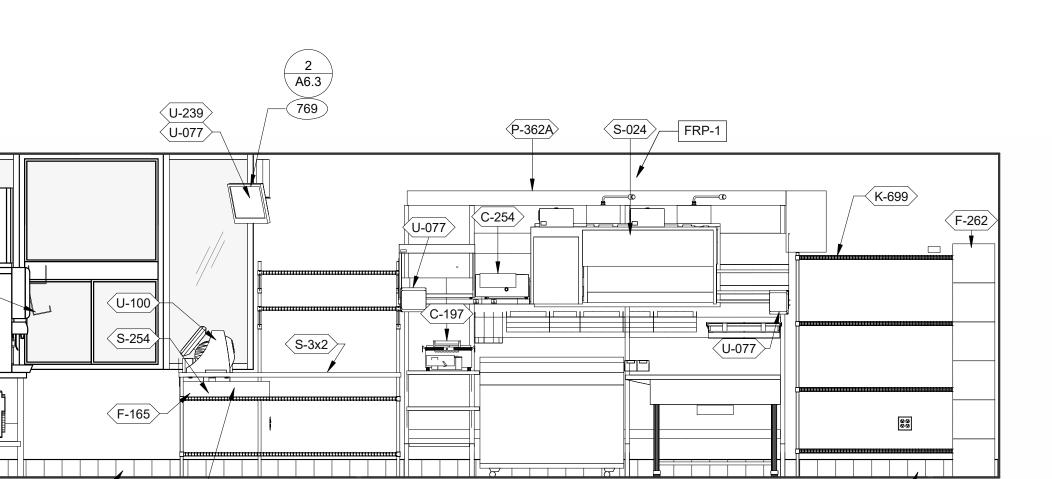CONTRACT DATE: BUILDING TYPE: END. 80FT PLAN VERSION: MARCH 2021 BRAND DESIGNER: DICKSON SITE NUMBER: 315672 STORE NUMBER: PA/PM: DRAWN BY.: 2021088.52

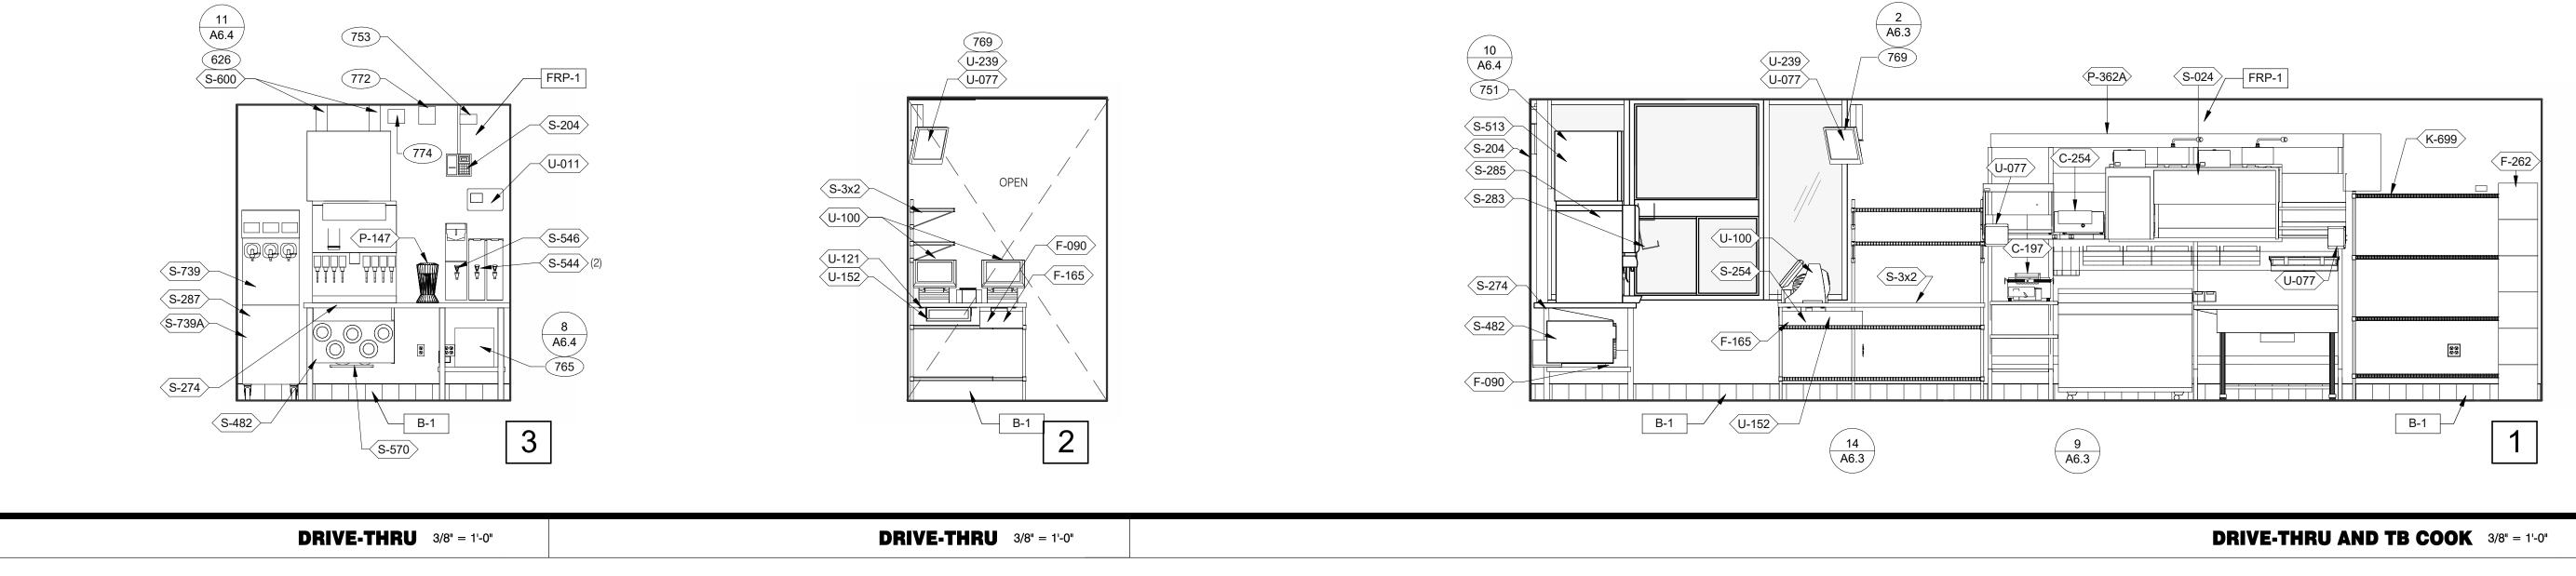TACO BELL

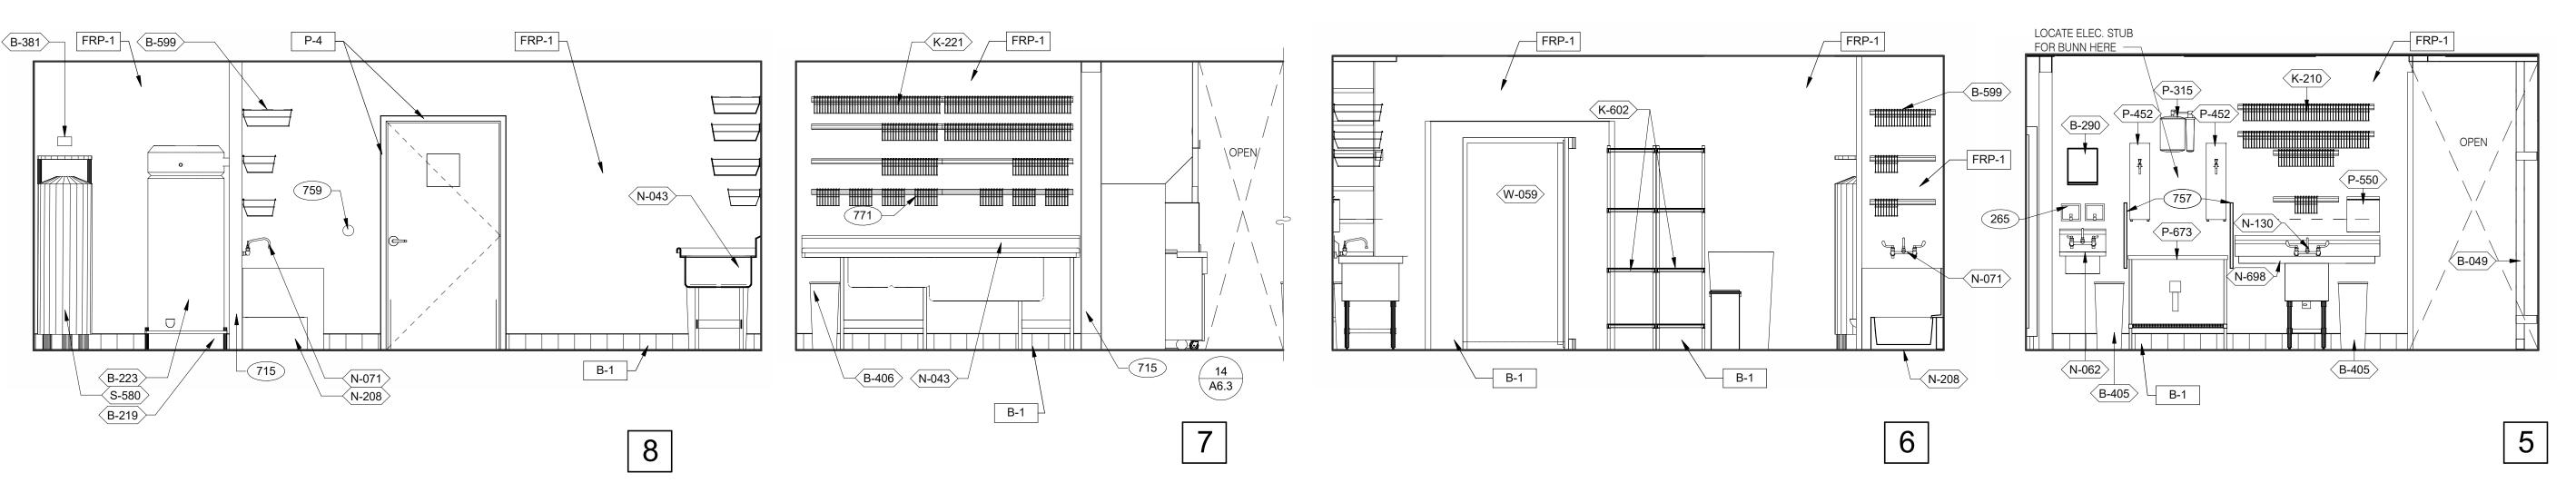
1551 West River Rd. Elyria, OH

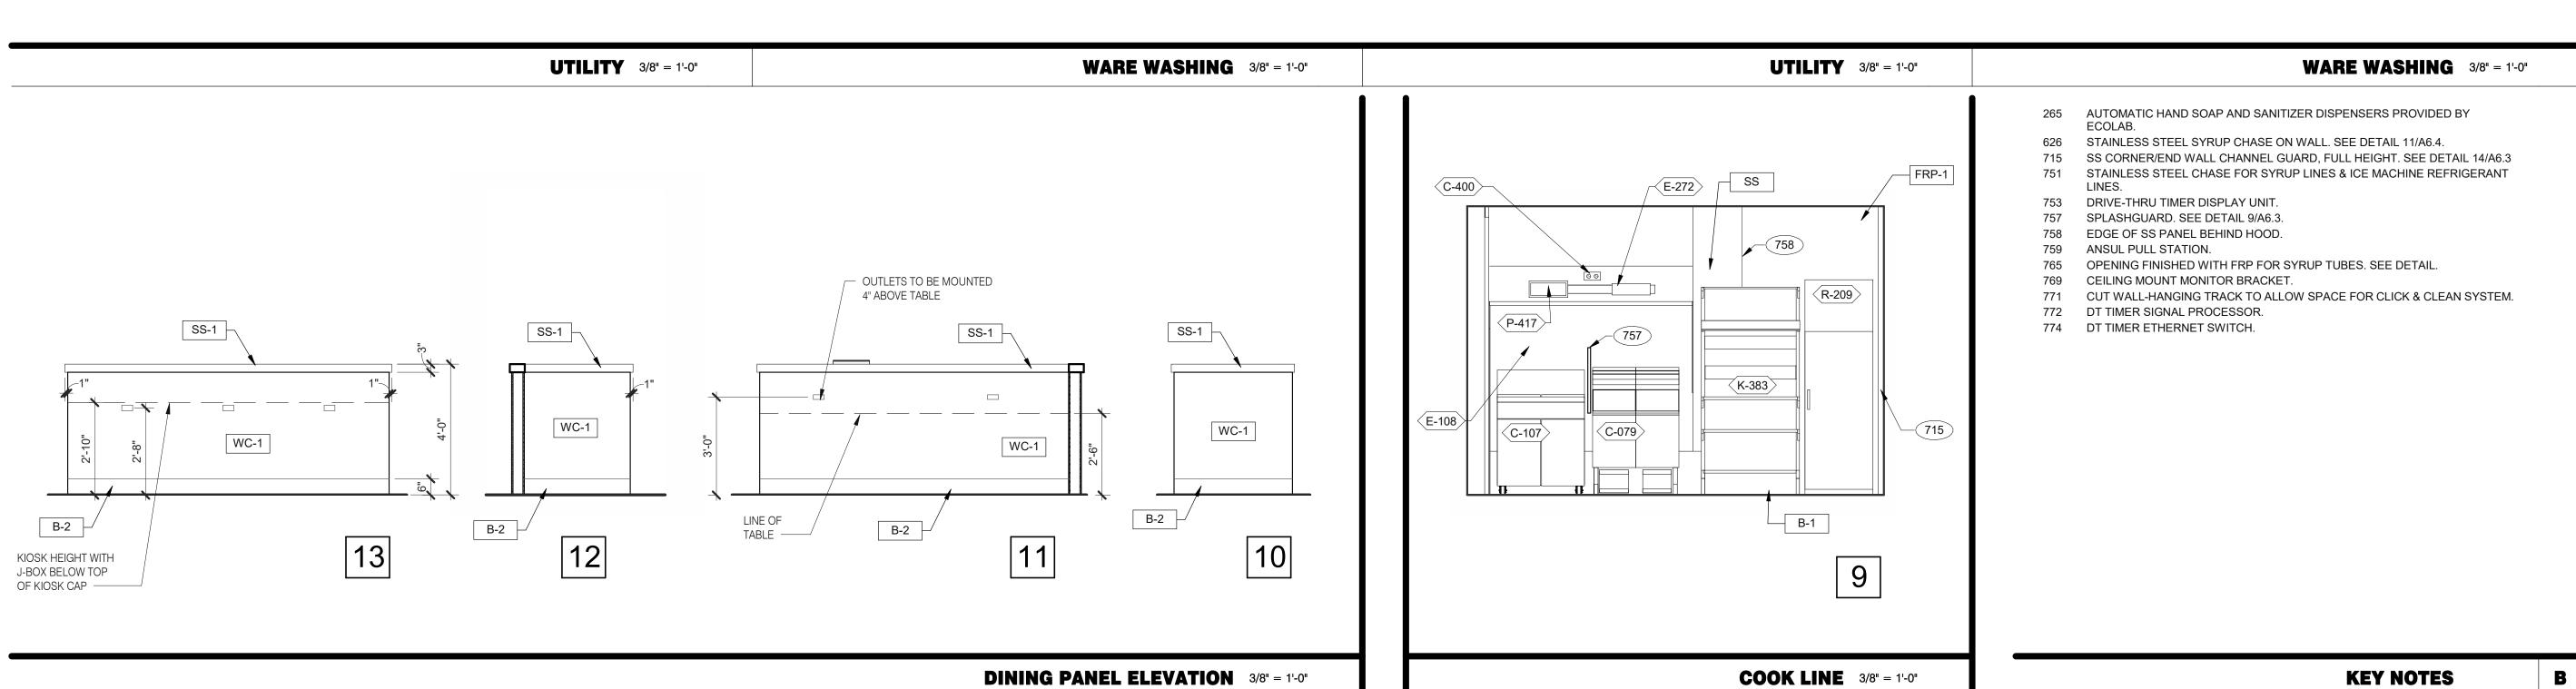


ENDEAVOR 2.0 INTERIOR ELEVATIONS KITCHEN


PLOT DATE: 8/9/2022 12:48:39 PM


520 S. MAIN STREET, SUIT 2531 AKRON, OH 44311 330.572.2100 FAX: 330.572.2102 Copyright, Glaus, Pyle, Schomer, Burns & DeHaven, Inc. 2021

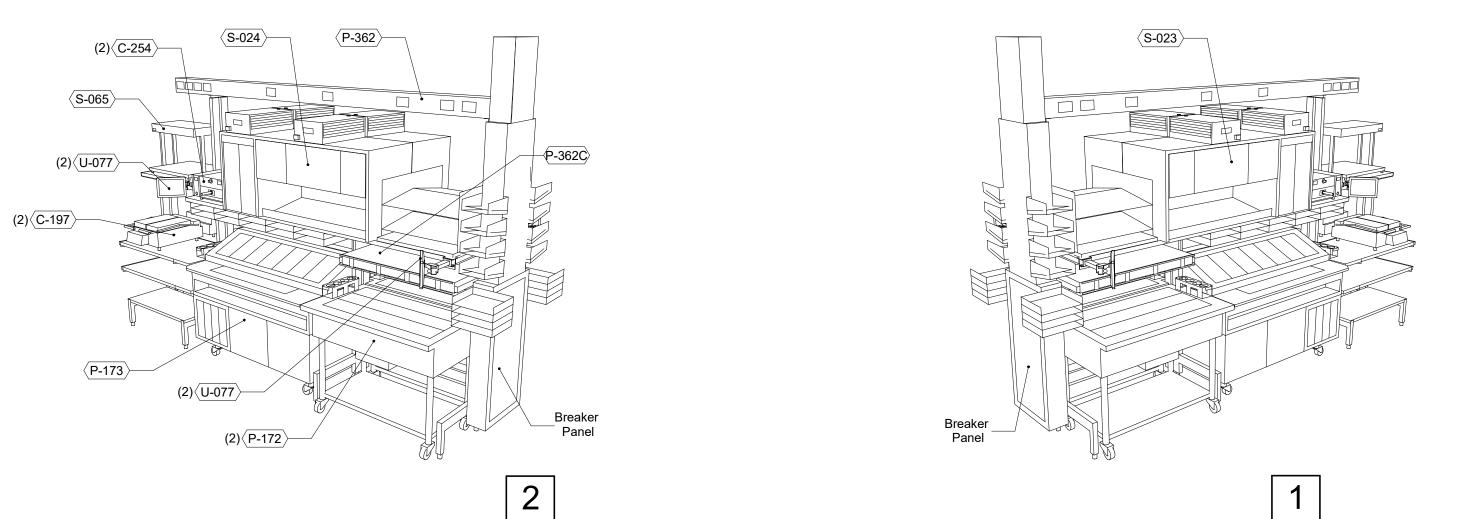


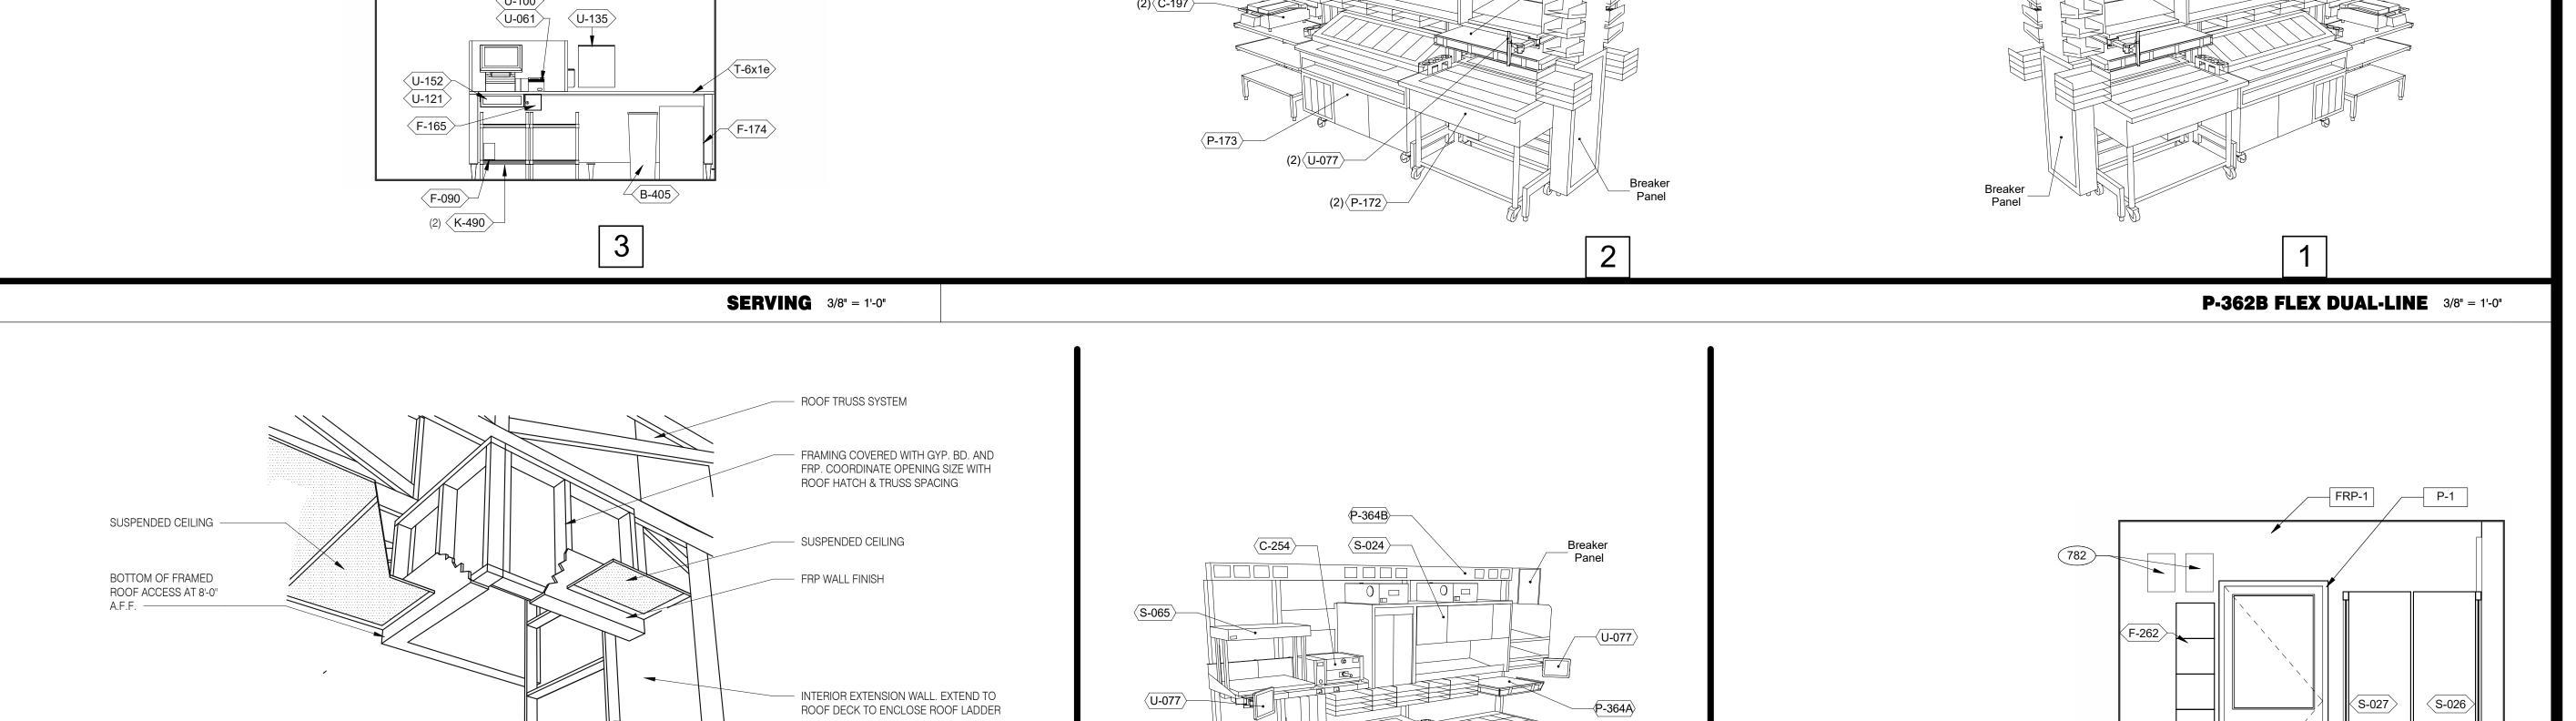

A - ROOF LADDER VIEW

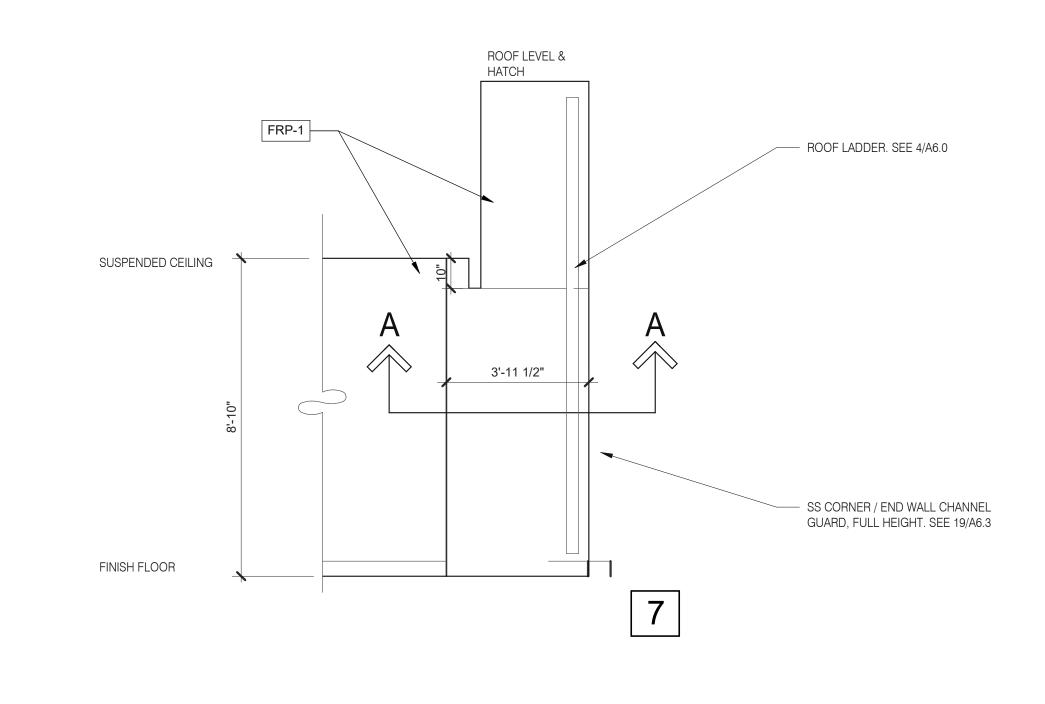

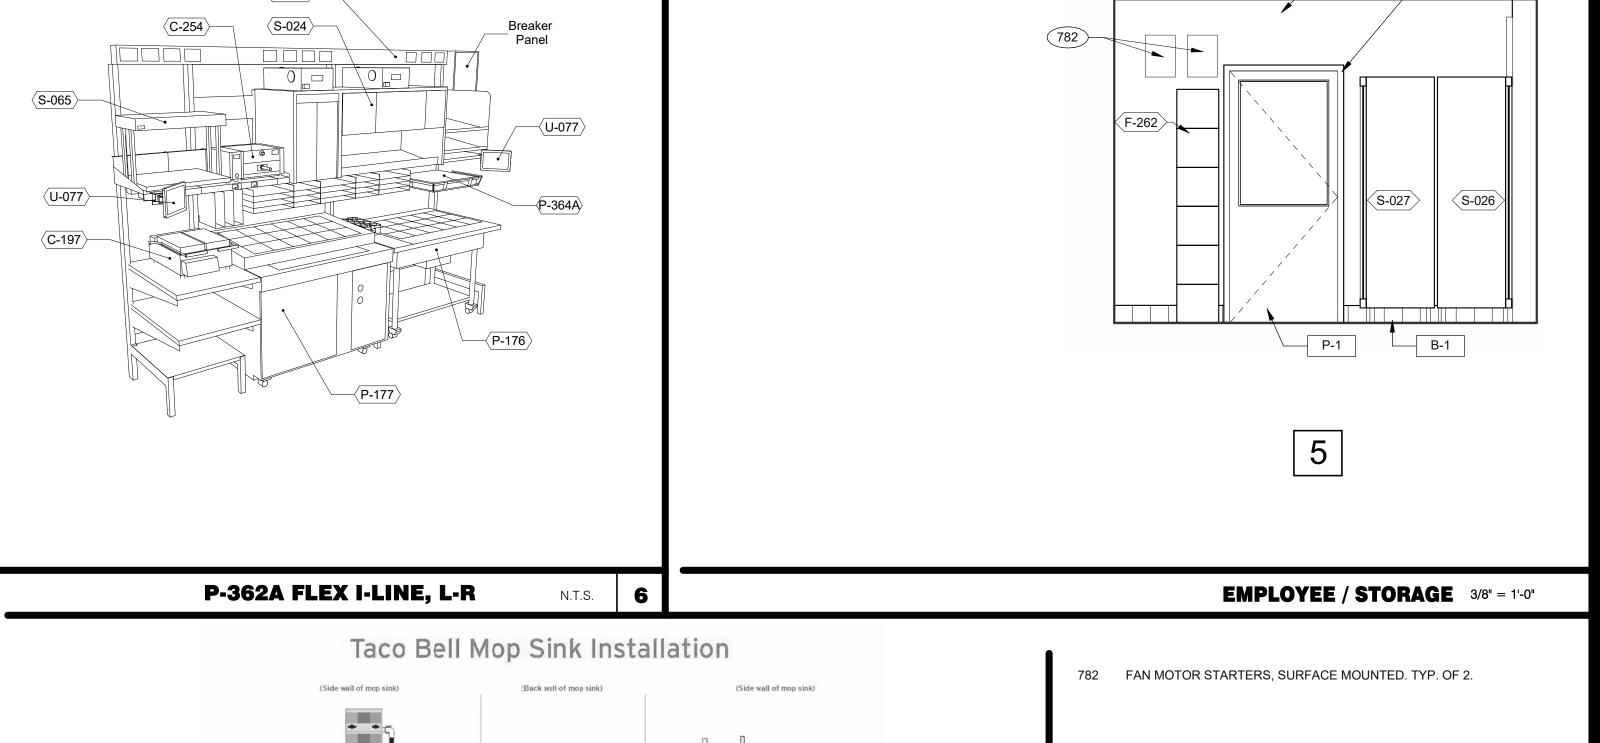

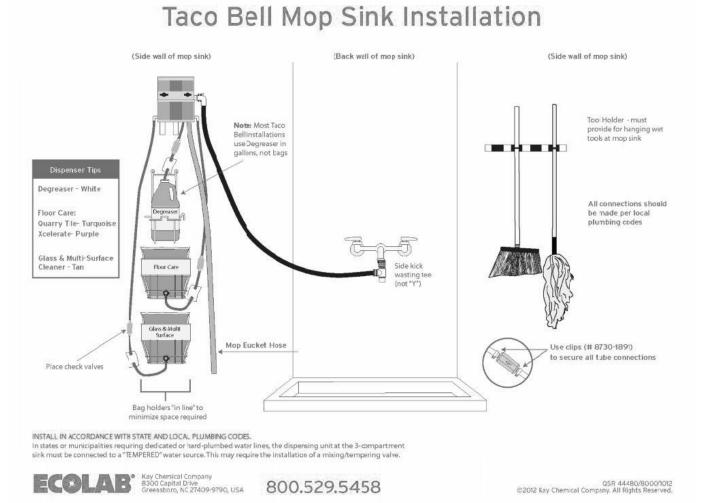

TACO BELL

07.26.22 NTP 08.09.22 IFB

END. 80FT

2021088.52

MARCH 2021

CONTRACT DATE:

BUILDING TYPE:

PLAN VERSION:

STORE NUMBER:

DRAWN BY.:

BRAND DESIGNER:

1551 West River Rd. Elyria, OH



ENDEAVOR 2.0 INTERIOR ELEVATIONS KITCHEN


ROOF ACCES PASSAGEWAY 3/8" = 1'-0" B


ROOF LADDER. SEE 4/A6.0

B-049, B-050

MOP SINK INSTALLATION

KEYNOTE

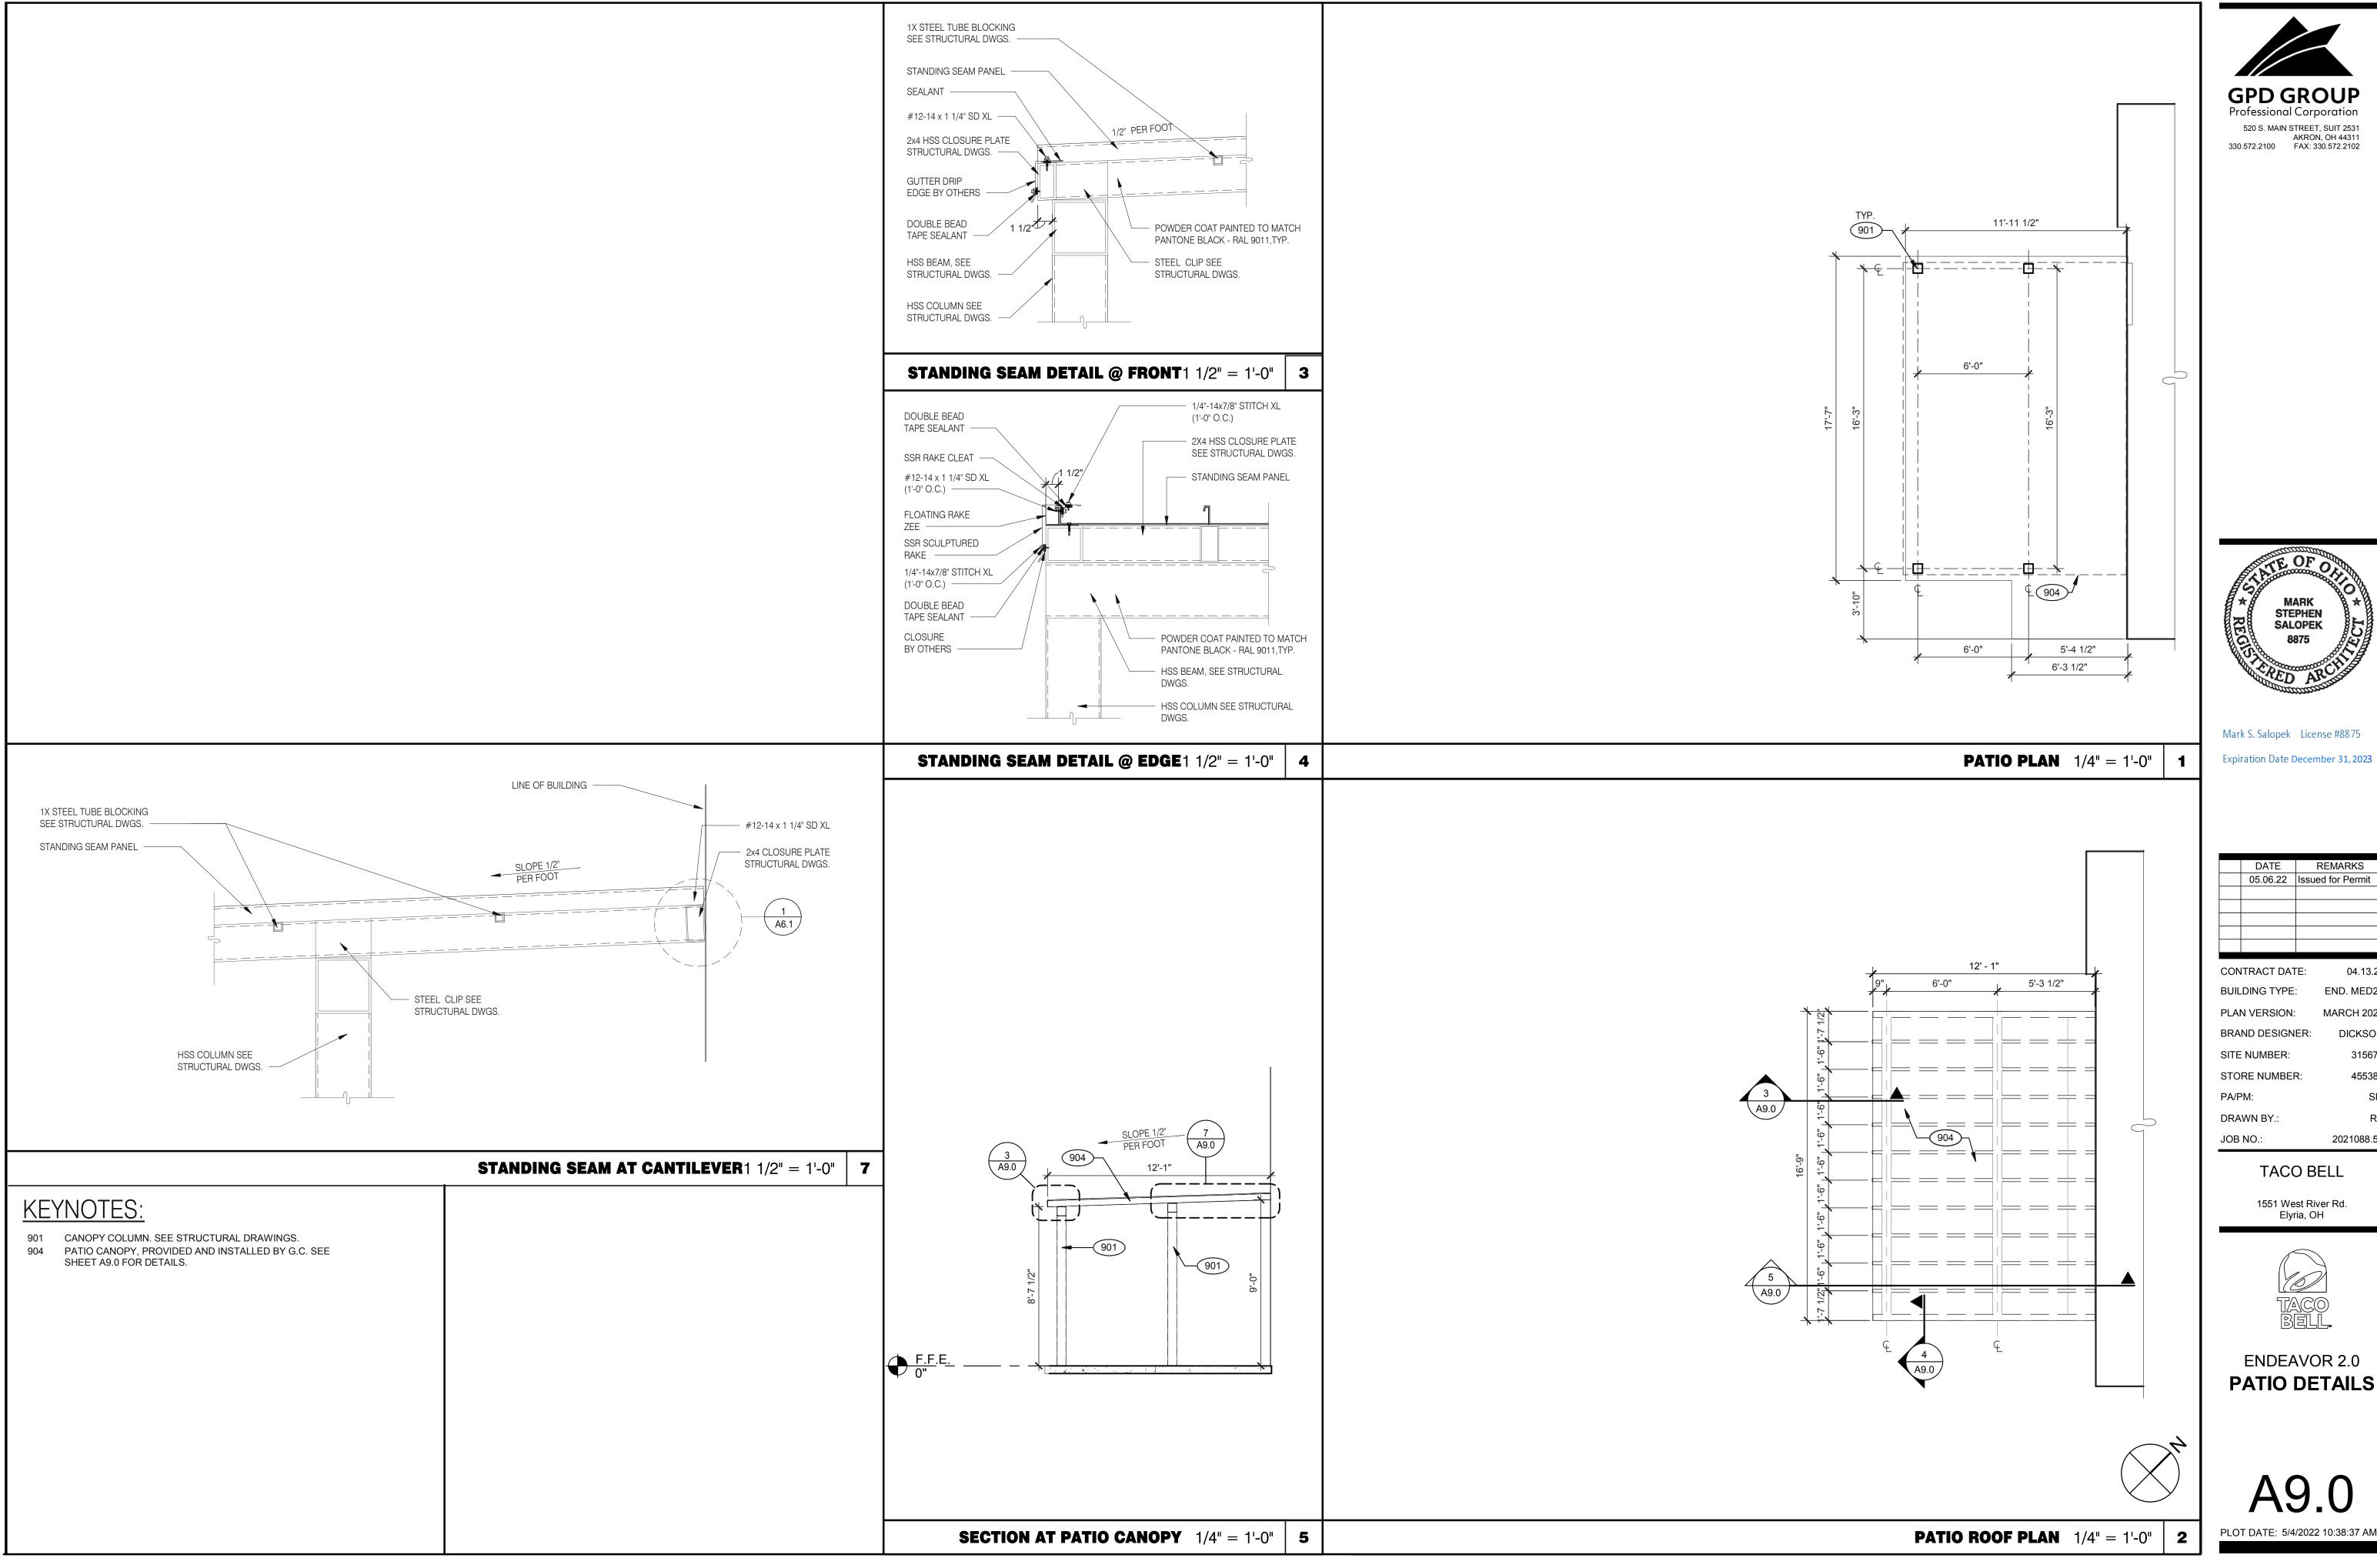

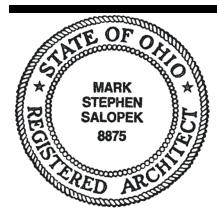

Mark S. Salopek License #8875

05.06.22 Issued for Permit


MARCH 2021


2021088.52


1551 West River Rd.




ENDEAVOR 2.0 PATIO DETAILS

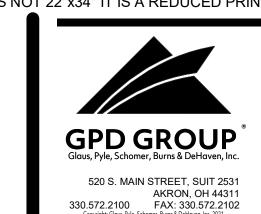


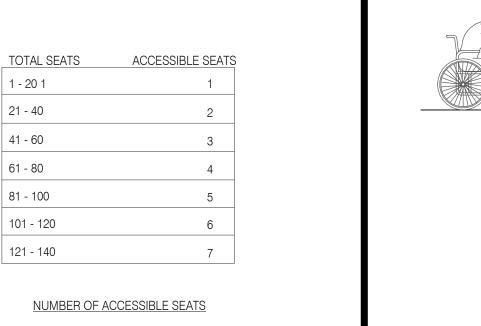

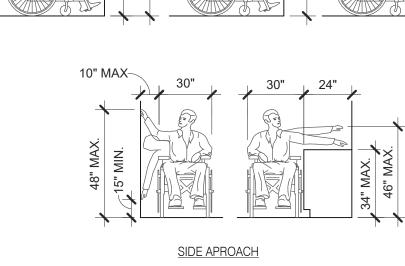


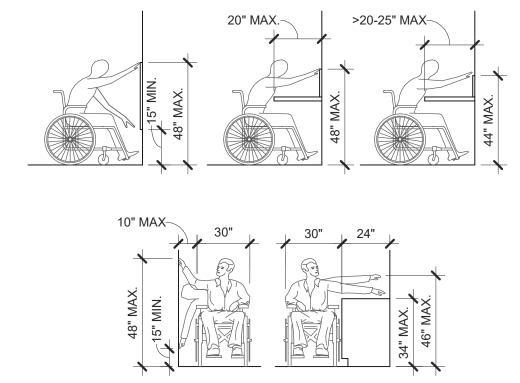




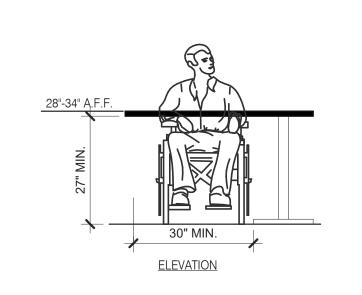


SEATING AND TABLES 1/2" = 1'-0" | 18

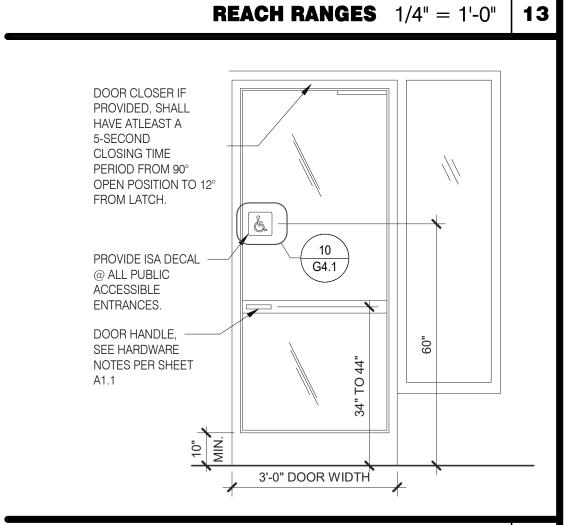



TYP. ENTRANCE / EXIT DOOR 3/8" = 1'-0" | 14

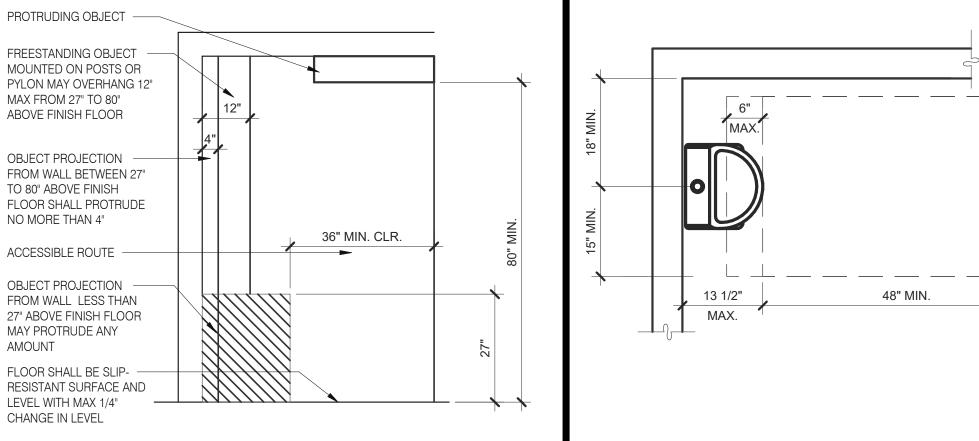

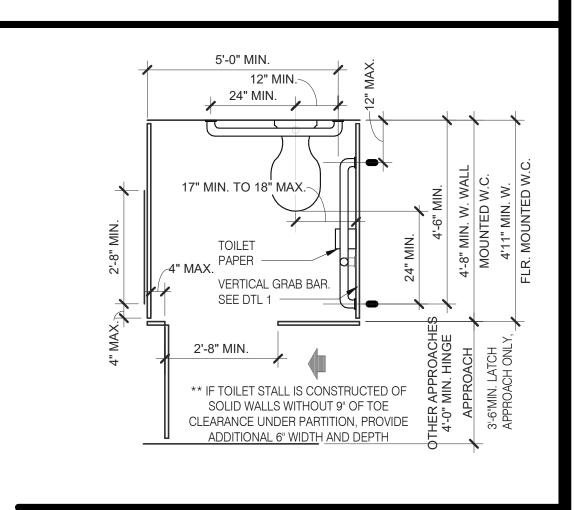


STANDARD TOILET STALL 1/2" = 1'-0"

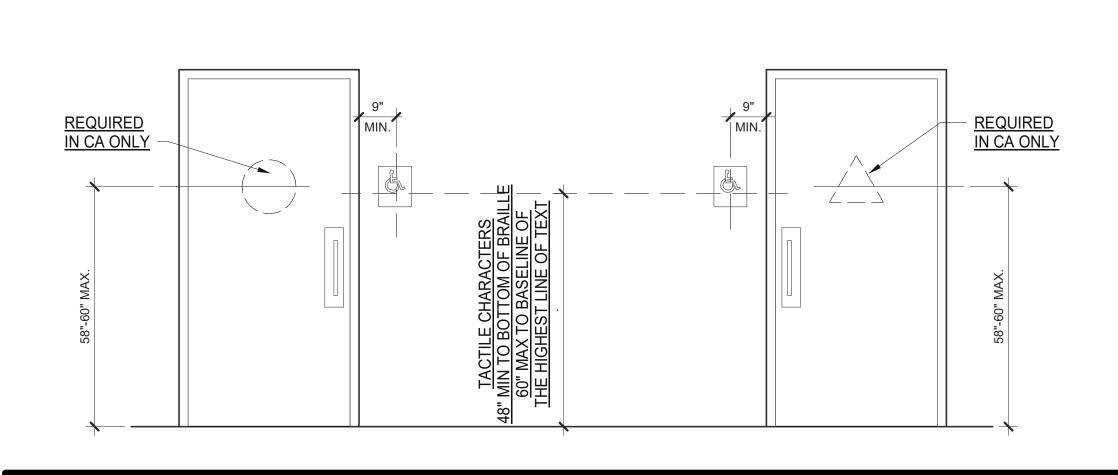

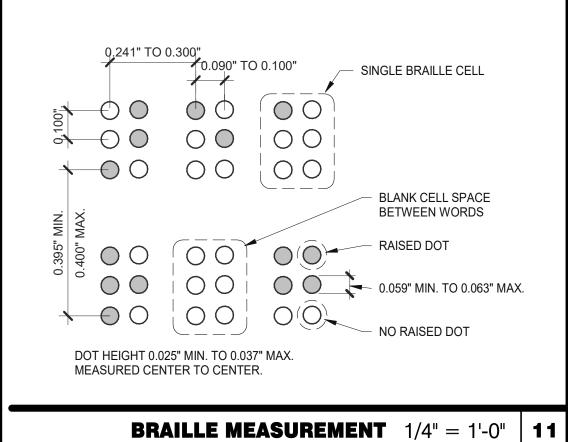

INT. ACCESS. ROUTE CLEARANCES 1/2" = 1'-0" | 10

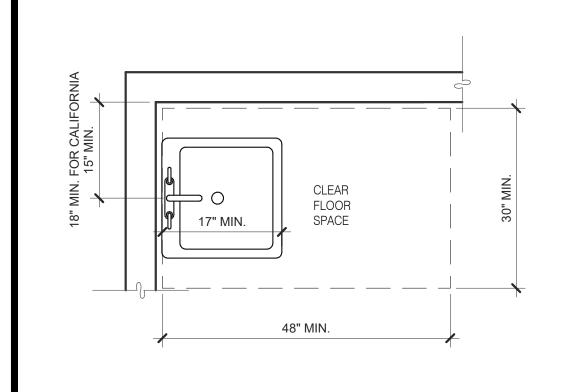

	DATE	REMARI	S
	05.06.22	Issued for Pe	rmit
	07.26.22	NTP	
	08.09.22	IFB	
	i		
CON	ITRACT DA	E: 0	4.13.22
BUIL	DING TYPE	: END). 80FT
PLAI	N VERSION	MARC	H 2021
BRA	ND DESIGN	ER: DIC	KSON
SITE	NUMBER:	(315672
STO	RE NUMBE	₹: 4	455386

TACO BELL

1551 West River Rd.

Elyria, OH

ENDEAVOR 2.0

ACCESSIBILITY


REQUIREMENTS

2021088.52


PA/PM:

DRAWN BY.


JOB NO.:

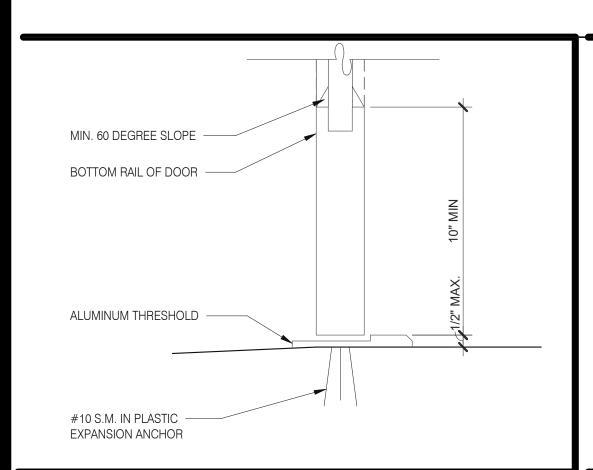

BOTTOM RAIL (EXTERIOR DOOR) 3" = 1'-0" **20**

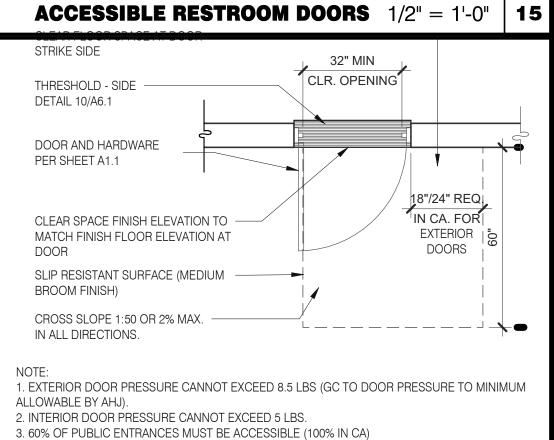


EXTERIOR DOOR REQUIREMENTS 3/8" = 1'-0" | 16

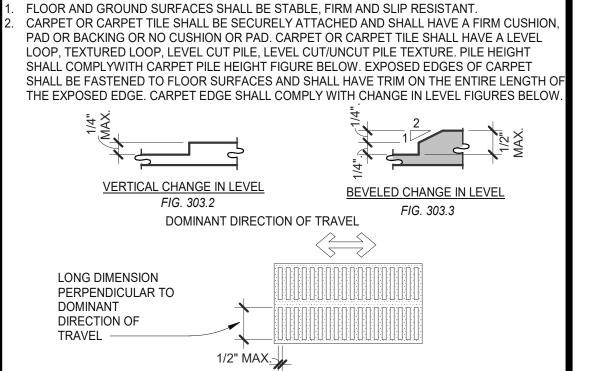

ELONGATED OPENINGS IN FLOOR OR GROUND SPACE FIG. 302.3

CHANGES IN LEVEL 1/2" = 1'-0" | **12**

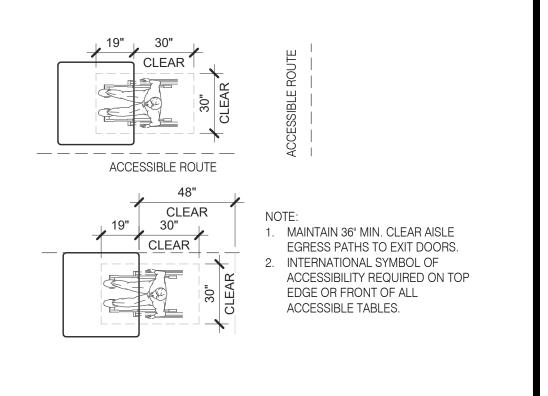

DINING SEATING CLEARANCES

ACCESSIBLE URINAL 3/4" = 1'-0"

1. INDICATED DIMENSIONS, HEIGHTS, DEPTHS, AREAS AND OTHER GRAPH	IIC
INFORMATION ARE PROVIDED AS MINIMUMS THAT MUST BE MAINTAINED. THE	HESE
MINIMUMS ARE BASED UPON YUM STANDARDS AND MAY EXCEED ADA	
REQUIREMENTS.	

ACCESSIBLE LAVATORY 3/4" = 1'-0"

THE DETAILS SHOWN ARE CONCEPTUAL ONLY AND INTENDED TO SHOW ABSOLUTE MINIMUMS AND SHALL BE COORDINATED WITH THE OTHER CONSTRUCTION DOCUMENTS ASSOCIATED WITH THIS PROJECT.

2. 60" TURNING SPACE

N.T.S.

- PERMITTED OVERLAP LIMITED TO 1 ARM OF T-SHAPED SPACE - CAN OVERLAP FIXTURE & DOOR CLEARANCE

- DOOR CAN SWING INTO TURNING SPACE A MAXIMUM OF 12" RESTROOM, IN GENERAL, DOOR SWING MUST BE OUTSIDE OF THE FIXTURE CLEAR FLOOR SPACE HOWEVER A DOOR CAN SWING INTO FIXTURE CLEAR FLOOR SPACE IF WHEELCHAIR SPACE 30"X48" IS PROVIDED BEYOND THE


DOOR SWING.

GENERAL NOTES

4. TOILET ROOM MUST ALLOW FOR SIDE TRANSFER - 42" BETWEEN FIXTURES. 5. ADAPT TEAM TO VERIFY LOCAL CODE REQUIREMENTS.

ADA1.0

PLOT DATE: 8/9/2022 12:48:44 PM

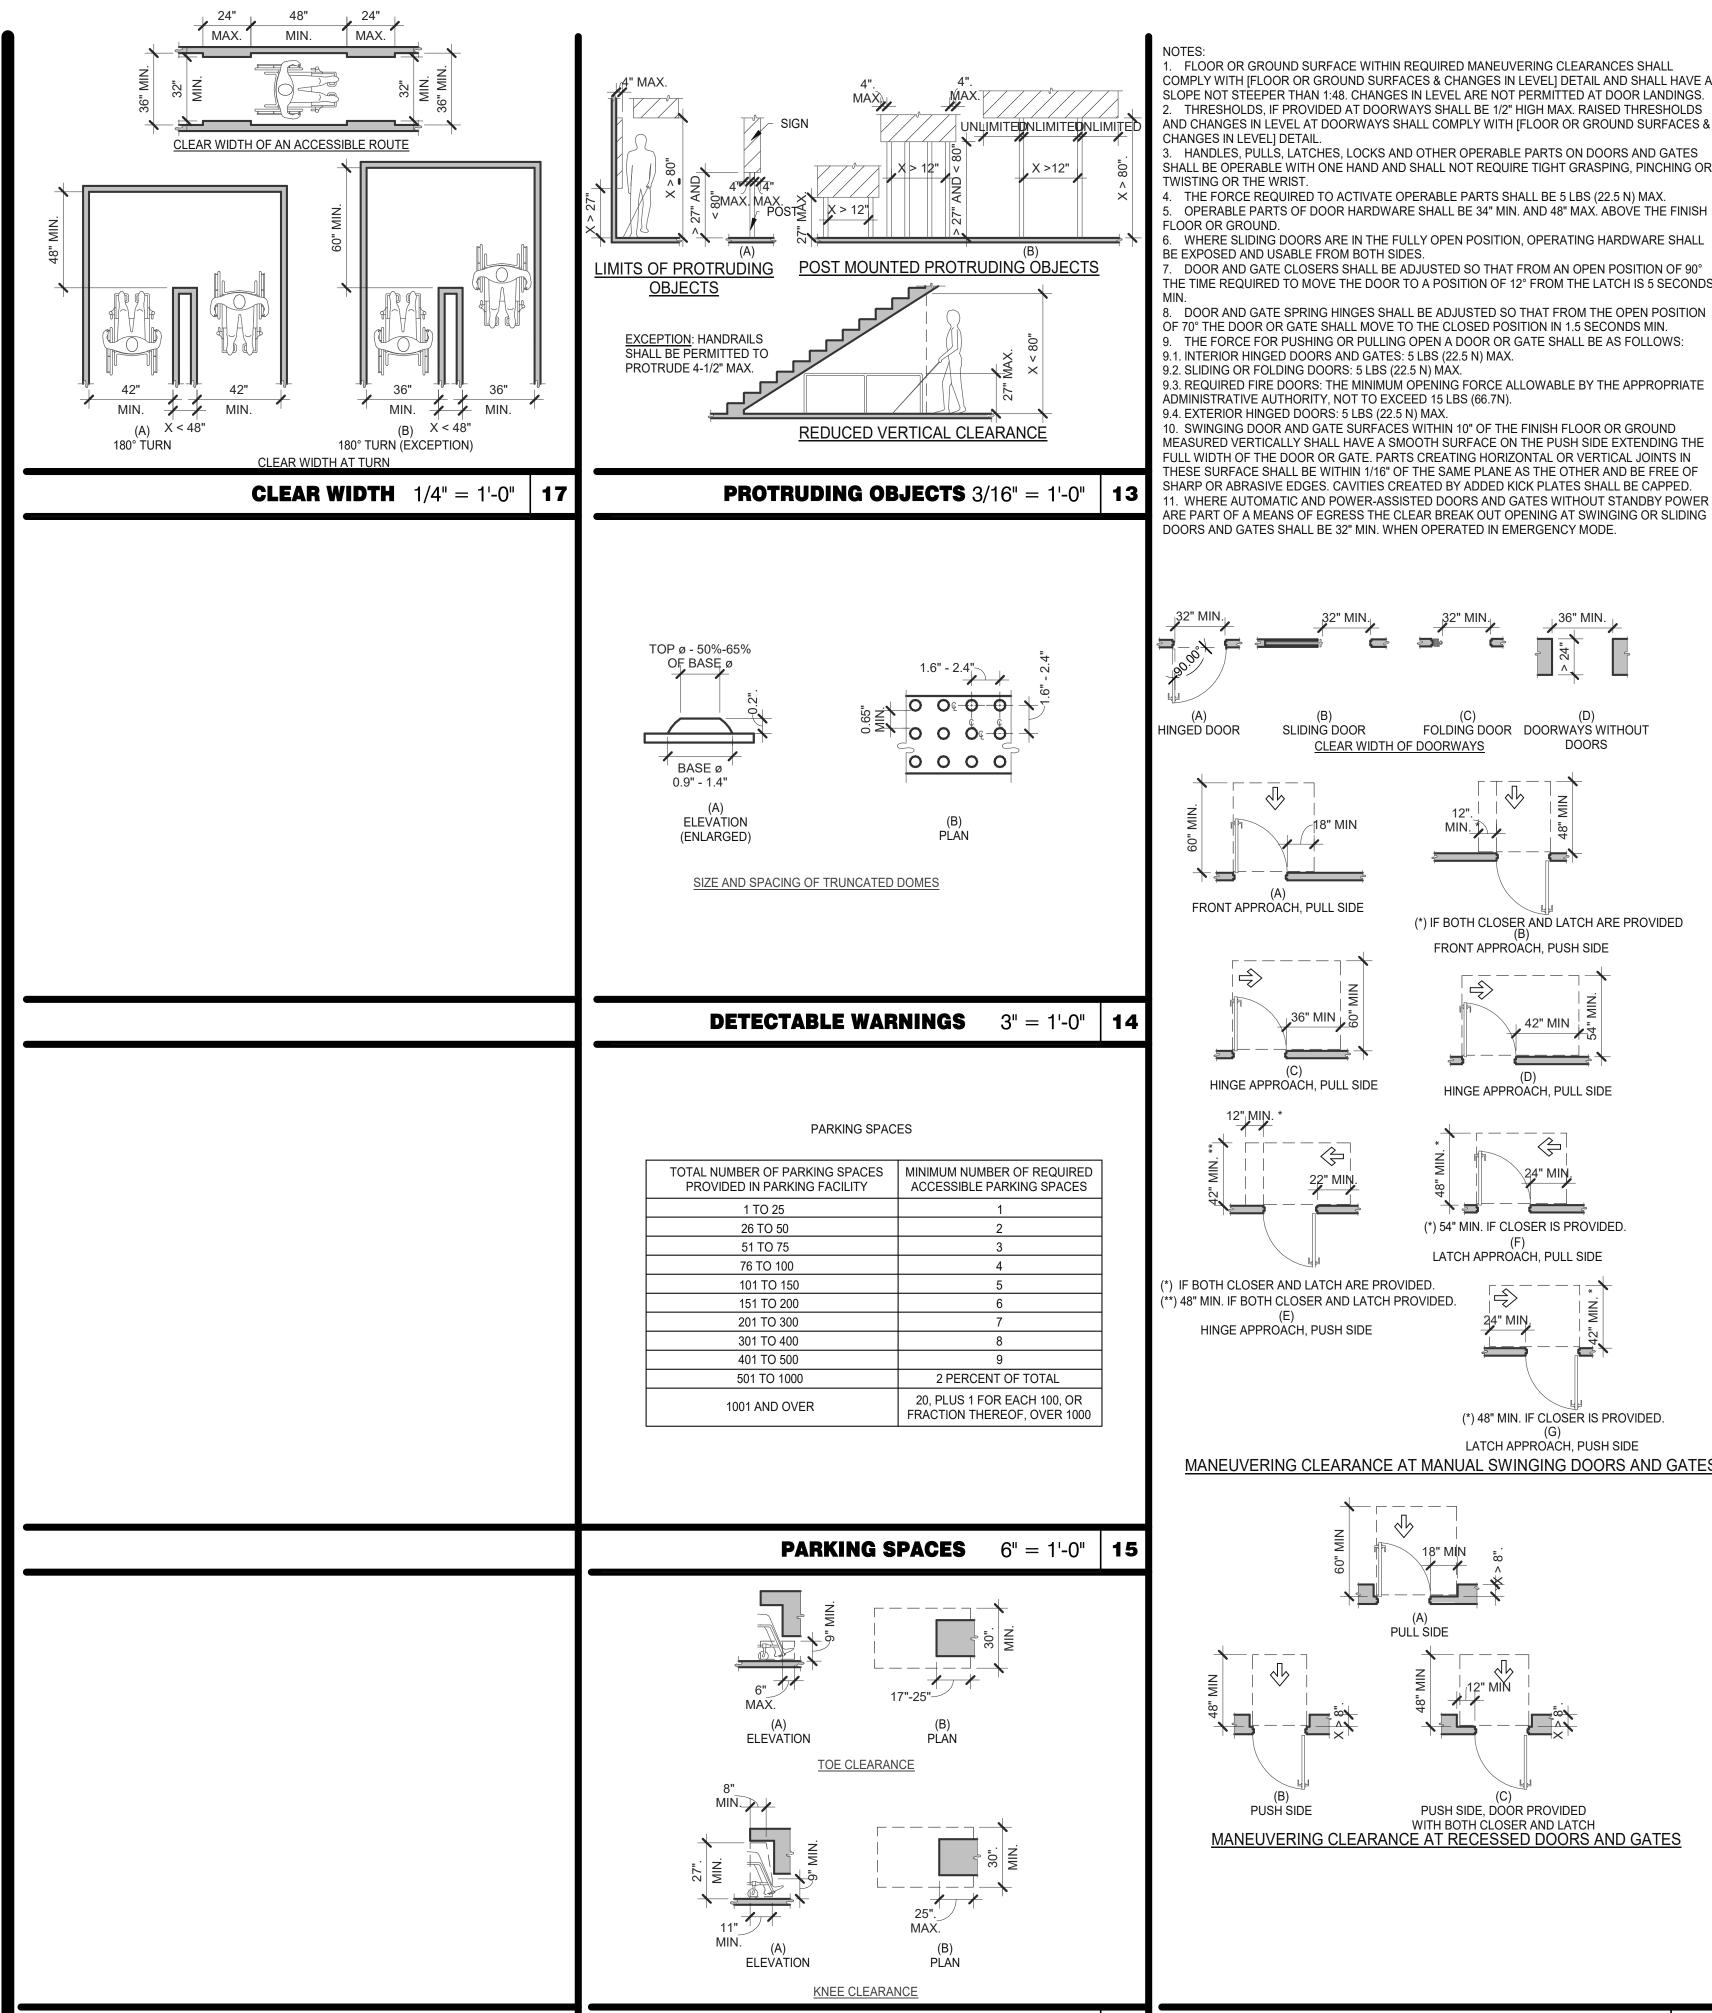

KNEE AND TOE CLEARANCE 1/4" = 1'-0" | 16

CIRCULAR CROSS SECTION. GRAB BARS WITH CIRCULAR CROSS SECTIONS SHALL HAVE AN OUTSIDE DIAMETER OF 1-1/4 INCHES MINIMUM AND 2 INCHES MAXIMUM. FLOOR OR GROUND SURFACE WITHIN REQUIRED MANEUVERING CLEARANCES SHALL SPACING. THE SPACE BETWEEN THE WALL AND THE GRAB BAR SHALL BE 1-1/2 INCHES. THE COMPLY WITH [FLOOR OR GROUND SURFACES & CHANGES IN LEVEL] DETAIL AND SHALL HAVE A

FRONT APPROACH, PUSH SIDE

42" MIN

\$

(*) 48" MIN. IF CLOSER IS PROVIDED.

LATCH APPROACH, PUSH SIDE

HINGE APPROACH, PULL SIDE

(*) 54" MIN. IF CLOSER IS PROVIDED.

(F) LATCH APPROACH, PULL SIDE

-

12" MIN

PUSH SIDE, DOOR PROVIDED

11


DOORS, DOORWAYS & GATES 3/16" = 1'-0" | **12** |

⇒>

SPACE BETWEEN THE GRAB BAR AND PROJECTING OBJECTS BELOW AND AT THE ENDS SLOPE NOT STEEPER THAN 1:48. CHANGES IN LEVEL ARE NOT PERMITTED AT DOOR LANDINGS. SHALL BE 1-1/2 INCHES MINIMUM. THE SPACE BETWEEN THE GRAB BAR AND PROJECTING THRESHOLDS, IF PROVIDED AT DOORWAYS SHALL BE 1/2" HIGH MAX. RAISED THRESHOLDS OBJECTS ABOVE SHALL BE 12 INCHES MINIMUM. AND CHANGES IN LEVEL AT DOORWAYS SHALL COMPLY WITH [FLOOR OR GROUND SURFACES (

POSITION OF GRAB BARS. GRAB BARS SHALL BE INSTALLED IN A HORIZONTAL POSITION, 33 INCHES MINIMUM AND 36 INCHES MAXIMUM ABOVE THE FINISH FLOOR MEASURED TO THE TOP OF THE GRIPPING SURFACE, EXCEPT THAT AT WATER CLOSETS FOR CHILDREN'S USE, GRAB BARS SHALL BE INSTALLED IN A HORIZONTAL POSITION 18 INCHES MINIMUM AND 27 INCHES MAXIMUM ABOVE THE FINISH FLOOR MEASURED TO THE TOP OF THE GRIPPING SURFACE.


BACKING. PROVIDE MIN. 6 INCHES x 16 GA CONTINUOUS SHEET METAL BACKING ATTACHED TO MIN. 3 STUD BAYS WITH #10 FLAT HEAD SHEET METAL SCREWS. INSTALL GRAB BARS PER

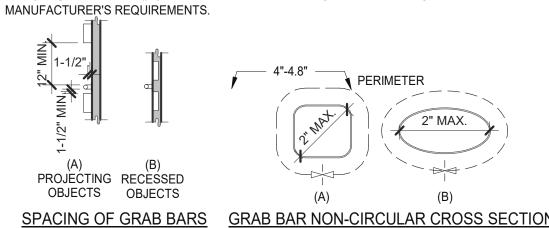

GRAB BARS 3/16" = 1'-0"

TWO DOORS IN SERIES

DOORS, DOORWAYS & GATES 3/16" = 1'-0"

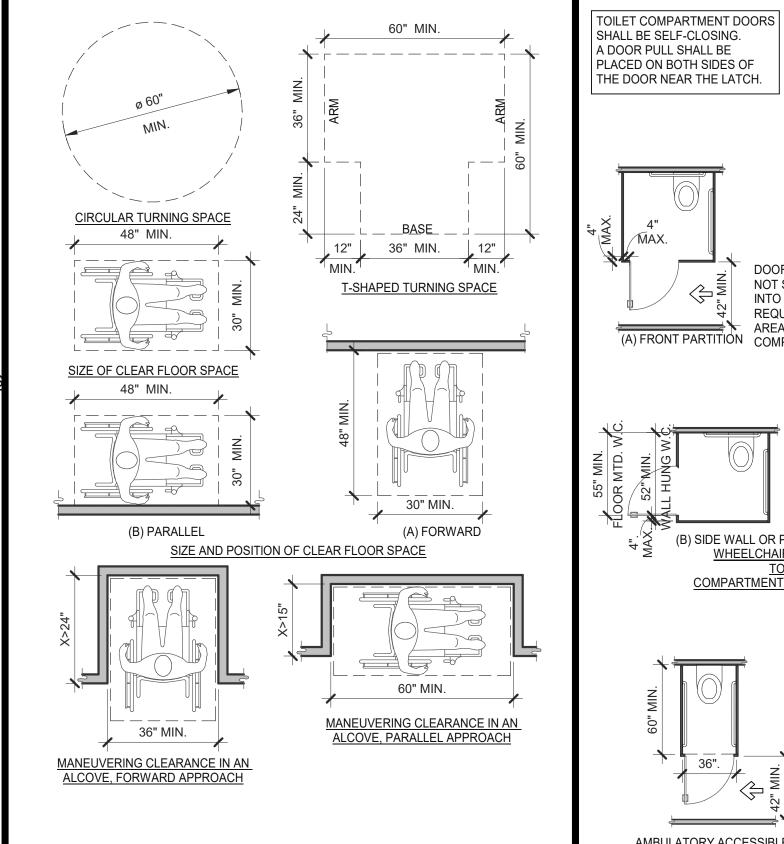

CLEAR FLOOR OR GROUND SPACE 3/8" = 1'-0" 8

ACCESSIBILITY NOTES

- 1. "THE ACCESSIBILITY GUIDELINES AND CODES" MENTIONED BELOW REFER TO ALL APPLICABLE LOCAL/STATE BUILDING CODES REFERENCED ON THE PROJECT DATA SHEET OF THIS SET IN ADDITION TO THE FEDERAL
- REQUIREMENTS OF THE ADA (THE AMERICANS WITH DISABILITIES ACT). DETAILS ON THIS SHEET ARE FOR REFERENCE ONLY, REFER TO THE ACCESSIBILITY GUIDELINES AND CODES FOR ALL ACCESSIBILITY
- 3. THE GENERAL CONTRACTOR SHALL BECOME FAMILIAR WITH THE ACCESSIBILITY GUIDELINES AND CODES.


OTHER FIXTURES NOT

REQUIREMENTS.

4. ANY DISCREPANCY CONTAINED HEREIN DOES NOT RELIEVE THE GENERAL CONTRACTOR OR OWNER FROM COMPLYING WITH THE ACCESSIBILITY GUIDELINES AND CODES.





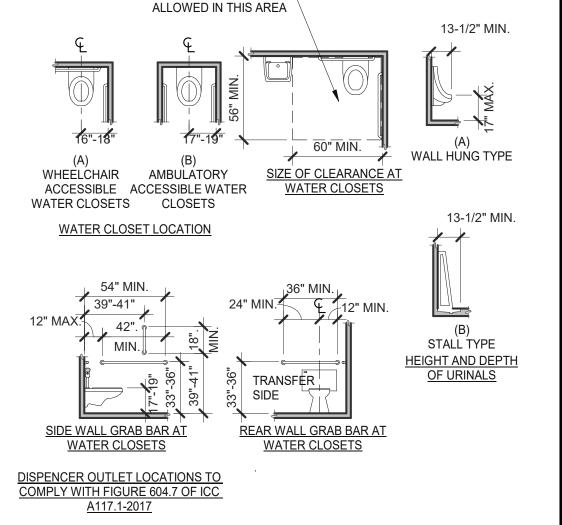

60" MIN. *

ADULT WALL HUNG

TOILET COMPARTMENT

PARTITION

56" MIN.

WATER CLOSET

DOOR SHALL

NOT SWING

AREA OF THE

INTO THE REQUIRED MIN

(A) FRONT PARTITION COMPARTMENT


(B) SIDE WALL OR PARTITION

WHEELCHAIR ACCESSIBLE

TOILET
COMPARTMENT DOOR OPENING\$

WC AND TOILET COMPARTMENTS 3/16" = 1'-0"


MAX.

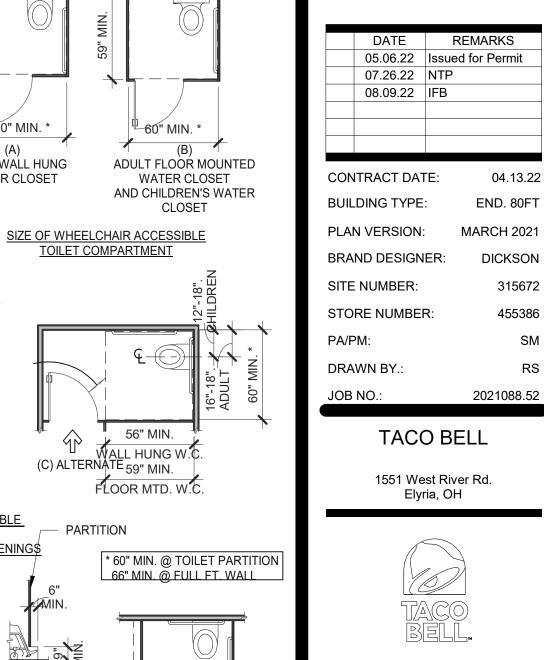




ACCESSIBILITY REQUIREMENTS

PLOT DATE: 8/9/2022 12:48:47 PM

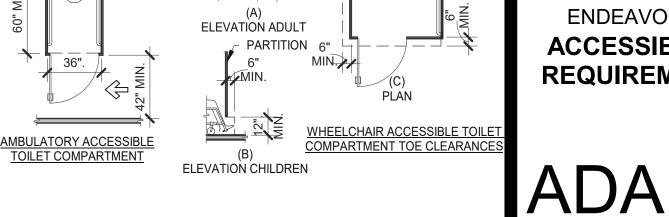



AKRON, OH 44311
330.572.2100 FAX: 330.572.2102

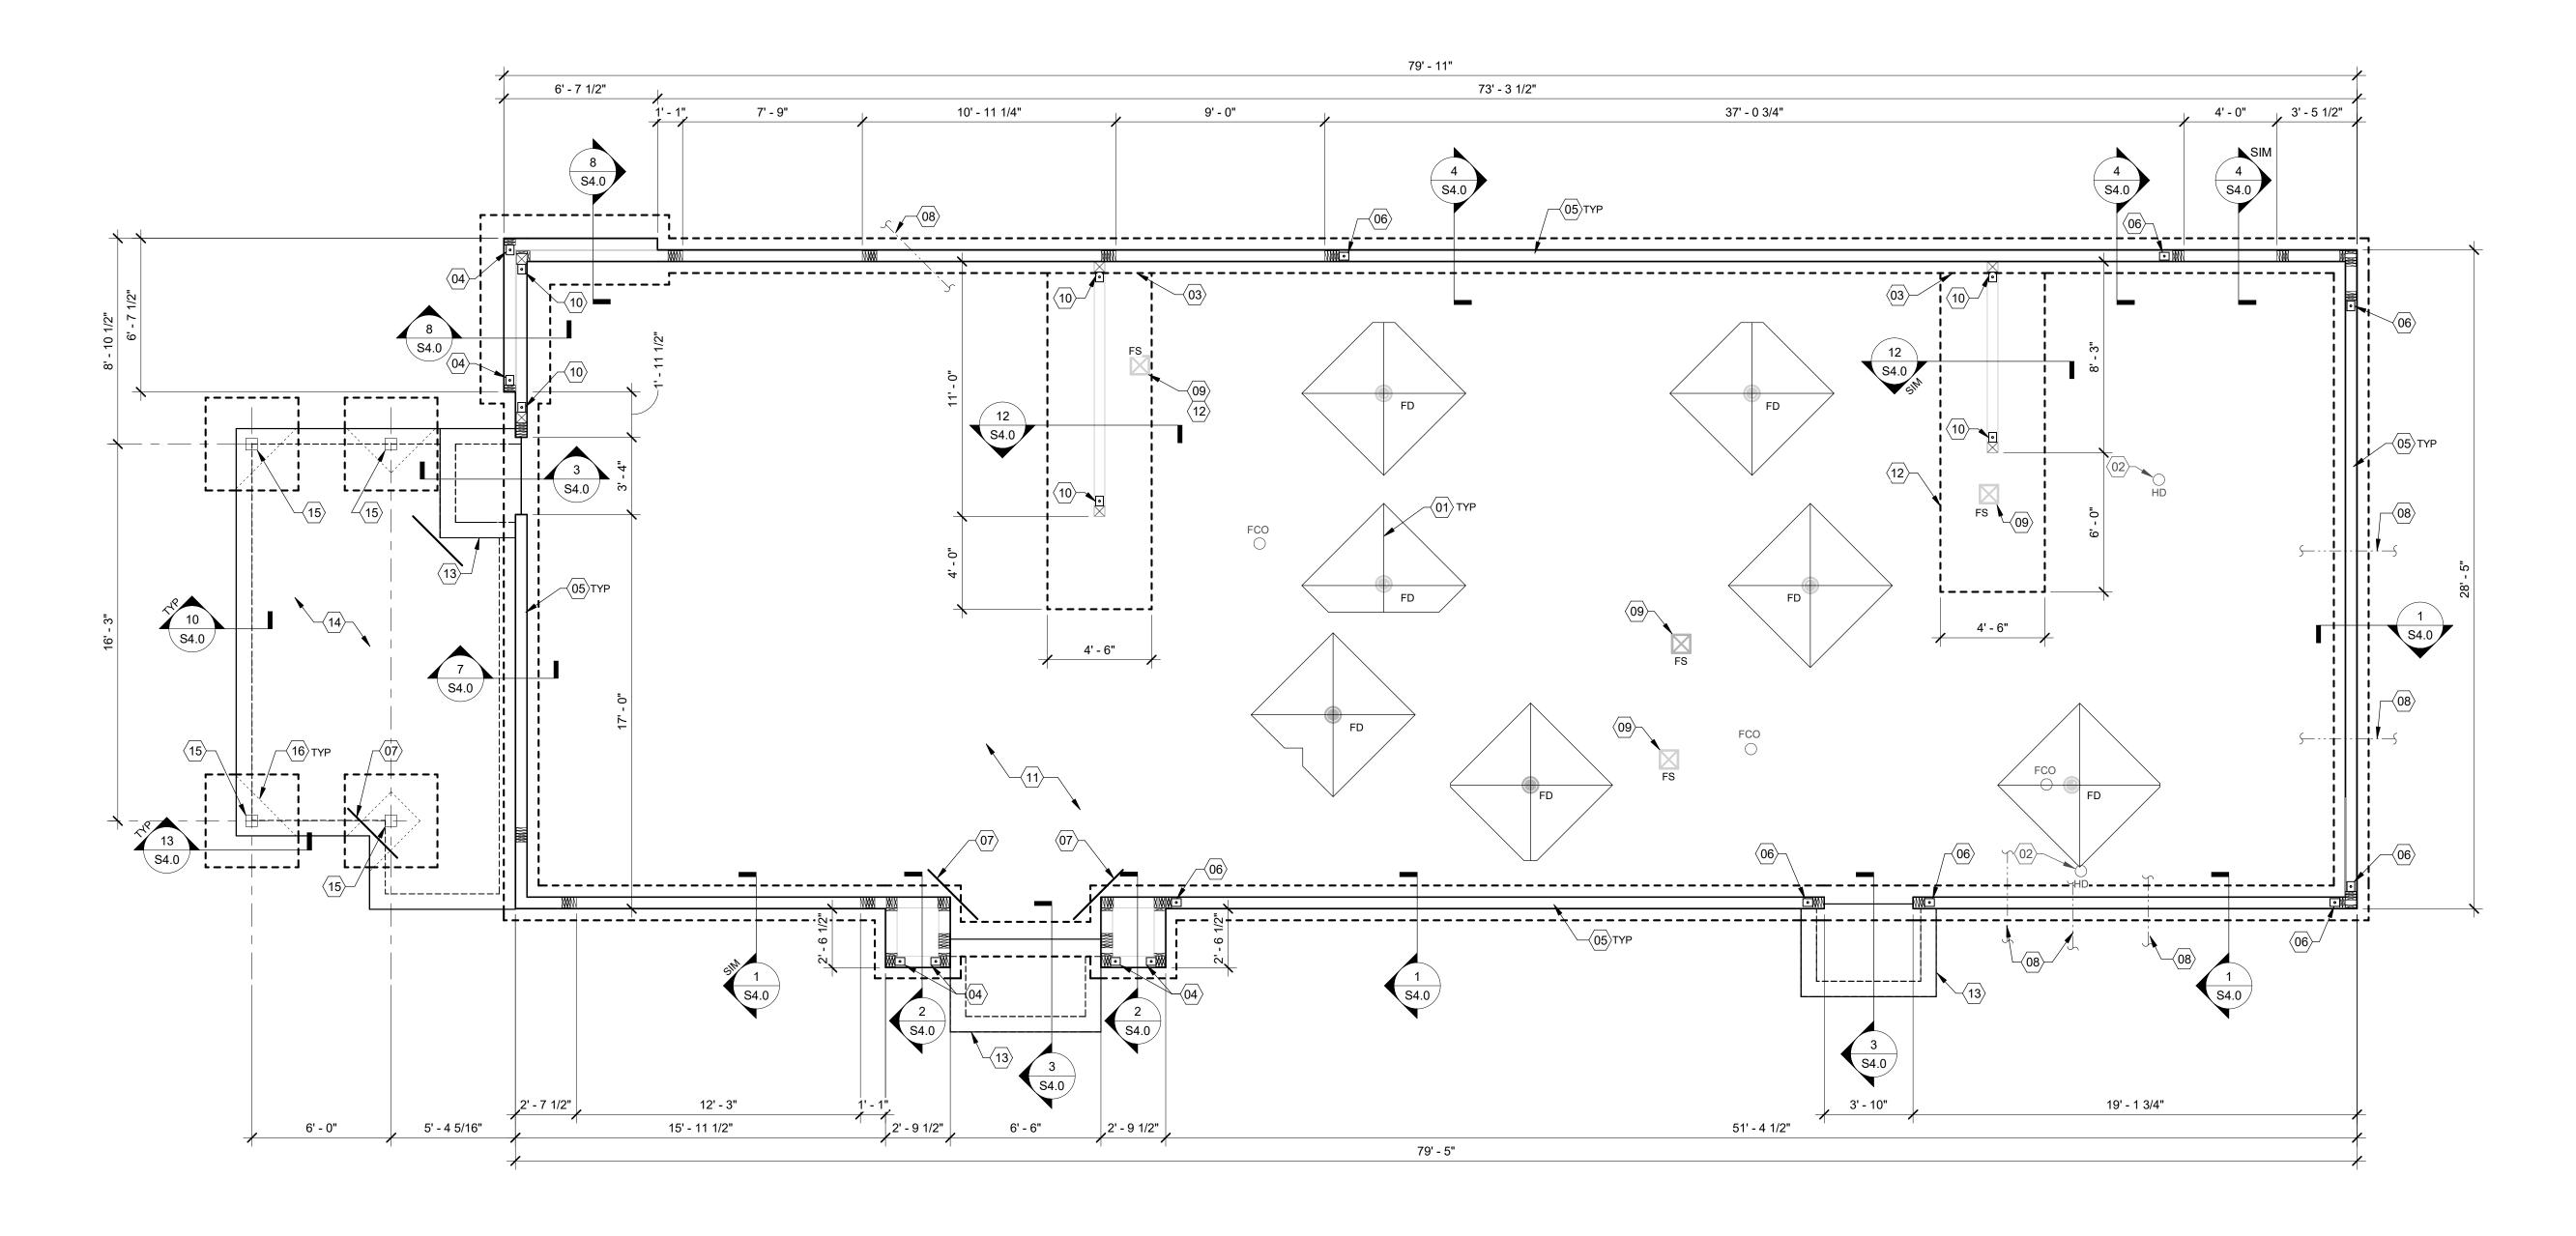

CONTRACT DATE: BUILDING TYPE: PLAN VERSION: BRAND DESIGNER:

08.09.22 | IFB

SITE NUMBER:

DRAWN BY

STORE NUMBER:

04.13.22

END. 80FT

DICKSON

2021088.52

315672

MARCH 2021

FOUNDATION PLAN 1/4" = 1'-0"

DESIGN CRITERIA:

RISK CATEGORY:

EXPOSURE CATEGORY (MWFRS):

SEE SHEET S4.4 FOR COMPONENT AND

INTERNAL PRESSURE COEFF.:

CLADDING PRESSURES.

<u>DESIGN CRITERIA:</u> 2017 OHIO BUILDING CODE (2015 IBC) SEISMIC LOADS: RISK CATEGORY ROOF SNOW LOADS: GROUND SNOW LOAD (Pg): SITE CLASS: EXPOSURE FACTOR (Ce): IMPORTANCE FACTOR (I): THERMAL FACTOR (Ct): 14 PSF FLAT ROOF SNOW LOAD (Pf): MIN. ROOF SNOW LOAD (Pmin): SPECTRAL RESPONSE COEFF.: SHORT PERIODS (SDS): 1 SEC. PERIODS (SD1) DEAD LOAD: SEISMIC DESIGN CATEGORY: WOOD SHEARWALLS RESPONSE MOD FACTOR (R):

DESIGN CRITERIA

± 0.18

SEISMIC IMPORTANCE FACTOR: 1.0 MAPPED SPECTRAL RESPONSE ACCEL 0.0547g

DESIGN BASE SHEAR (Cs): 0.0223*W

ANALYSIS BY SIMPLIFIED PROCEDURE

NEAR THE STRUCTURES.

FOUNDATION NOTES - TYP U.N.O.:

FOUNDATION DESIGN IS BASED UPON THE GEOTECHNICAL ENGINEERING REPORT BY INTERTEK PSI, DATED MARCH 29, 2022. PROJECT NO. 0142-2517.

CONTRACTOR TO PROVIDE FOUNDATION & FOOTING AS REQUIRED FOR PYLON OR MONUMENTAL SIGN. SEE ELECTRICAL DRAWINGS FOR DETAIL. COORDINATE STRUCTURAL PLANS AND DETAILS WITH REQUIREMENTS OF GEOTECHNICAL REPORT. FOUNDATION DESIGN IS BASED ON 2,500 PSF ALLOWABLE BEARING CAPACITY.

CONTRACTOR SHALL TREAT SOIL BELOW SLAB FOR TERMITES. REFER TO THE GEOTECHNICAL REPORT FOR GENERAL REQUIREMENTS OF EARTHWORK, OVEREXCAVATION, SUBGRADE PREPARATION, FILL AND COMPACTION, WATERPROOFING

AND OTHER PERTINENT REQUIREMENTS AND INFORMATION. PROTECT PIPES AND CONDUITS RUNNING THROUGH WALLS AND SLABS WITH 1/2 INCH EXPANSION MATERIAL. LOWER CONTINUOUS FOOTINGS PERPENDICULAR TO PIPE RUNS TO ALLOW PIPES TO PASS ABOVE THE FOOTINGS. ALTERNATIVELY, PROVIDE A CONCRETE JACKET IF PIPES ARE LOW ENOUGH TO BE PLACED BELOW THE FOOTINGS AND GRADE BEAMS. LOWER FOOTINGS PARALLEL TO PIPE RUNS TO AVOID SURCHARGE

ONTO ADJACENT TRENCH EXCAVATIONS. MAINTAIN SUBGRADE AND FILL MOISTURE CONTENT UNTIL FOUNDATIONS ARE PLACED. ARRANGE FOR OWNER'S INDEPENDENT TESTING AGENCY TO MONITOR CUT AND FILL OPERATIONS AND PERFORM FIELD DENSITY AND MOISTURE CONTENT TESTS TO VERIFY COMPACTION AND APPROVE FOOTING SUBGRADES PRIOR TO PLACING CONCRETE.

DO NOT PLACE FOOTINGS OR SLABS AGAINST SUBGRADE CONTAINING FREE WATER, FROST, OR ICE.

MAINTAIN PROPER SITE DRAINAGE DURING CONSTRUCTION TO ENSURE SURFACE RUNOFF AWAY FROM STRUCTURES AND TO PREVENT PONDING OF SURFACE RUNOFF

CONCRETE SHALL BE HARD ROCK CONC. (5 SACK CEMENT PER CU.YD. MIN.) AND MEET THE

FOLLOWING MIN. ULTIMATE COMPRESSIVÈ STRENGTHS AT 28 DAYS:

MIN STRENGTH AGGREGATE SLUMP LOCATION SLAB ON GRADE INCHES TOLERANCE SIZE - INCHES FOUNDATIONS (4000 DESIGN)

CONCRETE MIX DESIGN AND TESTING SHALL MEET WITH THESE SPECS. CEMENT SHALL BE

IN ACCORDANCE WITH ASTM C 150 TYPE II. VERIFY MIN. CONC. STRENGTH AND CEMENT REINFORCING STEEL SHALL CONFORM TO ASTM A-615, GRADE 60. STEEL SHALL BE KEPT CLEAN AND FREE OF RUST.

CONCRETE CURING SHALL BE IN ACCORDANCE WITH REQUIREMENTS OF ACI-318-14 SECTION 5.11 AND STANDARD PRACTICE FOR CURING CONCRETE REPORTED BY

ANCHOR BOLTS - A36 OR A307. ANCHOR BOLTS SHALL BE TIED IN PLACE PRIOR TO PLACEMENT OF CONCRETE. SEE SCHEDULE FOR REQUIREMENTS. TO RESIST FREEZE - THAW DETERIORATION W/C. RATIO SHALL NOT EXCEED .50 FOR

CONCRETE IN CONTACT WITH SOILS. TOTAL AIR CONTENT TO BE 6% ± 1%.

A. DESIGN IS BASED UPON 4" THICK CONCRETE SLAB REINFORCED WITH WWF 6x6-W2.9xW2.9 OVER 10 MIL VISQUEEN MEMBRANE, ON PREPARED SUBGRADE PER THE PROJECT

GEOTECHNICAL REPORT. DIMENSIONS NOTED ARE TO FACE OF CONCRETE. REFER TO DWG. A1.0 FOR DIMENSIONS

TO FACE OF STUD AND OTHER DIMENSIONS NOT OTHERWISE NOTED. DRAWINGS SHALL NOT BE SCALED. ALL DIMENSIONS AND FIT SHALL BE DETERMINED AND VERIFIED BY THE CONTRACTOR PRIOR TO COMMENCEMENT OF WORK. C. DETAILS NOT FULLY OR SPECIFICALLY SHOWN SHALL BE OF SAME NATURE AS OTHER

SIMILAR CONDITIONS. SEE PLUMB. DWGS. FOR PLUMB. LAYOUT DIMENSIONS, U.O.N.

SEE ELECT. DWGS. FOR ELECT. LAYOUT DIMENSIONS, U.O.N. COORD. FOUNDATION AND SLAB LAYOUT WITH OTHER TRADES PRIOR TO PLACING SLAB.

SPECIAL INSPECTIONS:

SPECIAL INSPECTIONS ARE TO BE PROVIDED IN ACCORDANCE WITH SECTION 1704. SPECIAL INSPECTIONS SHALL BE IN ADDITION TO THE INSPECTIONS CONDUCTED BY THE DEPARTMENT OF BUILDING SAFETY AND SHALL NOT BE CONSTRUED TO RELIEVE THE OWNER OR THEIR AUTHORIZED AGENT FROM REQUESTING THE PERIODIC AND CALLED INSPECTIONS REQUIRED BY THE BUILDING CODE. SPECIAL INSPECTION SHALL BE PAID BY THE OWNER.

REQUIRED SPECIAL INSPECTIONS:

IN ADDITION TO THE REGULAR INSPECTIONS, THE FOLLOWING ITEMS WILL ALSO REQUIRE SPECIAL INSPECTION IN ACCORDANCE WITH THE BUILDING CODE.

- SOILS COMPLIANCE PRIOR TO FOUNDATION INSPECTION
- (COMPACTING FILL, SPECIAL GRADING) STRUCTURAL CONCRETE OVER 2,500 PSI


SPECIAL INSPECTOR SHALL MEET THE QUALIFICATIONS AS STATED IN THE BUILDING CODE AND SHALL PERFORM THE DUTIES AND RESPONSIBILITIES AS OUTLINED IN THE BUILDING CODE. THE SPECIAL INSPECTOR SHALL PROVIDE INSPECTION REPORTS TO THE CODE OFFICIAL, ENGINEER AND OWNER.

- 01) SLAB SHALL BE PITCHED 1/2" FOR 5'-0" x 5'-0" SQUARE AT ALL FLOOR DRAINS U.O.N. REFER TO PLUMBING DRAWINGS FOR
- 02) PROVIDE HUB DRAIN (HD) UNLESS REQUIRED BY LOCAL CODE TO HAVE FLOOR SINK (FS).
- $\langle 03
 angle$ BOTTOM OF FOOTING STEPS DOWN, SEE SECTION 12/S4.0
- HTT5 HOLDOWN ANCHOR. SEE 6/S4.0 FOR HOLDOWN EMBEDMENT DETAIL. ANCHOR BOLTS LOCATED THROUGHOUT PERIMETER OF BUILDING SHALL BE PROVIDED AS REQUIRED PER THE "PLATE/ANCHOR BOLT" COLUMN OF THE "WALL SHEATHING
- 06 HDU5 HOLDOWN ANCHOR AT EACH END OF SHEARWALL. SEE 6/S4.0 FOR HOLDOWN EMBEDMENT DETAIL.
- $\langle 07 \rangle$ (2) #4x3'-0" LG. RE-ENTRANT BARS (CENTERED IN SLAB) AT ÀLL RE-ENTRANT CORNERS.

AND SHEARWALL SCHEDULE." SEE D/S2.0.

- $\langle 08
 angle$ underground pipe, see civil and plumbing dwgs.
- $\langle 09
 angle$ FLOOR SINK REFER TO PLUMBING DRAWINGS FOR LOCATION. (10) HD12 HOLDOWN ANCHOR AT EACH END OF FRONT SHEARWALL. SEE 6/S4.0 FOR HOLDOWN EMBEDMENT DETAIL ENTRANT CORNERS.

- 4" CONCRETE SLAB SEE FOUNDATION PLAN NOTES D/S1.0. MODIFY BASE MATERIAL AS REQUIRED BY ON-SITE SOILS TESING AGENCY. PROVIDE BOND BREAKER BETWEEN SLAB AND BUILDING FOUNDATIONS.
- FORM FOOTING TO ACCOMMODATE FLOOR SINK AND DRAIN
- 12 FORM FOULTS ... LINE INSTALLATION. (13) FROST SLAB - SEE CIVIL PLANS FOR TOP OF CONCRETE ELEVATION.
- (14) 4" EXTERIOR CONCRETE SLAB REINFORCED WITH 6x6-W2.9xW2.9 W.W.F. (CENTERED IN SLAB) OVER 4" COMPACTED GRANULAR FILL OVER COMPACTED SUBGRADE. SEE SLAB NOTES THIS SHEET FOR ADDITIONAL INFORMATION. REFER TO
- CIVIL PLAN FOR EXTENTS OF SLAB. $\langle 15 \rangle$ HSS6x6x3/16 COLUMN WITH 3/4"x1'-0"x1'-0" BASE PLATE.
- $\langle 16
 angle$ SLAB ISOLATION JOINT AT CANOPY COLUMNS. TYPICAL.

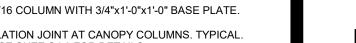

ENDEAVOR 2.0 REFERENCE SHEE S4.0 FOR DETAILS.

FOUNDATION PLAN

TACO BELL


1551 West River Rd.

Elyria, OH

FOUNDATION NOTES D | SPECIAL INSPECTIONS **FOUNDATION KEYNOTES**



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WALL FRAMING PLAN 1/4" = 1'-0"

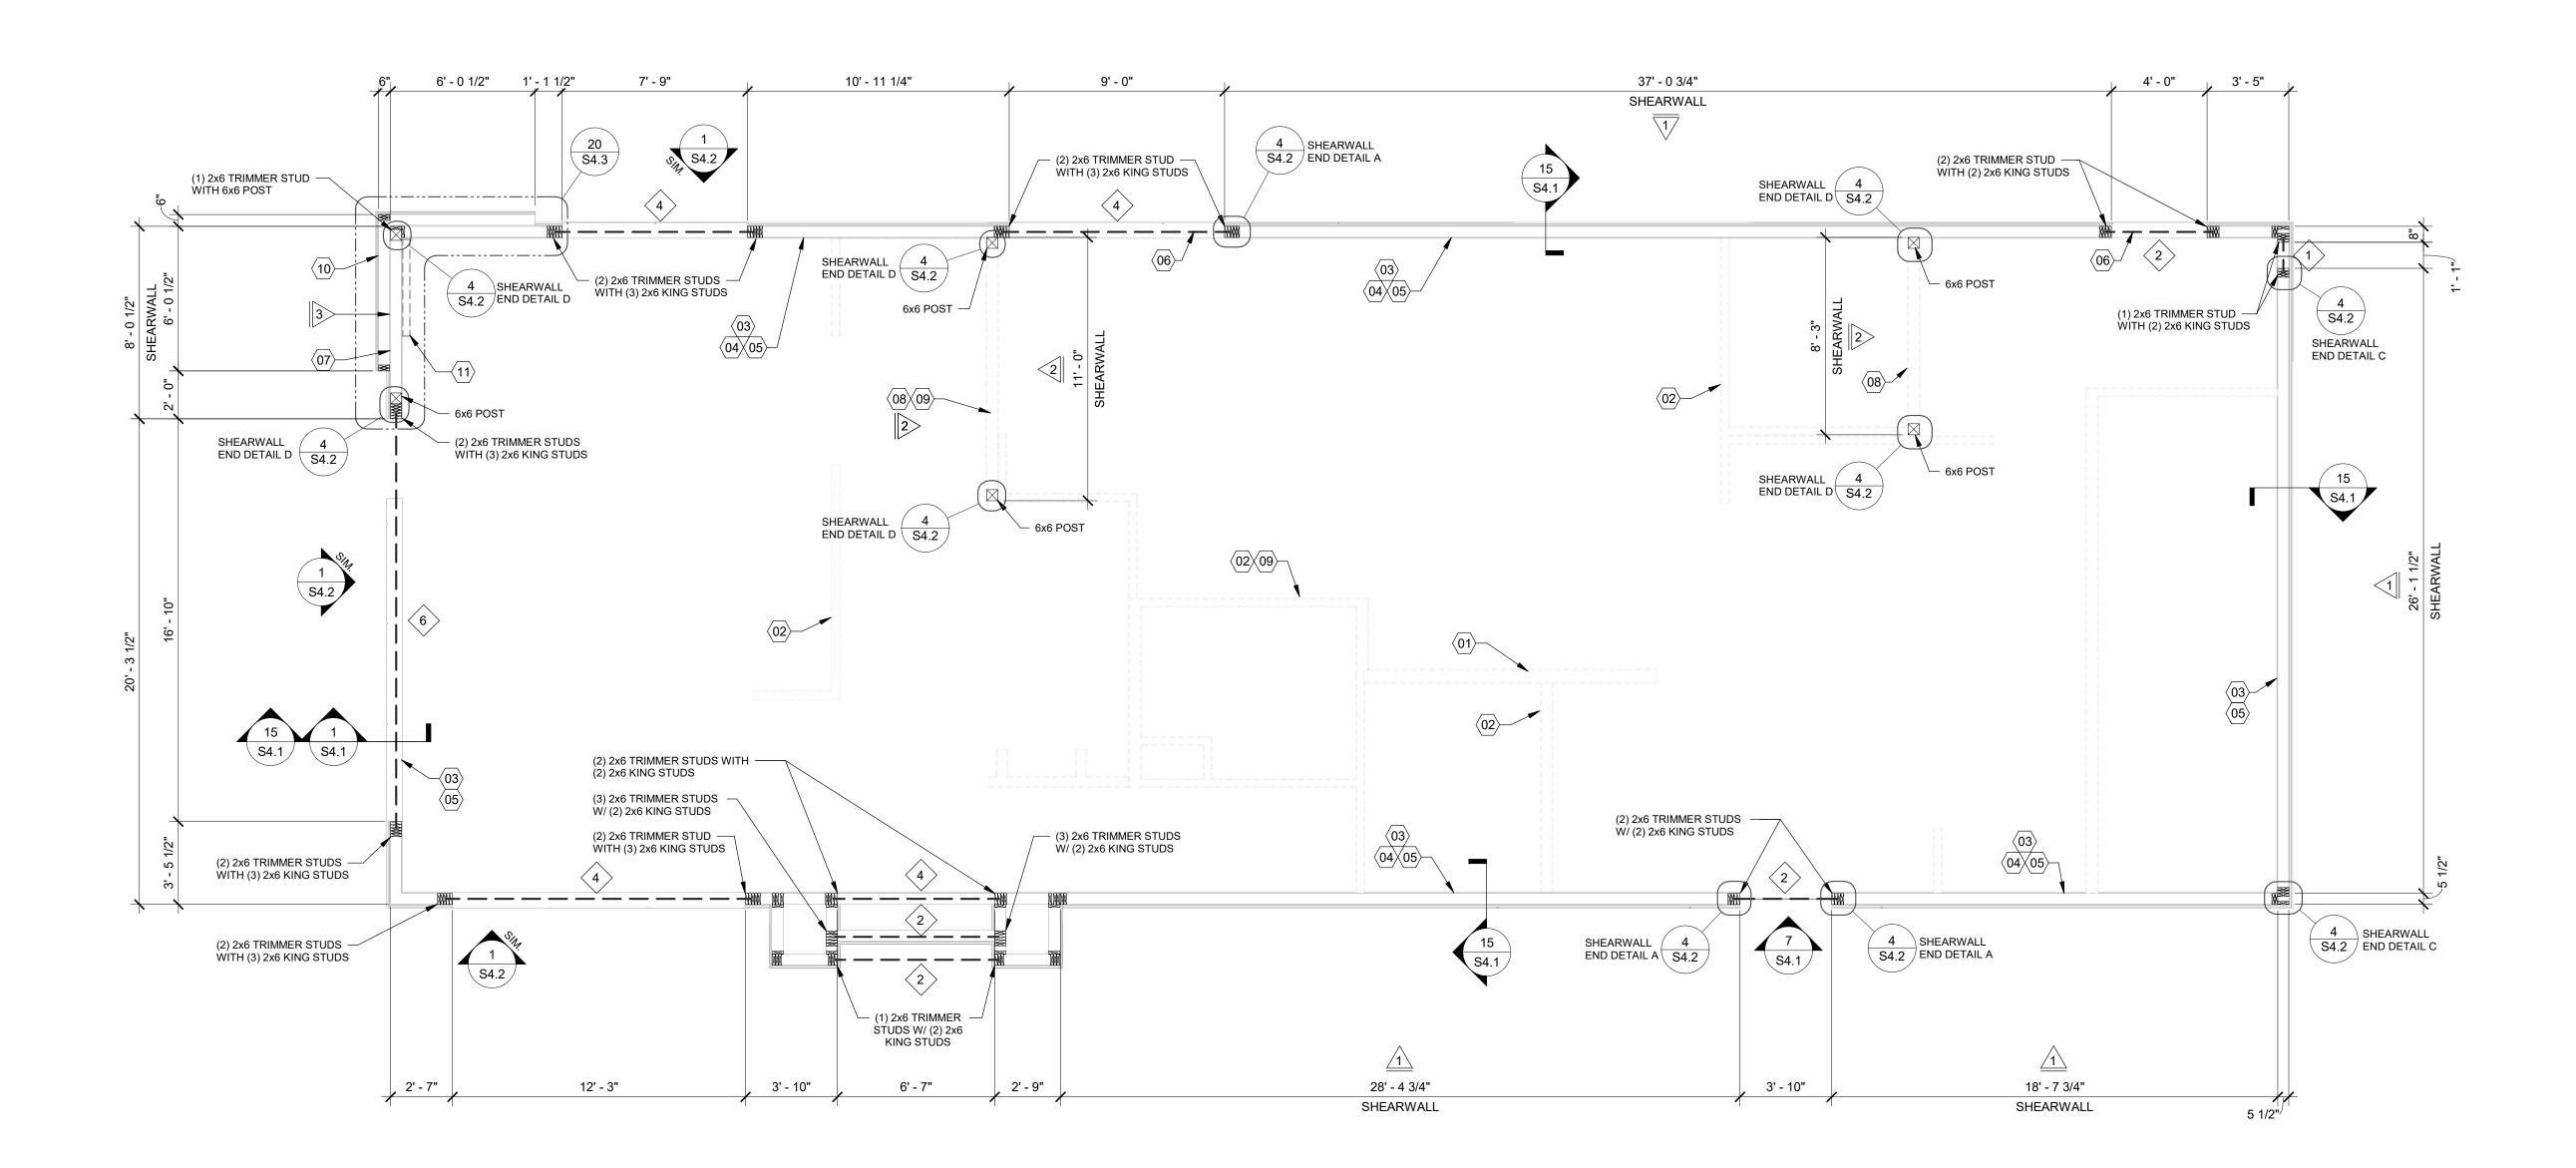	UEADE	2 COLLEGE F					WALL SH	EATHING AND SHEARWALL SCHEDULE	
	HEADE	RSCHEDULE	S	SW	SHEATHING	EDGE	FIELD	PLATE / ANCHOR BOLT	REMARKS
MARK	BUILT-UP SECTION	BUILT-UP MANUF. MEMBER		\triangleright	1/2" CDX PLYWD (32/16), PS1 RATING	10d @ 6" O.C.	10d @ 12" O.C.	5/8" DIA. F1554 (22x3) @ 32" O.C. W/ WASHER	PLYWOOD ON EXTERIOR FACE OF STUDS
$\langle 1 \rangle$	(3) 2x8			2>	1/2" CDX PLYWD (32/16), PS1 RATING	10d @ 4" O.C.	10d @ 12" O.C.	5/8" DIA. F1554 (18x3) @ 16" O.C. W/ WASHER	PLYWOOD ON BOTH SIDES OF STUDS
				3>	1/2" CDX PLYWD (32/16), PS1 RATING	10d @ 4" O.C.	10d @ 12" O.C.	5/8" DIA. F1554, (22x3) @ 16" O.C. W/ WASHER	PLYWOOD ON EXTERIOR FACE OF WALL
2	(3) 2x10								
3	(3) 2x12								
\ \ \ \ \ \ \ \			***		1/2" CDX PLYWD (32/16), PS1 RATING	10d @ 6" O.C.	10d @ 12" O.C.	5/8" DIA. F1554, (22x3) @ 48" O.C. W/ WASHER	NAILING AT HEADERS PER 14/S4.1
4		5 1/4" x 9 1/4" PSL	***	REQ	UIREMENTS FOR EXTERIOR NON-SHEAR	RWALL WALLS	•	-	•

REQUIREMENTS FOR EXTERIOR NON-SHEARWALL WALLS

PROJECT ENGINEER AND THE LOCAL JURISDICTION.

O.C. OR LESS AND 8d NAILING IS 2" O.C. OR LESS.

REQUIREMENTS.

OSB OF COMPARABLE THICKNESS MAY BE USED IN LIEU OF PLYWOOD WHEN APPROVED IN

BLOCK ALL UNSUPPORTED EDGES WITH 2x MATERIAL U.O.N. BLOCK EDGES WITH 3x MATERIAL

WHERE 10d NAILING IS 3" O.C. OR LESS AND 8d NAILING IS 2" O.C. OR LESS.ALL UNSUPPORTED

EDGES WITH 2x MATERIAL U.O.N. BLOCK EDGES WITH 3x MATERIAL WHERE 10d NAILING IS 3"

EXTERIOR WALLS NOT DESIGNATED AS SHEARWALLS IN THE WALL FRAMING PLAN SHALL MEET

WRITING BY THE PROJECT ENGINEER AND THE LOCAL JURISDICTION OF COMPARABLE

THICKNESS MAY BE USED IN LIEU OF PLYWOOD WHEN APPROVED IN WRITING BY THE

ALL PLYWOOD NAILS SHALL BE COMMON WIRE. SEE SPECIFICATIONS FOR OTHER NAIL

REQUIREMENTS INDICATED FOR NON-SHEARWALL WALLS IN THE SCHEDULE ABOVE.

- 2. PSL BEAMS TO HAVE FOLLOWING MIN. PROPERTIES:
- NOTES:

 1. BUILT-UP HEADER SECTION SHALL HAVE 1/2" PLYWOOD SANDWICHED PIECES. REF. 14/S4.1
- Fb = 2900 PSI Fc = 750 PSI Fv = 290 PSI E = 2000 KSI

4

5

6

- - 5. SHEARWALL LENGTHS WHERE NOTED ARE MINIMUM. DO NOT LOCATE HOLDOWNS FROM THESE DIMENSIONS. SEE ARCH DWGS FOR ACTUAL WALL LENGTHS.
 - 6. HD REFERS TO SIMPSON STRONGTIE CO. HOLDOWNS. INSTALL PER 6/S4.0. POST WIDTH SHALL MATCH STUD WALL WIDTH. SEE FOUNDATION PLAN FOR OTHER REQ'S. EDGE NAIL WALL PLY TO STUDS OR POSTS WITH HOLDOWNS.
 - 8. WHERE PANELS ARE APPLIED TO BOTH FACES OF A WALL AND NAIL SPACING IS LESS THAN 6" O.C. ON EITHER SIDE, PANEL JOINTS SHALL BE OFFSET TO WALL ON DIFFERENT FRAMING MEMBERS OR FRAMING SHALL BE 3x OR THICKER AND NAILS ON EACH SIDE SHALL BE

WALL FRAMING NOTES - TYP U.N.O.:

- A. EXTERIOR WALL NON-BEARING & BEARING STUDS SHALL BE SOUTHERN PINE NO. 2. 6x6 POSTS TO BE SOUTHERN PINE NO. 2. INTERIOR WALL STUDS MAY BE STUD GRADE.
- B. ALL BEAMS AND JOISTS SHALL BE SEAT CUT FOR FULL UNIFORM BEARING AT SUPPORTS, BEAM SEATS AND COLUMN CAPS.
- SEE SHEET A1.0 FOR DIMENSIONS. EXTERIOR STUD WALLS ARE 2x6 AT 16" O.C. U.O.N.
- ALL WOOD IN CONTACT WITH CONC., STEEL OR GRADE SHALL BE PRESSURE TREATED. ALL BOLTED OR NAILED STRAP CONNECTIONS SHALL HAVE AN EQUAL NUMBER OF BOLTS OR NAILS EACH SIDE OF THE SPLICE JOINT. THE FIRST BOLT OR NAIL FROM EACH SIDE OF THE SPLICED OR TREATED MEMBER SHALL BE EQUAL DISTANCE FROM THE SPLICE. STRAPS USING 16d NAILS ON 2x MATERIAL SHALL BE INSTALLED ON THE 1-1/2" EDGE OF
- G. THE CONTRACTOR SHALL VERIFY THAT THE MOISTURE CONTENT OF ALL FRAMING LUMBER AND PLYWOOD MEET THE REQUIREMENTS OF THE SPECS. AT THE TIME OF INSTALLATION AND AT CLOSE-IN.
- H. USE PRESSURE TREATED LUMBER AT WINDOW JAMBS, SILL AND STUDS UNDER SILL AS WELL AS ALL TOILET PLUMBING WALLS.
- STUD LAYOUT:
 A. LAYOUT STUDS ON SIDEWALLS (LONG WALLS) STARTING AT REAR OF BUILDING TOWARDS
- B. LAYOUT STUDS ON ENDWALLS (SHORT WALLS) STARTING AT EACH END AND WORKING TOWARDS CENTER.

- $\langle 01 \rangle$ COLD-FORMED STUD WALL (NON-LOAD BEARING STUD WALL). SEE ARCH.
- 02 INTERIOR NON-BEARING STUD WALL FRAMING; REFER TO SHEET A1.0 FOR DIMENSIONS AND STUD SIZES. SEE DETAIL 10 & 11/S4.1 AND WALL FRAMING NOTES.
- (2) 2x6 TOP PLATES AT TRUSS BEARING SPLICE PER 16/S4.1. U.O.N. REF. 1/S4.3 FOR PARAPET CAP DETAIL.
- $\langle 04 \rangle$ TOP OF TRUSS BEARING PLATE. SEE DETAIL 2/S4.1. $\langle 05 \rangle$ TOP OF PARAPET. SEE S3.0.
- ENSURE ROUGH OPENING DIMENSION TO PROVIDE TOLERANCE FOR DRIVE THRU WINDOW INSTALLATION. COORDINATE WITH WINDOW MANUFACTURER.
- $\langle 07
 angle$ EXTERIOR SHEATHING SHALL NOT BE INTERRUPTED WITH ADJACENT FRAMING TYPICAL.
- $\langle 08 \rangle$ INTERIOR SHEAR WALL. PROVIDE 6x6 POST AT EACH END OF WALL.
- $\langle 09 \rangle$ COORDINATE WITH PLUMBING ROUGH IN SHEET P4.0.
- 2x FRAMING ON THICKENED CONCRETE FOUNDATION / PIER; SEE SHEETS S1.0 AND S4.0. DIMENSIONS FOR FRAMING ARE TO FACE OF STUD.
- $\langle 11 \rangle$ 2x4 FRAMING FOR ALCOVE. SEE ARCHITECTURAL.

TACO	RFII

DRAWN BY.

08.09.22 | IFB

04.13.22

END. 80FT

DICKSON

2021088.52

315672

MARCH 2021

CONTRACT DATE:

1551 West River Rd.



Elyria, OH

ENDEAVOR 2.0 WALL FRAMING **PLAN**

PLOT DATE: 8/9/2022 1:01:59 PM

D

C

WALL FRAMING KEYNOTES

HEADER SCHEDULE E

5 1/4" x 11 1/4" PSL


5 1/4" x 14" PSL

WALL SHEATHING AND SHEARWALL SCHEDULE

WALL FRAMING NOTES

GPD GROUP

520 S. MAIN STREET, SUIT 2531 AKRON, OH 44311 330.572.2100 FAX: 330.572.2102

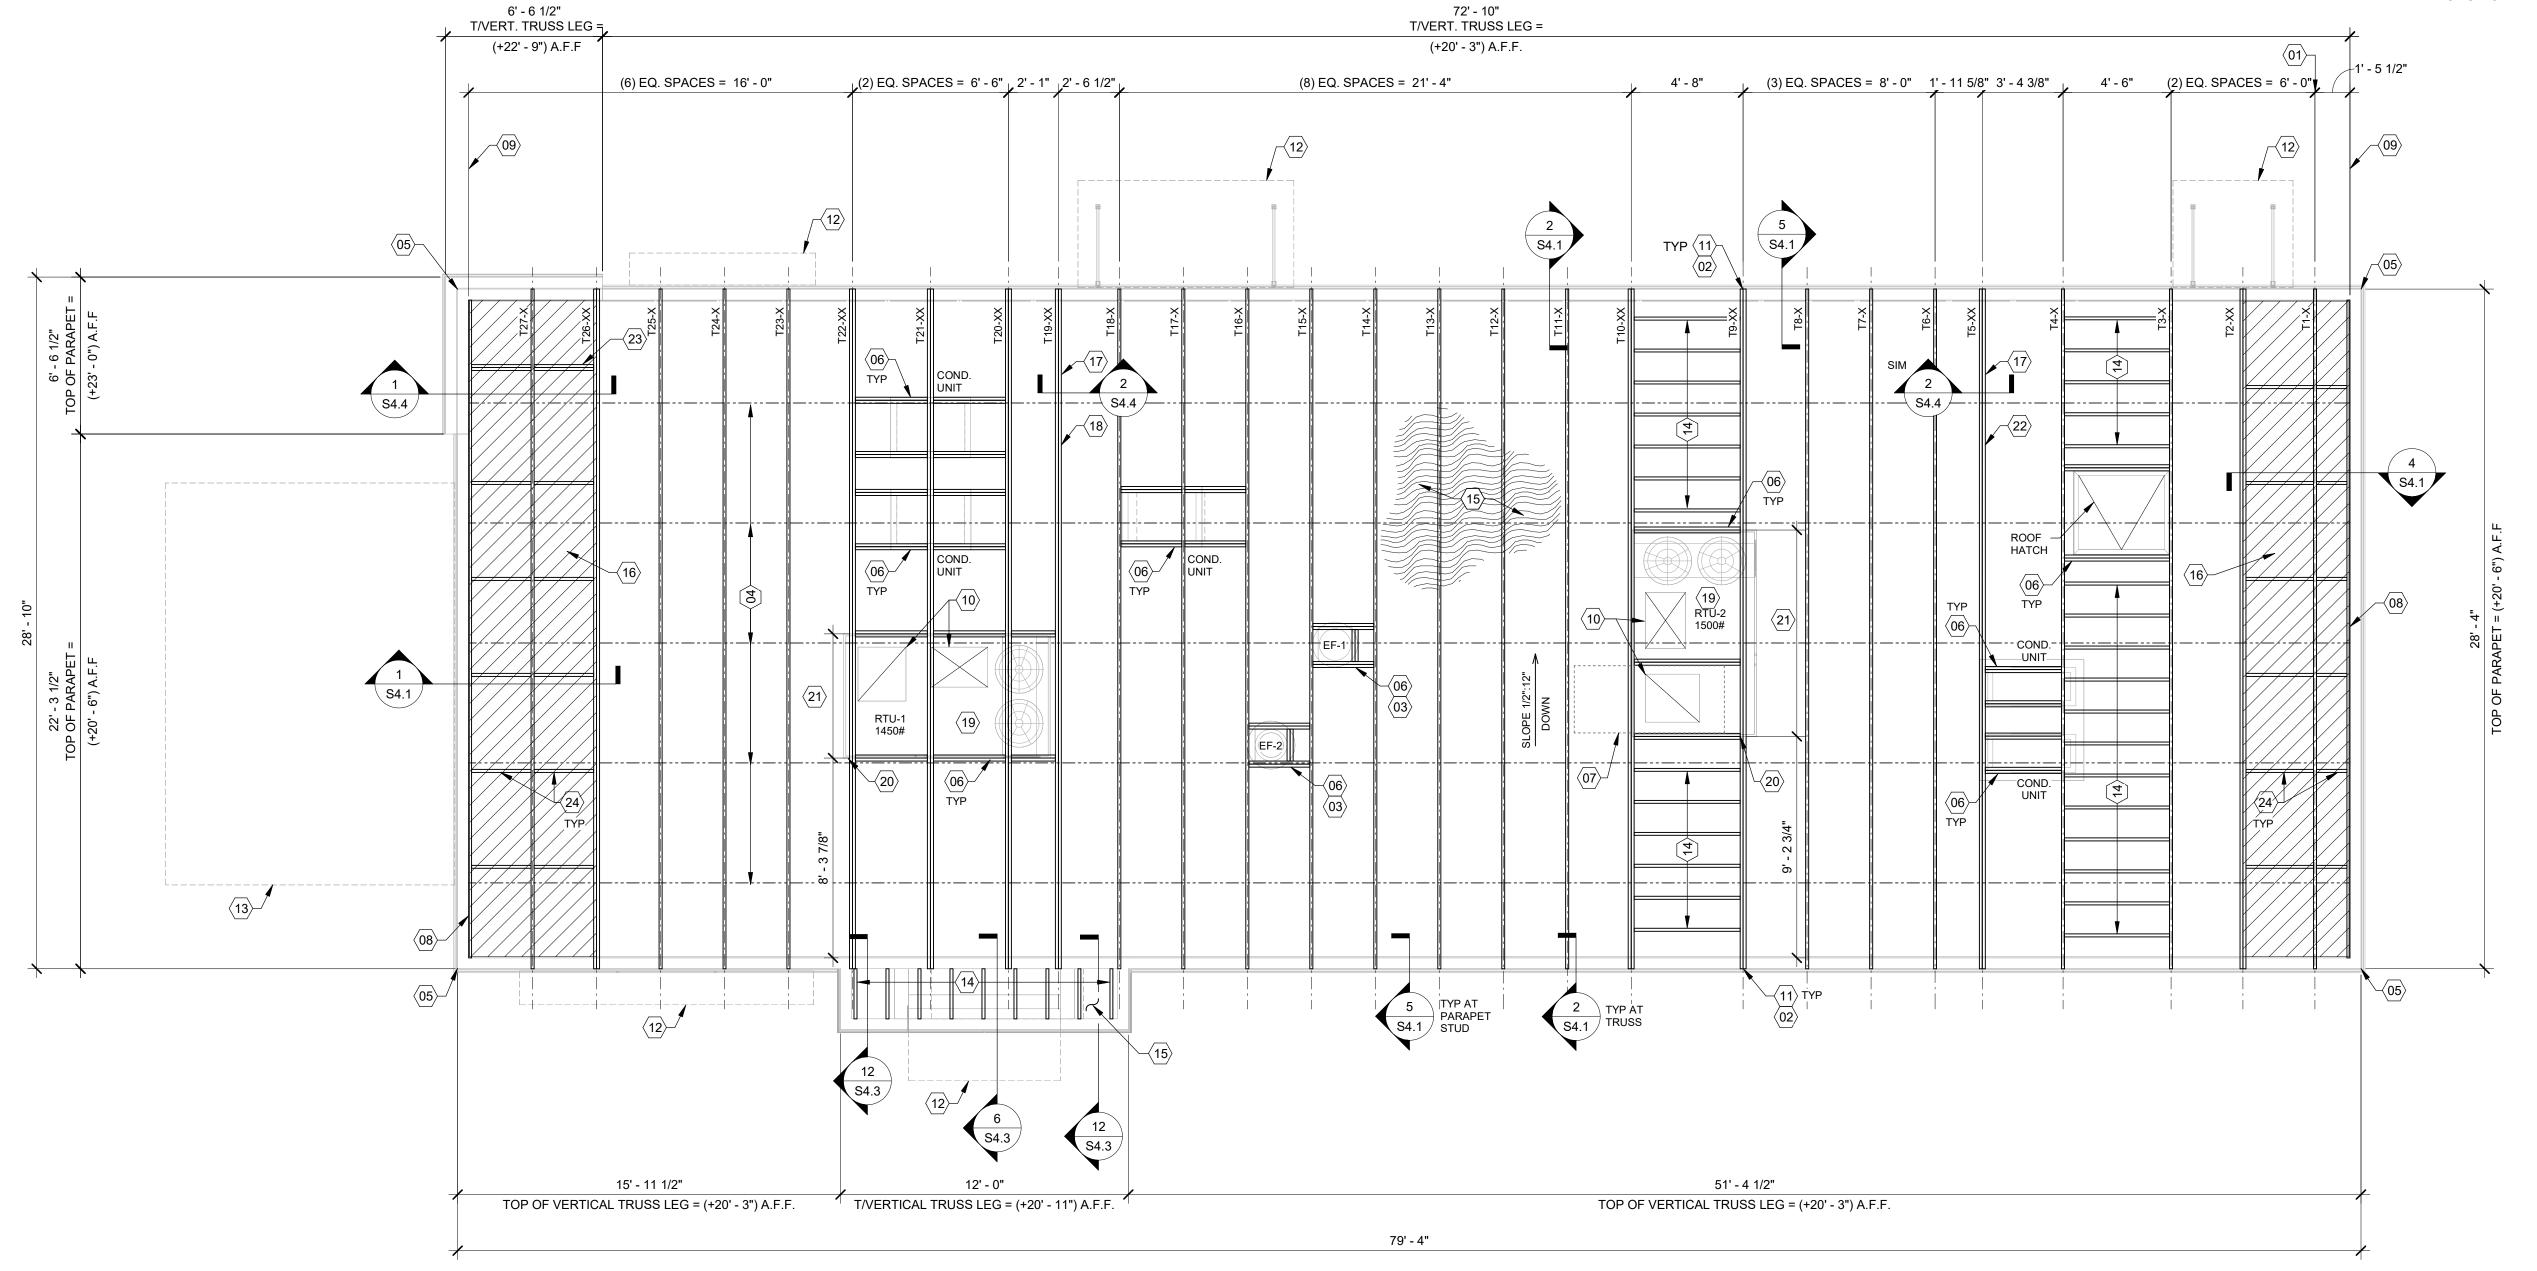

EXTREME CARE SHALL BE USED IN ERECTING ROOF TRUSSES -COMPLY WITH TPI BRACING REQUIREMENTS.

ROOF NOT DESIGNED FOR PONDING. SEE ARCHITECTURAL DRAWINGS FOR DRAIN REQUIREMENTS.



ROOF FRAMING PLAN 1/4" = 1'-0"

ROOF NAILING SCHEDULE									
TYPE	NAILING / SHEATHING	REMARKS							
BN	10d @ 6" O.C.								
EN	10d @ 6" O.C.								
FN	10d @ 12" O.C.								
ROOF SHEATHING	19/32" CDX PLYWOOD (40/20) PS1 RATING								

NOTES: SEE 8/S4.2 FOR DEFINITIONS AND ROOF NAILING PLAN. SEE 11/S4.2 FOR TYPICAL NAILING SCHEDULE.

A. ALL UNSUPPORTED EDGES OF PLYWOOD SHEATHING SHALL BE SUPPORTED WITH SIMPSON PSCL CLIPS, PROVIDE (2) CLIPS EQUALLY SPACED BETWEEN EACH TRUSS/SUPPORT. SEE DETAIL 9/S4.2. OSB OF COMPARABLE THICKNESS MAY BE USED IN LIEU OF PLYWOOD WHEN

APPROVED IN WRITING BY THE PROJECT ENGINEER AND THE LOCAL JURISDICTION. B. ALL MECHANICAL SUPPLY AND RETURN OPENINGS SHALL BE BETWEEN FRAMING U.O.N.

MANUFACTURED ROOF TRUSS NOTES:
A. MFR'D ROOF TRUSSES ARE AT 2'-8" O.C. U.O.N.

B. "T-#" DENOTES ROOF TRUSS TYPE. REFER TO SCHEDULE 7/S4.2. TRUSS DWGS ARE PROVIDED FOR CONCEPTUAL DESIGN ONLY. MFR. SHALL SUBMIT SHOP DWGS. AND CALCS, BOTH SIGNED BY A LICENSED STRUCTURAL ENGINEER (STATE OF OHIO). SUBMIT SHOP DWGS. AND CALCS TO THE ARCHITECT AND ENGINEER FOR REVIEW AND SUBMITTAL AND, IF REQUIRED, TO BLDG OFFICIAL FOR APPROVAL PRIOR TO FABRICATION. SHOP DWGS SHALL INCLUDE LAYOUT PLAN AND CONNECTORS. CALCS SHALL BE BASED ON THE SPECIFIED LOADING CONDITIONS SHOWN HEREIN. MFR SHALL PROVIDE HANGERS AND CONNECTIONS BETWEEN TRUSSES. REVIEW AND APPROVE DIMENSIONS,

ARCHITECT / ENGINEER FOR REVIEW AND COMMENT. TRUSS MFR SHALL PROVIDE HANGERS AND CONNECTORS ADEQUATE FOR LOADS. ROOF CONNECTORS ARE BASED UPON SIMPSON "STRONG TIE" OR APPROVED EQUAL.

TRUSS CHORDS AND PARAPET VERTICALS SHALL BE 2x6 MIN AND CONSISTENTLY SIZED THROUGHOUT PROJECT.

SHAPES AND DETAILS SHOWN ON SHOP DWGS. PRIOR TO SUBMITTAL TO THE

REFER TO TRUSS ELEVATIONS FOR SHAPE, OVERHANG, SLOPES, SPAN, ETC. LOCATION OF BEARING POINTS ARE AS INDICATED ON THE DRAWINGS. SEE 2/S4.2. G. MFR'D ROOF TRUSS DESIGN LOADS: SEE TRUSS DESIGN CRITERIA 3/S4.2. THE POSITIONS, WEIGHTS, AND METHODS OF ATTACHMENT OF ALL MECHANICAL UNITS,

DESIGN ROOF TRUSSES TO SUPPORT ALL IMPOSED LOADS, INCLUDING WIND & LATERAL LOADS. COORDINATE SIZE, LOCATION AND WEIGHT OF EQUIPMENT WITH MECHANICAL WORK. PROVIDE MULTIPLE TRUSSES WHERE ONE TRUSS CANNOT SUPPORT THE LOAD. PROVIDE BRIDGING BETWEEN TRUSSES AS SPECIFIED AS MINIMUM STANDARD.

ELECT FIXTURES, PLUMBING, ETC. SHALL BE INCLUDED IN THE DESIGN OF THE TRUSSES BY

INSTALLATION OF ALL TRUSSES SHALL BE DONE USING A SPREADER BAR WITH A THREE POINT VERTICAL PICK. CARE SHALL BE USED IN LIFTING TO PREVENT HORIZONTAL BENDING. IMPROPER HANDLING OF THE TRUSSES AS NOTED ABOVE AND IN THE SPECS SHALL MEAN REMOVAL OF THE TRUSSES FROM THE JOBSITE AND REPLACEMENT AT CONTRACTOR'S

L. SEE DIV. 6 OF THE SPECS FOR DETAILS ON TRUSS MANUFACTURING AND NAILING.

DELEGATED DESIGN NOTE:
ALL DEFERRED SUBMITTALS SHALL CONTAIN SHOP DRAWING PLANS AND DESIGN CALCULATIONS SIGNED AND SEALED BY A PROFESSIONAL ENGINEER REGISTERED (OTHER THAN THE ENGINEER OF RECORD) IN THE STATE OF OHIO. THE DEFERRED SUBMITTALS SHALL BE SUBMITTED TO ENGINEER OF RECORD FOR REVIEW OF GENERAL CONFORMANCE WITH THE BUILDING DESIGN PRIOR TO CONSTRUCTION, FABRICATION, AND/OR ORDERING OF MATERIALS. ENGINEER OF RECORD APPROVED DEFERRED SUBMITTALS SHALL BE REVIEWED AND APPROVED BY THE LOCAL BUILDING OFFICIALS PRIOR TO INSTALLATION. THE FOLLOWING ITEMS SHALL BE SUBMITTED PER THIS SECTION (REFER TO PLANS FOR ADDITIONAL INFORMATION):

MANUFACTURED WOOD ROOF TRUSSES

 $\langle 01 \rangle$ STARTING POINT OF TRUSS LAYOUT.

VERIFY NECESSITY OF DOUBLE TRUSSES WITH TRUSS MFR. DUE TO POINT LOADING AND ADDITIONAL UNIFORM LOADING, TYPICAL.

 $\langle 03 \rangle$ COORDINATE BLOCKING WITH EXHAUST AND SUPPLY DUCT.

(04) CONT 2x4 WD BRIDGING ON TOP OF BOTTOM CHORD. ADJUST AS REQUIRED FOR DUCT PLENUMS, MAX SPACING AT 7'-0" O.C. OR TIGHTER SPACING AS REQUIRED BY TRUSS DESIGN. SEE 8 & 9/S4.1 FOR BRIDGING LAP DETAIL.

 $\langle 05
angle$ SIMPSON MSTA 24 AT CORNER DBL TOP PLATE. CENTER STRAP ON CORNER. $\langle 06 \rangle$ (2) 2x6 BLOCKING W/ U26-2 HANGERS. TYP. AT EDGES OF ALL ROOF TOP EQUIPMENT

AND ALL ROOF OPENINGS - SEE DET. 6 & 10/S4.2. (07) LOCATION OF HOOD. SEE HOOD DRAWINGS. FOR HOOD ATTACHMENT, SEE DETAIL

 $\langle 08 \rangle$ (2) 2x6 LEDGER REF. 6/S4.1.

 $\langle 09 \rangle$ DIMENSION IS FROM INSIDE FACE OF WALL FRAMING.

\(\frac{10}{DWGS}\) HVAC ROOF OPENING FOR DUCT. VERIFY SIZE WITH HVAC MFR. & MECHANICAL

(11) (2) 2x6 BUILT-UP COLUMN AT TRUSS BEARING, TYP. AT GIRDER TRUSS ONLY. REF.

 $\langle 12 \rangle$ CANOPY- SEE ARCH. DWGS.

DÉTAIL 12/S4.2.

OUTLINE OF CANOPY FRAMING. SEE CANOPY FRAMING PLAN ON SHEET S4.5 FOR CANOPY ROOF FRAMING.

 $\langle 14 \rangle$ 2x6 @ 16" O.C. WITH SIMPSON LUS26 HANGER EA. END.

 $raket{15}$ PLYWOOD ROOF SHEATHING. SEE NAILING SCHEDULE, THIS SHEET.

HATCH DENOTES LOCATION OF KICKERS. SEE 1/S4.4 FOR ADDITIONAL INFORMATION REGARDING KICKERS.

(17) INTERIOR SHEAR WALL BELOW. ALIGN DINING SIDE OF WALL WITH SIDE OF TRUSS. ─ SEE DTL. 2/S4.4.

DRAG TRUSS AT INTERIOR SHEAR WALL. PROVIDE DOUBLE TRUSS. DESIGN DRAG TRUSS FOR 363 PLF (ASD, 0.6*W) ALONG TOP CHORD OF TRUSS (9,942 LBS TOTAL). ATTACH ROOF SHEATHING TO DRAG TRUSS WITH 10d NAILS @ 3" O.C. ALONG ENTIRE

(19) SEE MECHANICAL DRAWINGS FOR SIZE OF SELECTED RTU OPTION.

 $\langle 20 \rangle$ RTU LOCATION POINT.

LENGTH OF TRUSS.

 $\langle 21 \rangle$ SEE MECHANICAL DRAWINGS FOR SIZE OF RTU.

DRAG TRUSS AT INTERIOR SHEAR WALL. PROVIDE DOUBLE TRUSS. DESIGN DRAG TRUSS FOR 329 PLF (ASD, 0.6*W) ALONG TOP CHORD OF TRUSS (9,012 LBS TOTAL). ATTACH ROOF SHEATHING TO DRAG TRUSS WITH 10d NAILS @ 3" O.C. ALONG ENTIRE LENGTH OF TRUSS.

(2) 2x6 BLOCKING W/ U26-2 HANGERS EACH END AT 24" O.C. BELOW KICKERS AT HIGH PARAPET.

 $\langle 24 \rangle$ 2x BLOCKING AT BRACES. SEE 1 & 4/S4.1.

ROOF NAILING SCHEDULE D **ROOF FRAMING NOTES**

C

ROOF FRAMING KEYNOTES

08.09.22 | IFB

04.13.22

END. 80FT

DICKSON

2021088.52

315672

MARCH 2021

CONTRACT DATE:

BUILDING TYPE:

PLAN VERSION:

SITE NUMBER:

DRAWN BY.

STORE NUMBER:

TACO BELL

1551 West River Rd.


Elyria, OH

ENDEAVOR 2.0

ROOF FRAMING

PLAN

BRAND DESIGNER:

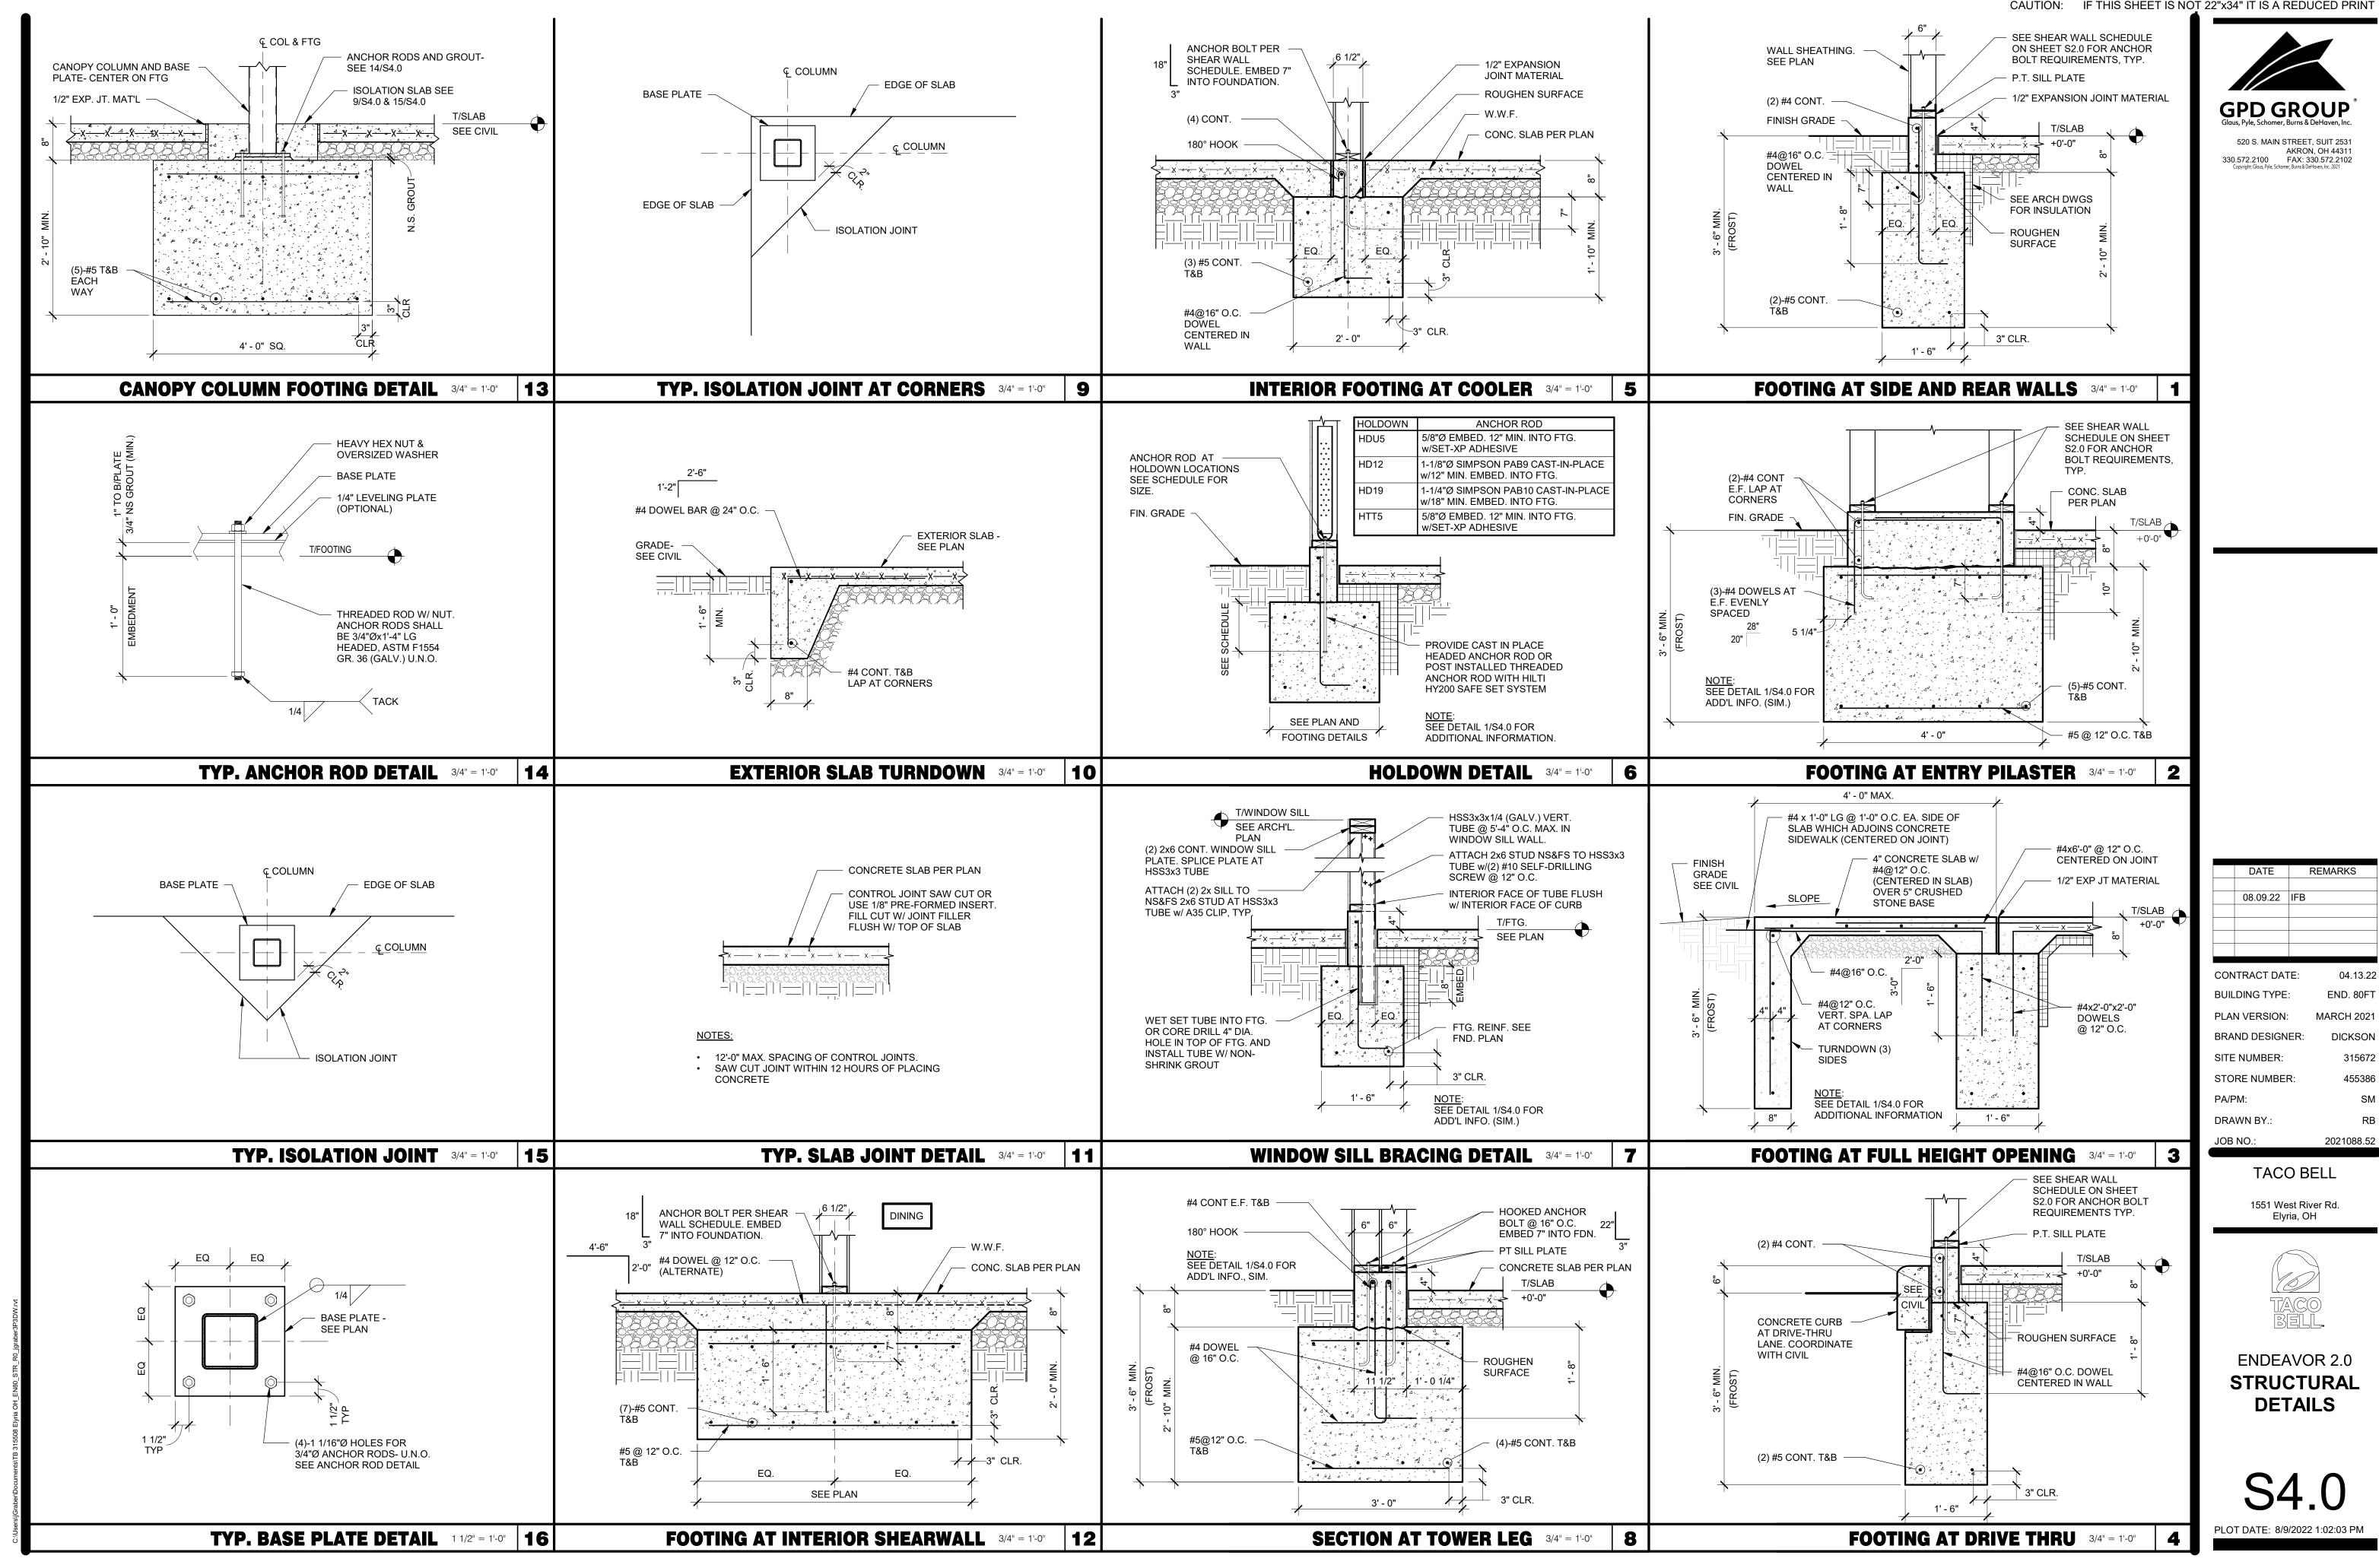


N.T.S. 13 BRIDGING LAP DETAIL AT OPEN CLG. N.T.S.

SIDE WALL AT PARAPET STUD 3/4" = 1'-0"

SIDE WALL AT TRUSS

PLATE LAP DETAIL 1" = 1'-0"

16 HANGING BULKHD. OR HOOD DETL.

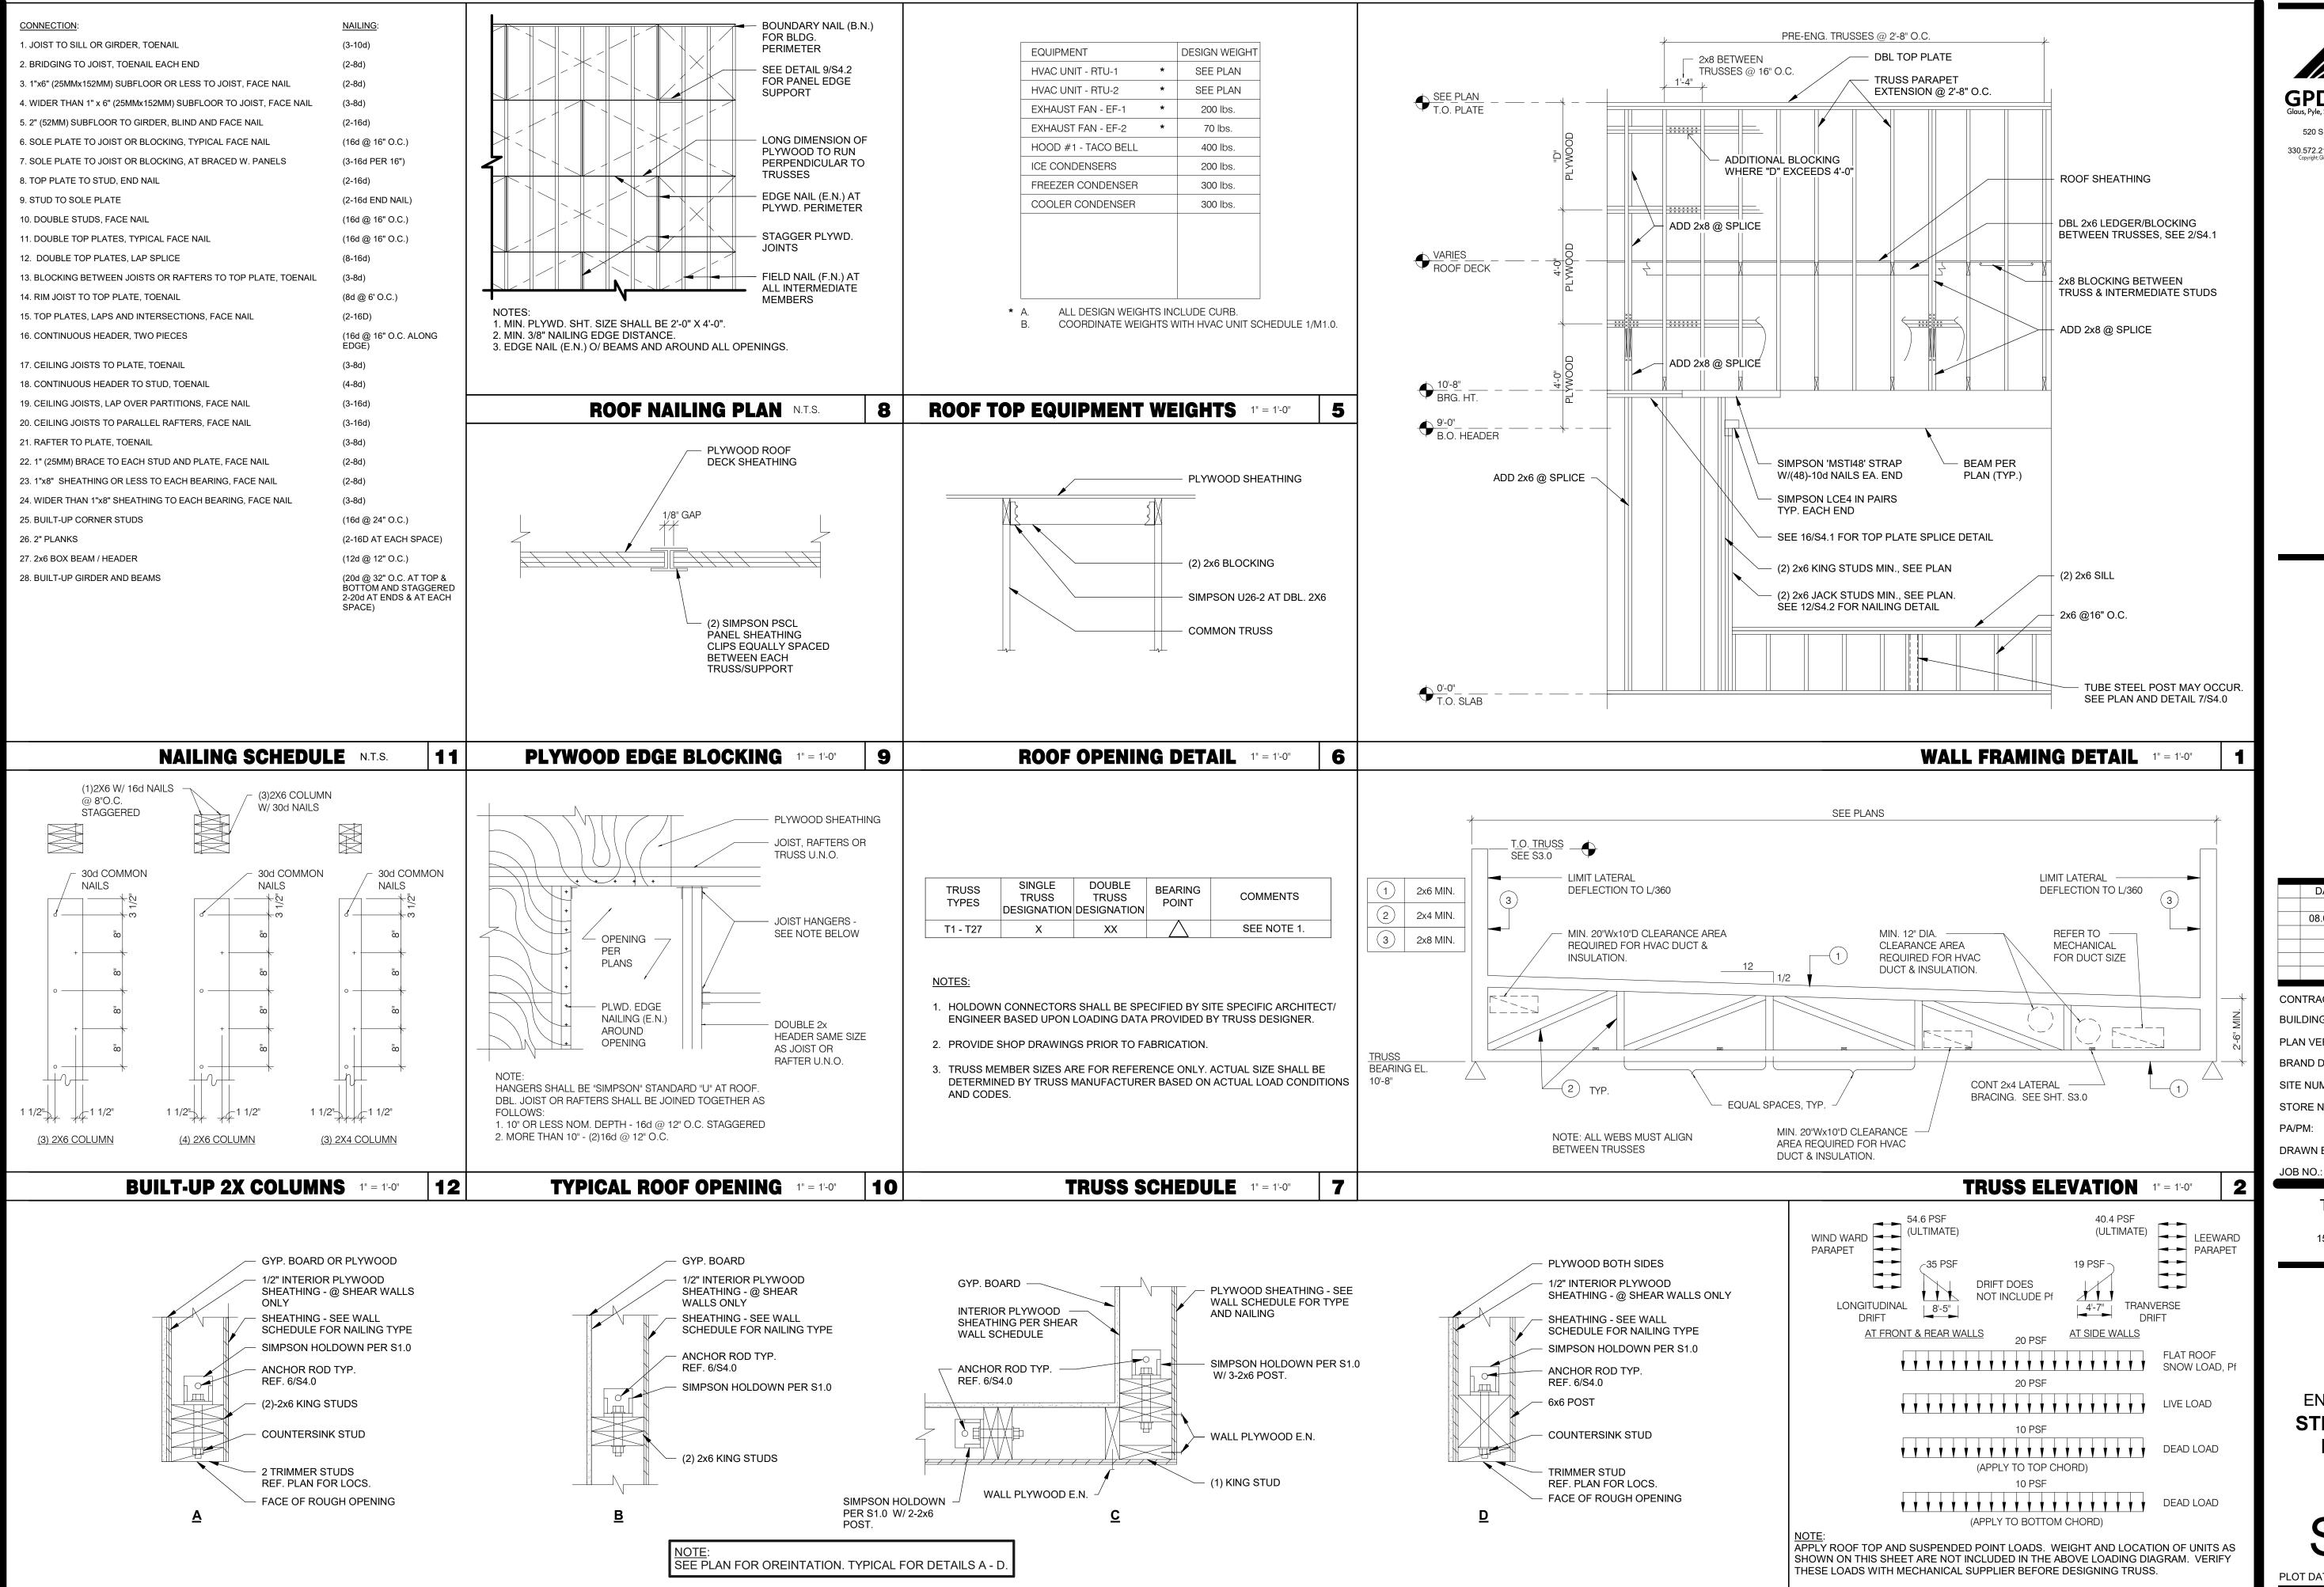

HOLDOWN DETAILS 1" = 1'-0"

4

GPD GROUP

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DATE REMARKS

08.09.22 IFB

CONTRACT DATE: 04.13.22
BUILDING TYPE: END. 80FT
PLAN VERSION: MARCH 2021
BRAND DESIGNER: DICKSON
SITE NUMBER: 315672
STORE NUMBER: 455386
PA/PM: SM
DRAWN BY.: RB

TACO BELL

2021088.52

1551 West River Rd.


Elyria, OH



STRUCTURAL DETAILS

S4.2PLOT DATE: 8/9/2022 1:02:07 PM

TRUSS LOAD DIAGRAMS

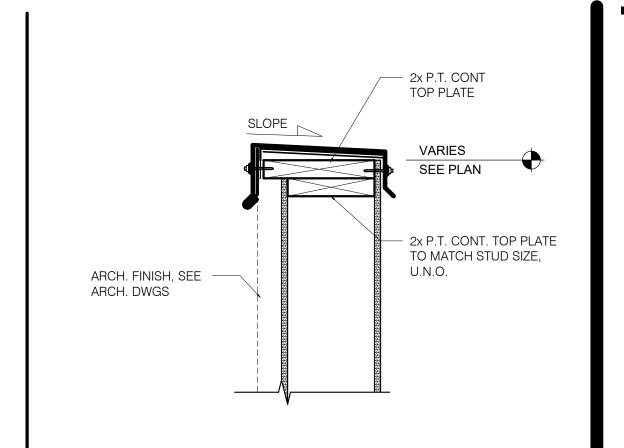




520 S. MAIN STREET, SUIT 2531 AKRON, OH 44311
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SIMPSON A34 T&B



TIE-ROD BLOCKING 3" = 1'-0"

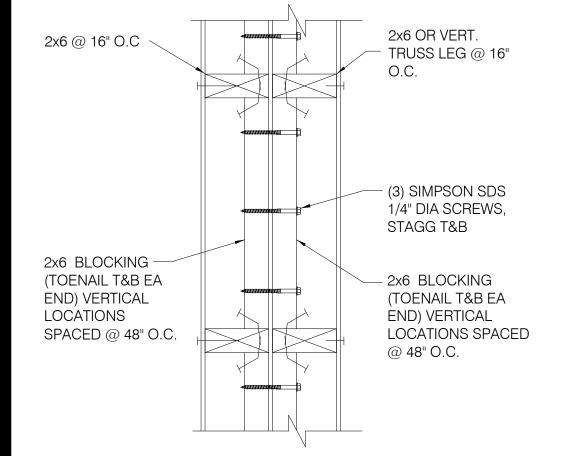BOLTS (SEE-

CANOPY (SEE -SCOPE OF WORK)

PIPE/SLEEVE — SEE ARCH.

SCOPE OF

WORK)

SIMPSON A34 FRAMING ANCHOR

(TOTAL OF 4)

3 - 2x10 BLOCKING

BRACING SPAN

- (2) - 2x6 STUDS EACH SIDE OF **BLOCKING WITH** 2- 12d NAILS INTO


EACH OF THE 2x10 **BLOCKING MEMBERS**

STUDS AS NEEDED

2x6 RIM BOARD


(TYP.)

WALL DETAIL (PLAN VIEW)

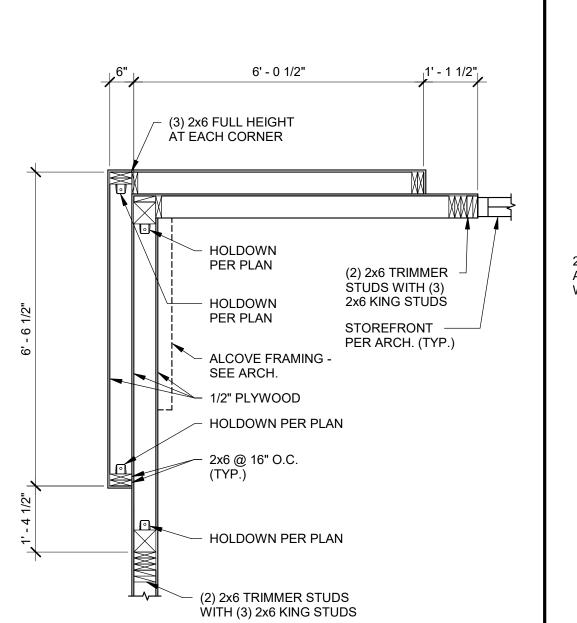

PLAN VIEW

FRONT TOWER FRAMING 1/2" = 1'-0"

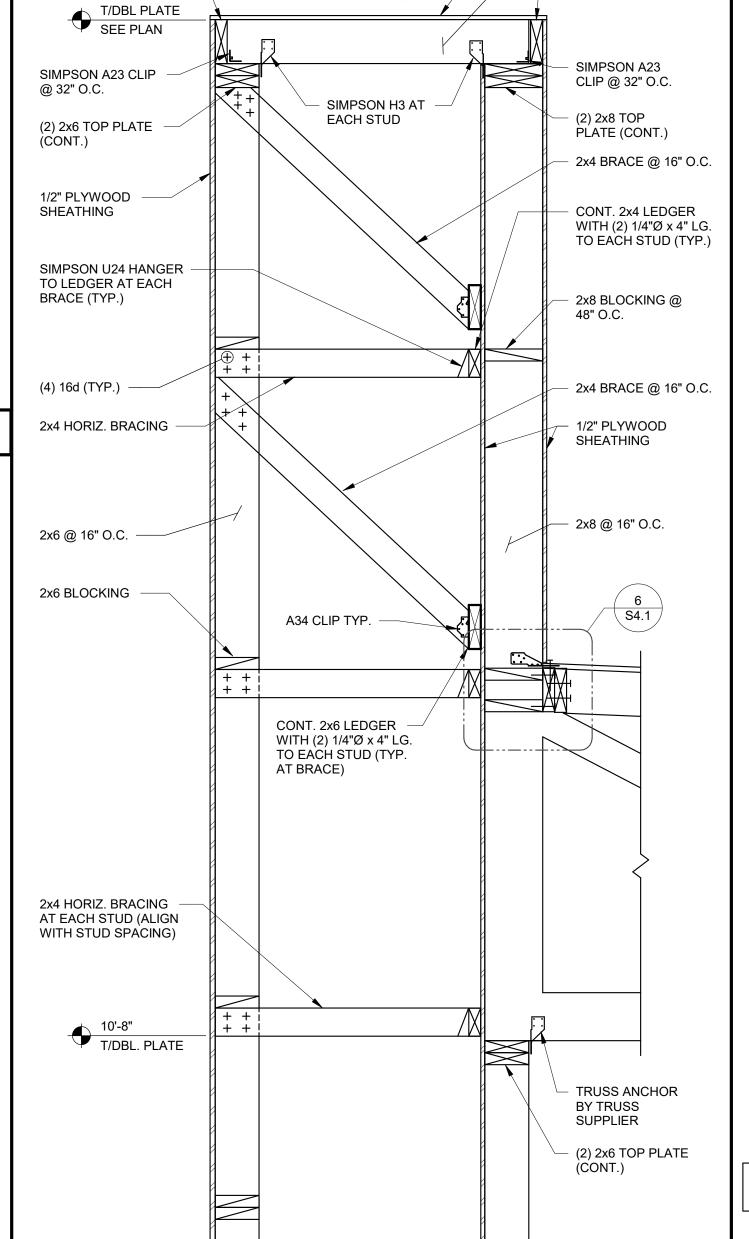

SECTION AT SIDE TOWER 1" = 1'-0"

SLOPE DOWN -


SEE ARCH.

1/2" PLYWOOD

- 2x6 @ 16" O.C.

- 2x6 RIM BOARD

(TYP.)

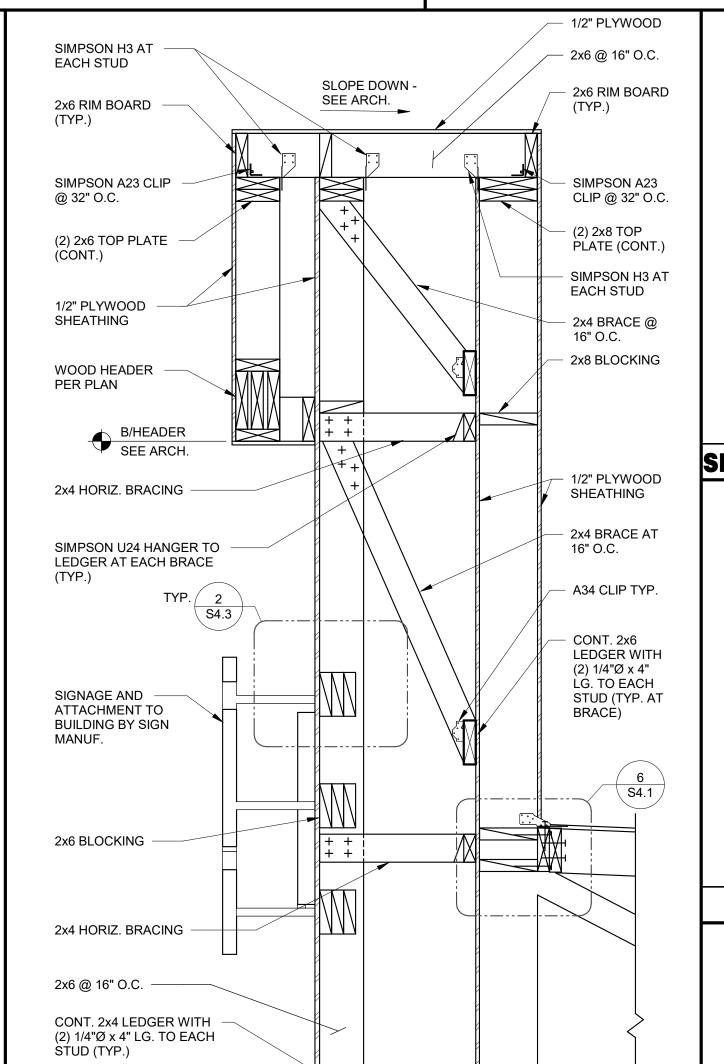

+ + |

SIDE ENTRY TOWER FRAMING 1" = 1'-0"

TRUSS ANCHOR

WOOD HEADER

6

BY TRUSS

SUPPLIER

PER PLAN

2x4 HORIZ. BRACING -

2x6 HORIZ. @ 16" O.C. -

CANOPY AND CANOPY


B/CANOPY SEE ARCH.

ATTACHMENT TO **BUILDING BY CANOPY**

MANUFACTURER

WOOD HEADER PER PLAN

12

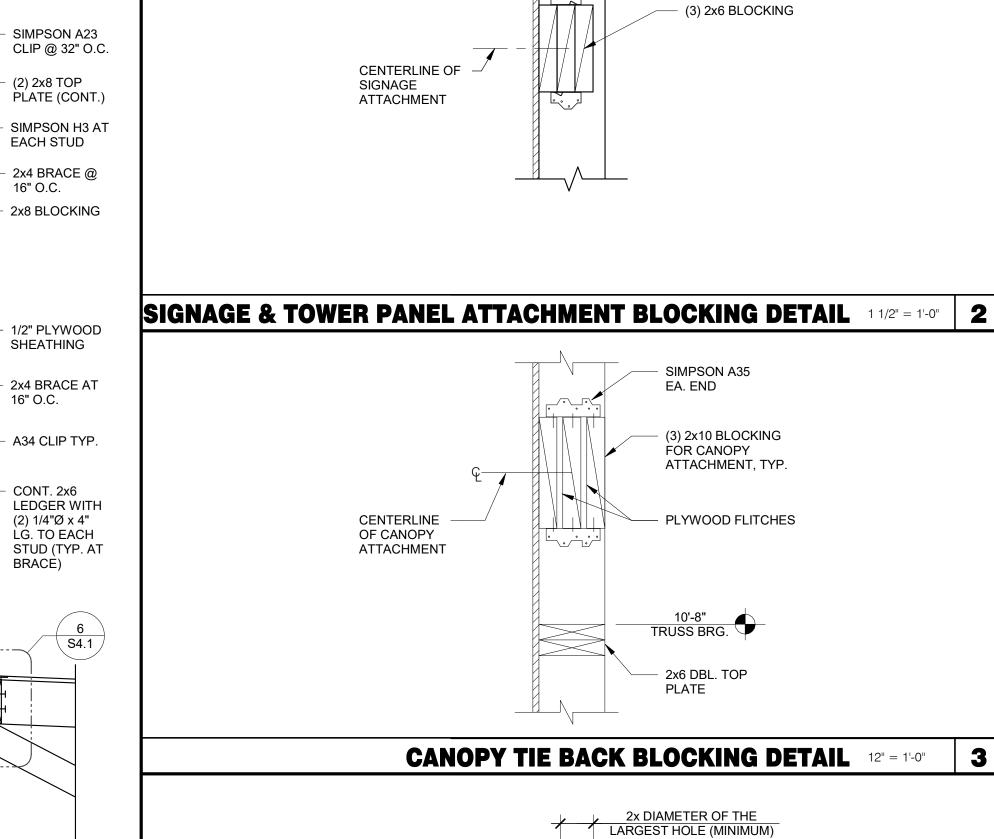

	- 1/3 DEPTH
PARALLAM PSL ALLOWED HOLE ZONE MIDDLE 1/3 SPAN	
NOTES:	V
ALLOWED HOLE SIZE SUITABLE FOR HEADERS A WITH UNIFORM LOADS ONLY.	AND BEAMS
ROUND HOLES ONLY.	
NO HOLES IN CANTILEVERS.	
NO HOLES IN HEADERS OR BEAMS ORIENTATED	FLATWISE.
HEADER OR BEAM DEPTH MAXIMUM ROUND H	OLE SIZE

O HOLES IN THE ABERCON BEAMOON CHIENTY TEB TEATWISE.								
EADER OR BEAM DEPTH	MAXIMUM ROUND HOLE SIZE							
3/8"	1"							
1/2"	1 3/4"							

EADER OR BEAM DEPTH	MAXIMUM ROUND HOLE SIZE	
3/8"	1"	
1/2"	1 3/4"	
1/4"-20"	2"	
	·	

PSL BEAM PENETRATION DETAIL 3/4" = 1'-0"

ENDEAVOR 2.0

STRUCTURAL

DETAILS

08.09.22 IFB

END. 80FT

MARCH 2021

2021088.52

CONTRACT DATE:

BUILDING TYPE:

PLAN VERSION:

SITE NUMBER:

DRAWN BY.:

STORE NUMBER:

TACO BELL

1551 West River Rd.


Elyria, OH

BRAND DESIGNER:

GPD GROUP

520 S. MAIN STREET, SUIT 2531

AKRON, OH 44311
330.572.2100 FAX: 330.572.2102
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COMPONENT AND CLADDING WIND LOAD SCHEDULE EFFECTIVE WIND AREA | CORNER (SQ. FT.) ZONE (PSF) ZONE (PSF) ZONE (PSF) ZONE (PSF) ZONE (PSF) <u>≤</u> 10 +16.0/-72.7 +16.0/-48.3 +16.0/-28.8 +28.8/-38.6 +28.8/-31.2 +16.0/-60.2 +16.0/-43.2 +16.0/-28.0 +27.4/-35.9 +27.4/-29.8 +16.0/-36.4 +16.0/-43.6 +16.0/-27.1 +25.7/-32.5 +25.7/-28.1 +16.0/-31.2 +16.0/-31.2 +24.4/-29.8 +16.0/-26.3 +24.4/-29.8 +16.0/-31.2 +16.0/-31.2 +16.0/-26.3 +24.4/-29.8 +24.4/-29.8

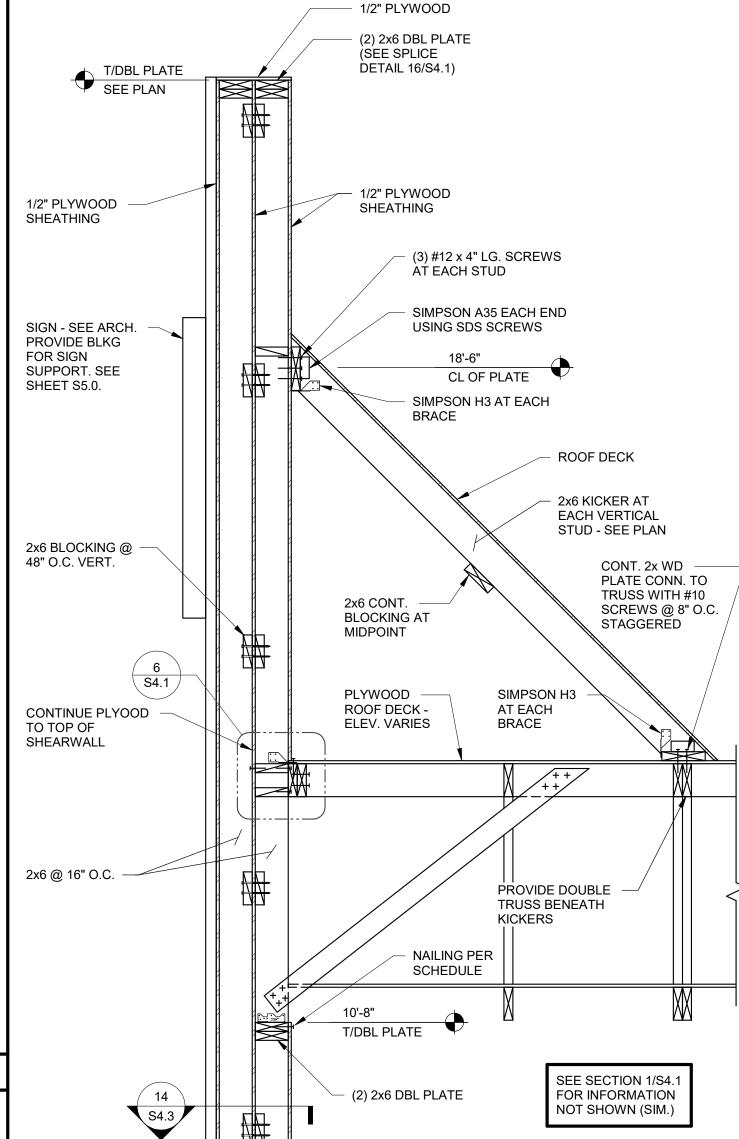1. PRESSURES SHOWN ARE ULTIMATE WIND PRESSURES. PLUS AND MINUS SIGNS SIGNIFY PRESSURES ACTING TOWARD AND AWAY FROM THE SURFACES, RESPECTIVELY.

WIND LOAD TABLE 12" = 1'-0" (4) ANCHOR RODS VERIFY LOCATION &
SIZE WITH LIGHT POLE MANUFACTURER NOTES:
1. VENDOR TO SUPPLY (2)-#4 TIES -ÌN TOP 5" CONTRACTOR WITH ANCHOR BOLT 3" CHAMFER TEMPLATE. 2. ANY BASE LOCATED WITHIN 1'-0" OF A PAVED SURFACE SHALL BE PAINTED WITH 2 COATS OF SAFETY YELLOW TRAFFIC RATED PAINT. GRADE HEAVY HEX -NUT (TYP.) TACK WELD TYP. _ (8) #5 VERT. BARS -(EQUALLY SPACED) #4 TIES AT 8" O.C. 2'-0" DIAMETER CONDUIT (18" MIN. RADIUS) 2'-0" DIAMETER

	FRONT TOWER SECTION 3/4" = 1'-0"
DRAG STRUT - ALIGN SIDE OF TRUSS w/DINING SIDE OF SHEAR WALL AT SIMILAR)	2x4 BRACE @ 48" O.C. WITH (4) 10d TO BLOCKING 2x6 BLOCKING @ 48" O.C. W/U26 HANGER EACH END. ALIGN W/BRACE.
LTP5 @ 12" O.C. FROM SIDE OF TRUSS TO SIDE OF DOUBLE TOP PLATE EDGE NAILING	H3 AT EACH BRACE TO DOUBLE TOP PLATE A35 ANGLE @ 12" O.C. FROM TRUSS TO DOUBLE TOP PLATE
NOTE: ATTACH 6x6 POST AT EACH END OF SHEAR WALL TO DRAG TRUSS USING SIMPSON CS18x1'-5" LG STRAP. PROVIDE (8)-10d NAILS INTO POST AND TRUSS BOTTOM CHORD (16 TOTAL)	2x6 CONT. DOUBLE TOP PLATE - NO SPLICES WALL SHEATHING (NS & FS) - SEE SHEARWALL SCHEDULE 2x6 STUDS @ 16" O.C.

08.09.22 IFB

CONTRACT DATE: 04.13.22 BUILDING TYPE: END. 80FT PLAN VERSION: MARCH 2021 **BRAND DESIGNER:** DICKSON SITE NUMBER: STORE NUMBER: PA/PM: DRAWN BY. 2021088.52

TACO BELL


1551 West River Rd.

Elyria, OH

ENDEAVOR 2.0 STRUCTURAL SECTIONS

PLOT DATE: 8/9/2022 1:02:09 PM

2

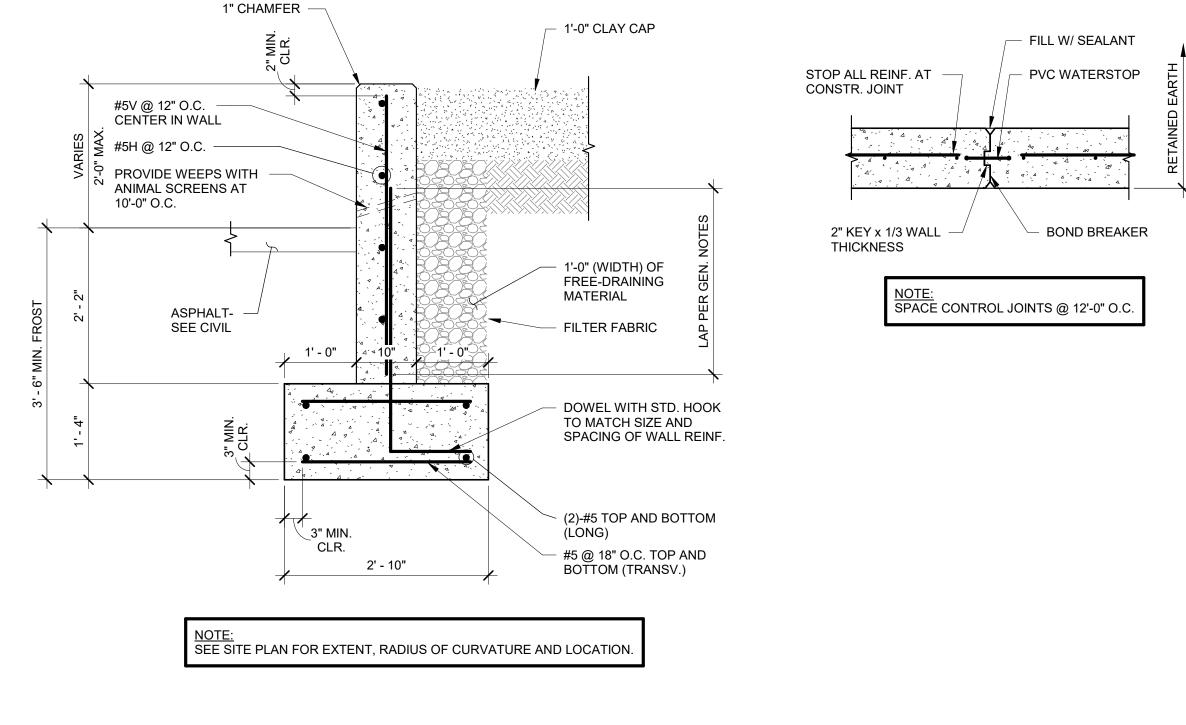

RETAINING WALL SYSTEM:

TOTAL UNIT WT. OF SOIL:

ACTIVE SOLI PRESSURE:

SURCHARGE LOADING

PASSIVE SOLI PRESSURE:

<u>RETAINING WALLS ON SITE.</u>

BE USED WITH THIS DETAIL.

DESIGN PARAMETERS BASED ON GEOTECHNICAL REPORT:

120 PCF

100 PSF

0.32

FOUNDATIONS HAVE BEEN DESIGNED IN ACCORDANCE WITH THE UNSATURATED

RECOMMENDATIONS CONTAINED IN THE GEOTECHNICAL REPORT. THE SUBGRADE AND SUBSURFACE DRAINAGE FOR BELOW GRADE WALLS SHALL BE FOLLOWED FOR THE

SEE C-121 FOR GRADING PLAN AND TOP OF WALL AND FINISHED GRADE ELEVATIONS TO

SEE FOUNDATION NOTES ON \$1.0 FOR CONCRETE SPECIFICATIONS (FOUNDATIONS).

40 PSF/FT.

172 PSF/FT.

NET ALLOWABLE SOIL BEARING PRESSURE:


COEFFICIENT OF SLIDING FRICTION (f)

RETAINING WALL DETAIL 3/4" = 1'-0"

LIGHT POLE FOUNDATION DETAIL 3/4" = 1'-0"

3

INTERIOR SHEAR WALL 3/4" = 1'-0"

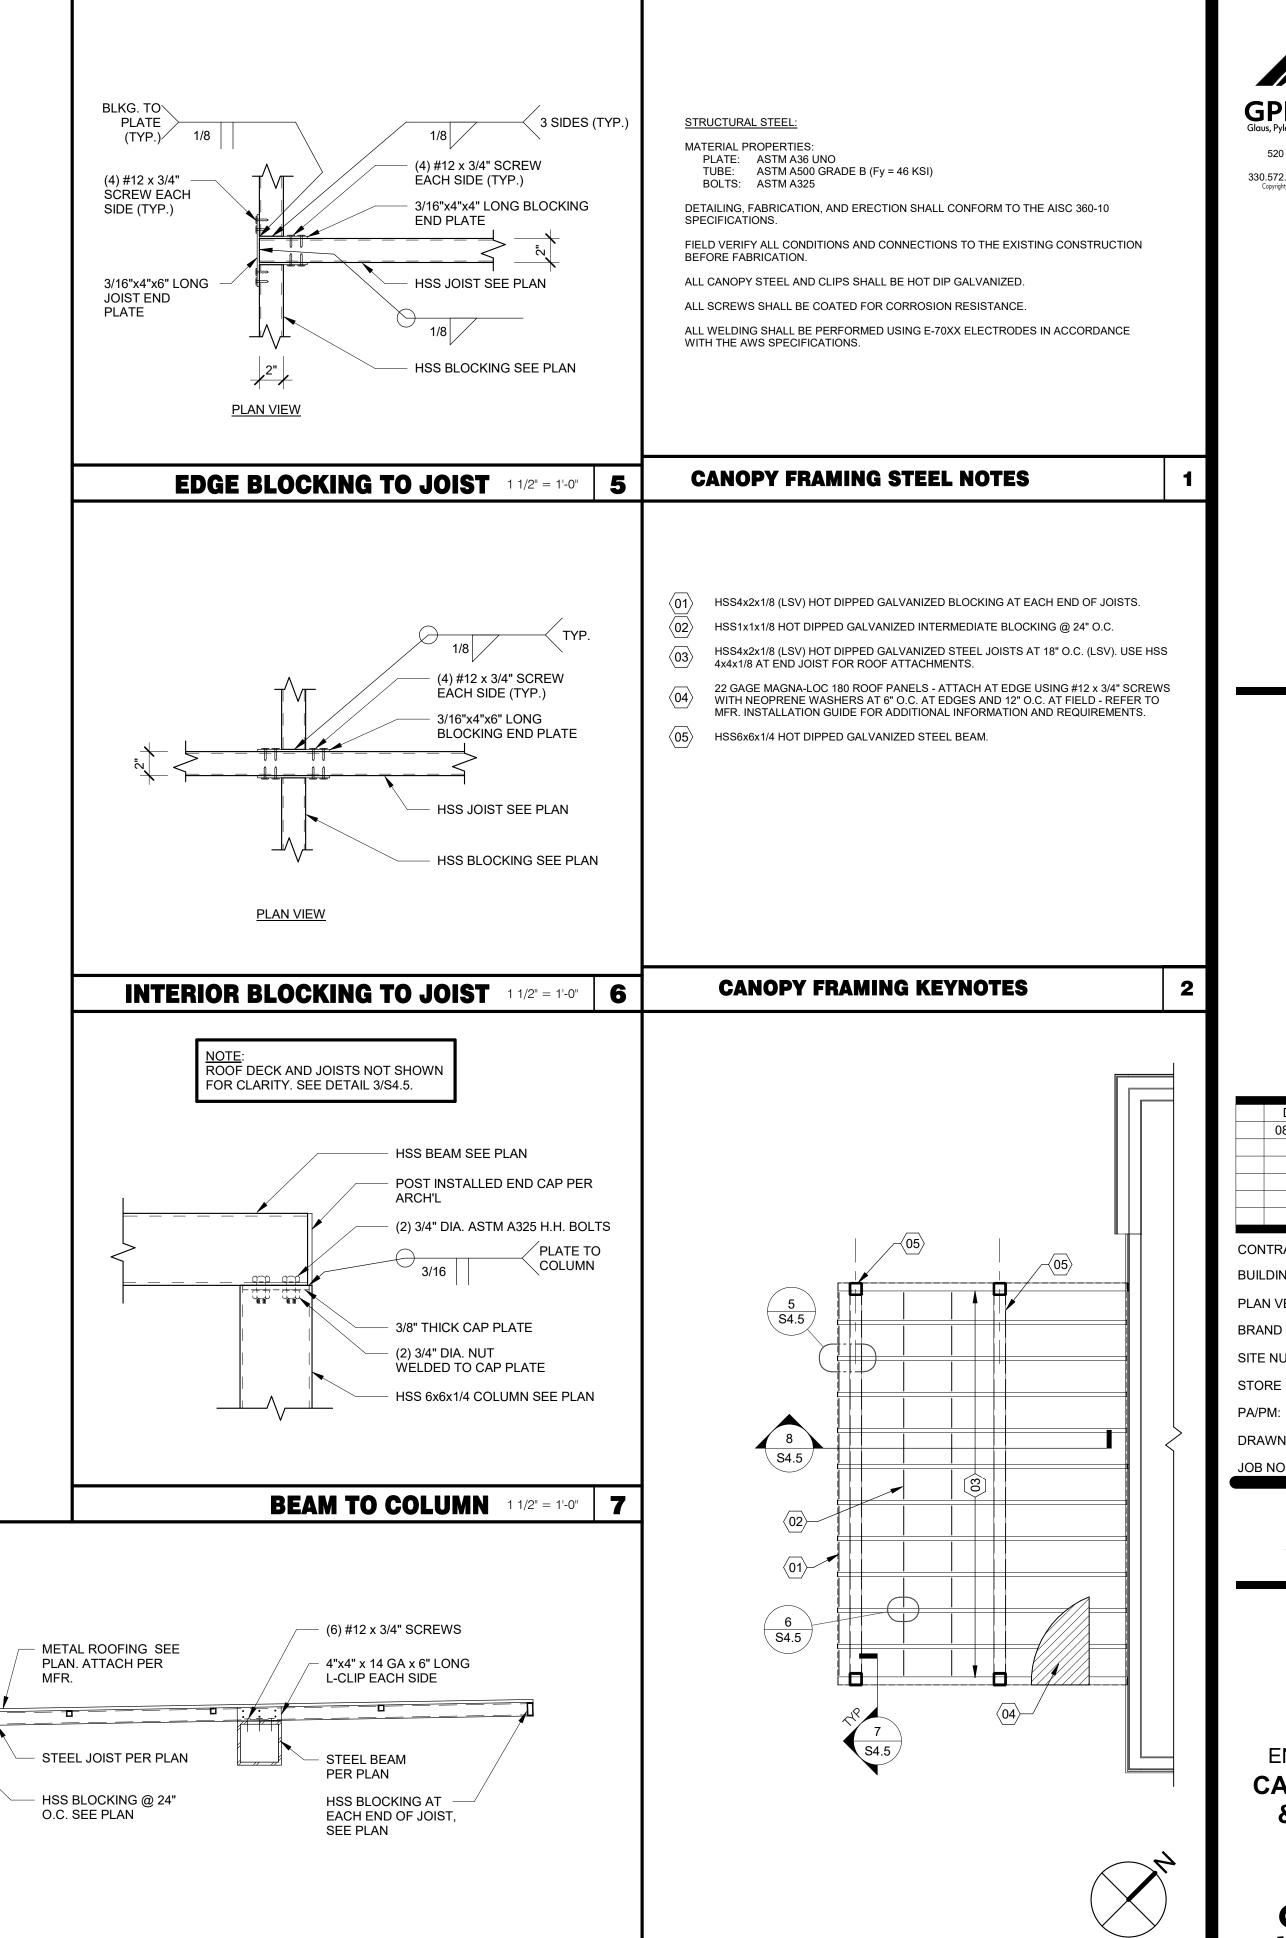

CANOPY DETAIL 3/4" = 1'-0"

8

CANOPY ROOF FRAMING 1/4" = 1'-0" 3

1/2" PER FOOT SLOPE

DRIP EDGE -PER ARCH'L GPD GROUP

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DATE REMARKS
08.09.22 IFB

CONTRACT DATE: 04.13.22
BUILDING TYPE: END. 80FT
PLAN VERSION: MARCH 2021
BRAND DESIGNER: DICKSON
SITE NUMBER: 315672
STORE NUMBER: 455386
PA/PM: SM
DRAWN BY.: RB
JOB NO.: 2021088.52

TACO BELL

1551 West River Rd. Elyria, OH





ENDEAVOR 2.0
CANOPY PLAN
& DETAILS


S4.5

GPD GROUP

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EAST ELEVATION 1/4" = 1'-0"

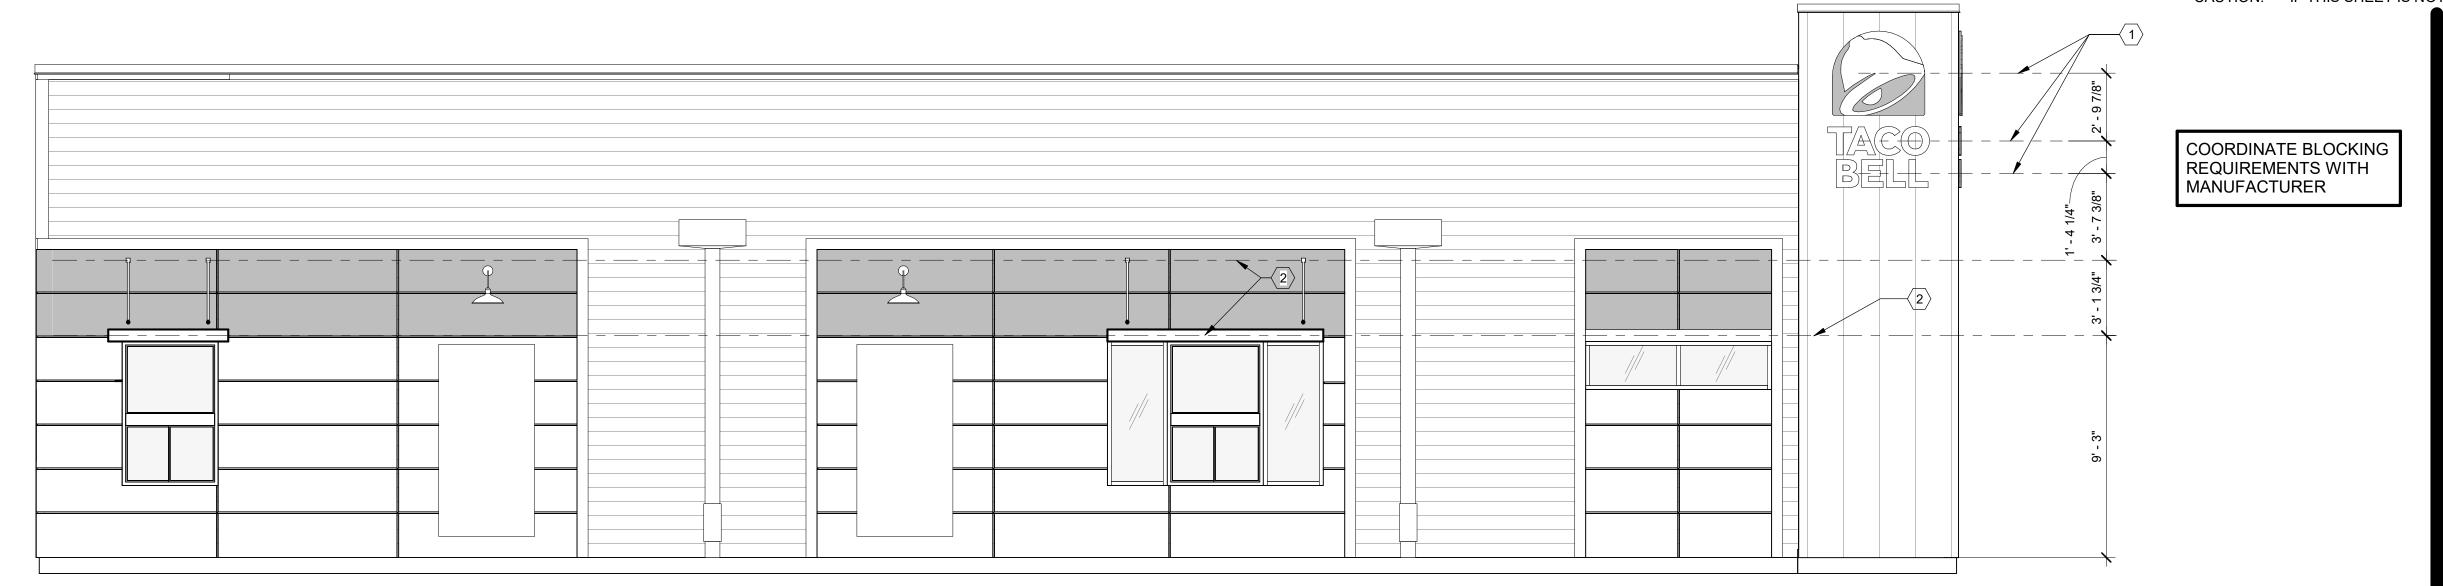1 SOLID BLOCKING FOR FASTENERS	S AS REQUIRED FOR SIGN MOUNTING.

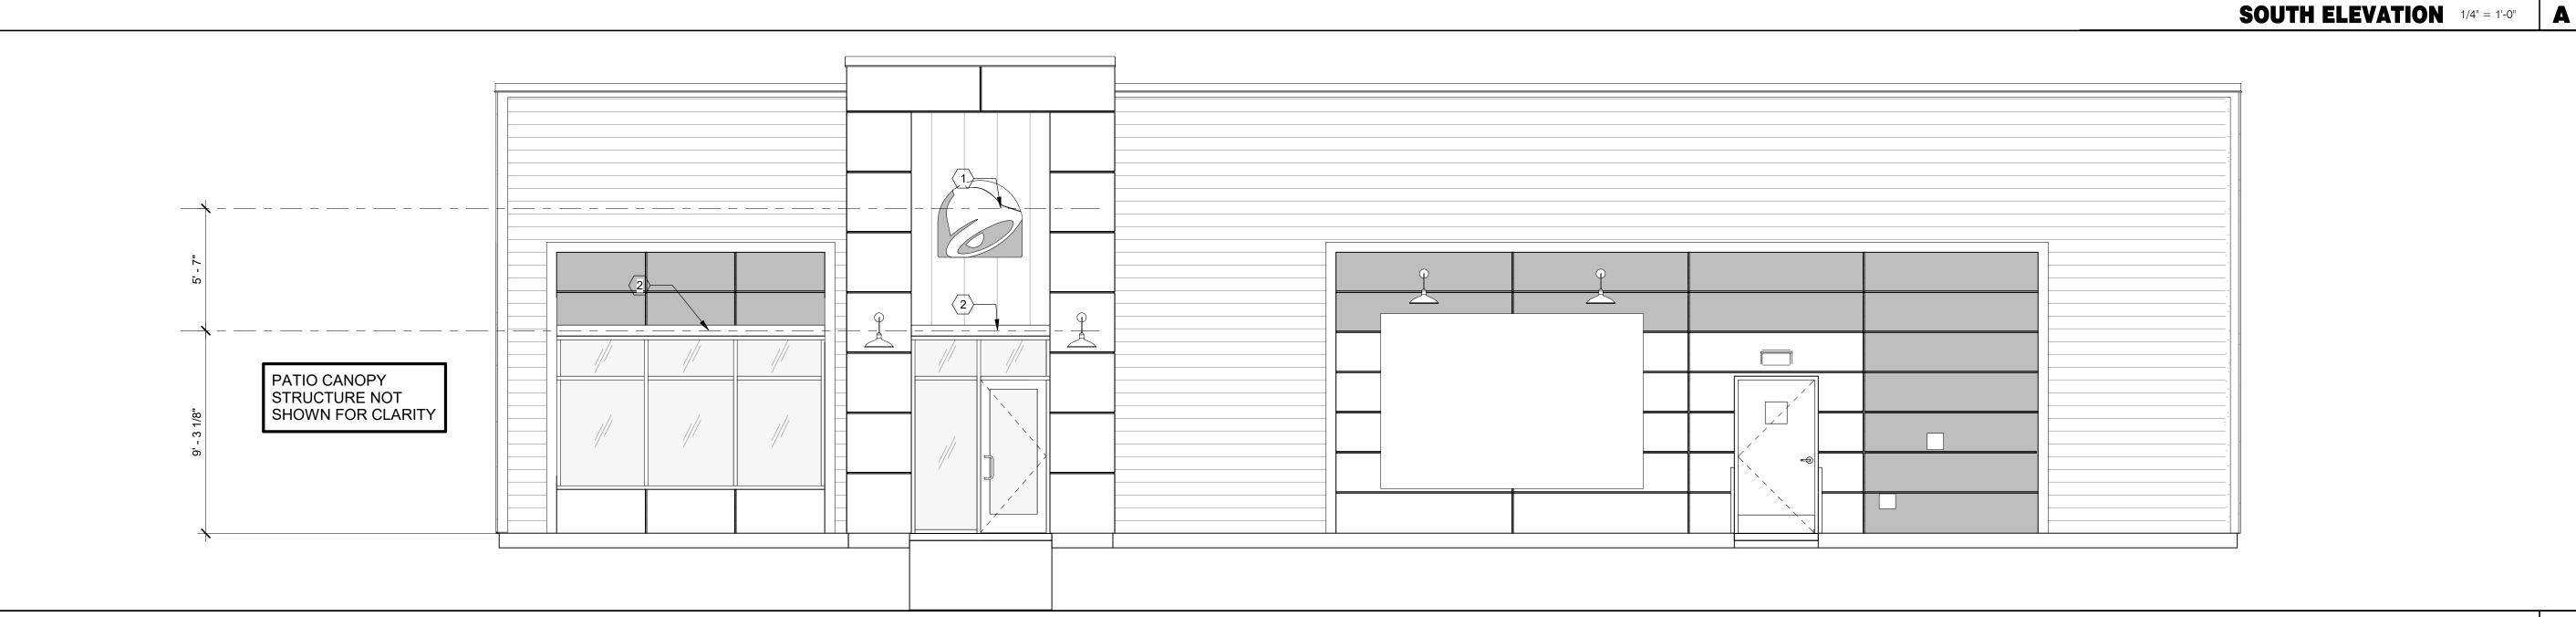2 PROVIDE BLOCKING FOR CANOPY. SEE DETAILS 3/S4.3 AND 13/S4.3.

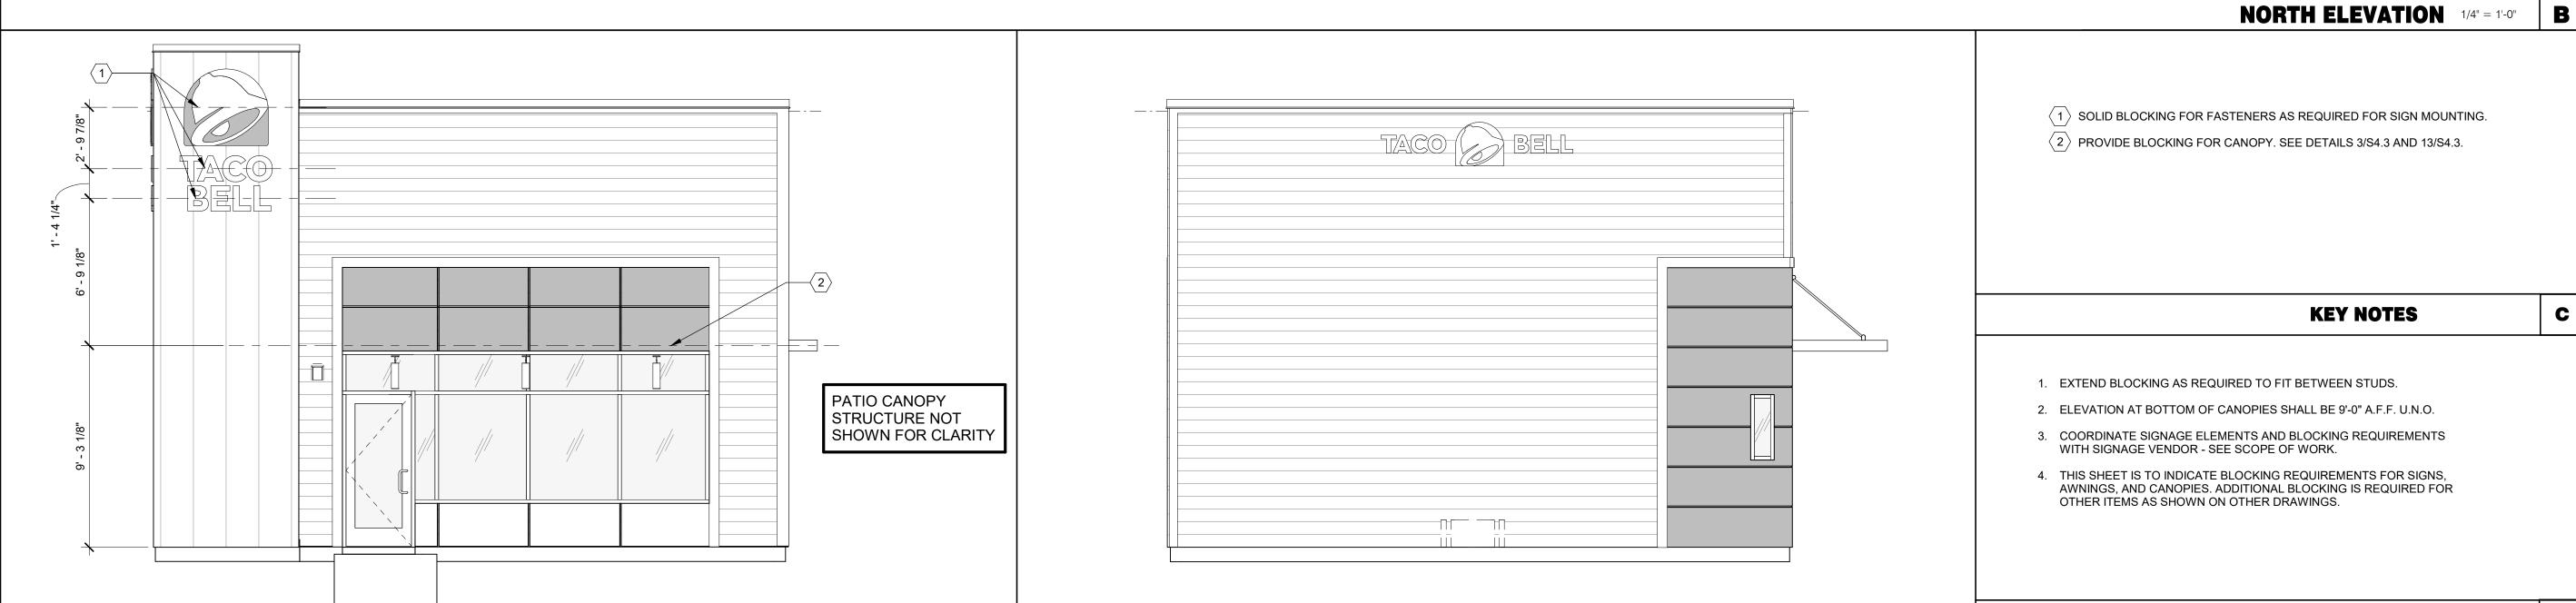C

D

WEST ELEVATION 1/4" = 1'-0"

- 2. ELEVATION AT BOTTOM OF CANOPIES SHALL BE 9'-0" A.F.F. U.N.O.

KEY NOTES

GENERAL NOTES

- COORDINATE SIGNAGE ELEMENTS AND BLOCKING REQUIREMENTS WITH SIGNAGE VENDOR SEE SCOPE OF WORK.
- THIS SHEET IS TO INDICATE BLOCKING REQUIREMENTS FOR SIGNS, AWNINGS, AND CANOPIES. ADDITIONAL BLOCKING IS REQUIRED FOR OTHER ITEMS AS SHOWN ON OTHER DRAWINGS.

1551 West River l Elyria, OH

TACO BELL

08.09.22 IFB

END. 80FT

2021088.52

MARCH 2021

CONTRACT DATE:

BUILDING TYPE:

PLAN VERSION:

SITE NUMBER:

PA/PM:

DRAWN BY.:

STORE NUMBER:

BRAND DESIGNER:

ENDEAVOR 2.0 CANOPY/AWNING

BLOCKING ELEVATIONS

GENERAL:

- LOCATE, CUT AND FRAME ROOF OPENINGS AS SHOWN FOR ALL HVAC EQUIPMENT AND EXHAUST FANS.
- IT IS VERY IMPORTANT THAT ACCURATE MEASUREMENTS ARE USED WHEN LOCATING EXHAUST FAN ROOF OPENINGS TO ENSURE THAT NO ADDITIONAL OFF-SETS ARE REQUIRED IN THE EXHAUST DUCTWORK. COORDINATE ROOF OPENINGS WITH
- PROVIDE FRAMING REQUIRED FOR DIFFUSER INSTALLATION IN HARD CEILING.

HVAC:

- INSTALLATION SHALL CONFORM TO MECHANICAL AND ENERGY CODES FOR NEW NONRESIDENTIAL BUILDINGS.
- ALL WORK AND MATERIALS SHALL COMPLY WITH GOVERNING CODES, SAFETY ORDERS AND REGULATIONS.
- OBTAIN AND PAY FOR ALL NECESSARY PERMITS, FEES AND INSPECTIONS REQUIRED BY GOVERNING AUTHORITIES.
- E.C. SHALL PROVIDE CONDUIT FOR LINE AND LOW VOLTAGE WIRING, LINE VOLTAGE WIRING SWITCHES, AND FINAL CONNECTIONS. REFER TO SHEETS E3.0 ELECTRICAL POWER PLAN, SHEET E3.2-ELECTRICAL POWER ROOF PLAN, E6.0 - ELECTRICAL DETAILS - TBCCB, E6.1 - ELECTRICAL DETAILS - TBCCB, E7.0 - ELECTRICAL DETAILS, E7.1 - ELECTRICAL DETAILS.
- PROVIDE 24V CONTROL WIRING AND FINAL CONNECTIONS. EQUIPMENT THAT IS SUBSTITUTED SHALL FIT IN SPACE PROVIDED WITH ADEQUATE ROOM FOR SERVICING. INCLUDING SUBSTITUTE EQUIPMENT NAMED IN SPECIFICATIONS. SUBMIT A 1/4" SCALE DRAWING OF ALL EQUIPMENT SUBSTITUTED FOR APPROVAL PRIOR TO INSTALLATION, INCLUDING, BUT NOT LIMITED TO, STRUCTURAL AND ARCHITECTURAL IMPACT, CLEARANCE REQUIREMENTS AND UTILITY REQUIREMENTS. REFER TO ELECTRICAL DRAWINGS SHEETS E6.1 AND E7.1 FOR ADDITIONAL LOW VOLTAGE WIRING AND CONNECTIONS.
- PROVIDE ALL REFRIGERANT LINES FROM ICE MACHINE TO CONDENSER ON ROOF AND CHARGE LINES PER EQUIPMENT MANUFACTURER'S RECOMMENDATIONS.
- HVAC UNITS SHALL BE MOUNTED LEVEL ON ROOF CURBS.
- SUPPLY / RETURN DUCTWORK SHALL BE EXTERNALLY INSULATED. ALL RETURN AND SUPPLY DUCT RISERS SHALL BE LINED (NOT WRAPPED).
- SUPPLY / RETURN DUCTS SHALL BE RIGID (EXCEPT AS NOTED/INDICATED AS RIGID ON THE DUCT PLAN), WITH THE EXCEPTION OF THE LAST 5'-0", WHICH MAY UTILIZE FLEXIBLE DUCT. ALL EXHAUST DUCT SHALL BE RIGID. ROOFTOP UNITS SHALL BE ORDERED WITH FACTORY SUPPLIED AND INSTALLED RETURN SMOKE DETECTORS. WHEN REQUIRED BY MANUFACTURER, SAMPLE TUBE SHALL BE LOCATED PER FIELD INSTALLATION
- INSTRUCTIONS. DETECTOR SHALL DEACTIVATE ROOFTOP UNIT UPON SENSING SMOKE. INCLUDE SUPPLY SMOKE DETECTOR ONLY IF REQUIRED BY LOCAL CODE. HOOD EXHAUST DUCTS SHALL BE RIGID 16 GA MINIMUM, WELDED DUCT. GRIND ALL WELDS SMOOTH. PROVIDE 3M FIRE BARRIER DUCT WRAP FOR ALL HOOD EXHAUST DUCTS. PROVIDE TRANSITION AT TERMINATION OF
- TYPE 1 EXHAUST DUCT TO TOP OF FAN BASE. TRANSITION SHALL BE CENTERED AND HAVE MINIMUM OF 1" PER FOOT SLOPE. BRANCH DUCTS FEEDING INDIVIDUAL DIFFUSERS SHALL HAVE DAMPERS AT BRANCH FEEDER. DAMPER SHALL BE MINIMUM 26 GAUGE LOCATED IN DEDICATED SLEEVE WITH AXLE AND LOCKING QUADRANT. DAMPERS
- SHALL NOT BE INSTALLED IN STARTER COLLARS. ALL DAMPER HANDLES SHALL HAVE A FLAG ON THE HANDLE FOR LOCATION PURPOSES. OUTSIDE AIR INTAKES SHALL BE A MINIMUM OF 10'-0" FROM EXHAUST FANS AND VENTS.
- SEE M1.0 AND SCOPE OF WORK FOR DESCRIPTION OF HVAC PACKAGE TO BE PURCHASED THROUGH YUM! BRANDS NATIONAL CONTRACT.
- CONTRACTOR IS RESPONSIBLE FOR PROVIDING HVAC TEST & BALANCE REQUIRED FOR LOCAL AUTHORITY HAVING JURISDICTION, CERTIFICATE OF OCCUPANCY, BUILDING FINAL, ETC.
- FINAL HVAC SYSTEM TESTING AND BALANCING, AND COMMISSIONING SHALL BE PERFORMED BY INDEPENDENT AGENT. INDEPENDENT AGENT CONTRACTED DIRECTLY BY THE OWNER IS SCHEDULED AND PAID FOR (FRANCHISEE STORES) BY GENERAL CONTRACTOR (CORPORATE STORES ARE DIRECT BILLED TO TACO BELL)". CONTRACTOR SHALL CERTIFY COMPLETION OF INSTALLATION, START UP AND PRE-COMMISSIONING CHECKLIST SHOWN ON SHEET SW2.0 BEFORE SCHEDULING OWNER'S INDEPENDENT AGENT. A RE-TEST IS MANDATORY FOR A FALSE START (I.E. NO POWER UPON AGENT'S ARRIVAL, EQUIPMENT NOT WIRED, COMPLETED, STARTED, ETC.) AND SHALL BE A COST INCURRED BY THE G.C. IN THE EVENT A SYSTEM / STORE RECEIVES A GRADE OF 5 OR BELOW AS A RESULT OF THE HVAC SYSTEM PERFORMANCE OR OPERATIONAL DEFICIENCIES, OWNER WILL REQUEST A RE-TEST AND THE COST SHALL BE INCURRED BY THE GENERAL CONTRACTOR.

INDEPENDENT AGENTS:

- Air Care Experts TAB@ACE-IAQ.COM
- 949 770-2222
- WIRE ALL SMOKE DETECTORS IN RTU TO ITS RESPECTIVE REMOTE ANNUCIATOR/RESET SWITCH. INSTALL "SYSTEM SENSOR" MODEL RTS2AOS. MOUNT NEXT TO THERMOSTATS @ 48" A.F.F. INSTALL PER MANUFACTURER
- REFERENCE RTU TO TBCCB CONNECTIONS PER E6.1. RTU MANUFACTURER FURNISHED THERMOSTATS SHALL BE CAPABLE OF RECIEVING AN EXTERNAL "OCCUPIED" SIGNAL
- MECHANICAL CONTRACTOR IS RESPONSIBLE FOR LOW VOLTAGE CONNECTIONS.
- REFERENCE RTU TO TBANS CONNECTIONS PER E7.1. MECHANICAL CONTRACTOR IS RESPONSIBLE FOR LOW VOLTAGE CONNECTIONS.
- LOW VOLTAGE CONNECTIONS TO SMOKE DETECTORS, REMOTE ANNUCIATORS AND RESETS, HUMIDISTATS, THERMOSTATS, REMOTE SENSORS, TBCCB AND TBANS REQUIRE VISUAL INSTALLATION VERIFICATION CERTIFICATE. CONTACT CERTIFY@ACE-BCX.COM OR 949 770 2222 FOR CERTIFICATE. SEE SHEET SW2.0 CERTIFICATE

MECHANICAL NOTES

REFER TO SCOPE OF WORK IN DIV 23

BALANCE & COMMISSIONING

THE GC.

SPECIFICATION FOR HVAC FOR TEST &

BY THE OWNER AND COORDINATED BY

REQUIREMENTS WHICH WILL BE SUPPLIED

SYMBOL &	ABBREV.	DESCRIPTION	SYMBOL & ABBREV.	DESCRIPTION
	SA/SUP	SUPPLY AIR (RISE/DROP)	A/C, AC	AIR CONDITIONING
	RA/RET	RETURN AIR DUCT (RISE/DROP)	A.F.F.	ABOVE FINISHED FLOOR
	EA/EXH	EXHAUST AIR DUCT (RISE/DROP)	BDD	BACK DRAFT DAMPER
→	CD/SR	CEILING DIFFUSER/SUPPLY REGISTER	СВ	CIRCUIT BREAKER
Y	00/011	(ARROWHEAD REPRESENTS NUMBER OF THROW)	CLG.	CEILING
	RR/RG	RETURN REGISTER/GRILLE	CONN.	CONNECT/CONNECTION
	ER/EG	EXHAUST REGISTER/GRILLE	CONT.	CONTINUATION
			CFM	CUBIC FEET PER MINUTE
	FLEX	FLEXIBLE DUCT (14'-0" MAXIMUM) ROUND DUCT ELBOW	DISC.	DISCONNECT
		ROUND DOCT ELBOW	EA	EXHAUST AIR
		ROUND DUCTWORK	EF	EXHAUST FAN
		ROUND DOCTWORK	(E)	EXISTING
	MCD	MANUAL VOLUME DAMPER	GA.	GAGE/GAUGE
	IVICD	DUCT TRANSITION (RECTANGULAR TO ROUND)	GC	GENERAL CONTRACTOR
		DUCT TRANSITION (RECTANGULAR TO ROUND)	HVAC	HEATING, VENTILATING, AND AIR CONDITIONING
T	TOTAT	DDOODAMMADI E THEDMOOTAT DDOMDED WITH HIVAO DAOMAGE	MFR.	MANUFACTURER
(TS)	T-STAT	PROGRAMMABLE THERMOSTAT, PROVIDED WITH HVAC PACKAGE	MECH.	MECHANICAL
(H)		THERMOSTAT SENSOR (REMOTE), PROVIDED WITH HVAC PACKAGE	OA	OUTSIDE AIR
SD		HUMIDITY SENSOR (REMOTE), PROVIDED WITH HVAC PACKAGE	OBD	OPPOSED BLADE DAMPER
	<u> </u>	SMOKE DETECTOR, PROVIDED WITH HVAC PACKAGE, MOUNTED IN UNIT	RA	RETURN AIR
— D —	D	CONDENSATE DRAIN	SA	SUPPLY AIR
Ø	DIA.	DIAMETER	S/S	STAINLESS STEEL
			TYP.	TYPICAL
(0000 X-X)		MECHANICAL EQUIPMENT DESIGNATION		
R	RESET	SMOKE DETECTOR RESET		

MECHANICAL SYMBOLS

CAUTION: IF THIS SHEET IS NOT 22"x34" IT IS A REDUCED PRINT

				FAI	N DATA			CC	OOLING CAPACI	ΓΥ	F	HEATING CA	APACITY		ELI	ECTRICAL	DATA			
									MIN CAP											
		AREA	SUPPLY	MIN. OA				NOMINAL	(MBH)			OUTPUT	HEATING		VOLTS/			WEIGHT		
	MARK	SERVED	CFM	CFM	ESP	HP	RPM	TONS	TOT/SEN	MIN EER	INPUT (MBH)	(MBH)	STAGES	AFUE %	PH	MCA (A)	MOCP (A)	(LBS.)	MODEL	NOTES
EEN	RTU-1	DINING	3000	675	1.0	2	931	7.5	92.2/64.5	12.5	180	144	2	80	208/3	42	50	1450	LGH092H4BM	1,2,3,4,5,6,7,8,9,10,11,12,13,
	RTU-2	KITCHEN	5000	1125	1.0	5	1135	12.5	152.8/106.9	10.8	180	144	2	80	208/3	71	90	1500	LGH150H4BM	1,2,3,4,5,6,7,8,9,10,11,12,13,

SCHEDULE NOTES

1. LISTED CAPACITY IS THE UNIT'S NET COOLING CAPACITY AT THE FOLLOWING CONDITIONS: RTU-1 - 80.8°F DB / 68.5F WB EAT AND 95°F AMBIENT / RTU-2 - 79.6°F DB / 67.7°F WB EAT AND 95°F AMBIENT. OUTDOOR DESIGN CONDITION, SUMMER 95°F & 73°F WB, WINTER 0°F. THERMOSTAT SHALL BE PROGRAMMED FOR 73°F IN SUMMER AND 68°F IN WINTER WITH 2°F ADJ. FUNCTION UP OR DOWN. THE UNOCCUPIED TEMP SHALL BE SET TO THE STORE SCHEDULE AND 60°F MINIMUM. SPECIFIED UNITS INCLUDE MINIMUM 2 STAGE COOLING, LOW AMBIENT CONTROL TO 0 DEG. F AND THROUGH THE ROOF CURB CURB GAS AND POWER CONNECTIONS..

2. HINGED ACCESS DOORS (FACTORY PROVIDED) 3. 2 INCH MERV 8 FILTER (FACTORY PROVIDED).

4. SINGLE ENTHALPY ECONOMIZER/W HOOD (FACTORY PROVIDED).

HIGH PERF ECONOMIZER (FACTORY PROVIDED)

STANDARD STATIC POWER RELIEF/W HOOD (FACTORY PROVIDED) UNIT MOUNTED DISCONNECT SWITCH (FACTORY PROVIDED).

8. RETURN AIR SMOKE DETECTOR (FACTORY PROVIDED).

9. PHASE MONITOR (FACTORY PROVIDED).

10. CONSTANT AIR VOLUME (FACTORY PROVIDED).

11. 14" ROOF CURB (FIELD INSTALLED). 12. COMFORT SENSE 7500 THERMOSTAT (FIELD INSTALLED).

13. GFCI (FIELD WIRED, FACTORY INSTALLED).

14. PROVIDE HOT GAS REHEAT. HUMIDITY SENSOR TO BE MOUNTED IN THE RETURN AIR AT THE UNIT

HVAC UNIT SCHEDULE

		FAN DATA								
REEN	Mark	CFM	ESP	RPM	HP	VOLTS/PH	DRIVE TYPE	MANUFACTURER	MODEL	NOTES
	EF-1	1050	0.9	1344	1/2	120/1	DIRECT	STRATOVENT	#SVDU50HFA	1,3,5,6,7,8,10
	EF-2	570	0.375	1025	1/4	120/1	DIRECT	STRATOVENT	#SVDR30HFA	2,4,7,8,9,10,11

SCHEDULE NOTES:

- UL 762 LISTED (GREASE) UL 705 LISTED (HEAT OR STEAM)
- FLAT ROOF CURB, 19.5" X 19.5" X 26"H, VENTED
- FLAT ROOF CURB, 19.5" X 19.5" X 14"H
- GREASE CUP WITH DRAIN FACTORY ATTACHED HINGES
- WEATHERPROOF PRE-WIRED DISCONNECT SWITCH
- PROVIDE PRE-WIRED SOLID STATE SPEED CONTROLLER
- GRAVITY BACKDRAFT DAMPER
- FURNISHED BY OWNER WITH HOOD PACKAGE
- FURNISHED WITH DAMPER TRAY

EXHAUST FAN SCHEDULE

	FACE SIZE OR	(NO.) & AIR		MAX FLOW					
NECK SIZE	GRID SIZE	PATTERN	TYPE	(CFM)	MOUNTING	MATERIAL	MANUFACTURER	MODEL NUMBER	REMARKS
8"X8"	12"x12"	-	EXHAUST	200	SURFACE	ALUMINUM	METAL-AIRE / TITUS	CC5S-1/50F	FRN SQR TO RND ADAPTER
8"DIA	24"x24"	-	EXHAUST	300	SURFACE	ALUMINUM	METAL-AIRE / TITUS	CC5-FB-TB/50F-NT	FRN SQR TO RND ADAPTER
22"X22"	24"x24"	-	RETURN	2500	LAY-IN	ALUMINUM	METAL-AIRE / TITUS	RHE-6/50FF	HINGED/FULLY REMOVABLE FACE
15"X15"	24"x24"	4W	SUPPLY	600	LAY-IN	ALUMINUM	METAL-AIRE / TITUS	5000-6 / TDC-AA-NT	FRN SQR TO RND ADAPTER
9"X9"	14"x14"	4W	SUPPLY	250	SURFACE	ALUMINUM	METAL-AIRE / TITUS	5000-1 / TDC-AA	FRN SQR TO RND ADAPTER
20"x20"	24x24	4W	SUPPLY	600	LAY-IN	MODULAR PLASTIC CORE	HART & COOLEY	RZMCDST	FRN SQR TO RND ADAPTER
	8"X8" 8"DIA 22"X22" 15"X15" 9"X9"	NECK SIZE GRID SIZE 8"X8" 12"x12" 8"DIA 24"x24" 22"X22" 24"x24" 15"X15" 24"x24" 9"X9" 14"x14"	NECK SIZE GRID SIZE PATTERN 8"X8" 12"x12" - 8"DIA 24"x24" - 22"X22" 24"x24" - 15"X15" 24"x24" 4W 9"X9" 14"x14" 4W	NECK SIZE GRID SIZE PATTERN TYPE 8"X8" 12"x12" - EXHAUST 8"DIA 24"x24" - EXHAUST 22"X22" 24"x24" - RETURN 15"X15" 24"x24" 4W SUPPLY 9"X9" 14"x14" 4W SUPPLY	NECK SIZE GRID SIZE PATTERN TYPE (CFM) 8"X8" 12"x12" - EXHAUST 200 8"DIA 24"x24" - EXHAUST 300 22"X22" 24"x24" - RETURN 2500 15"X15" 24"x24" 4W SUPPLY 600 9"X9" 14"x14" 4W SUPPLY 250	NECK SIZE GRID SIZE PATTERN TYPE (CFM) MOUNTING 8"X8" 12"x12" - EXHAUST 200 SURFACE 8"DIA 24"x24" - EXHAUST 300 SURFACE 22"X22" 24"x24" - RETURN 2500 LAY-IN 15"X15" 24"x24" 4W SUPPLY 600 LAY-IN 9"X9" 14"x14" 4W SUPPLY 250 SURFACE	NECK SIZE GRID SIZE PATTERN TYPE (CFM) MOUNTING MATERIAL 8"X8" 12"x12" - EXHAUST 200 SURFACE ALUMINUM 8"DIA 24"x24" - EXHAUST 300 SURFACE ALUMINUM 22"X22" 24"x24" - RETURN 2500 LAY-IN ALUMINUM 15"X15" 24"x24" 4W SUPPLY 600 LAY-IN ALUMINUM 9"X9" 14"x14" 4W SUPPLY 250 SURFACE ALUMINUM	NECK SIZE GRID SIZE PATTERN TYPE (CFM) MOUNTING MATERIAL MANUFACTURER 8"X8" 12"x12" - EXHAUST 200 SURFACE ALUMINUM METAL-AIRE / TITUS 8"DIA 24"x24" - EXHAUST 300 SURFACE ALUMINUM METAL-AIRE / TITUS 22"X22" 24"x24" - RETURN 2500 LAY-IN ALUMINUM METAL-AIRE / TITUS 15"X15" 24"x24" 4W SUPPLY 600 LAY-IN ALUMINUM METAL-AIRE / TITUS 9"X9" 14"x14" 4W SUPPLY 250 SURFACE ALUMINUM METAL-AIRE / TITUS	NECK SIZE GRID SIZE PATTERN TYPE (CFM) MOUNTING MATERIAL MANUFACTURER MODEL NUMBER 8"X8" 12"x12" - EXHAUST 200 SURFACE ALUMINUM METAL-AIRE / TITUS CC5S-1/50F 8"DIA 24"x24" - EXHAUST 300 SURFACE ALUMINUM METAL-AIRE / TITUS CC5-FB-TB/50F-NT 22"X22" 24"x24" - RETURN 2500 LAY-IN ALUMINUM METAL-AIRE / TITUS 5000-6 / TDC-AA-NT 9"X9" 14"x14" 4W SUPPLY 250 SURFACE ALUMINUM METAL-AIRE / TITUS 5000-1 / TDC-AA

1. SURFACE MOUNTED DIFFUSERS IN HARD CEILINGS SHALL BE PROVIDED WITH OPPOSED BLADE DAMPERS. SEE ARCHITECTURAL DRAWINGS FOR CEILING TYPES.

AIR DEVICE SCHEDULE

TACO BELL HAS A NATIONAL HVAC AGREEMENT WITH LENNOX NATIONAL ACCOUNTS. FOR QUOTES & TECHNICAL SPECIFICATIONS CONTACT BY EMAIL AT YUM!@LENNOXIND.COM OR 800-367-6285 ACCOUNT

LENNOX HAS AGREED TO SUPPLY AN HVAC PACKAGE CONSISTING OF THE ROOF-TOP UNITS, CURBS. THERMOSTATS, TEMPERATURE SENSORS (REMOTE), AND HUMIDITY SENSORS (REMOTE). RTU'S AS SPECIFIED INCLUDE AN UNPOWERED CONVENIENCE OUTLET (SEE ELECTRICAL) AND AN HACR CIRCUIT BREAKER WHICH SERVES AS UNIT DISCONNECT.

FOR HVAC TEST AND BALANCE, GC TO SCHEDULE WITH TACO BELL'S PREFERRED VENDOR PER SCOPE OF WORK WORKSHEETS. BE PREPARED AT TIME OF ORDER OR QUOTE REQUEST TO PROVIDE ALL PROJECT DETAILS REGARDING SPECIFICATIONS AND QUANTITIES AS SITE SPECIFIC DESIGN MAY NOT MATCH NATIONAL DESIGN.

SEE THE SCOPE OF WORK SHEETS FOR ADDITIONAL INFORMATION.

ITEM	OA	RA	SA	EA	PRESSURE
EF-1				-1050	-1050
EF-2				-570	-570
RTU-1	675	2325	3000		+675
RTU-2	1125	3875	5000		+1125
TOTAL	1800	6200	8000	-1620	+180

OUTSIDE PERCENTAGE OF TOTAL SUPPLY AIR IS 22.5% FOR RTU-1 AND RTU-2.

ADJUST OUTSIDE AIR INTAKES TO MAINTAIN VALUES AT ALL EVAPORATOR FAN SPEEDS.

GPD GROU

520 S. MAIN STREET, SUIT 2531

AKRON, OH 44311 330.572.2100 FAX: 330.572.2102

DATE	REMARKS
08.09.22	IFB

CONTRACT DATE: 10.05.21 BUILDING TYPE: END. MED20 PLAN VERSION: MARCH 2021 **BRAND DESIGNER:** SITE NUMBER: STORE NUMBER: PA/PM: DRAWN BY. 2021088.52

TACO BELL

1551 West River Rd. Elyria, OH




ENDEAVOR 2.0 MECHANICAL SCHEDULES AND NOTES

HVAC NATIONAL ACCOUNT NOTES

AIR BALANCE SCHEDULE



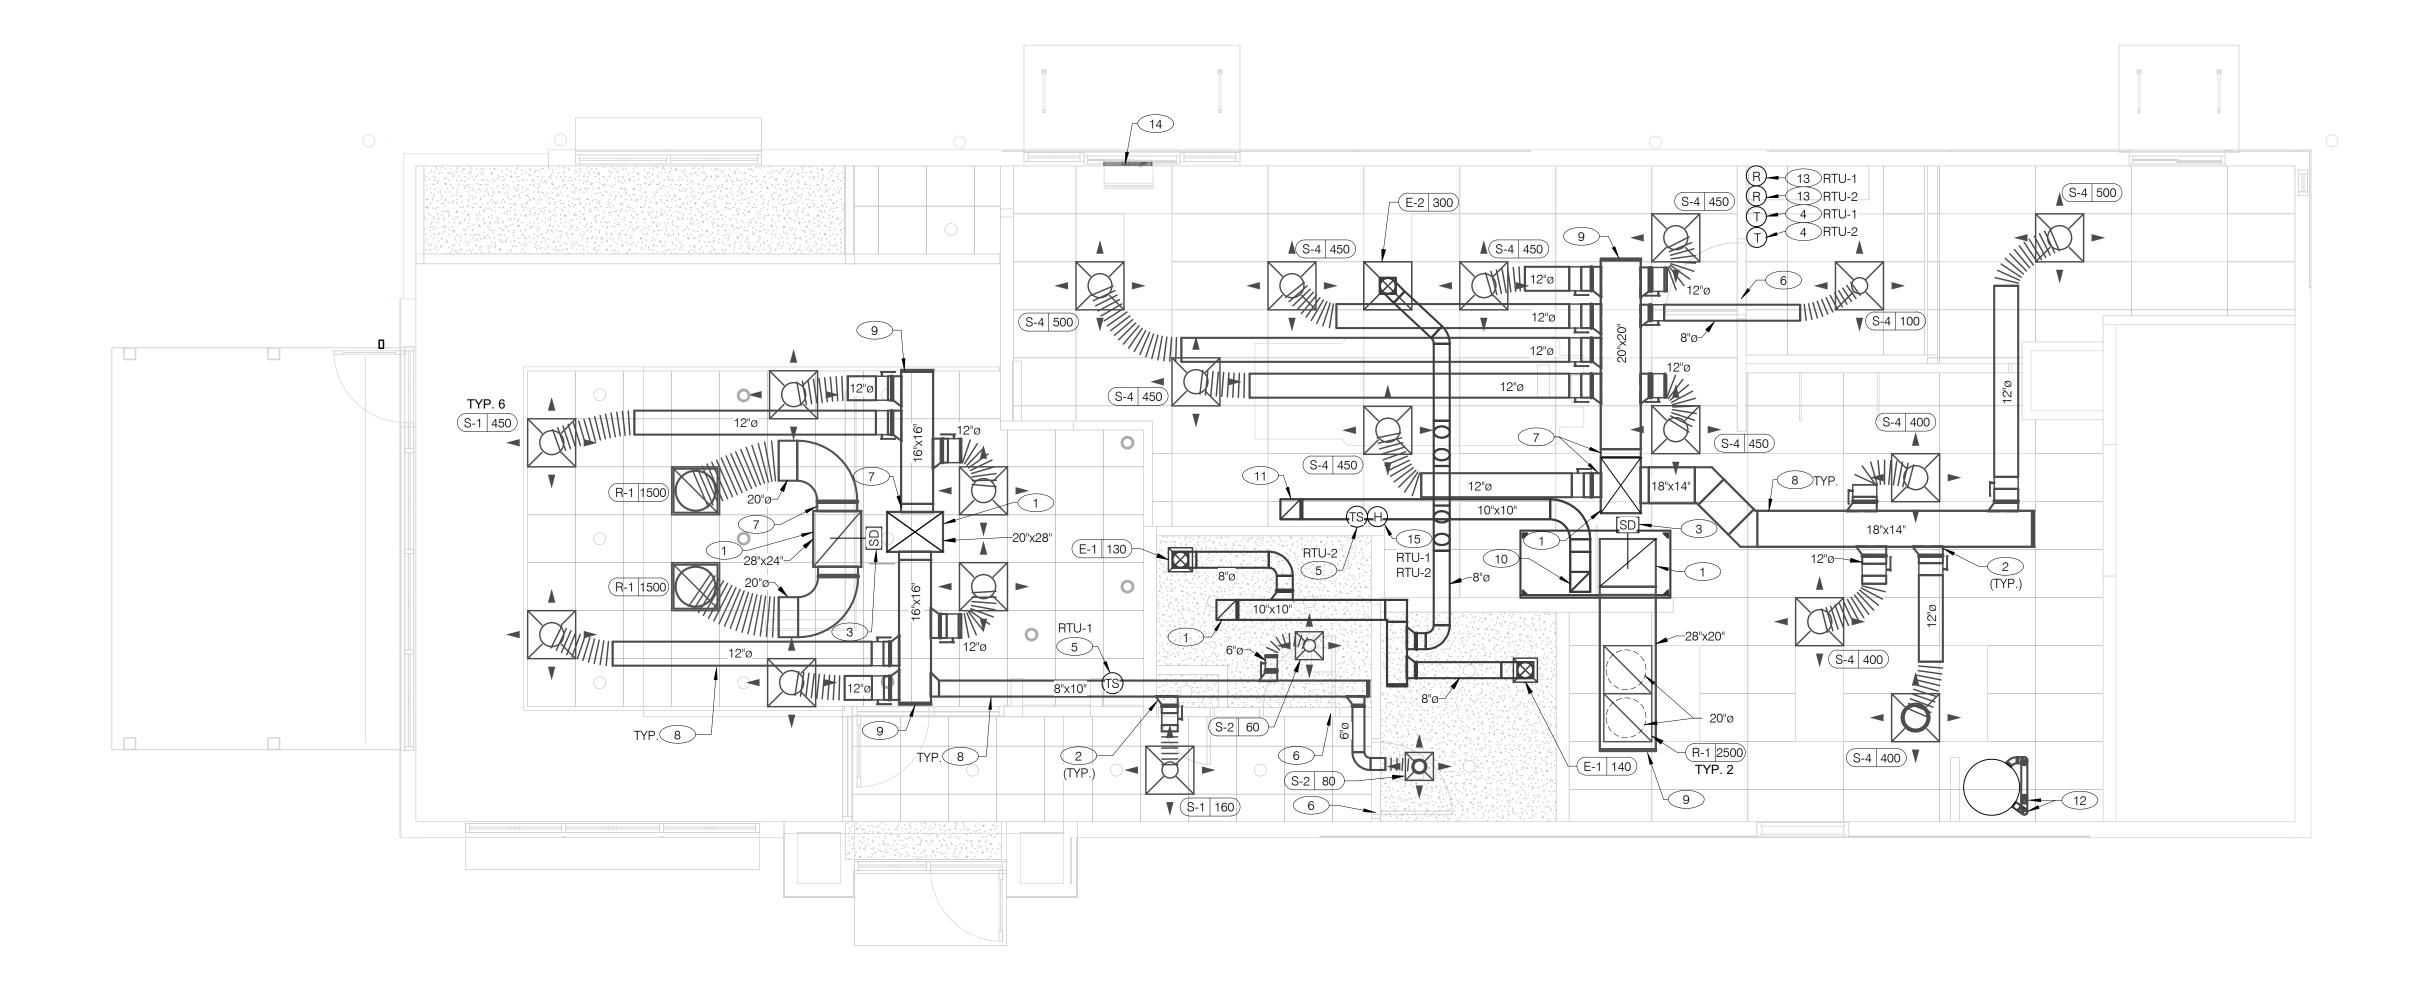

COVER ALL HVAC DUCT SYSTEMS OPENINGS TO PROTECT FROM CONSTRUCTION DUST AND DEBRIS UNTIL CONSTRUCTION IS COMPLETE. IF HVAC SYSTEM IS OPERATED BEFORE CONSTRUCTION IS COMPLETE, PROVIDE MERV8 FILTERS AT ALL AIR INTAKES INSIDE THE BUILDING.



PROVIDE 3" PVC WATER HEATER INTAKE AND FLUE VENT. TERMINATION ON

ROOF. COORDINATE WORK WITH ALL TRADES. 13 PROVIDE SMOKE DETECTOR RESET SWITCH WITH KEY. RESET SWITCH SHALL

14) PROVIDE AIR CURTAIN IN LOCATION AS SHOWN ON PLAN. MOUNT AIR CURTAIN ON MULLION DIRECTLY ABOVE SERVICE OPENING DOORS AT DRIVE-THRU WINDOW. AIR CURTAIN SHALL BE BERNER MODEL DTU03-2026A, WITH 120/1/60 POWER CONNECTION. REFER TO MANUFACTURERS INSTALLATION

15 HUMIDITY SENSOR (REMOTE). MOUNT HUMIDITY SENSORS FOR RTU-1 & RTU-2 AT EYE LEVEL IN KITCHEN. VERIFY EXACT LOCATION.

DUCT AND DIFFUSER PLAN 1/4" = 1'-0"

- BE "SYSTEM SENSOR" MODEL # RT5151 KEY. MOUNT NEXT TO THERMOSTATS @ 48" A.F.F. - INSTALL PER MANUFACTURER'S REQUIREMENTS.
- INSTRUCTIONS FOR MORE DETAILS.

DRAWN BY.: JOB NO.: 2021088.52

TACO BELL

END. MED20

MARCH 2021

455386

CONTRACT DATE:

BUILDING TYPE:

PLAN VERSION:

SITE NUMBER:

PA/PM:

STORE NUMBER:

BRAND DESIGNER:

1551 West River Rd. Elyria, OH

ENDEAVOR 2.0 DUCT AND DIFFUSER PLAN

GENERAL NOTES - MECHANICAL NTS

DINING ROOM LIGHT FIXTURE LOCATIONS ARE CRITICAL.

STRUCTURAL.

PACKAGE).

CONDITIONS.

COORDINATE DUCTWORK LOCATIONS WITH LIGHTING AND

THERMOSTATS SHALL BE PROGRAMMABLE THERMOSTAT WITH SUBBASE AND REMOTE TEMPERATURE SENSOR (PROVIDED WITH RTU

HUMIDITY SENSOR APPLICATION IS VARIABLE PER SITE SPECIFIC

CONDITIONS. REFER TO HVAC UNIT SCHEDULE FOR APPLICATION

1 AIR DUCT UP TO UNIT.

AND GRILLES.

CONDUCTOR CABLES, 18 AWG.

CONNECTION AT HOOD.

FOR EXHAUST DUCT TRANSITION.

AREA IS NOT LOCATED ON TILE WALL.

2 SEE DETAIL 4 ON DRAWING M4.0 FOR SUPPLY AIR TAKE-OFF TO CEILING DIFFUSERS

4 LOCATE THERMOSTAT CONTROLS ON WALL IN OFFICE AT 48" A.F.F. COORDINATE

24 VAC POWER AND SIGNAL CONDUCTORS IN TWO (2) SEPARATE TWO (2)

MOUNT THERMOSTAT REMOTE SENSOR AT 60" ABOVE FINISHED FLOOR. CONNECT

TO THERMOSTAT WITH 18 AWG 2 CONDUCTOR CABLE PER MANUFACTURER INSTALLATION INSTRUCTIONS. ENSURE THAT TEMPERATURE SENSOR IN DINING

7 PROVIDE SHOE TAP AT CONNECTION TO DUCT DROP FROM ROOFTOP UNIT, TYPICAL.

8 RUN DUCT THROUGH OPEN WEBBING OF ROOF TRUSSES (WHERE POSSIBLE).

10 10"X10" EXHAUST AIR DUCT DOWN AND TRANSITION TO FIELD CUT EXHAUST

11) EXHAUST DUCT SHALL RUN BETWEEN ROOF JOISTS TO CONNECT TO ROOF

COORDINATE WITH TRUSS DESIGN PRIOR TO DUCTWORK FABRICATION.

9 RUN DUCTWORK BETWEEN TRUSSES AS HIGH AS POSSIBLE UNDER ROOF JOISTS.

EXHAUST FAN EF-1. SEE HOOD DETAILS ON DRAWING M3.0. SEE DETAIL 10 ON SHEET M4.0 FOR FIRE PROTECTION OF DUCT WORK. SEE DETAIL 11 ON SHEET M4.0


LOCATION WITH LIGHT SWITCHES AND OTHER WALL MOUNTED ACCESSORIES. RUN

3 FACTORY INSTALLED SMOKE DETECTOR MOUNTED IN ROOFTOP UNIT.

6 UNDERCUT RESTROOM DOORS MINIMUM 3/4" FOR MAKE-UP AIR.

KEYNOTES - DUCT AND DIFFUSER NTS



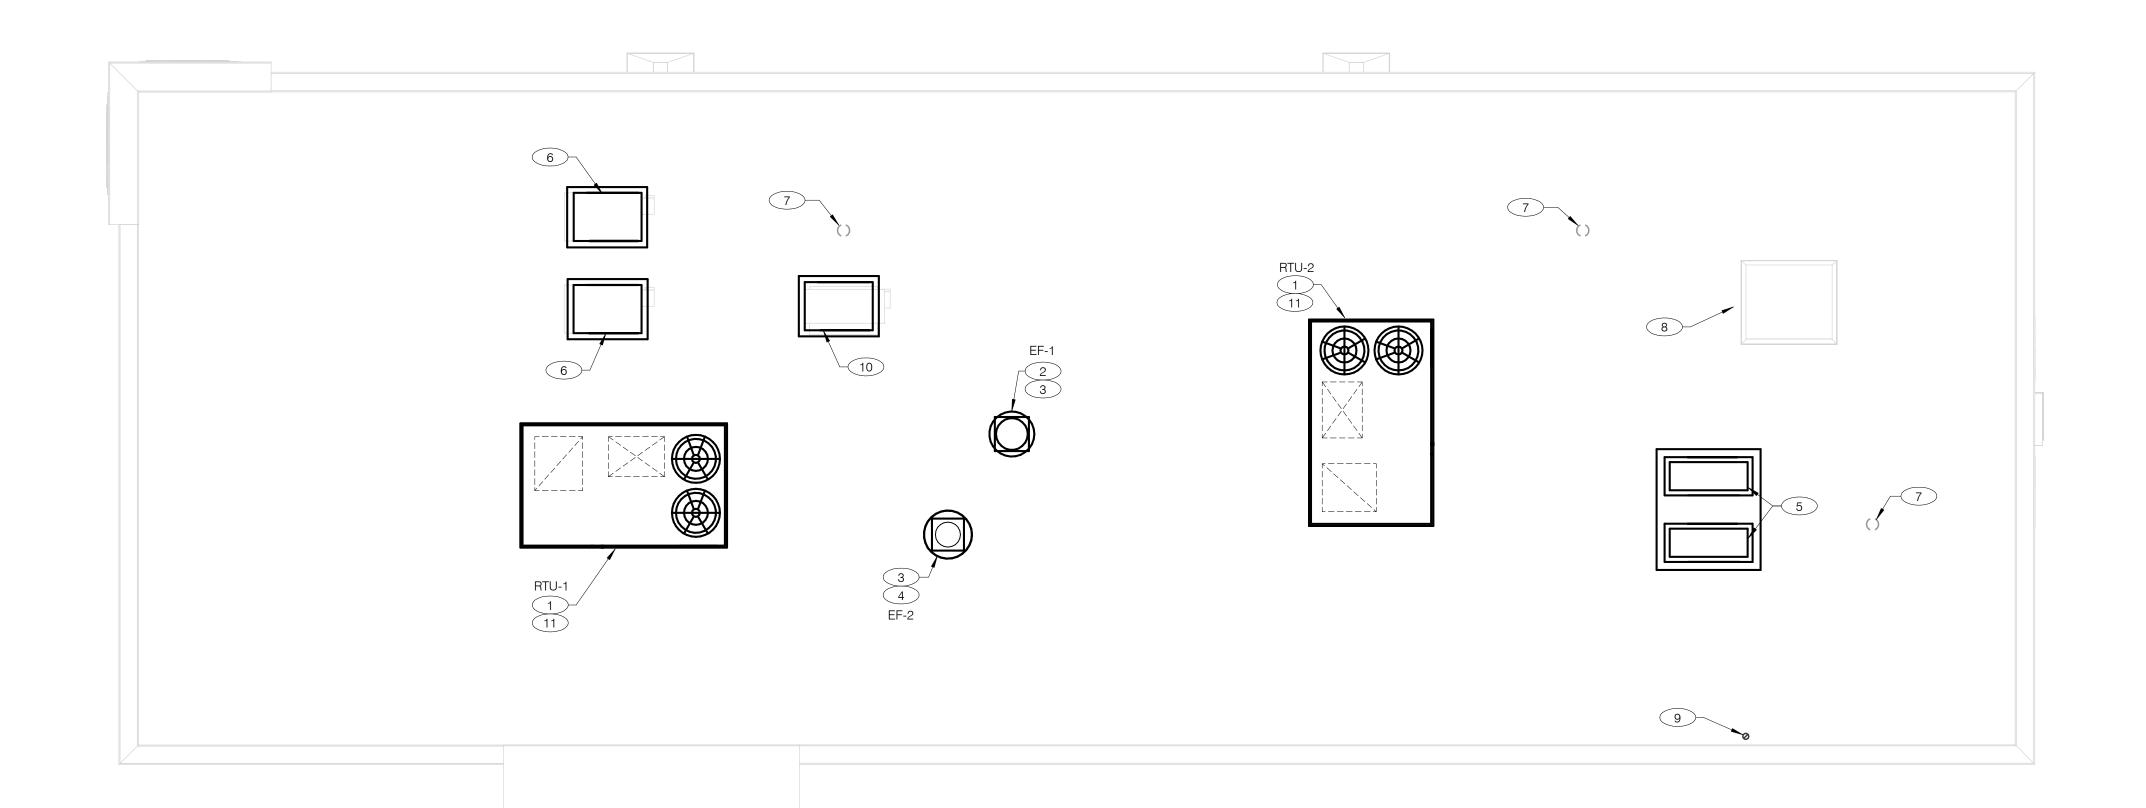

COVER ALL HVAC DUCT SYSTEMS OPENINGS TO PROTECT FROM CONSTRUCTION DUST AND DEBRIS UNTIL CONSTRUCTION IS COMPLETE. IF HVAC SYSTEM IS OPERATED BEFORE CONSTRUCTION IS COMPLETE, PROVIDE MERV8 FILTERS AT ALL AIR INTAKES INSIDE THE BUILDING.



MECHANICAL ROOF PLAN 1/4" = 1'-0"

- PROVIDE RTU IN LOCATION AS SHOWN ON PLANS. COORDINATE EXACT RTU LOCATION AND DUCT DROPS WITH STRUCTURAL TRUSS LAYOUT. MAINTAIN MINIMUM 10'-0" CLEARANCE BETWEEN OUTSIDE AIR INTAKES AND EXHAUST TERMINATIONS.
- PROVIDE TYPE I EXHAUST FAN IN LOCATION AS SHOWN PLANS. CONNECT 10"x10" EXHAUST DUCT FROM EXHAUST HOOD UP TO EF-1 ON ROOF. COORDINATION EXHAUST DUCT ROUTING WITH STRUCTURAL TRUSS LAYOUT.
- 3 COORDINATE EXHAUST FAN LOCATION WITH ROOFTOP UNIT. MAINTAIN ROOFTOP UNIT MANUFACTURER'S REQUIRED CLEARANCE AND MINIMUM 10 FT TO ROOFTOP UNIT'S OUTSIDE AIR INTAKE.
- PROVIDE EXHAUST FAN IN LOCATION AS SHOWN PLANS. CONNECT 10"x10" EXHAUST DUCT FROM RESTROOM EXHAUST GRILLES TO EF-2 ON ROOF. COORDINATION EXHAUST DUCT ROUTING WITH STRUCTURAL TRUSS LAYOUT.
- CONDENSING UNIT SERVING WALK-IN COOLER/FREEZER. COORDINATE EXACT LOCATION WITH ROOF LAYOUT. CONTRACTOR TO FIELD VERIFY EXACT REFRIGERANT PIPING. PROVIDE ALL NECESSARY PIPING ACCESSORIES INCLUDING PIPING INSULATION AND INSTALL ON APPROPRIATE EQUIPMENT SUPPORTS.
- 6 CONDENSING UNIT SERVING ICE MAKER. COORDINATE EXACT LOCATION WITH ROOF LAYOUT. CONTRACTOR TO FIELD VERIFY EXACT REFRIGERANT PIPING. PROVIDE ALL NECESSARY PIPING ACCESSORIES INCLUDING PIPING INSULATION AND INSTALL ON APPROPRIATE EQUIPMENT SUPPORTS.
- 7 PLUMBING VENT. REFERENCE 1/P2.0.
- 8 ROOF HATCH. REFER TO ARCHITECTURAL DRAWINGS FOR MORE INFORMATION.
- 9 PROVIDE MANUFACTURER'S CONCENTRIC TERMINATION VENT KIT SERVING HOT WATER HEATER BELOW. INSTALL IN STRICT ACCORDANCE WITH MANUFACTURER'S REQUIREMENTS. ENSURE AT LEAST 10'-0" DISTANCE BETWEEN OUTDOOR AIR INTAKES.

- CONDENSING UNIT SERVING FROZEN BEVERAGE MACHINE. COORDINATE EXACT LOCATION WITH ROOF LAYOUT. FIELD VERIFY EXACT REFRIGERANT PIPING. PROVIDE ALL NECESSARY PIPING ACCESSORIES INCLUDING PIPING INSULATION AND INSTALL ON APPROPRIATE EQUIPMENT SUPPORTS.
- ALL UTILITY PIPING FOR RTU'S SHALL RUN UP THROUGH ROOF INSIDE EACH UNIT'S ROOF CURB.

CONTRACT DATE:	10.05.21
BUILDING TYPE:	END. MED20
PLAN VERSION:	MARCH 2021
BRAND DESIGNER	DICKSON

BUILDING TYPE: END. MED20
PLAN VERSION: MARCH 2021
BRAND DESIGNER: DICKSON
SITE NUMBER: 315672
STORE NUMBER: 455386
PA/PM: JG
DRAWN BY.: DJ

TACO BELL

2021088.52

JOB NO.:

1551 West River Rd. Elyria, OH




ENDEAVOR 2.0


MECHANICAL


ROOF PLAN


M2.1




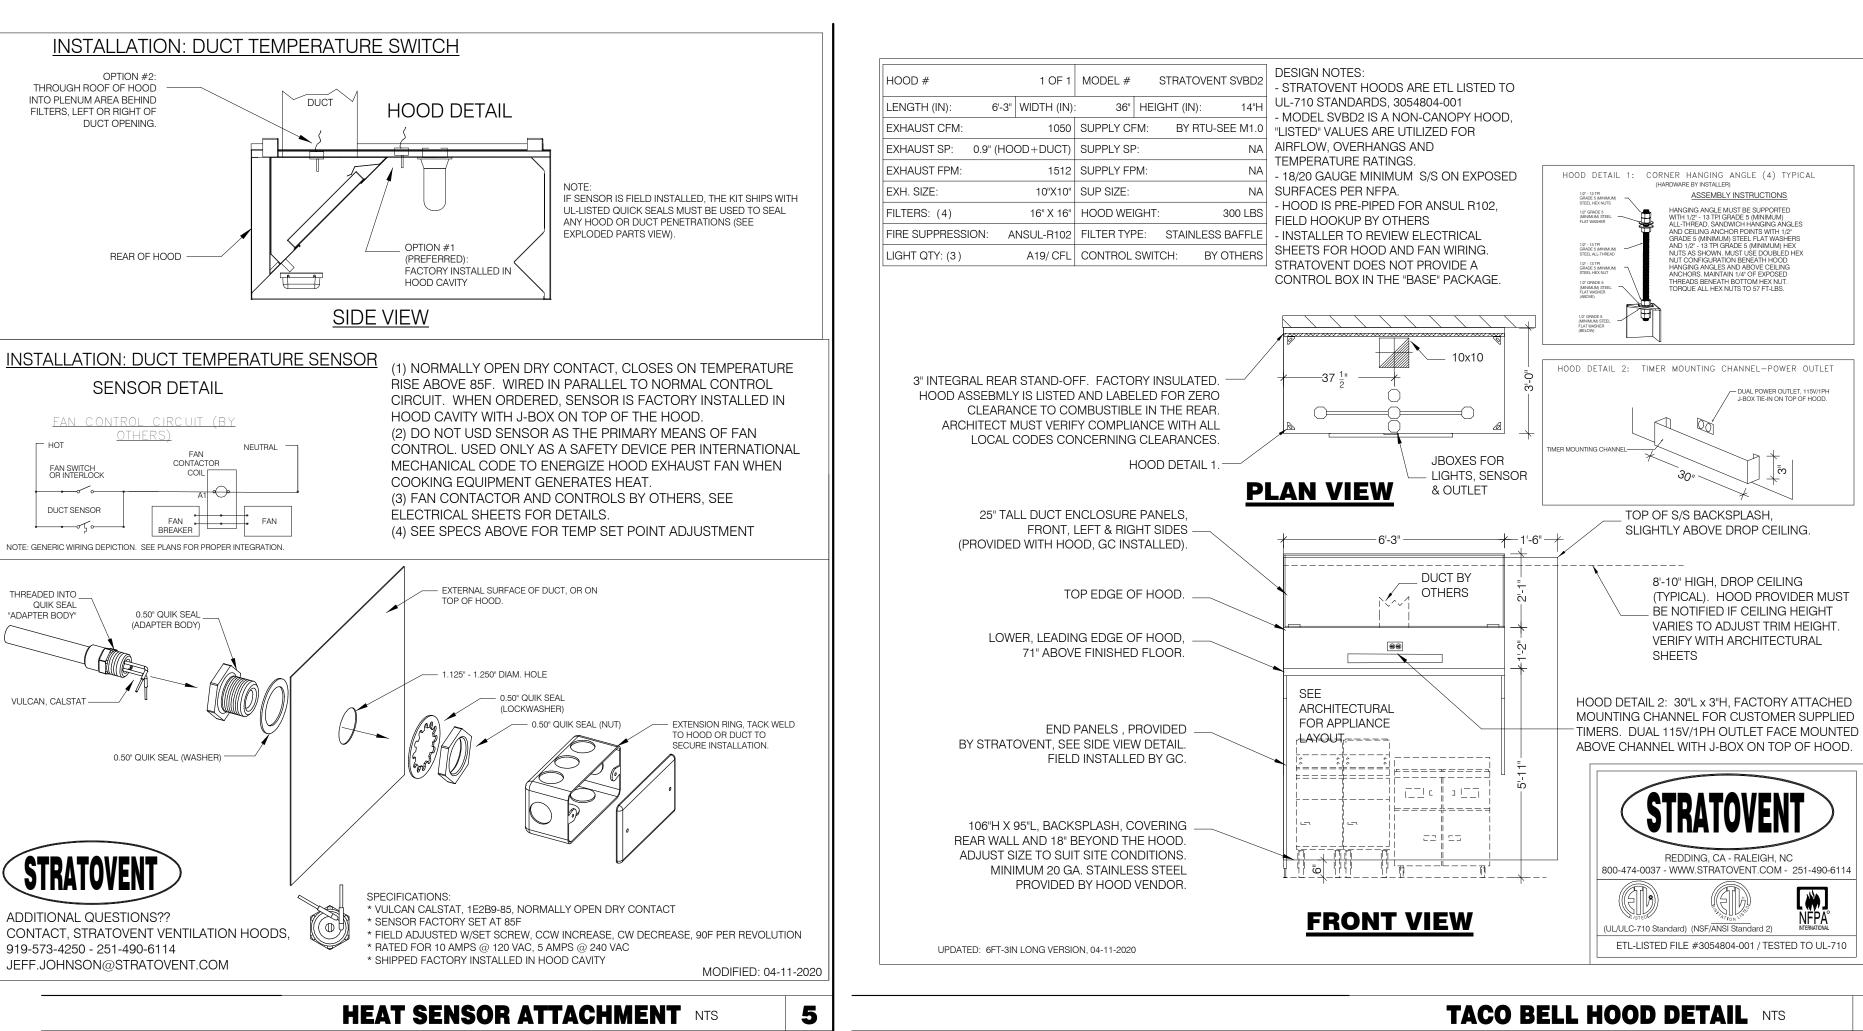


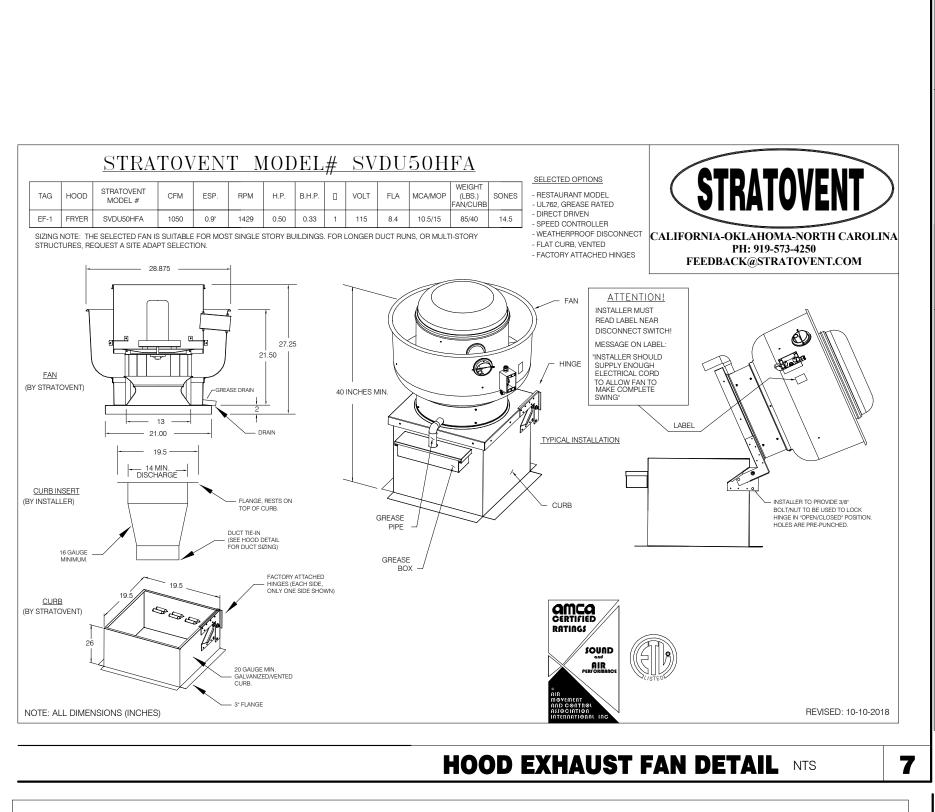

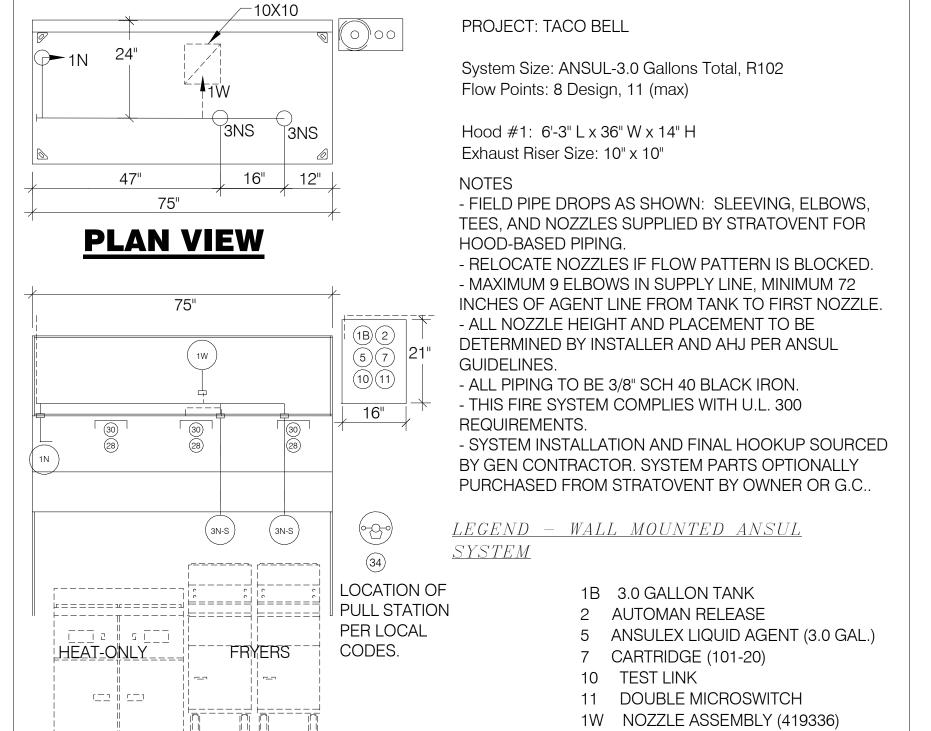


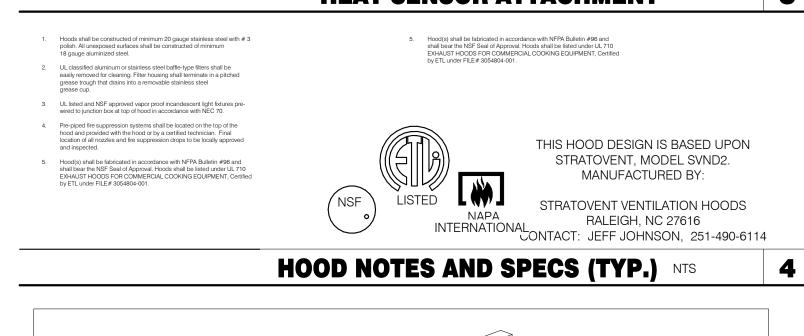

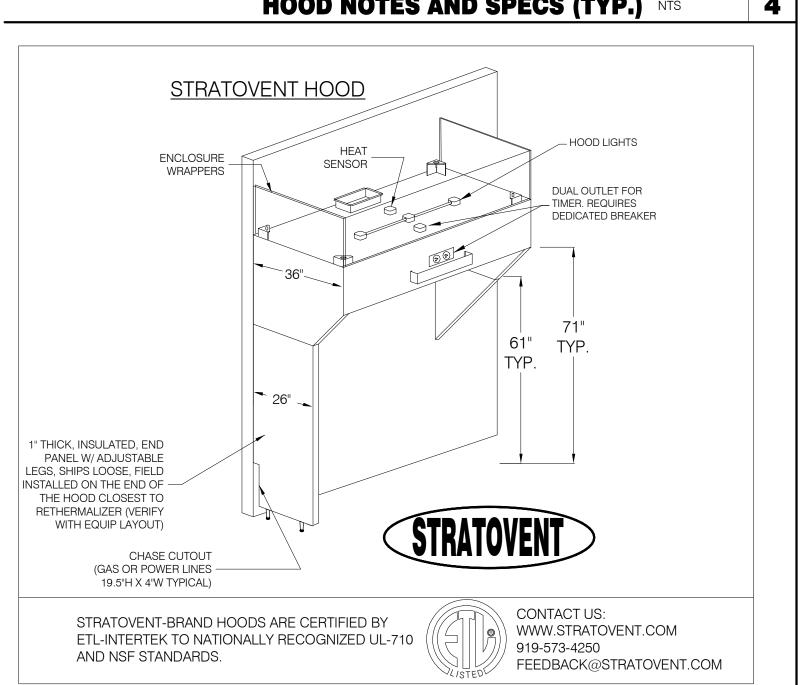

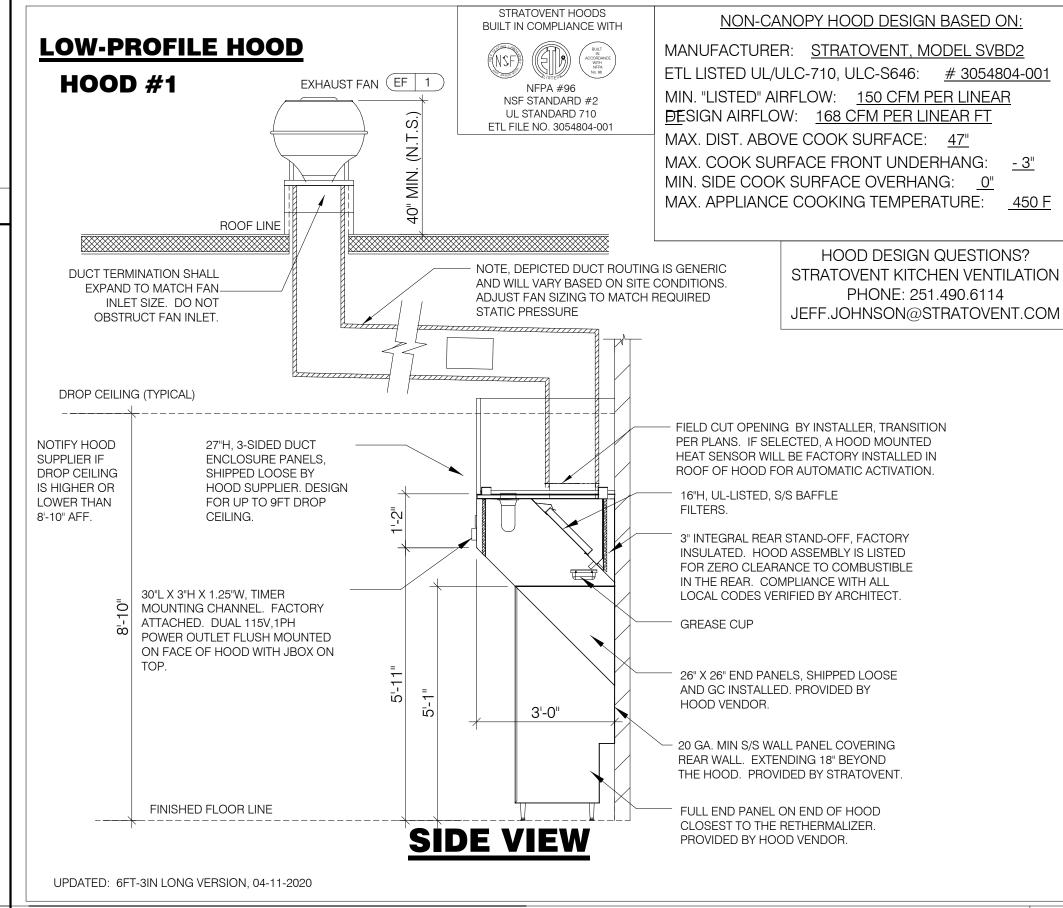

TACO BELL HOOD SECTION 12" = 1'-0"

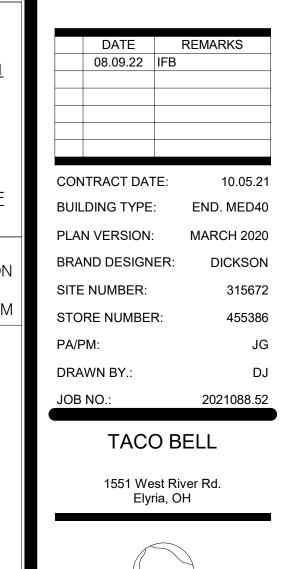

ENDEAVOR 1.0 HOOD DETAILS AND SECTIONS

PLOT DATE: 8/9/2022 1:15:45 PM

FRONT VIEW

ABOVE DEPICTION SHOWS DUAL FRYERS ON RIGHT END

LAYOUT PER PLANS AND PLACE FRYER NOZZLES ON THE

LEFT END WHEN APPROPRIATE TO SUIT SITE CONDITIONS

OF THE HOOD. HOOD SUPPLIER WILL VERIFY EQUIP

DESIGN NOTE

1N NOZZLE ASSEMBLY (419335)

3N NOZZLE ASSEMBLY (419338)


30 HIGH TEMP FUSIBLE LINK

MGV MECHANICAL GAS VALVE

34 REMOTE MANUAL PULL STATION

28 DETECTOR BRACKET


S SWIVEL ADAPTOR

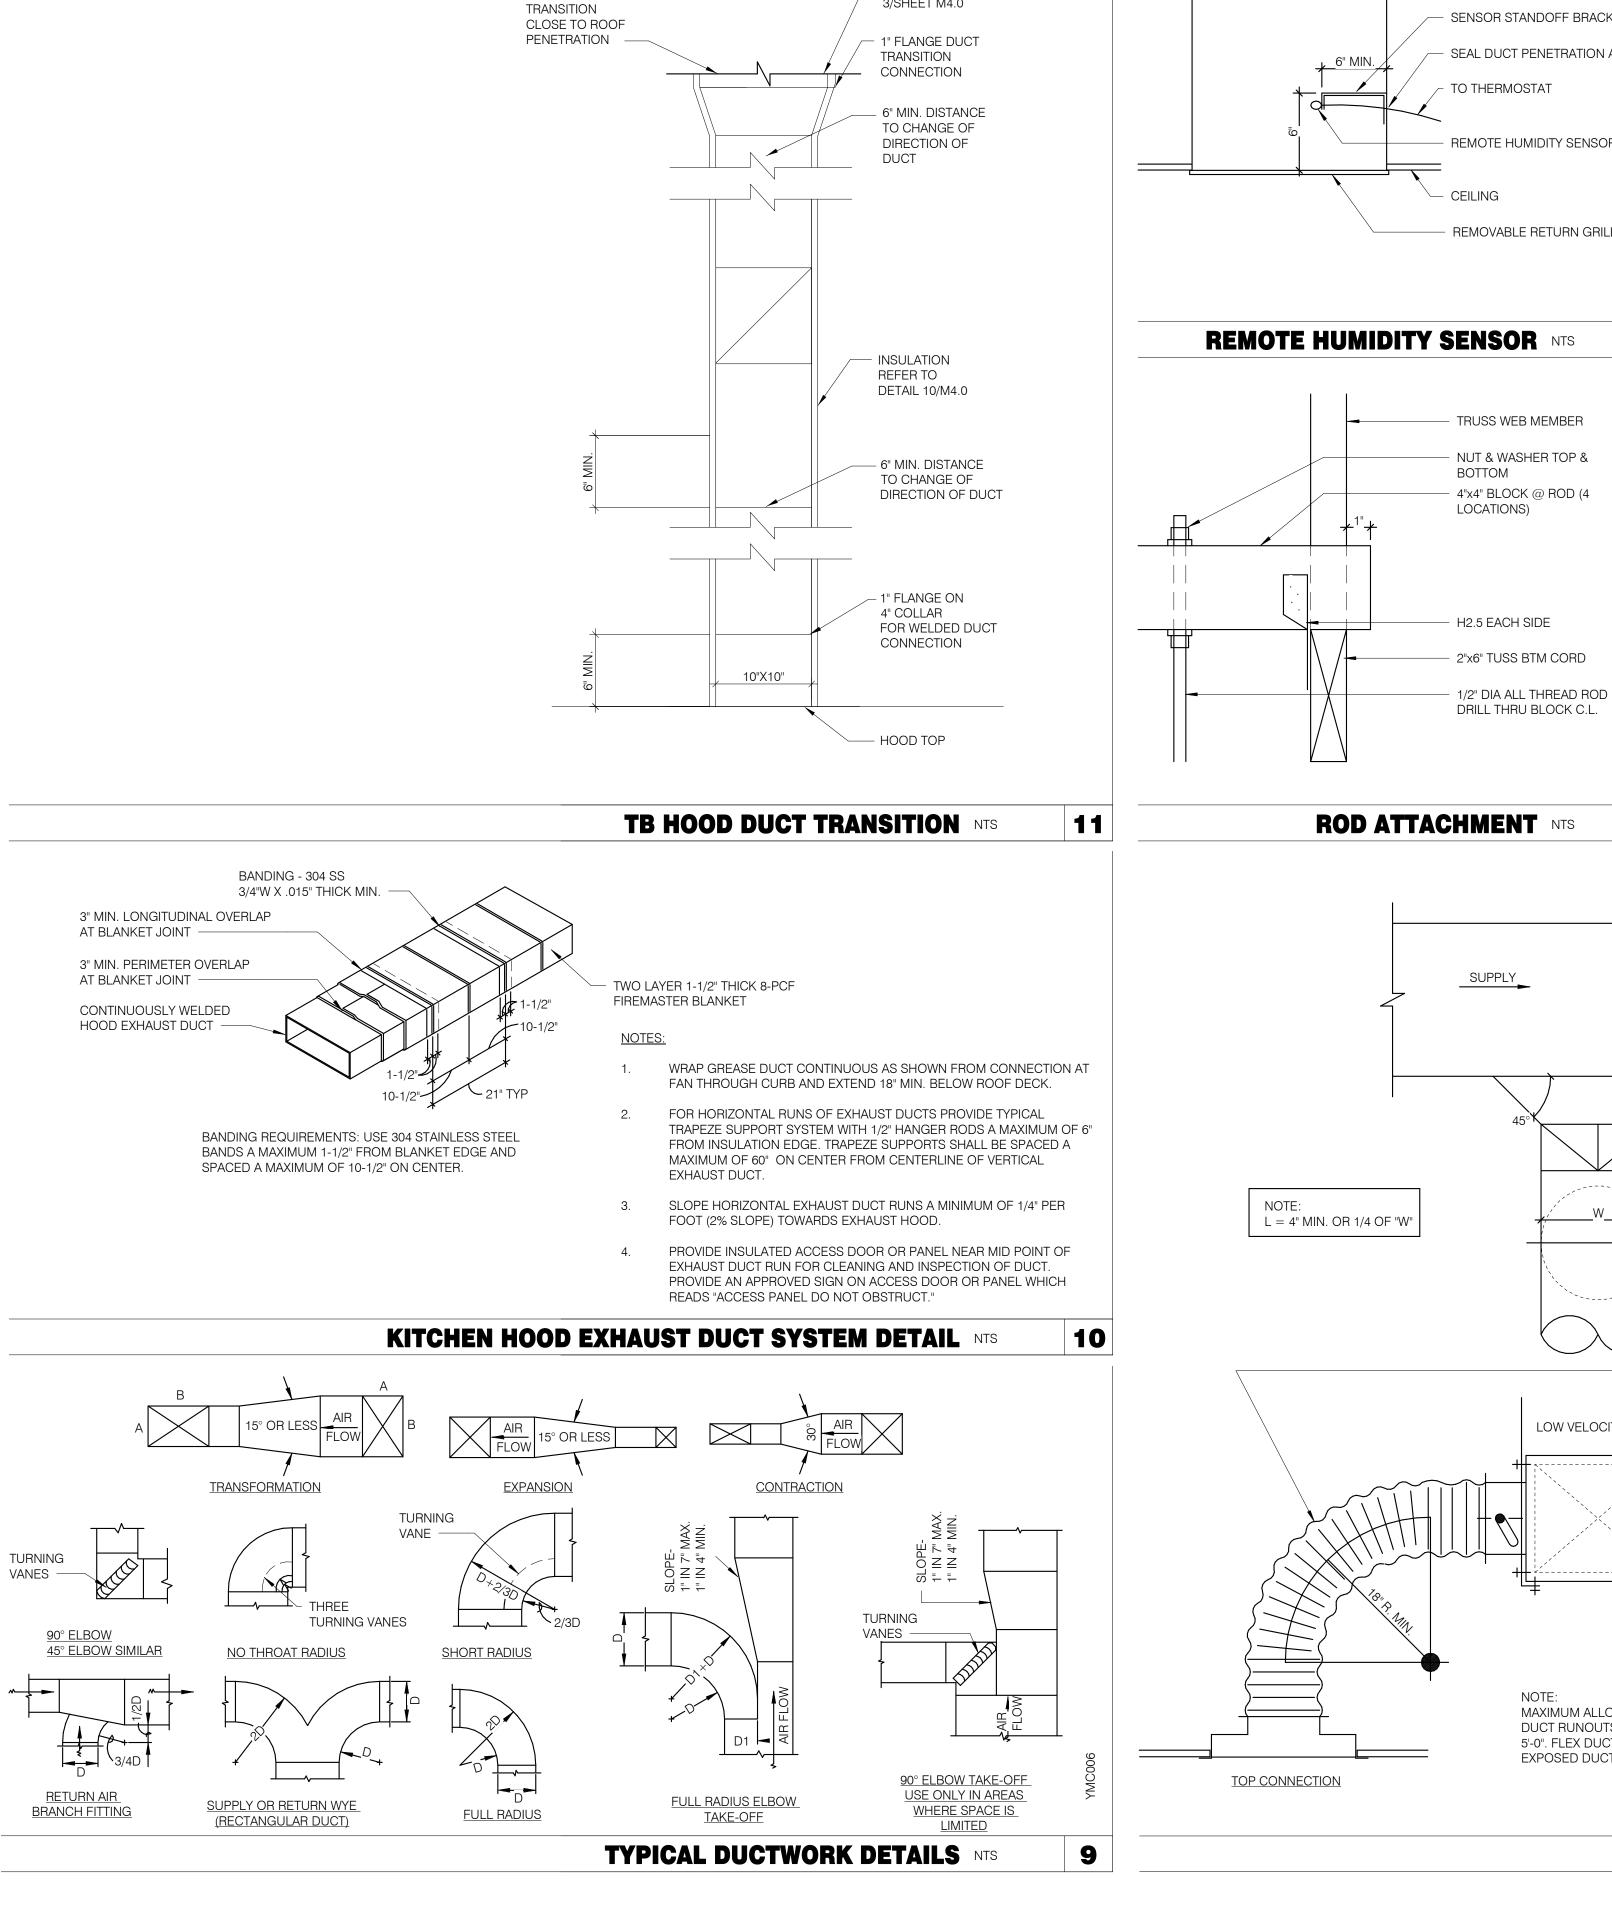

SEE DETAIL

3/SHEET M4.0

PROVIDE

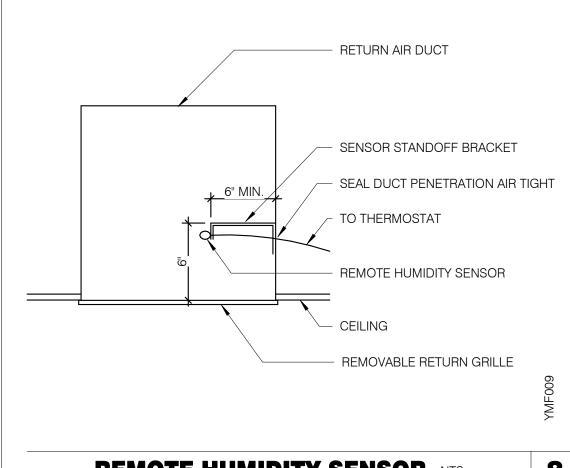



SUPPLY


REMOTE HUMIDITY SENSOR NTS NOT USED NTS 8 TRUSS WEB MEMBER NUT & WASHER TOP & BOTTOM 4"x4" BLOCK @ ROD (4 LOCATIONS)


EXHAUST RETURN

ALL-THREADS ROD - WASHER & NUT HOOD MOUNTING CHANNEL ON HOOD HOOD **BOLT CONNECTION TO HOOD NTS** 5

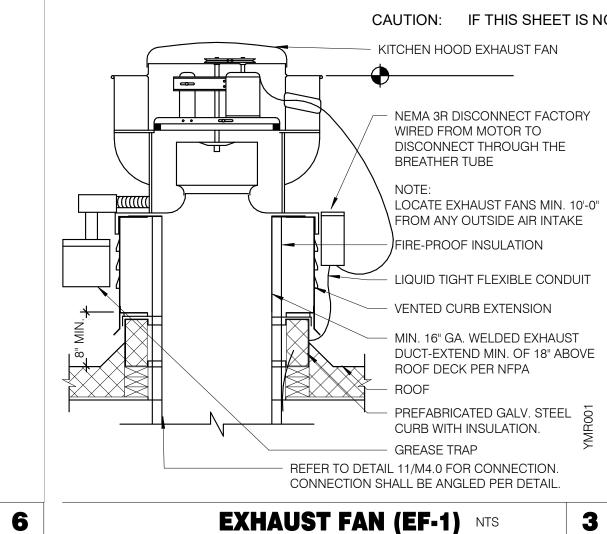

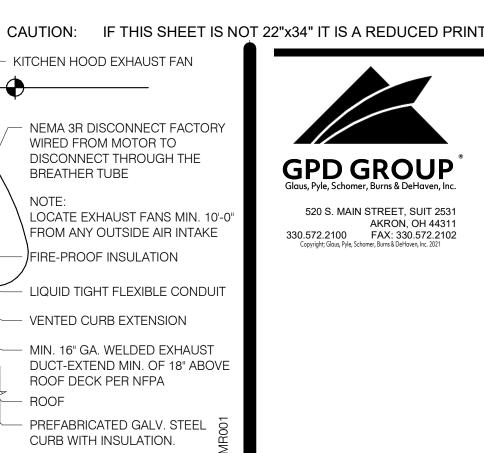

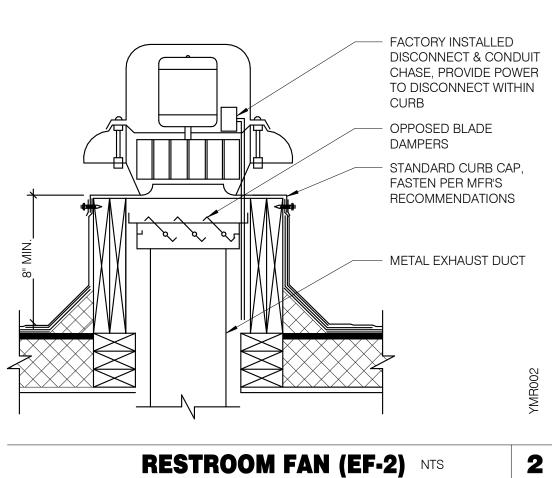

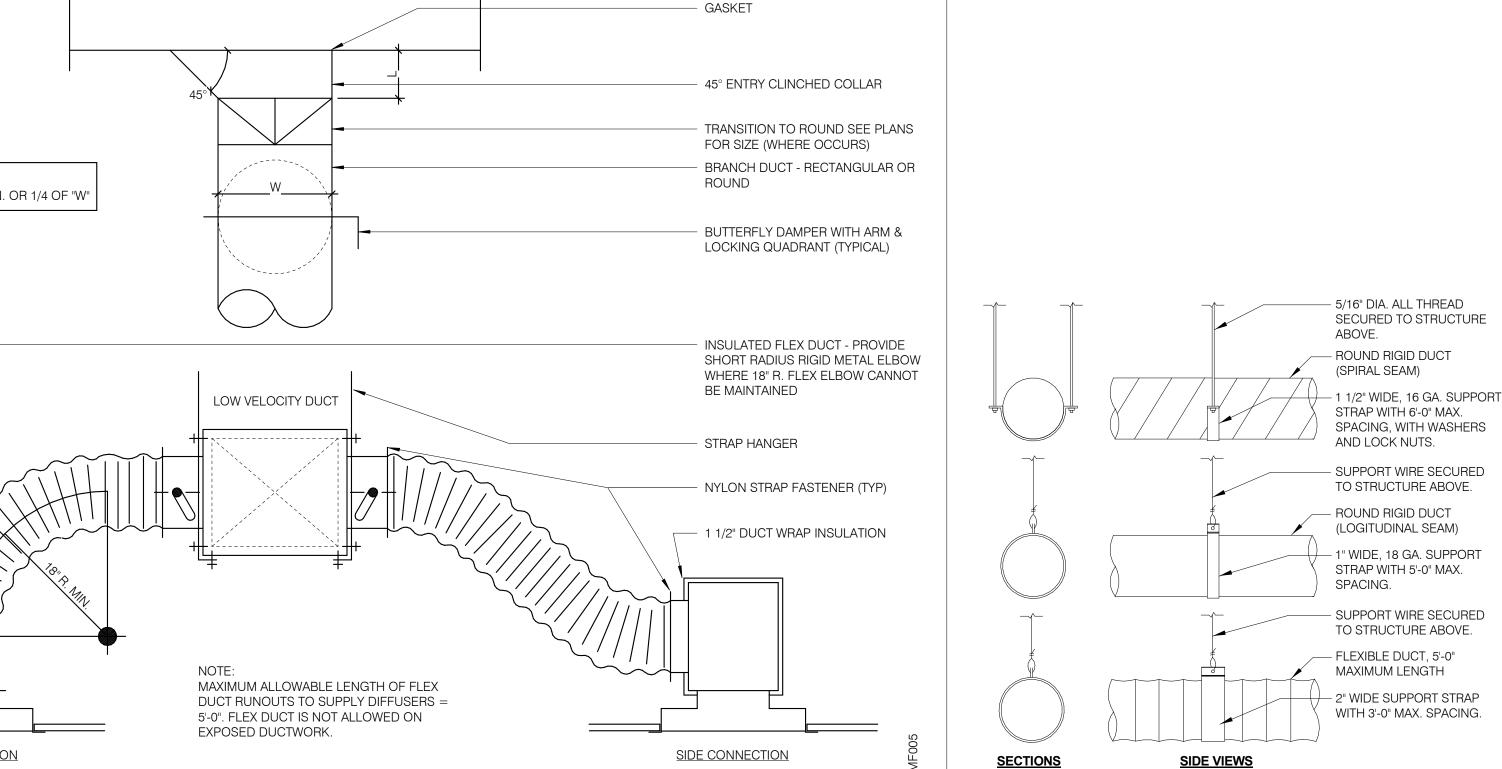

4

CEILING DIFFUSER CONNECTIONS NTS

	DATE	REMARKS	
	08.09.22	IFB	
400	ITDACT DAT	TE: 10.05.1	24

CONTRACT DATE: 10.05.21 END. MED20 BUILDING TYPE: PLAN VERSION: MARCH 2021 BRAND DESIGNER: DICKSON SITE NUMBER: 315672 STORE NUMBER: 455386 PA/PM: DRAWN BY. 2021088.52

TACO BELL


1551 West River Rd. Elyria, OH



ENDEAVOR 2.0 MECHANICAL DETAILS

DUCT SUPPORT DETAIL NTS

FOR REFERENCE ONLY

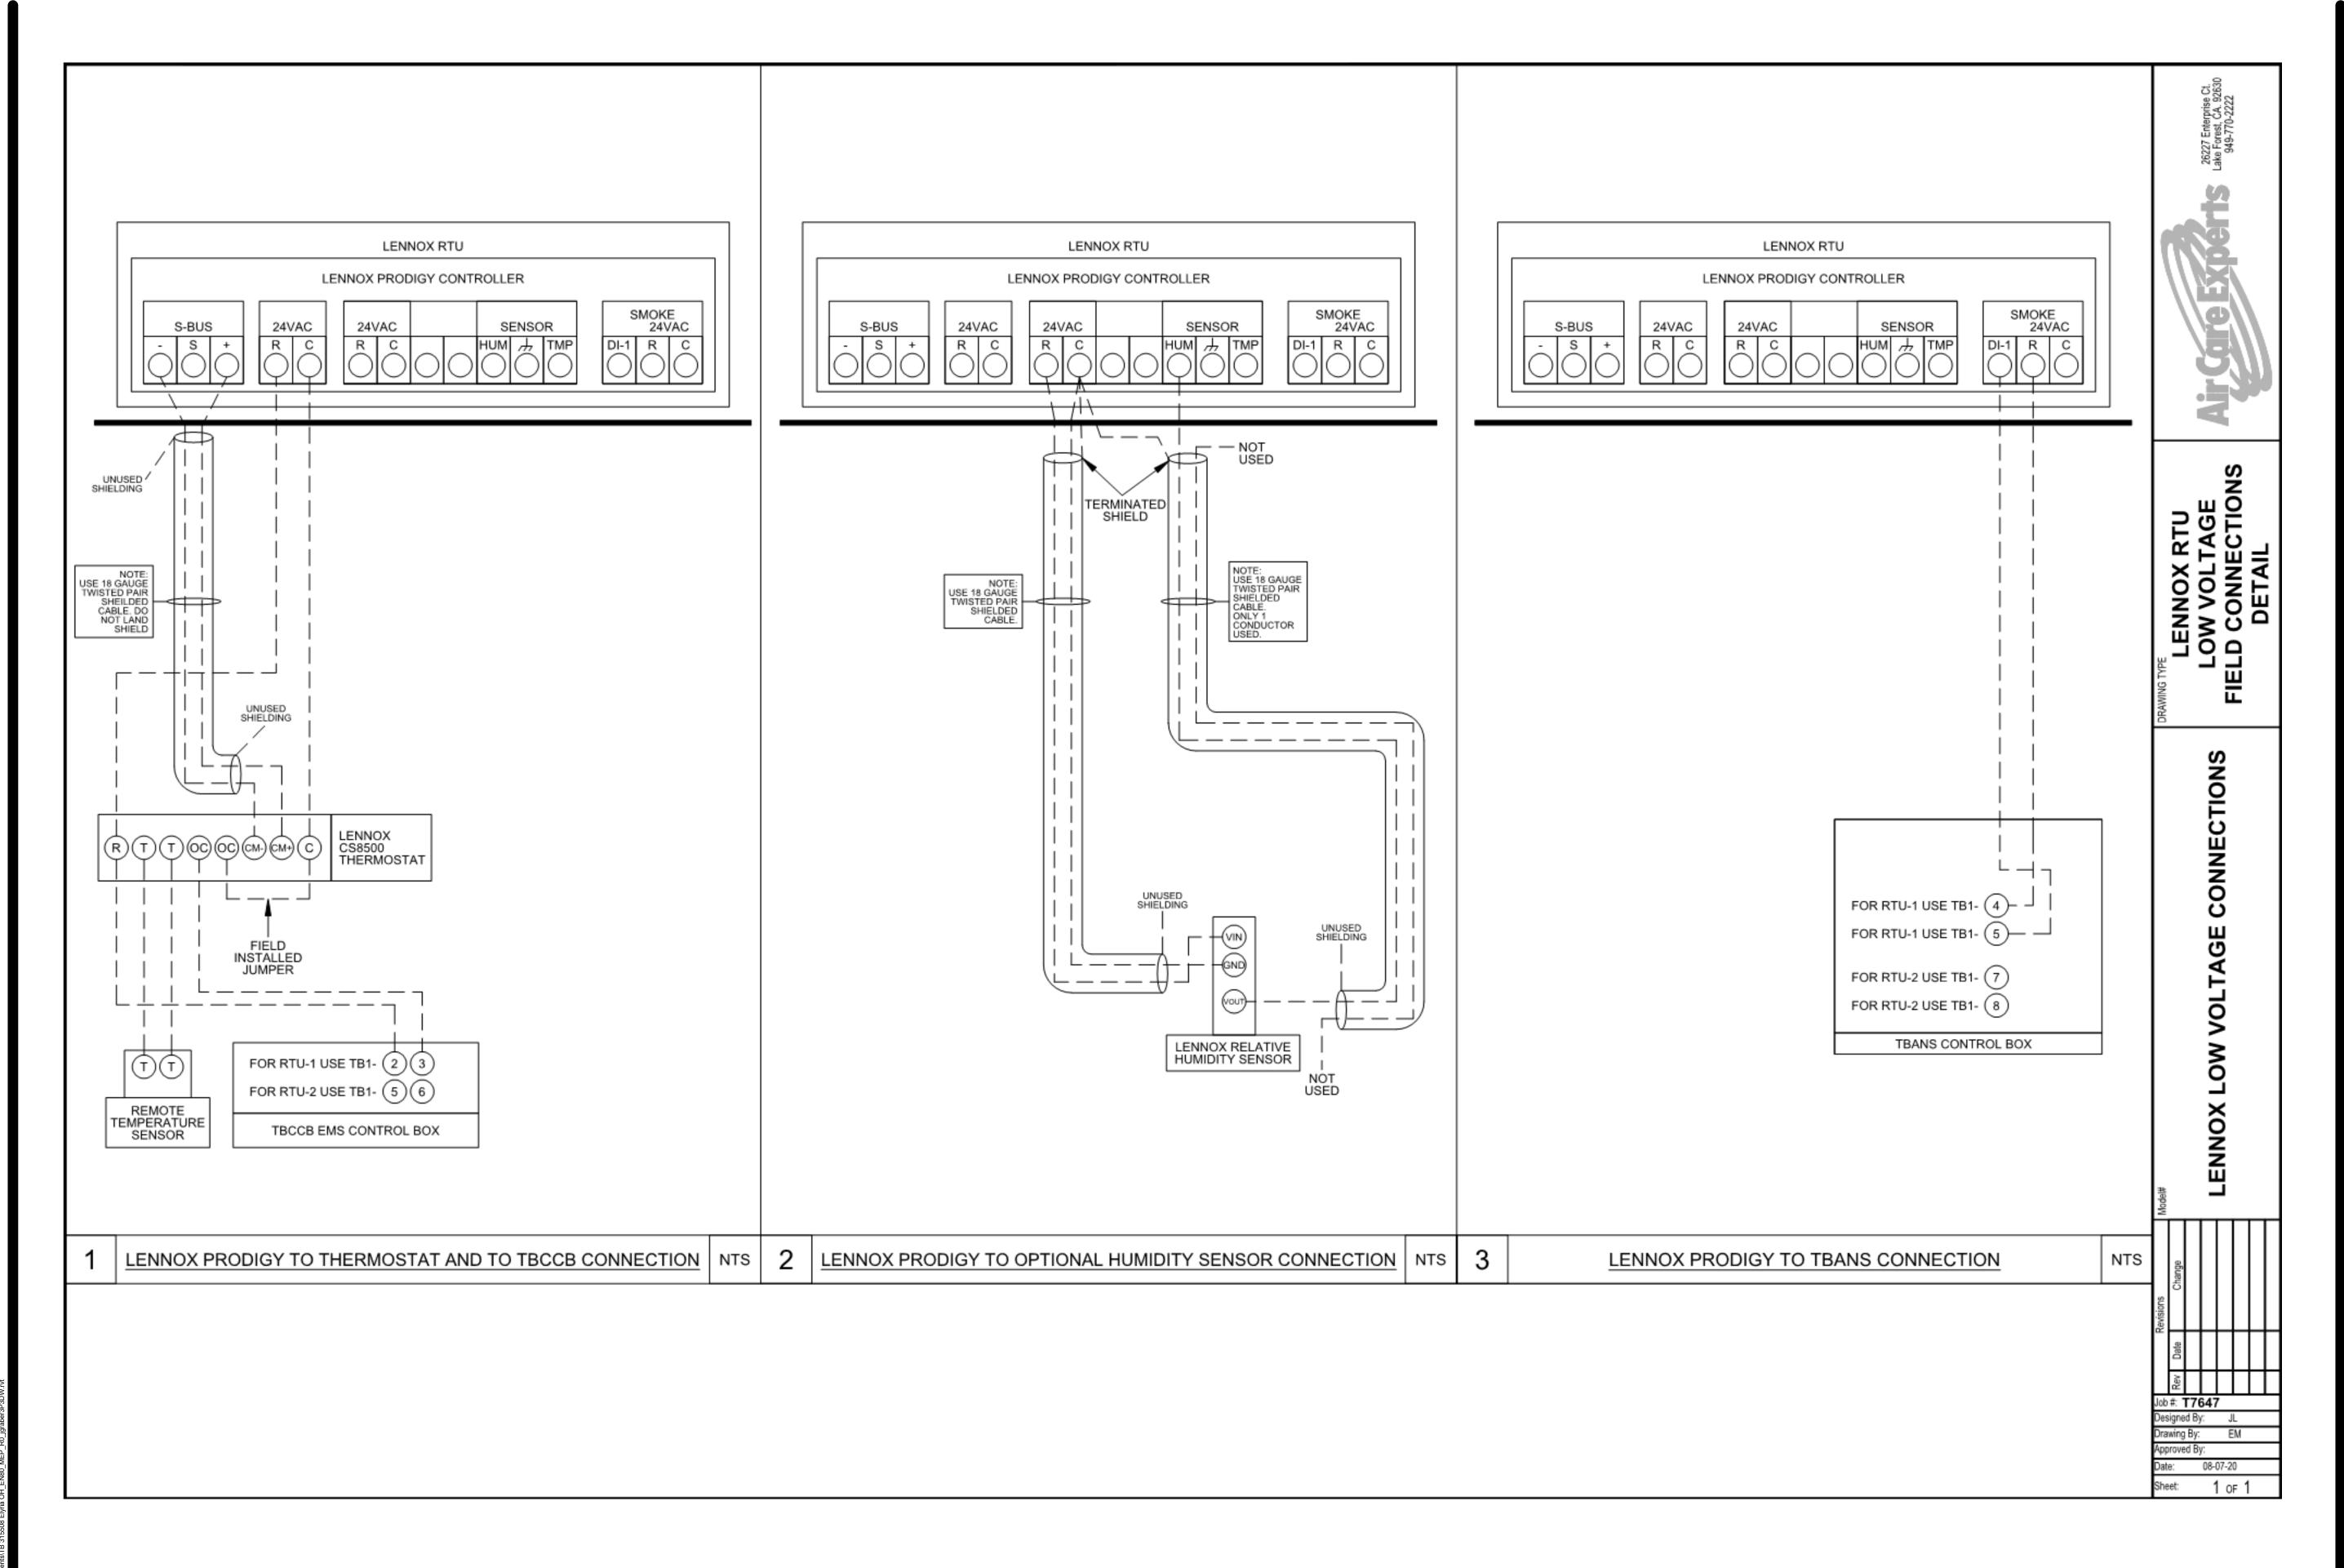

CONTRACT DATE: 10.05.21
BUILDING TYPE: END. MED40
PLAN VERSION: MARCH 2020
BRAND DESIGNER: DICKSON
SITE NUMBER: 315672
STORE NUMBER: 455386

08.09.22 IFB

TACO BELL

2021088.52

PA/PM:

DRAWN BY.:

1551 West River Rd. Elyria, OH



ENDEAVOR 1.0
CONTROLS
DETAILS

M5.0 PLOT DATE: 8/9/2022 1:15:47 PM 1. SOIL AND WASTE PIPE SHALL SLOPE 2% MINIMUM, UNLESS OTHERWISE NOTED OR REQUIRED BY CODE.

2. ALL DRAWN WATER & GAS LINES SHALL BE KEPT TIGHT TO UNDERSIDE OF EQUIPMENT & SECURED IN PLACE.

3. VERIFY LOCATION OF SANITARY SEWER ON SITE PLAN AND REVISE SEWER SYSTEM AS REQUIRED.

4. PROVIDE TRAP PRIMERS FOR FLOOR DRAINS IN RESTROOMS, WHERE REQUIRED BY CODE. PROVIDE DEEP SEAL TRAPS FOR FLOOR DRAINS WITHOUT TRAP PRIMERS.

5. CLEANOUTS SHALL BE INSTALLED WHERE READILY ACCESSIBLE. COORDINATE ALL CLEANOUT LOCATIONS WITH EQUIPMENT, CABINETS, ETC. AND OWNERS REPRESENTATIVE PRIOR TO INSTALLATION.

6. VALVES, TRAP PRIMERS, WATER HAMMER ARRESTORS AND OTHER EQUIPMENT SHOWN IN WALLS OR ABOVE NON-ACCESSIBLE CEILING SHALL BE INSTALLED BEHIND AN ACCESS PANEL.

7. PLUMBING FIXTURE VENTS SHALL TERMINATE MINIMUM OF 12 INCHES FROM VERTICAL SURFACES AND 10 FEET FROM OUTSIDE AIR INTAKES.

8. PROVIDE GAS PIPING TO UNITS AND MAKE FINAL CONNECTIONS REQUIRED FOR OPERATION.

9. PROVIDE SHUT-OFF VALVES ON HOT & COLD WATER LINES TO FIXTURES AND APPLIANCES. ALL EXPOSED WATER AND WASTE LINES SHALL BE CHROME PLATED.

10. PROVIDE LEVER HANDLE GAS SHUT-OFF VALVE IN BRACH PIPING OF EACH APPLIANCE. INSTALL OWNER FURNISHED QUICK DISCONNECT, FLEXIBLE PIPE (IF ALLOWED BY CODE) AND RESTRAINING DEVICE. PROVIDE PRESSURE REDUCING VALVES AT EACH PIECE OF EQUIPMENT OR APPLICANCE IF GAS PRESSURE IS GREATER THAN 10" WC DOWSTREAM OF THE GAS METER.

11. VALVES, UNIONS, ETC. SHALL BE SAME SIZE AS PIPE UNLESS OTHERWISE

12. REFER TO KITCHEN EQUIPMENT DRAWINGS FOR PLUMBING ROUGH-IN REQUIREMENTS. MAKE ALL ROUGH-IN AND FINAL CONNECTIONS TO KITCHEN EQUIPMENT UNLESS OTHERWISE NOTED.

13. REFER TO MECHANICAL DRAWINGS FOR HVAC AND HOOD PLUMBING REQUIREMENTS.

14. GAS LINES SHALL BE SUPPORTED.

15. FLOOR SINKS AND FLOOR DRAINS IN TRAFFIC AREAS SHALL BE INSTALLED FLUSH WITH FLOOR SURFACE.

16. PROVIDE WATER HAMMER ARRESTOR FOR ALL HAND SINKS AND URINAL WATER LINES

17. PROVIDE AIR GAPS FOR INDIRECT DRAINS AS REQUIRED BY CODE. AIR SHALL BE MINIMUM 2 TIMES DIAMETER OF INDIRECT DRAIN.

18. VERIFY DEPTH, SIZE, LOCATION, AND CONDITION OF ALL EXISTING UTILITIES IN THE FIELD PRIOR TO COMMENCING WORK ON PROJECT. NOTIFY OWNER IMMEDIATELY OF CONDITIONS THAT EXIST WHICH WOULD CAUSE THE DESIGN TO BE ALTERED..

19. COORDINATE INSTALLATION OF PLUMBING WORK WITH OTHER TRADES SO AS TO AVOID UNNECESSARY DELAY OR INTERFERENCES.REVIEW ARCHITECTURAL AND EQUIPMENT SHEETS.

20. PROVIDE BACKFLOW PROTECTION DEVICES REQUIRED BY AGENCIES HAVING JURISDICTION. BACKFLOW DEVICES REQUIRING TESTING SHALL BE INSTALLED NO HIGHER THAN 5'-0" A.F.F.

21. PROVIDE CONDENSATE DRAIN FROM A/C UNITS TO APPROVED DRAIN. PROVIDE GAS PIPING TO UNITS. MAKE FINAL CONNECTIONS REQUIRED FOR OPERATION.

22. THE OWNER OR KITCHEN EQUIPMENT SUPPLIER MAY SUBSTITUTE EQUIPMENT OR EQUIPMENT MAY VARY FROM WHAT IS SHOWN. THEREFORE, VERIFY ALL CRITICAL DIMENSIONS WITH OWNER PRIOR TO CONSTRUCTION. FAILURE OF CONTRACTOR TO VERIFY THESE DIMENSIONS SHALL PLACE RESPONSIBILITY FOR SUBSEQUENT RELOCATION DIRECTLY UPON CONTRACTOR.

23. ALL WATER LINES SHALL BE RUN OVERHEAD UNLESS OTHERWISE NOTED.

24. ALL WATER LINES SHALL BE FLUSHED PRIOR TO CONNECTING FIXTURES OR

25. PROVIDE ESCUTCHEON PLATES AND SILICONE SEALANT AT UTILITY PENETRATIONS INTO WALLS, CEILINGS, AND FLOORS. DO NOT USE CAULKS OR EXPANDING FOAMS FOR SEALANT.

26. CPVC SCHEDULE 40 WASTE PIPE CAN BE SUBSTITUTED FOR BLACK IRON WASTE PIPE WHERE ALLOWED BY LOCAL MUNICIPALITIES.

GENERAL NOTES - PLUMBING NTS

SYMBOLS	ABBREV.	DESCRIPTION
	Y.B.	YARD BOX
	R.D.	ROOF DRAIN
	A.P.	ACCESS PANEL
	V.T.R.	VENT THRU ROOF
	V.B.F.	VENT BELOW FLOOR
	U.T.R.	UP THRU ROOF
	V.C.P.	VITRIFIED CLAY PIPE
	C.I.	CAST IRON
	(TYP.)	TYPICAL
	(N)	NEW
	(E)	EXISTING
	F.D.	FLOOR DRAIN
0	H.D.	HUB DRAIN
	O.F.D.	OVERFLOW DRAIN
	F.S.	FLOOR SINK
	G.L.	GAS LINE
	A.F.F.	ABOVE FINISHED FLOOR
X 00		PLUMBING EQUIPMENT DESIGNATION
⟨XXX⟩		KITCHEN EQUIPMENT NUMBER: REFER TO KITCHEN EQUIPMENT DRAWINGS FOR DESCRIPTION.
— ss —	SS	SOIL OR WASTE (SANITARY)/WASTE STUB
——GW——	GW	SOIL OR WASTE (GREASE WASTE)/WASTE STUB
<u> — G —</u>	G	GAS / GAS STUB
CW	CW	COLD WATER/ CW STUB
— HW——	HW	HOT WATER / HW STUB
— HWR—	HWR	HOT WATER RETURN
	V	SANITARY VENT
—— SD ——	S.D.	STORM DRAIN
CD	C.D.	CONDENSATE DRAIN
	F.C.O.	FLOOR CLEANOUT
l——	W.C.O.	WALL CLEANOUT
——FW ——	FW	FILTERED WATER
——TW ——	TW	PREMIXED TEMPERATURE WATER
+	H.B.	HOSE BIBB
$-\!$	S.O.V.	SHUT-OFF GATE VALVE
	S.O.C.	SHUT-OFF GAS COCK
<u> </u>	C.V.	CHECK VALVE
≱ —	P.T.R.V.	PRESS-TEMPERATURE RELIEF VALVE
	B.V.	BALL VALVE
	C.W.	COLD WATER BELOW GRADE
	E.C.O.	EXTERIOR CLEAN OUT
	BFP	BACK FLOW PREVENTER
	FU	FIXTURE UNIT

PLUMBING LEGEND NTS

		DR	AIN	COLD	WATER	HOT WATER	
FIXTURE	NO.	D.F.U.	TOTAL D.F.U.	F.U. C.W.	TOTAL C.W.	F.U. H.W.	TOTAL H.W.
WATER CLOSET	2	4	8	5	10		
URINAL	0	5		5			
LAVATORY	2	1	2	1.5	3	1.5	3
HAND SINK	2	2	4	1.5	3.0	1.5	3.0
PREP SINK *	1			2	2	2	2
3 - COMPARTMENT SINK *	1			3	3	3	3
HOSE BIBB/WATER FILTRATION UNIT	2/1			5/0.5	10.5		
FLOOR DRAIN	7	2	14				
HUB DRAIN	2	2	4				
FLOOR SINK	4	3	12				
MOP SINK	1	3	3	2.25	2.25	2.25	2.25
RETHERMALIZER *	1					1.0	1.0
TOTAL			47		33.75		14.25

PROBABLE DEMANDS/ COLD WATER: 33.75 FU = 24.5 GPM USE 1-1/2" CW SERVICE AND PIPE SIZING DRAIN: GW 22 DFU USE 4" SANITARY (MIN) REQUIREMENTS: DRAIN: SAN 25 DFU USE 4" SANITARY (MIN) HOT WATER: 14.25 FU = 17.1 GPM USE 1-1/4" HW SERVICE BASED ON 2015 IPC (COMBINATION DRAIN & VENT). *FIXTURE HAS INDIRECT WASTE TO FLOOR SINK

GREASE INTERCEPTOR SIZING CALCULATION
(11 GPM) x (30 MIN RETENTION TIME) = 330 GALLONS

NOTES:

1. PROPOSED GREASE INTERCEPTOR SIZE = 1,000 GALLONS.
2. PER SECTION 709.3, ONE GPM IS EQUIVALENT TO TWO FIXTURE UNITS.

PLUMBING FIXTURE COUNT NTS

2

3

MANUFACTURER / MODEL NUMBER

CAUTION: IF THIS SHEET IS NOT 22"x34" IT IS A REDUCED PRINT



		WASIL		**	***	**	'0	'		
									CAST IRON CLEANOUT WITH THREADED ADJUSTABLE HOUSING, ROUND SCORIATED HEAVY	JOSAM / MODEL: 56000
(ECO 1)	EXTERIOR CLEANOUT								CAST IRON COVER.	WADE / MODEL: 6000Z
	CLLANOUT									ZURN / MODEL: Z-1400
									PVC 12" SQUARE FLOOR SINK, 8" DEEP, WITH ALUMINUM OR PVC DOME STRAINER AND LOOSE	JOSAM / MODEL: JPFS4-PVC
(FS 1)	FLOOR SINK	4"	2"				6		SET PVC SLOTTED TOP GRATE. SET FLOOR SINK LIP FLUSH WITH FLOOR TILE.	ZURN / MODEL: FD-2370-PV4-DS-F
	I LOON SINK	4	۷							2011(1) WODEL. 1 D-2070-1 14-D0-1
									CAST IRON 12" SQUARE FLOOR SINK, 8" DEEP, WITH ALUMINUM DOME STRAINER AND NICKEL BRONZE HINGED TOP.	JOSAM / MODEL: 49034AS
(FS 2)	FLOOR SINK	3"	2"				6		BNONZE HINGED TOP.	WADE / MODEL: 9144
										ZURN / MODEL: Z-1900-32
									PVC FLOOR DRAIN, 5" DIA. IF PVC OR ABS DRAINS ARE USED, SCHEDULE 80 PVC DRAIN PIPE	ZURN / MODEL: FD-2210
(FD 1)	FLOOR DRAIN	3"	2"				2		SHALL BE USED FOR THE FIRST 10'-0" FROM THE DRAIN.	JOSAM / MODEL: 30003-A
										WADE / MODEL:1103
									CAST IRON DEEP SEAL P-TRAP WITH FUNNEL, NO-HUB OUTLET AND BRASS GASKETED	JOSAM / MODEL: 88213
(HD 1)	HUB DRAIN	3"	2"				2		CLEANOUT PLUG.	WADE / MODEL: 2453EF
										ZURN / MODEL: Z-1019
									CAST IRON CLEANOUT WITH THREADED ADJUSTABLE HOUSING, ROUND SCORIATED HEAVY	JOSAM / MODEL: 56000
(FCO 1)	FLOOR								CAST IRON COVER.	WADE / MODEL: 6000Z
	CLEANOUT									ZURN / MODEL: Z-1400
									CAST IRON CLEANOUT TEE WITH INLET/OUTLET SPIGOT AND THREADED BRASS PLUG, WITH	JOSAM / MODEL: 58510
(Wood 1)	WALL								STAINLESS STEEL ACCESS COVER.	
(wcd 1)	WALL CLEANOUT								OTAMALESS STELL ASSESS SEVERI.	WADE / MODEL: 8560E
										ZURN / MODEL: Z-1446-BP
									NON-FREEZE WALL HYDRANT WITH INTEGRAL VACUUM BREAKER, BRONZE CASING AND NICKEL	JOSAM / MODEL: 71000
HB 1	HOSE BIBB			3/4"				2.5/1	BRONZE BOX.	WADE / MODEL: 8600L
										ZURN / MODEL: Z-1300
									WHITE VITREOUS CHINA FLOOR MOUNTED FLUSHOMETER TANK (PRESSURE ASSISTED) TYPE,	AM. STD. "CADET" / MODEL: 2467.100
									ELONGATED BOWL, ADA COMPLIANT, 1.1 GPF, WITH OPEN FRONT SEAT LESS COVER,	KOHLER "HIGHLINE" / MODEL: K-3519
	WATER								OLSONITE #95 OR EQUIVALENT. FLUSHOMETER TANK: SLOAN FLLUSHMATE OR EQUAL.	CRANE "ECONMISER" / MODEL: 31888
WC	CLOSET	4"	2"	1/2"			4	2	PROVIDE TANK COVER LOCKS. FLUSH VALVES SHALL BE RIGHT HAND OR LEFT HAND AS REQUIRED TO CORRESPOND WITH ACCESS FROM WIDE SIDE OF STALL. VERIFY FLUSH SIDE	·
<u> </u>									REQUIREMENTS.	
									WHITE VITREOUS CHINA, WALL HUNG, WITH CONCEALED ARMS SUPPORT, 4" CENTERS, WITH	A.S. COMRADE/ MODEL: 0124.131
	LAVATORY	1-1/4"	1-1/2"	1/2"		1/2"	4	1.5	INTEGRAL BACKSPLASH, ADA ACCESSIBLE. FLAT GRID STRAINER. BRAIDED WATER LINES.	CRANE "HARWICH" / MODEL: 1412V
	LAVATORT	1-1/4	1-1/2	1/2		1/2	'	1.5	FAUCET: FURNISHED BY OWNER-INSTALLED BY G.C. ELECTRONIC SENSOR TYPE FAUCET.	Chaire Hanviich / Wobel. 1412V
									SLOAN SF-2300, ADA COMPLIANT. SEE 5/P6.0 FOR LAV SUPPORT DETAIL, 0.5 GPM AERATOR	
a									S-1: STAINLESS STEEL HAND SINK, WALL HUNG, INCLUDES A 6" GOOSENECK STAINLESS.	
S 1	HAND SINK	1-1/2"	1-1/2"	1/2"		1/2"	2	1.5	FAUCET W/SINGLE KNEE PEDAL. BRAIDED WATER LINES, 0.5 GPM AERATOR.	
<u> </u>										
									MOP SINK: AERO - 3MP-2121-6 W/ 48" HIGH S.S. LEFT SIDE AND BACK-SPLASH. FURNISHED BY	
(S 2)	MOP SINK	3"	2"	1/2"	1/2"		3	2.25	OWNER, INSTALLED BY CONTRACTOR.	
									FAUCET: T&S #B2465, WITH VACUUM BREAKER, FURNISHED BY OWNER, INSTALLED BY CONTRACTOR.	
									CONTINACTOR.	
	0.00140								SINK, FAUCET & DRAIN, GEN IV POWER SOAK STANDARD, GEN III IS AN OPTION FOR	
$\left(\begin{array}{c c} S & 3 \end{array}\right)$	3-COMP. SINK	INDIRECT		1/2"	1/2"			3	FRANCHISES	
	Olivic									
									SINK, FAUCET AND DRAIN	
(S 4)	PREP SINK	INDIRECT		1/2"	1/2"			3		
									PRECAST 1,000 GALLON GREASE INTERCEPTOR WITH SAMPLING BOX. SEE SITE PLAN FOR	JENSEN / JP1000G
(GI 1)	GREASE INTERCEPTOR	4"							EXTERIOR GREASE INTERCEPTOR LOCATION.	
	I INTERCEPTOR									
									THEDMOSTATIC 105 DE16, 200 /F DDON'TE DODY STAINI FOR STEEL DISTONALINED SHESK	POWERS SERIES LFLM495
(NA)/I	MIXING VALVE			1 /0"	4 /0"				THERMOSTATIC, 125 P516, 200VF BRONZE BODY, STAINLESS STEEL PISTON LINER, CHECK VALVES SIZE PER PIPE CONNECTIONS.	
MV 1	VALVE			1/2"	1/2"					LAWLER SERIES 310
										LEONARD SERIES 170
	\\\\\								GAS FIRED WATER HEATER, 95% THERMAL EFF., 199,000 BTUH INPUT, 100 GAL. STORAGE	AO SMITH / CYCLONE MXI BTH-199
WH 1	WATER HEATER			1-1/2"	1-1/2"				TANK, 235 GPH @ 100 DEG. RISE REC. RATE, 3" PVC FLUE & INTAKE, ASME RATED TEMPERATURE AND PRESSURE RELIEF. VALVE, ELECTRONIC IGNITION SYSTEM AND	STATE / SUF 100 199 NE
									ELECTRONIC CONTROLS. Call 800-477-1953 Option #1 for National Account Price & Service	
										WATTS SERIES DETA
(ET]	EXPANSION TANK			0/411					EXPANSION TANK, STEEL, EXPANSION MEMBRANE 150 PSI, 160° F, 12 GALLON CAPACITY.	AMTROL SERIES ST
ET 1	TANK			3/4"						
									PERLICED PRESSURE TO U.S. D. O. (F. C.) (F. C.)	WILKINS SERIES WXTP
	BACKFI OW								REDUCED PRESSURE ZONE BACKFLOW PREVENTER, CAST BRONZE CONSTRUCTION WITH	WATTS / MODEL: LF009M2QTS
(BFP 1)	BACKFLOW PREVENTOR			VERIFY				1	QUARTER TURN FULL-PORT BALL VALVES AND BRONZE STRAINER.	WILKINS / MODEL: 975XLS
										FEBCO / MODEL: 860
	DE /55.55								REVERSE OSMOSIS FILTER SYSTEM BY OWNER. SEE DETAIL 9/P6.0	
(RO 1)	REVERSE OSMOSIS	INDIRECT		1/2"						
									0.5 GPM @5 FEET HEAD. PROVIDE WITH CHECK VALVE, BALANCE VALVE, AND	TACO 009
(RP 1)	RECIRC PUMP				1/2"				AQUASTAT.	
1	İ	1		1	ı		i	1		1

DESCRIPTION

SOIL OR WASTE VENT

COLD | HOT | TEMP'D | WASTE | WATER

| WATER | WATER | FU | FU



BUILDING TYPE: END. MED20
PLAN VERSION: MARCH 2021
BRAND DESIGNER: DICKSON
SITE NUMBER: 315672
STORE NUMBER: 455386
PA/PM: JG

DRAWN BY.:

TACO BELL

2021088.52

1551 West River Rd. Elyria, OH





PLUMBING
SCHEDULES
AND NOTES


P1.0

PLOT DATE: 8/9/2022 1:15:49 PM



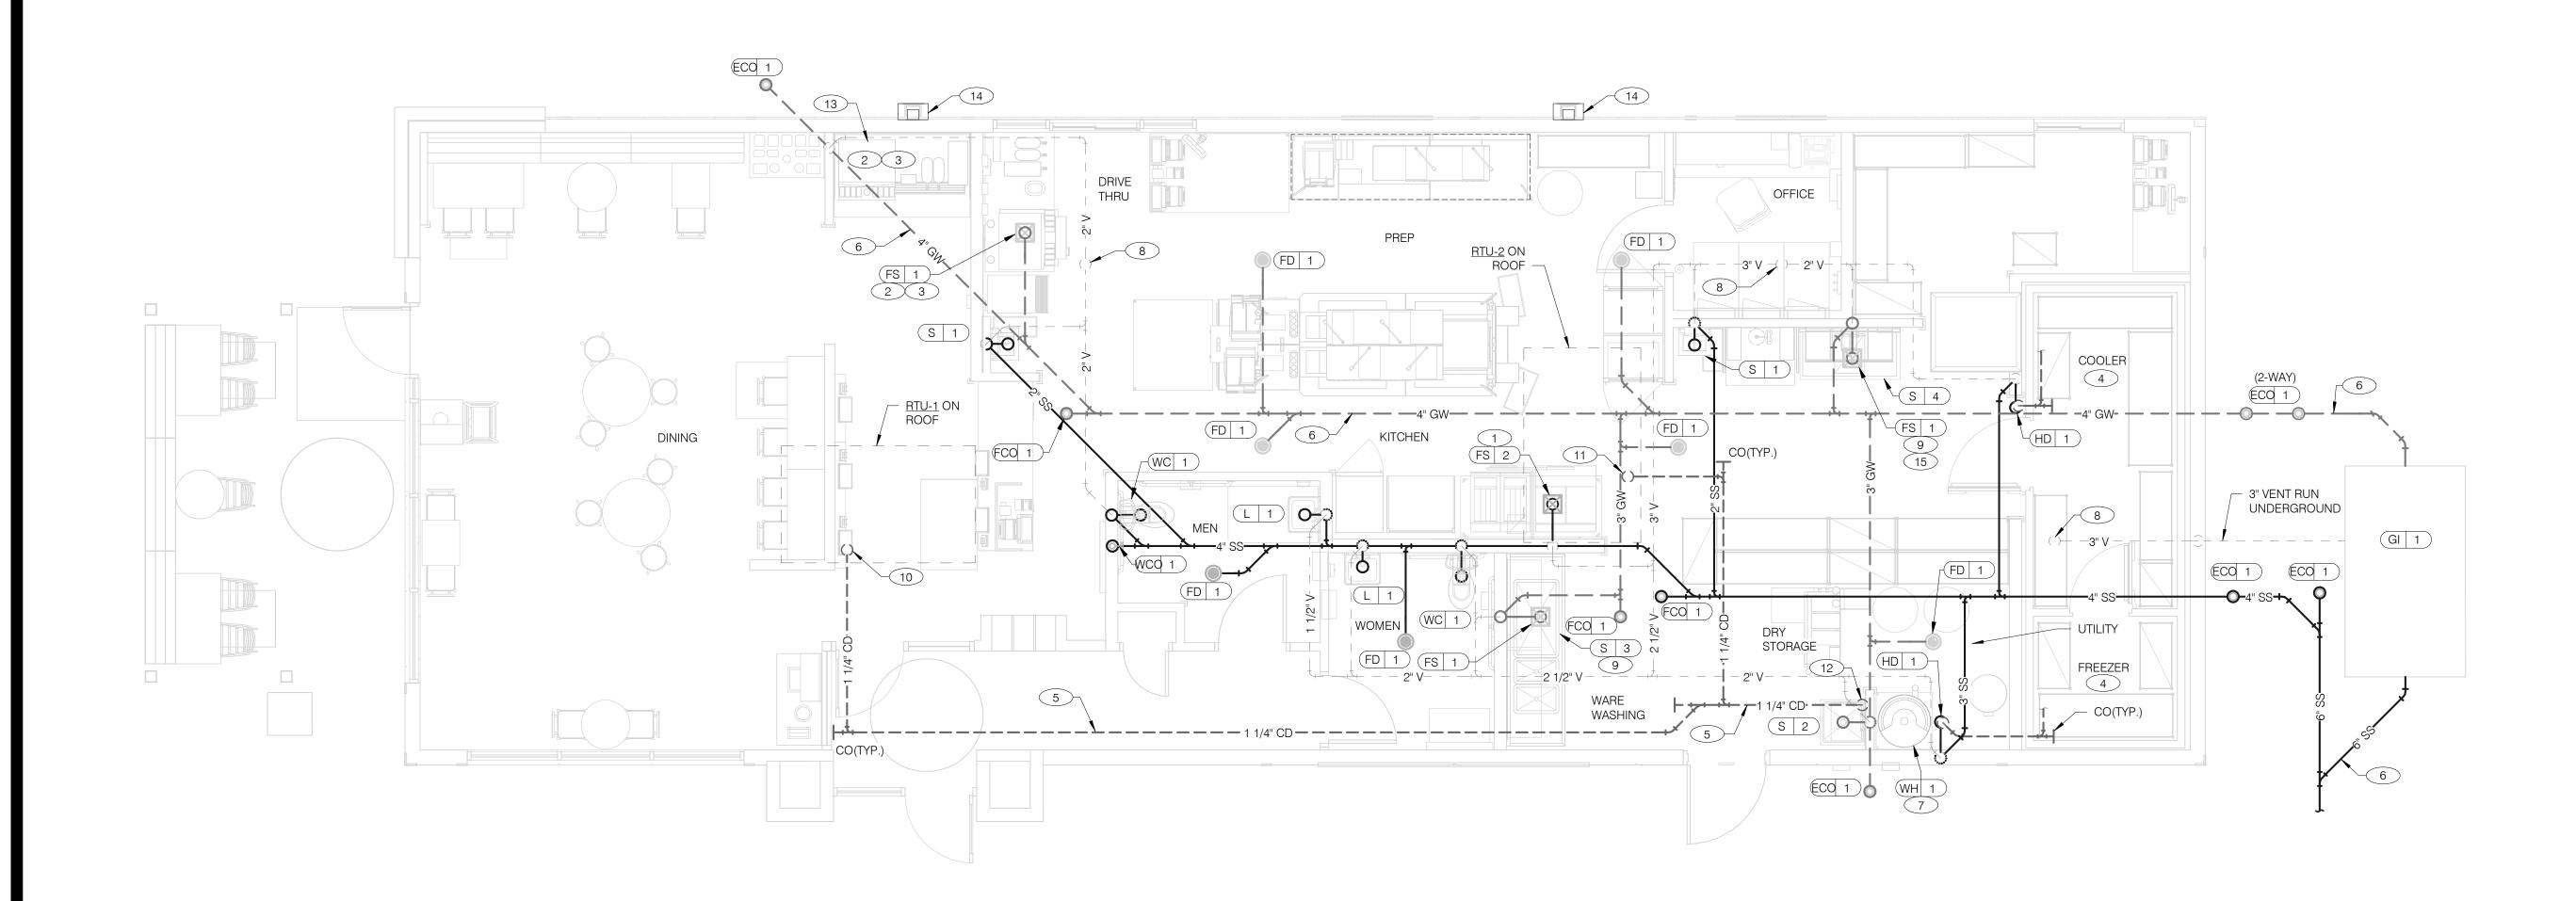

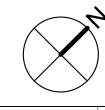

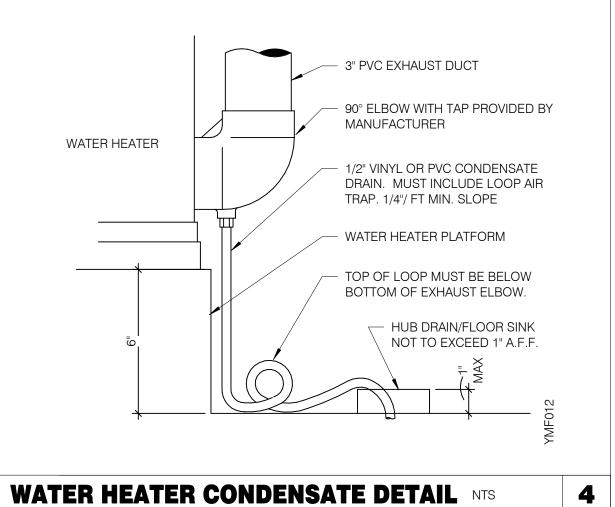

- A. NO ROOF PENETRATIONS PERMITTED WITHIN ROOF WATER PLY. REFER TO ROOF PLAN FOR LOCATIONS.
- B. REFER TO RISER DIAGRAM ON SHEET P5.0 FOR ALL WASTE AND VENT SIZES.

WASTE & VENT PLAN NOTES NTS

- C. SEE ARCHITECTURAL PLANS FOR DOWNSPOUT LOCATIONS
- D. VERIFY WITH THE LOCAL BUILDING AUTHORITY THAT CONDENSATE DRAINAGE CAN BE ROUTED TO THE MOP SINK.
- (1) UNDERGROUND SANITARY PIPE SHALL BE NO HUB CAST IRON PIPE FOR THE FIRST 10 FEET FROM CONNECTION TO FLOOR SINK FS-2, OUTWARD.
- 2 PROVIDE DEDICATED CONDENSATE LINE AND DRAIN LINE FROM ICE MACHINE TO THE FS UNDERNEATH THE DRIVE THRU SODA MACHINE. PROVIDE AIR GAP PER LOCAL CODE.
- 3 PROVIDE DEDICATED WASTE LINES FROM BEVERAGE UNIT TO THE FS UNDERNEATH THE DRIVE THRU SODA MACHINE. PROVIDE AIR GAP PER LOCAL
- PROVIDE 3/4" COPPER CONDENSATE FROM DRAIN PROVIDED BY VENDOR TO OUTFALL AT HUB DRAIN/MOP SINK (HEAT ROPE IS SUPPLIED WITH FREEZER CONDENSATE). CONCEAL CONDENSATE PIPE IN WALL.
- (5) PVC OR COPPER CONDENSATE DRAIN FROM HVAC UNITS ON ROOF. RUN TO MOP SINK. PIPING SHALL SLOPE 1/4" PER FOOT AND SHALL BE INSULATED WITH 1" CLOSED CELLULAR INSULATION. REFER TO RISER DIAGRAM ON SHEET P5.0 FOR PIPE SIZES.
- 6 ENTIRE RUN OF DRAIN LINES TO INLET OF EXTERIOR GREASE INTERCEPTOR AND OUTBOUND FROM INTERCEPTOR TO CONNECTION AT SANITARY MAIN SHALL BE SCHEDULE 40 PVC DWV OR AS REQUIRED BY AUTHORITY HAVING JURISDICTION.
- 7 ROUTE INDIRECT WASTE FROM WH-1 TO HD-1. REFERENCE DETAIL 2/P6.0 AND DETAIL 4/P2.0.
- 8 3" VENT UP THROUGH ROOF.

3

9 PIPE THREE COMP. SINK / PREP SINK TO FLOOR SINK WITH AIR GAP PER CODE.

WASTE & VENT PIPING PLAN 1/4" = 1'-0" 1

- 10 1-1/4" CONDENSATE DRAIN DOWN FROM RTU-1. SEE DETAIL 10/P6.0.
- 11 1-1/4" CONDENSATE DRAIN DOWN FROM RTU-2. SEE DETAIL 10/P6.0.
- (12) CONDENSATE DRAIN PIPE DOWN TO MOP SINK. PROVIDE AIR GAP AS REQUIRED BY CODE. IF REQUIRED RUN CONDENSATE PIPING TO EXTERIOR DRYWELL, RETENTION AREA OR STORM SEWER AS DIRECTED BY AUTHORITY HAVING
- 13 RUN DRAIN LINE FROM S/S DRINK MACHINE THROUGH WALL OPENING. TO OUTFALL AT FS BENEATH D/T DRINK MACHINE.
- 14 DOWN SPOUT. SEE CIVIL PLANS FOR CONTINUATION AND ARCHITECTURAL PLANS FOR MORE DETAIL.
- 15 ROUTE DRAIN FOR REVERSE OSMOSIS DISCHARGE TO FLOOR SINK. ENSURE PROPER AIR GAP.

BELL.
ENDEAVOR 2.0
WASTE AND
VENT PLAN

TACO BELL

1551 West River Rd.

Elyria, OH

08.09.22 IFB

END. MED20

MARCH 2021

DICKSON

315672

455386

2021088.52

CONTRACT DATE: BUILDING TYPE:

PLAN VERSION:

SITE NUMBER:

PA/PM:

DRAWN BY.:


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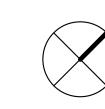
STORE NUMBER:

BRAND DESIGNER:

KEYNOTES - WASTE AND VENT NTS





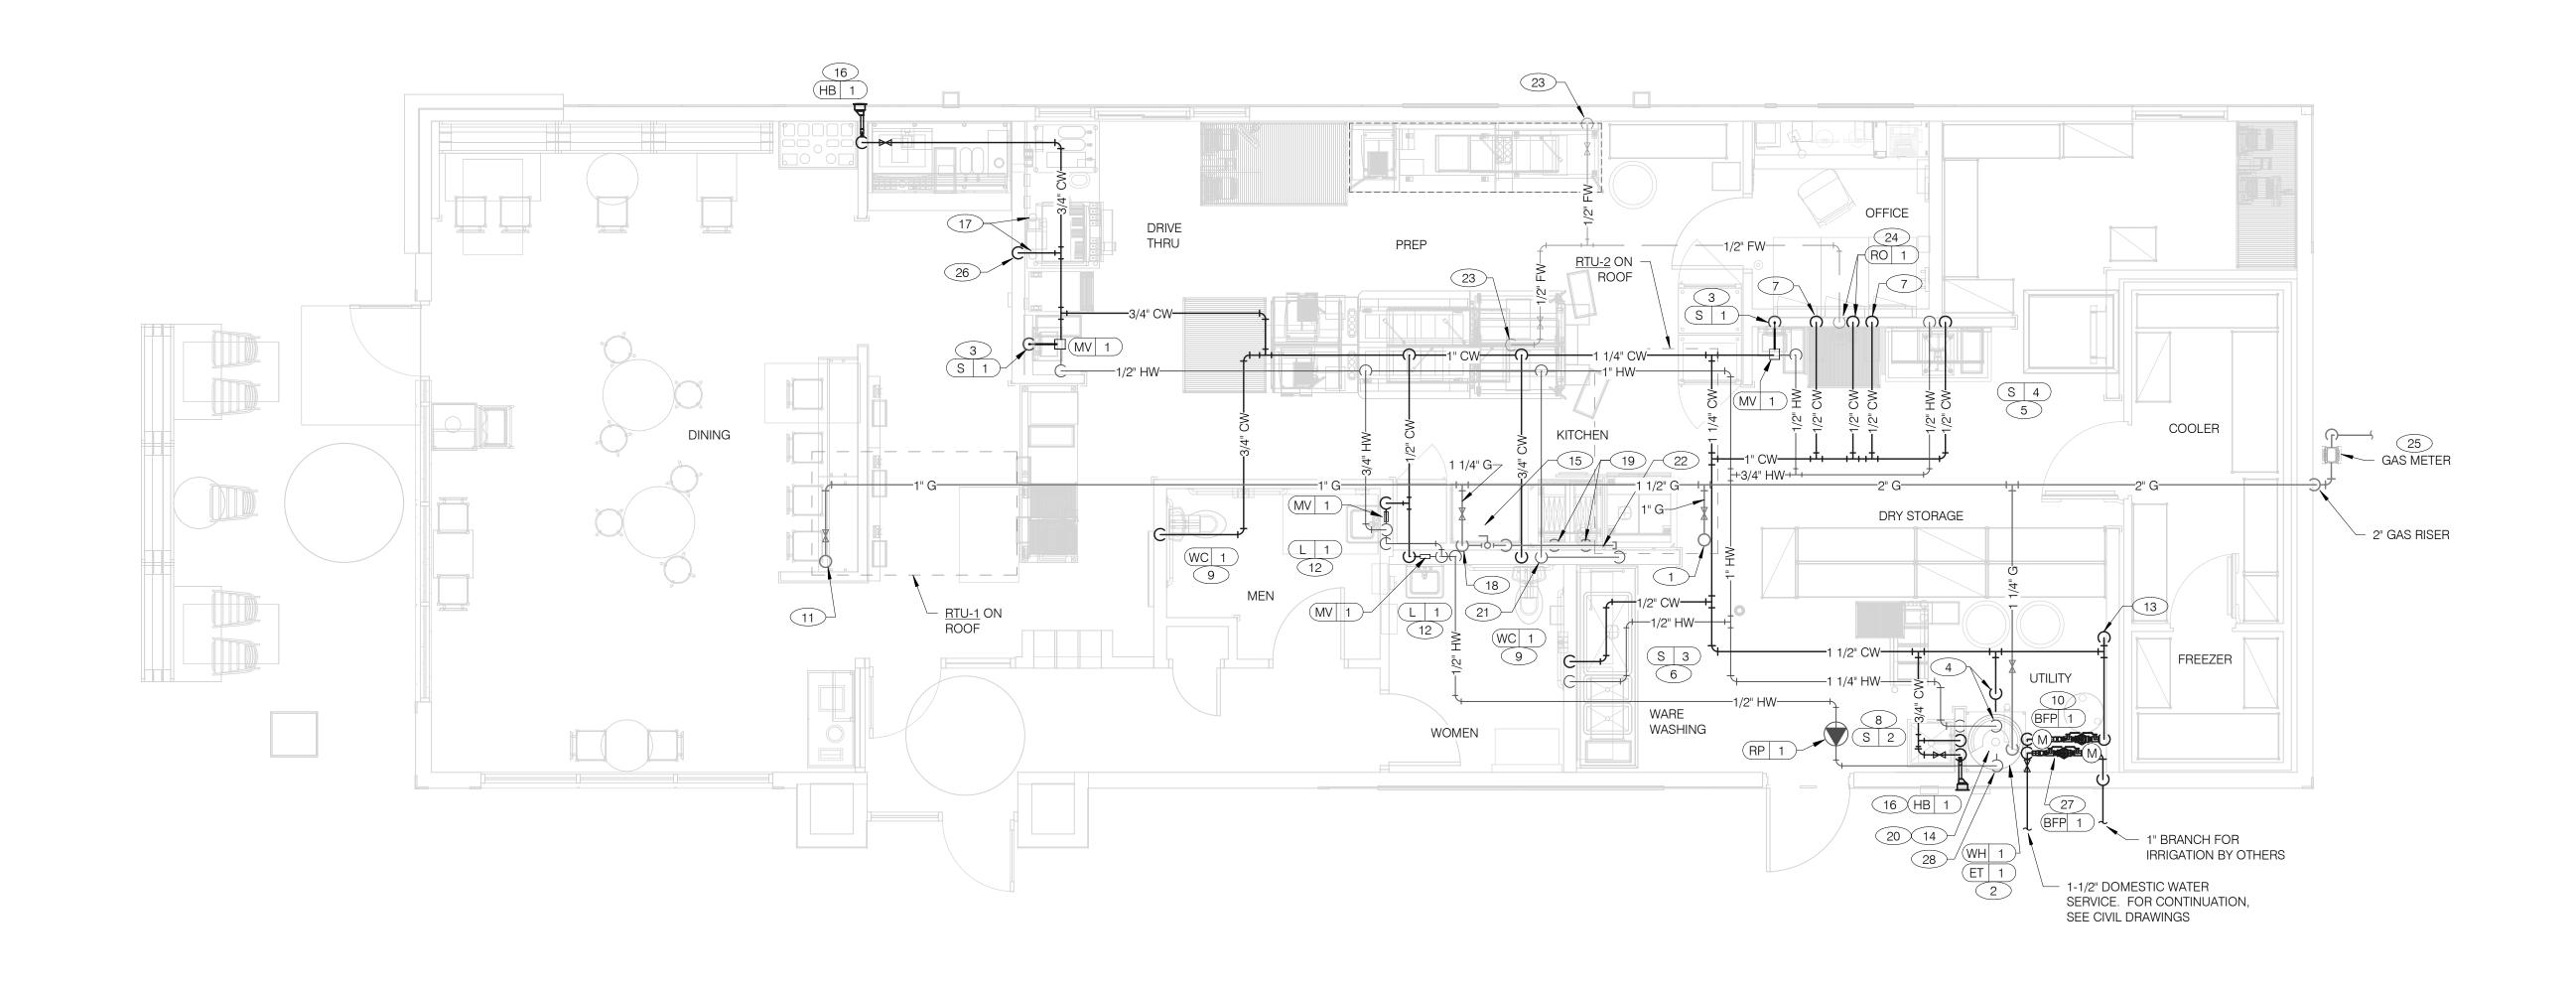

WATER & GAS PLAN 1/4" = 1'-0" **1**

NO ROOF PENETRATIONS PERMITTED WITHIN ROOF "WATER VALLEYS". REFER TO ROOF PLAN FOR LOCATIONS.

REFER TO SHEET P4.0 FOR ROUGH-IN LOCATIONS.

REFER TO SHEET P5.0 FOR WATER AND GAS ISOMETRIC DRAWINGS.

FLUSH ALL WATER SUPPLY LINES OF ALL DEBRIS AND IMPURITIES PRIOR TO CONNECTING TO WATER FILTERS.

PROVIDE REDUCED PRESSURE BACKFLOW PREVENTER TO SERVE CARBONATOR. DRAIN RELIEF TO FLOOR SINK WITH AIR GAP

1" (180 CFH) GAS UP TO RTU-2 WITH DIRT LEG, GAS COCK AND UNION.

2 1-1/4" (199 CFH) GAS DOWN TO WATER HEATER WITH GAS COCK, DIRT LEG AND

3 1/2" TEMPERED WATER DOWN IN WALL TO HAND SINK.

1-1/4" HOT AND 1-1/4" COLD WATER LINES DOWN TO WATER HEATER.

5 1/2" HOT AND COLD WATER LINES DOWN IN WALL TO PREP SINK. 6 1/2" COLD AND HOT WATER LINES DOWN IN WALL TO THREE COMP. SINK.

7 1/2" COLD WATER 2'-0" A.F.F. . CONNECT TO WATER FILTER FOR HOT WATER SYSTEM, P-452. PROVIDE SHUT-OFF VALVE PRIOR TO CONNECTION TO WATER

8 1/2" COLD AND HOT WATER DOWN IN WALL TO MOP SINK.

9 3/4" CW DOWN IN WALL TO FLUSH TANK WATER CLOSET .

10 LOCATE REDUCED PRESSURE BACKFLOW PREVENTER AND 1" WATER METER INSIDE BUILDING PER LOCAL AUTHORITY REQUIREMENTS FOR WATER SERVICE. REFER TO CIVIL PLANS FOR CONTINUATION AND FURTHER INFORMATION.

1" (180 CFH) GAS UP TO RTU-1 WITH DIRT LEG, GAS COCK AND UNION.

1/2" TEMPERED WATER LINES DOWN IN WALL TO LAVATORY.

13 3/4" CW DOWN ALONG WALL TO WATER FILTER SYSTEM, S-286 AND BOOSTER TANK, S-540.

WATER HEATER (WH-1). PIPE CONDENSATE LINE. T&P DISCHARGE AND DRAIN PAN TO HUB DRAIN. SEE WATER HEATER DETAIL 2/P6.1.

15 EMERGENCY GAS SHUT OFF VALVE LOCATED BELOW CEILING.

16 3/4" CW DOWN IN WALL TO EXTERIOR HOSE BIBB.

17 BUNDLED SYRUP LINES TO BEVERAGE DISPENSERS S-284 & S-285 AND FILTERED WATER LINES TO ICE MAKERS S-513 AND FROZEN BEVERAGE DISPENSER S-546. SEE DRAWINGS A2.0 AND P5.0.

18 1-1/4" GAS DOWN ALONG WALL TO COOKING EQUIPMENT. VERTICAL GAS PIPING IN WALL SHALL NOT BE RIGIDLY SECURED AND ADEQUATE PIPE PROTECTION SHALL BE

19 3/4" GAS DIRT LEG W/ GAS COCK TO COOKING EQUIPMENT. PROVIDE FLEXIBLE GAS HOSE KIT FOR CONNECTION TO COOKING EQUIPMENT.

20 3" PVC EXHAUST AND INTAKE FLUES FROM WATER HEATER, PIPE THROUGH ROOF AS RECOMMENDED BY MANUFACTURER TO LOCATIONS SHOWN ON SHEET M2.0. SEE

21) 1/2" HOT WATER DOWN IN WALL TO RETHERMALIZER C-107. PROVIDE SHUT-OFF VALVE OUTSIDE OF WALL FOR CONNECTION TO RETHERMALIZER.

22 RUN GAS PIPE 18" A.F.F. WITH DIRT LEGS FOR GAS HOSE KITS TO COOKING EQUIPMENT C-026 AND C-107.

23 1/2" RO WATER PIPE DOWN IN WALL AND ROUTED IN LOW WALL OF DRY PRODUCTION LINE. PROVIDE SHUT-OFF VALVE ON RO PIPING IN CEILING NEAR CHASE.

1/2" COLD WATER TO REVERSE OSMOSIS FILTER P-315 AND 1/2" FILTER WATER FROM REVERSE OSMOSIS FILTER. PROVIDE SHUT-OFF VALVE ON CW PIPE PRIOR TO CONNECTION TO FILTER. SEE DETAIL 9/P6.0.

25 GAS METER, REGULATOR VALVES, BRACKETS, ETC. AS REQUIRED BY LOCAL GAS COMPANY. SEE CIVIL DRAWINGS FOR CONTINUATION.

26 1/2" COLD WATER. CONNECT TO WATER FILTER FOR BUNN POD BREWER S-547. PROVIDE SHUT-OFF VALVE PRIOR TO CONNECTION TO WATER FILTER.

27 LOCATE REDUCED PRESSURE BACKFLOW PREVENTER AND 1" DEDUCT METER FOR IRRIGATION SYSTEM INSIDE BUILDING PER LOCAL AUTHORITY REQUIREMENTS.

28 1/2" HOT WATER RETURN DOWN TO WATER HEATER HOT WATER RETURN INLET.

KEYNOTES - WATER AND GAS NTS

DATE	REMARKS
08.09.22	IFB

CONTRACT DATE: END. MED20 BUILDING TYPE: PLAN VERSION: MARCH 2021 BRAND DESIGNER: DICKSON SITE NUMBER: 315672 STORE NUMBER:

PA/PM:

DRAWN BY.: JOB NO.: 2021088.52


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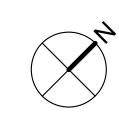
1551 West River Rd. Elyria, OH



ENDEAVOR 2.0 WATER AND **GAS PLAN**





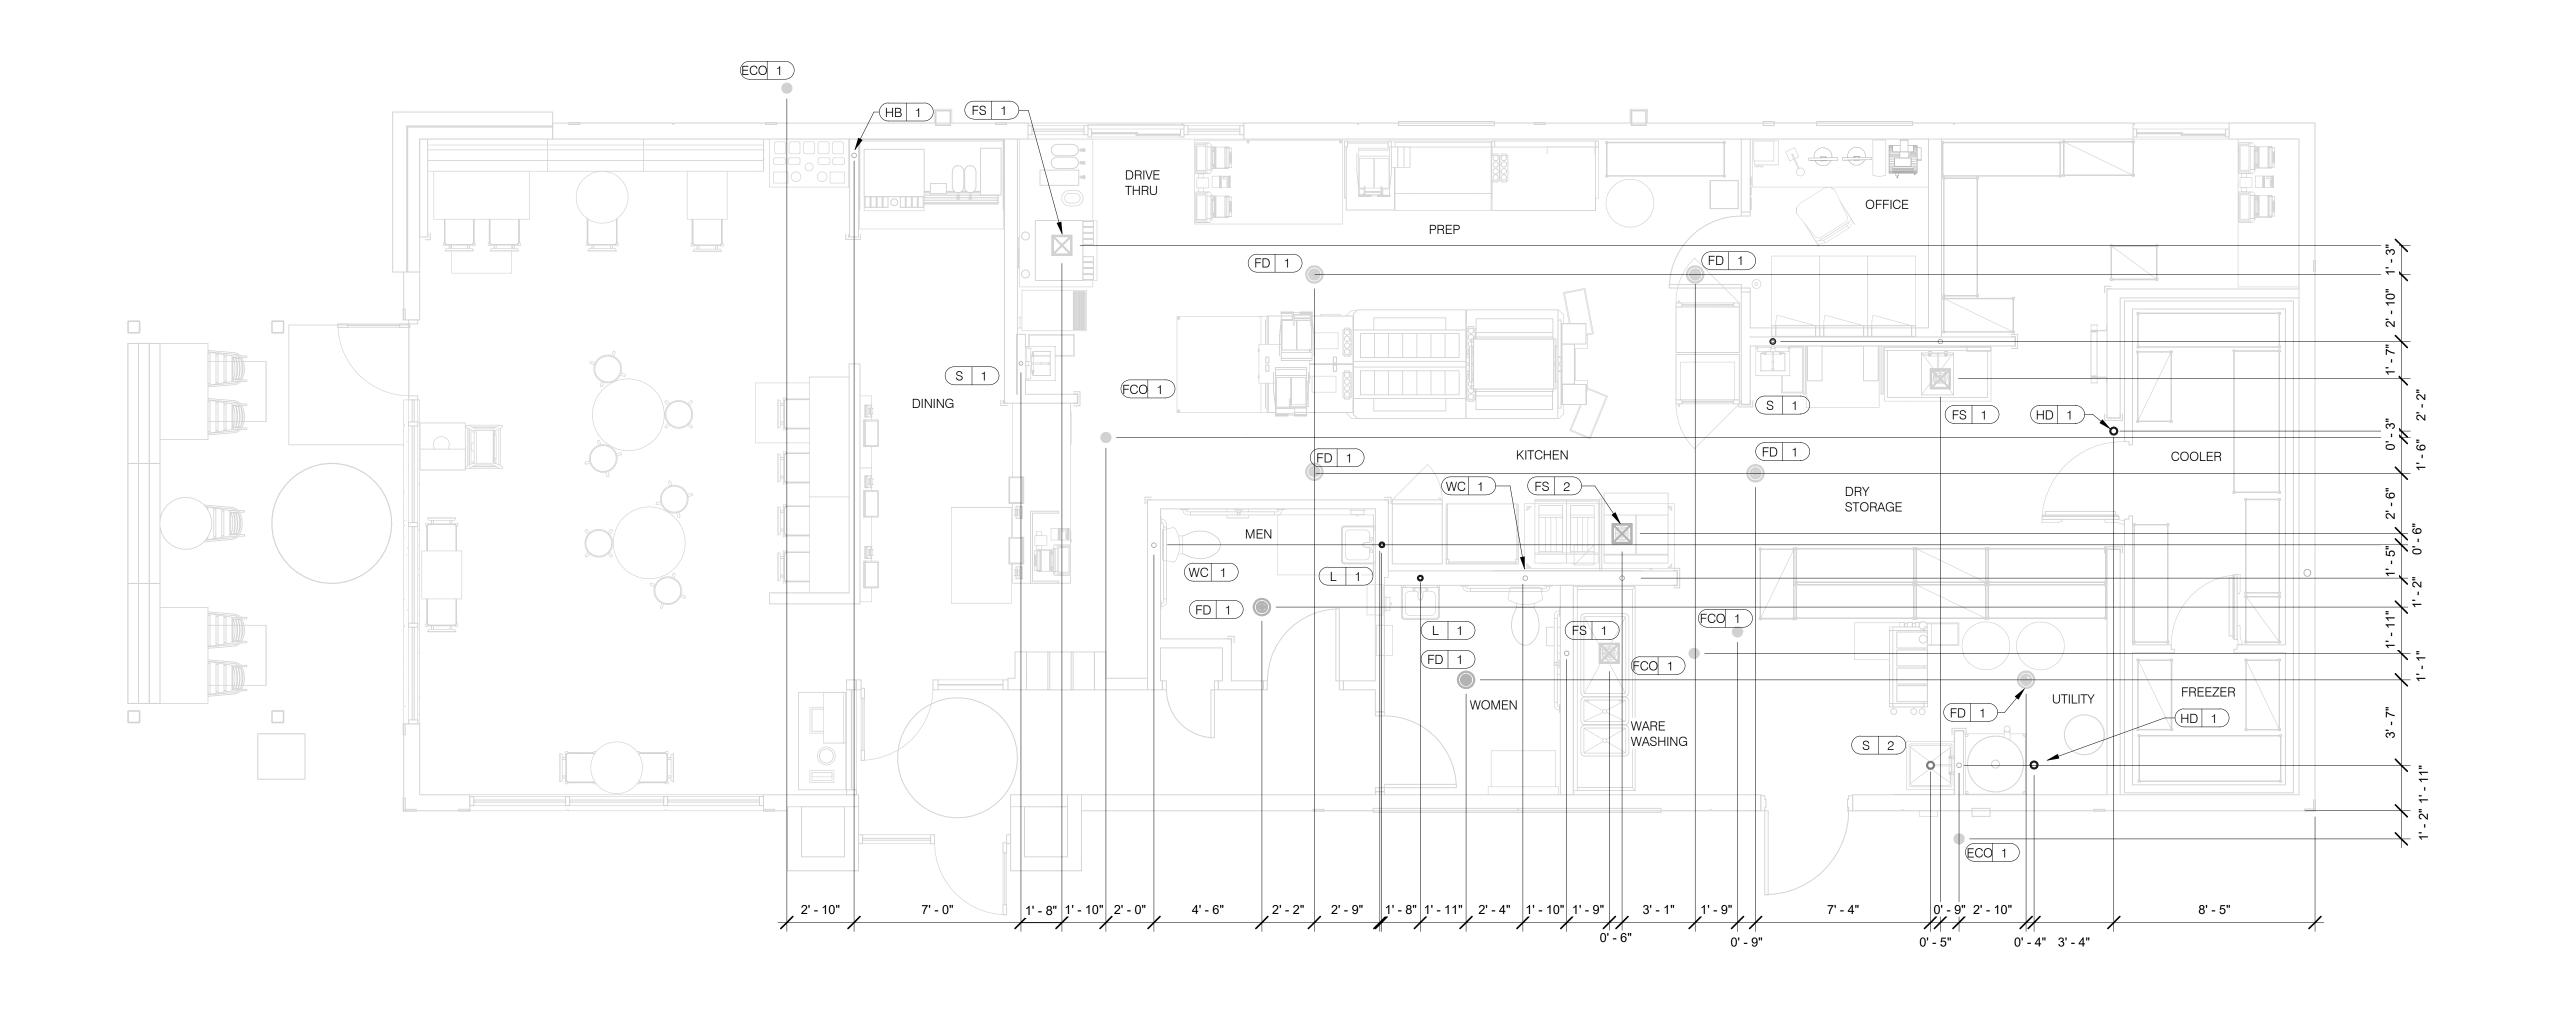

PLUMBING ROUGH-IN PLAN 1/4" = 1'-0" 1

1.	ALL DIMENSIONS TO FLOOR SINKS, FLOOR DRAINS AND HUB DRAINS ARE CENTER OF FIXTURE.

) 	IT IS THE RESPONSIBILITY OF THE CONTRACTOR TO COORDINATE THIS DATA
	ON LOCATION OF ALL PLUMBING ROUGH-INS WITH INFORMATION PROVIDED
	ON ARCHITECTURAL AND STRUCTURAL DRAWINGS AND EQUIPMENT
	ACTUALLY SUPPLIED AND TO CONFIRM CORRECTNESS OF DIMENSIONS
	INDICATED HEREIN.

CON	ITRACT DAT	10.05.21	
BUIL	DING TYPE	END. MED20	
PLA	N VERSION:		MARCH 2021
BRAND DESIGNER:			DICKSON
SITE	NUMBER:		315672
STO	RE NUMBER	455386	

08.09.22 IFB

TACO BELL

1551 West River Rd. Elyria, OH

DRAWN BY.:




ENDEAVOR 2.0 PLUMBING ROUGH-IN PLAN


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EQUIP #	EQUIPMENT ITEM TYPE	ELEVATION	REMARKS	EQUIP #	EQUIPMENT ITEM	TYPE	ELEVATION	REMARKS
FS 1	FLOOR SINK			S 3	3-COMPARTMENT SINK FAUCET	CW/HW	+38" A.F.F	
FS 2	FLOOR SINK		EPOXY COATED CAST IRON	S 4	PREP SINK	W	+19" A.F.F	
(HD 1)	HUB DRAIN			S 4	PREP SINK FAUCET	CW/HW	+38" A.F.F	
WH 1	WATER HEATER CW			(WCO 1	WALL CLEAN OUT			
WH 1	WATER HEATER G	+15" A.F.F.		FCO 1	FLOOR CLEAN OUT			
WC 1	WATER CLOSET CW	+29" A.F.F	BOTH HANDICAP AND REGULAR	(HB 1	HOSE BIB			
UR 1	URINAL FLUSH VALVE CW	+47" A.F.F.	WALL MOUNTED					
UR 1	URINAL WASTE STUB W	+16-1/2" A.F.F.	WALL MOUNTED					
L 1	LAVATORY	+20" A.F.F.		⟨C-107⟩	RETHERMALIZER	HW	+8" A.F.F.	
L 1	LAVATORY WASTE LINE W	+16-1/2" A.F.F.		⟨C-107⟩	RETHERMALIZER	G	+12" A.F.F.	
RO 1	REVERSE OSMOSIS CW	+84" A.F.F		(C-026)	DUAL VAT FRYER	G	+12" A.F.F.	
S 1	HAND SINK TW	+18" A.F.F	RIM OF LAV @ +2'-8" A.F.F.					
S 2	MOP SINK W	-6" A.F.F.	RECESSED IN FLOOR					
S 2	MOP SINK FAUCET CW/HW	+36" A.F.F		⟨S-286⟩	WATER FILTER SYSTEM	CW	+94" A.F.F.	INLET TO & OUTLET FROM FILTER
S 2	MOP SINK FAUCET CW/HW	+42" A.F.F	CLOSET MOP SINK ONLY					
S 3	3-COMPARTMENT SINK W	+19" A.F.F		(P-452)	HOT WATER SYSTEM	CW	+24" A.F.F.	

GPD GROUP

520 S. MAIN STREET, SUIT 2531 AKRON, OH 44311 330.572.2100 FAX: 330.572.2102 Copyright; Glaus, Pyle, Schomer, Burns & DeHaven, Inc. 2021



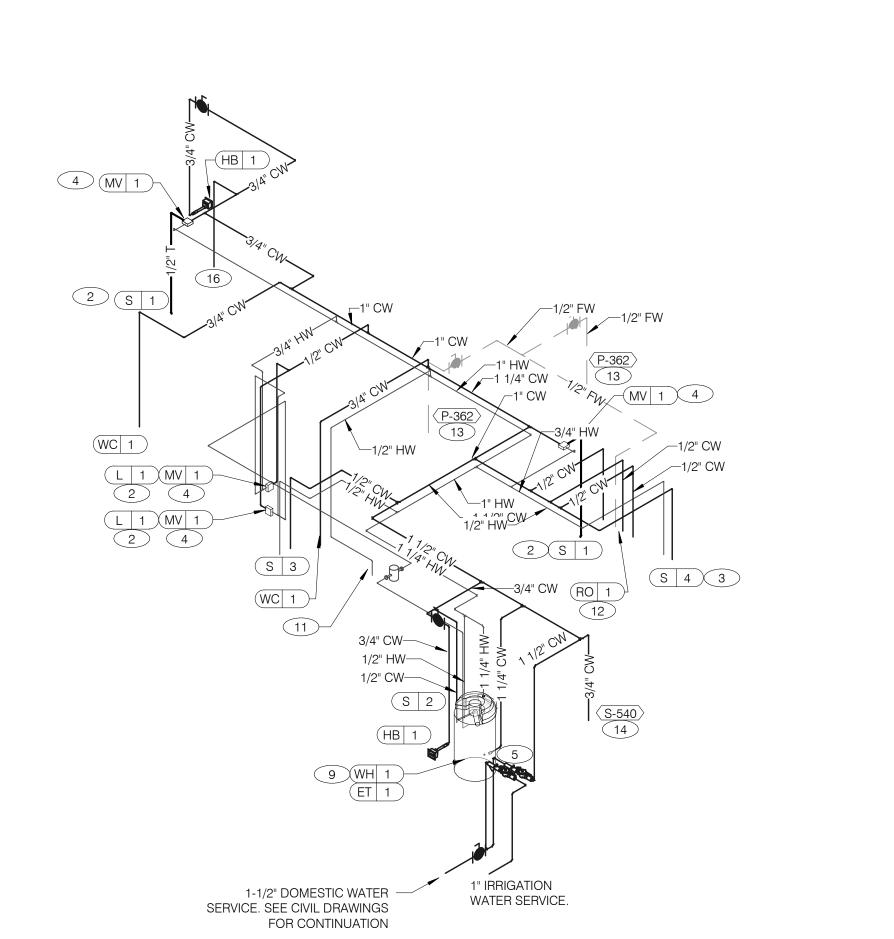


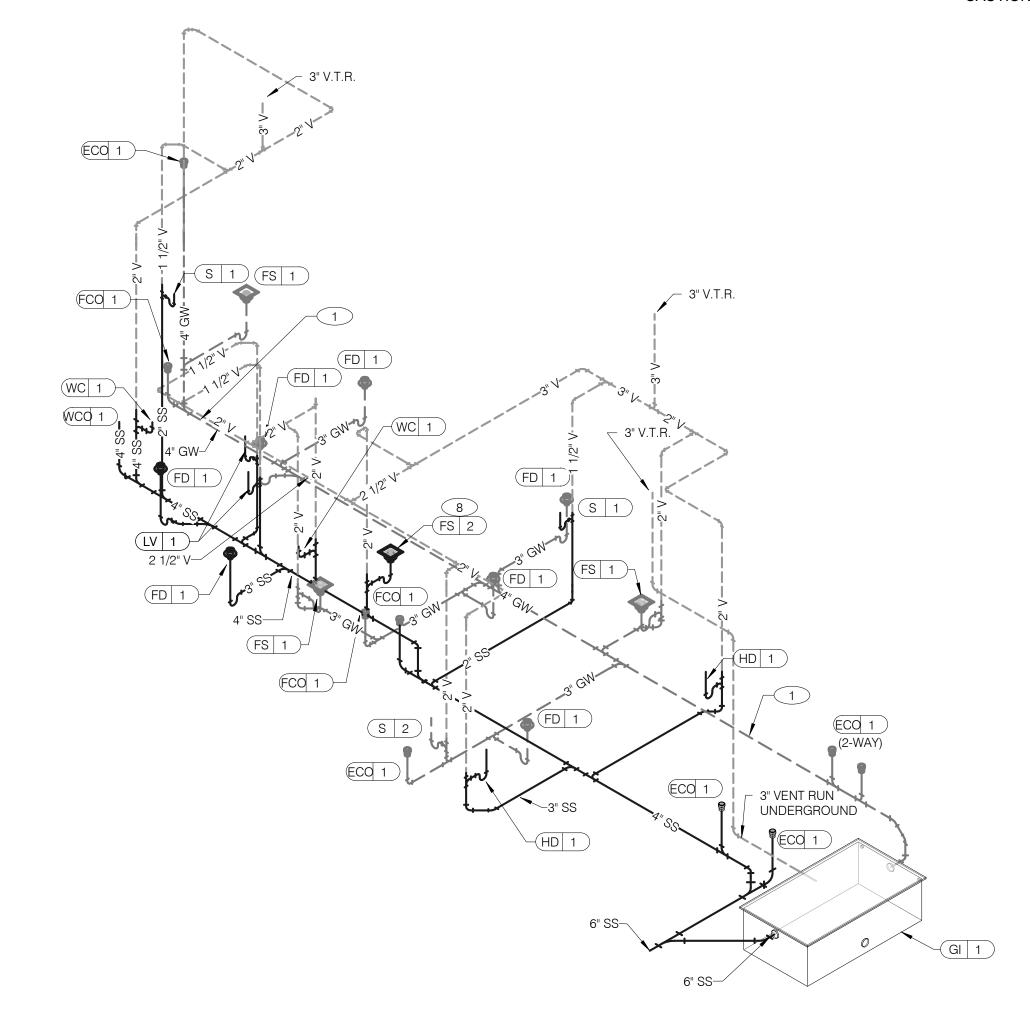WASTE AND VENT ISOMETRIC NTS


GAS DEMAND SCHEDULE 180 CFH RTU-2 180 CFH 199 CFH WH-1 **DUAL FRYER** 160 CFH RETHERMALIZER 110 CFH 829.0 CFH = 829,000 BTUH DEMAND

COORDINATE GAS DEMAND REQUIREMENTS WITH SITE-SPECIFIC RTU DESIGN.

PIPE SIZE BASED ON 100' OF PIPE AND 7" W.C. OPERATING PRESSURE

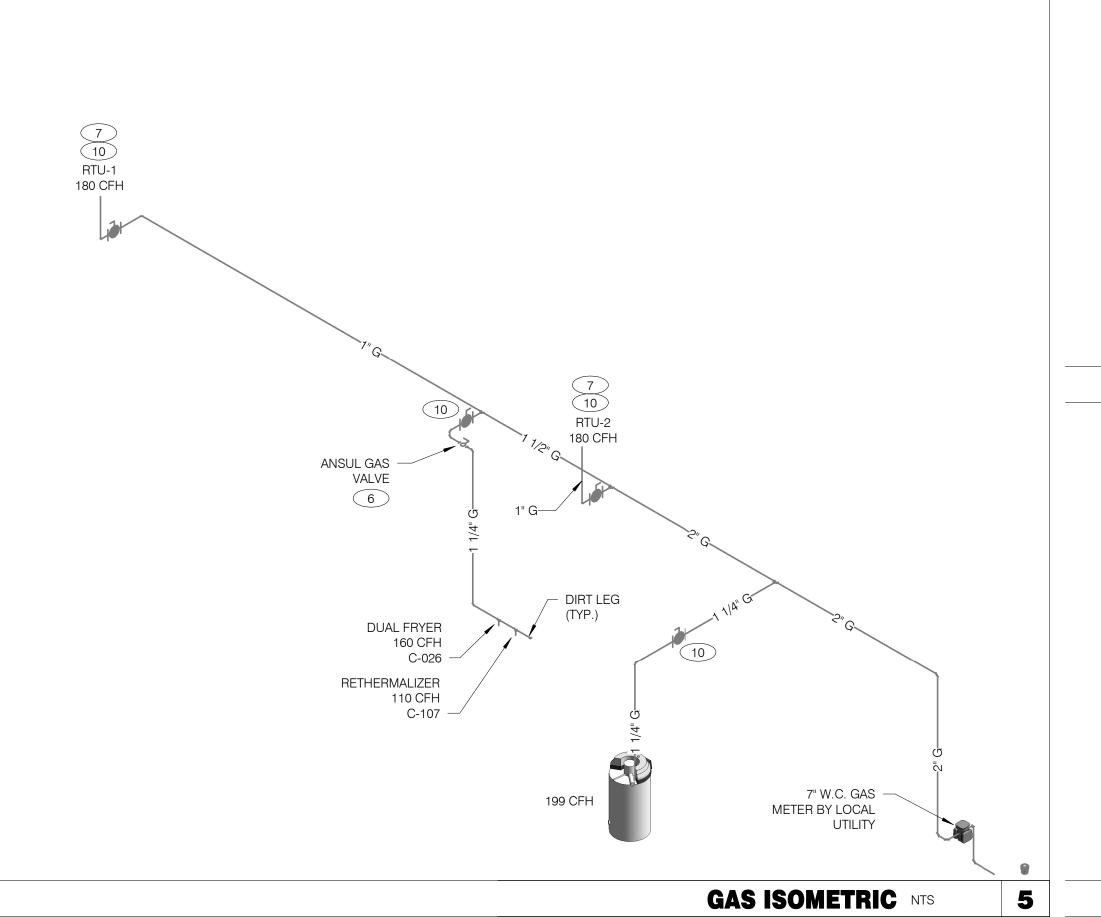

WATER ISOMETRIC NTS

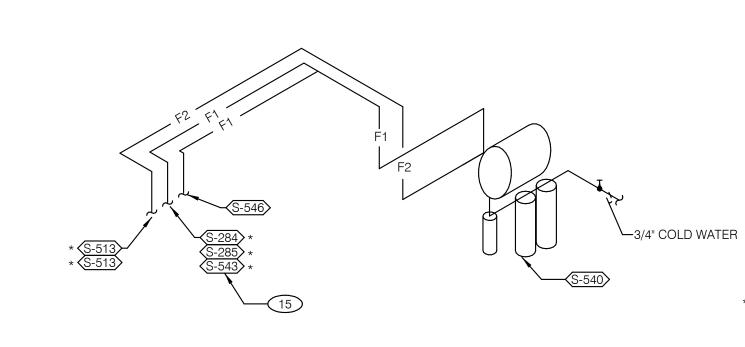

FILTERED EQUIPMENT AND LINES:

FILTERED LINE (COLD WATER)

S-513 - ICE MAKER - ABOVE SELF-SERVE BEVERAGE DISPENSER *

S-513 - ICE MAKER - ABOVE DRIVE-THRU BEVERAGE DISPENSER *

S-285 - DRIVE-THRU BEVERAGE DISPENSER *

S-284 - SELF-SERVE BEVERAGE DISPENSER *

S-546 - ICED TEA BREWER

-3/4" COLD WATER S-543 - FROZEN BEVERAGE DISPENSER

FILTERED WATER SUPPLIED VIA SYRUP BUNDLE. REFER TO 11/P6.0. SEE SCOPE OF WORK FOR RESPONSIBILITIES.

FILTERED WATER ISOMETRIC NTS

1 ENTIRE RUN OF DRAIN LINES ON INLET TO GREASE TRAP SHALL BE SCHEDULE 40 PVC OR NO HUB CAST IRON AS REQUIRED BY CODE.

2 1/2" TEMPERED WATER DOWN IN WALL TO HAND SINK / LAVATORY.

3 1/2" HOT AND COLD WATER LINES DOWN IN WALL TO PREP SINK.

4 THERMOSTATIC MIXING VALVE.

REDUCED PRESSURE BACKFLOW PREVENTERS AND WATER METERS PER LOCAL UTILITY REQUIREMENTS. PROVIDE SHUT-OFF VALVES AT BOTH SIDES OF BACKFLOW PREVENTER.

6 EMERGENCY GAS SHUT-OFF VALVE (NORMALLY CLOSED) SHALL BE ELECTRIC SOLENOID TYPE WITH SPRING RETURN AND 24 VOLT ACTUATOR, SUITABLE FOR USE ON GAS PIPING SYSTEMS. VALVE SHALL BE ACTIVATED BY ANY OF THE EXHAUST HOOD FIRE SUPPRESSION SYSTEM. PROVIDE RELAYS AS REQUIRED TO ACTIVATE SHUT-OFF VALVE.

GAS PIPING AT ROOF TOP UNIT FOR THROUGH THE BASE PIPE CONNECTION. SHUT-OFF VALVE SHALL BE LOCATED OUTSIDE OF THE UNIT.

8 PROVIDE NO HUB CAST IRON PIPE FOR FIRST 10 FEET OF PIPE FROM CONNECTION TO FLOOR SINK FS-2

9 PIPE T&P RELIEF VALVE TO OUTSIDE OF BUILDING OR TO HUB DRAIN. RUN FULL SIZE PIPE FROM VALVE WITH TYPE "K" COPPER TUBING.

10 PROVIDE GAS SHUT-OFF VALVE IN CEILING SPACE.

11 1/2" HOT WATER PIPE DOWN IN WALL. PROVIDE SHUT-OFF VALVE OUTSIDE OF WALL FOR CONNECTION TO RETHERMALIZER.

1/2" COLD WATER CONNECT TO REVERSE OSMOSIS FILTER AND 1/2" FILTERED WATER FROM REVERSE OSMOSIS FILTER. PROVIDE SHUT-OFF ON CW PIPE PRIOR TO CONNECTION TO FILTER.

13 1/2" RO WATER FROM REVERSE OSMOSIS FILTER DOWN IN UTILITY CHASE OF M.A.P.S. LINE. PROVIDE SHUT-OFF VALVE ON FW PIPE IN CEILING NEAR UTILITY

1/2" COLD WATER TO HOT WATER SYSTEM FILTER.

15 TEE OFF 3/8" LINE FROM DRIVE THRU BEVERAGE DISPENSER FILTERED WATER SUPPLY. SEE DETAIL 8/P6.0.

16 1/2" COLD WATER. CONNECT TO WATER FILTER FOR BUNN POD BREWER S-547. PROVIDE SHUT-OFF VALVE PRIOR TO CONNECTION TO THE WATER FILTER.

DATE	REMARKS
08.09.22	IFB

CONTRACT DATE: BUILDING TYPE: END. MED20 PLAN VERSION: MARCH 2021 BRAND DESIGNER: DICKSON SITE NUMBER: 315672 STORE NUMBER: 455386 PA/PM: DRAWN BY.: JOB NO.: 2021088.52

TACO BELL


1551 West River Rd. Elyria, OH



ENDEAVOR 2.0 RISER DIAGRAMS

KEYNOTES - ISOMETRICS NTS

2

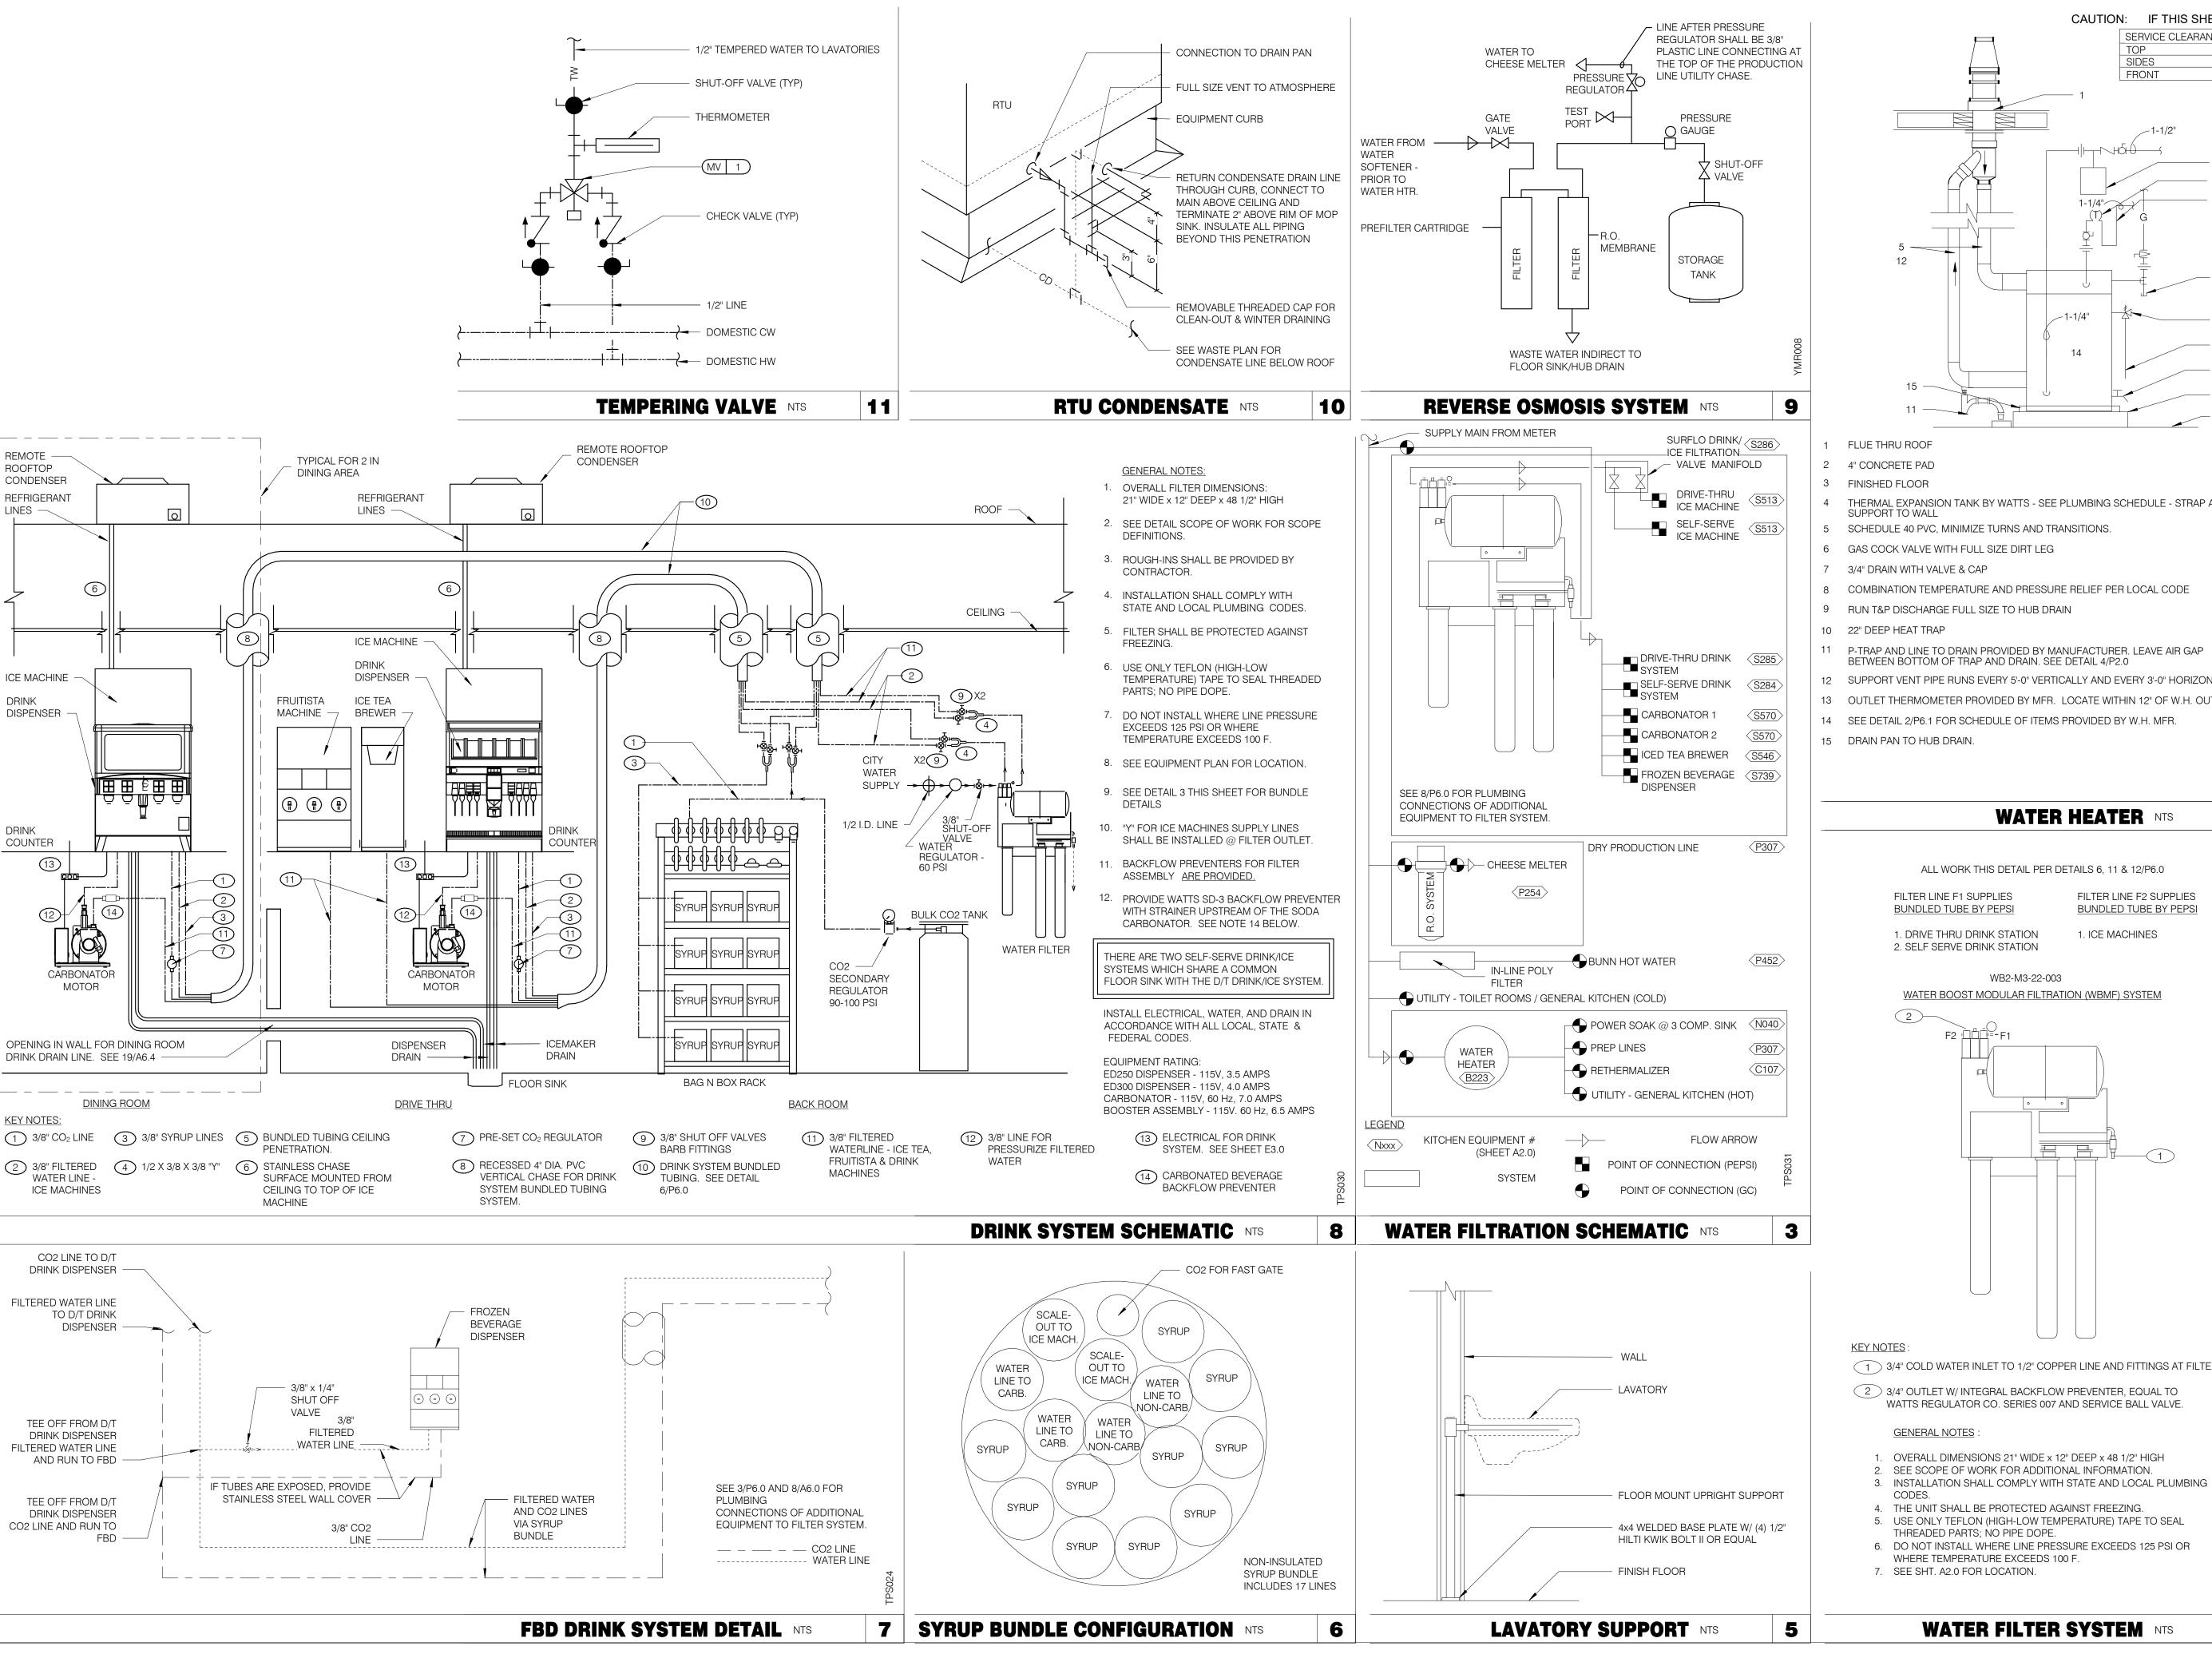

CAUTION: IF THIS SHEET IS NOT 22"x34" IT IS A REDUCED PRINT SIDES FRONT _1-1/4"

- THERMAL EXPANSION TANK BY WATTS SEE PLUMBING SCHEDULE STRAP AND
- SCHEDULE 40 PVC, MINIMIZE TURNS AND TRANSITIONS.
- 6 GAS COCK VALVE WITH FULL SIZE DIRT LEG
- 3/4" DRAIN WITH VALVE & CAP
- COMBINATION TEMPERATURE AND PRESSURE RELIEF PER LOCAL CODE
- 9 RUN T&P DISCHARGE FULL SIZE TO HUB DRAIN
- 11 P-TRAP AND LINE TO DRAIN PROVIDED BY MANUFACTURER. LEAVE AIR GAP
- SUPPORT VENT PIPE RUNS EVERY 5'-0" VERTICALLY AND EVERY 3'-0" HORIZONTALLY.
- 13 OUTLET THERMOMETER PROVIDED BY MFR. LOCATE WITHIN 12" OF W.H. OUTLET.
- 14 SEE DETAIL 2/P6.1 FOR SCHEDULE OF ITEMS PROVIDED BY W.H. MFR.

WATER HEATER NTS


ALL WORK THIS DETAIL PER DETAILS 6, 11 & 12/P6.0

FILTER LINE F1 SUPPLIES FILTER LINE F2 SUPPLIES **BUNDLED TUBE BY PEPSI BUNDLED TUBE BY PEPSI**

1. DRIVE THRU DRINK STATION 2. SELF SERVE DRINK STATION

1. ICE MACHINES

WB2-M3-22-003

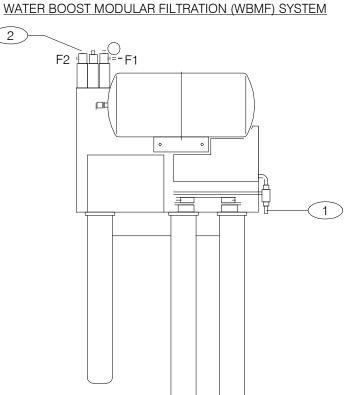

- 1 3/4" COLD WATER INLET TO 1/2" COPPER LINE AND FITTINGS AT FILTER.
- 2 3/4" OUTLET W/ INTEGRAL BACKFLOW PREVENTER, EQUAL TO WATTS REGULATOR CO. SERIES 007 AND SERVICE BALL VALVE.

GENERAL NOTES

- 1. OVERALL DIMENSIONS 21" WIDE x 12" DEEP x 48 1/2" HIGH
- SEE SCOPE OF WORK FOR ADDITIONAL INFORMATION.
- 4. THE UNIT SHALL BE PROTECTED AGAINST FREEZING.
- THREADED PARTS; NO PIPE DOPE 6. DO NOT INSTALL WHERE LINE PRESSURE EXCEEDS 125 PSI OR
- WHERE TEMPERATURE EXCEEDS 100 F.
- 7. SEE SHT. A2.0 FOR LOCATION.

WATER FILTER SYSTEM NTS

08.09.22 IFB

GPD GROUP

520 S. MAIN STREET, SUIT 2531

330.572.2100 FAX: 330.572.2102 Copyright; Glaus, Pyle, Schomer, Burns & DeHaven, Inc. 2021

CONTRACT DATE: BUILDING TYPE: END. MED20 PLAN VERSION: MARCH 2021 **BRAND DESIGNER:** DICKSON SITE NUMBER: 315672 455386 STORE NUMBER: PA/PM: DRAWN BY.

TACO BELL

2021088.52

1551 West River Rd. Elyria, OH

JOB NO.:



ENDEAVOR 2.0 PLUMBING DETAILS

			Installation, Start Up and Pre-Com	miss	ioni	ng (Chec	klist		
					= R	espoi	nsible	Party		ت ت
				Init	4	•	Compl	•		CA-Commissioning Agent Functional Verification ICA Contracted by Owner)
)	RTO			_	-	ical	<u> </u>	ce		CA-Commissioning Age Functional Verification
	Multi-Speed RTU	nce #		eneral ctor	EC - Electrical Contractor	MC-Mechanical	mbing	AB-Air Balance Agency		mmiss onal V
	Multi-(Reference #	PROCESS	GC - General Contractor	EC - Electri	MC-Mecha	Contractor Contractor	AB-Air E Agency	Remarks	CA-Cor Function
	_	1	Package Units Reference and abide to all instructions in manufacturers Installation, Startup,		П	T = (, a (« T	1	
	Х	2	Operation and Maintenance literature							
	X		Units are set level Unit and plenums align to each other							
	Х		Units and plenums are properly sealed to each other All loose shipped components are relocated and installed per manufacturers							
	X	6	instructions a) economizer eyebrow, skirts and mist eliminator installed				_			
	Х	8	b) economizer dampers and linkage installed and operable							
	X	9 10	c) economizer wiring connected and completed d) relief damper or power exhauster installed and operable							
	х	11	e) smoke detectors and sample tubes relocated and installed per manufacurers instructions							
-	X	12 13	Utilities are installed and ON to the units a) power on and breakers sized to unit rating]		
1	Х	14	b) phases correct			J				
1	X	15 16	c) gas on d) gas gooseneck or pipe capacity meets or exceeds unit capacity							
	X	17 18	e) condensate line is piped per plan f) condensate vent is on leaving side of trap							
1		19	No thermostat, smoke detector, remote enunciator or any other wiring runs			T	7			
	Х	20	though the plenums Manufacturers start up procedure has been followed and all units evaporator fan							
1	Х	21	operates through all fan stages per manufacturers instructions							
	х	22	Manufacturers start up procedure has been followed and all units cycle through all heating stages per manufacturers instructions							
	х	23	Manufacturers start up procedure has been followed and all units cycle through all cooling stages per manufacturers instructions							
	Х	2/1	Manufacturers start up procedure has been followed and all units cycle through all economizer stages per manufacturers instructions							
1		25 26	<u> </u>							
		27	Dustrusuli							
	Х	29	Ductwork All ductwork and registers are installed per plan							
1	X		All starters and or take offs are radiused per plan. Ductwork from the exhaust register over production line to EF-2 fan base is 100%							
1	Х	31	rigid per plan Balance dampers are in sleeves on axles with locking quadrant, not located in any							
	X	32	starter collars, "T"s or "Y"s and located per plan							
	Х	34	Balance damper handles are flagged to identify their location							
\int		35 36	Economizer							
1	X	37 38	All mechanical components related to the economizer have been installed "Blank off" plate under economizer eyebrow has been installed							
1	Х	39	Barometric relief damper operates freely Input sensors for the Economizer have been properly located and connected to							
	Х	40	the Economizer							
	Х	41	Economizer has been tested to perform "Free" cooling when ambient conditions are below 55 degrees							
	X		Mechanical cooling stages on when Economizer cooling is not available Mechanical cooling stages on with the Economizer cooling when conditioned							
	X		space temperature rises and requires two stage cooling Economizer damper positions to minimum damper position when set							
1		45	Smoke Detectors							
	Х		Smoke Detectors Smoke detector option has been included in package unit				_			
	х		Return side smoke detector has been relocated from its shipping position to the							
	, ;		factory provided installation location in the return section of the package unit							
1	X		All smoke detector sample tubes are properly located per manufacturers design The return smoke detector in each unit has been tested for unit shutdown							
-	X		The supply smoke detector in each unit has been tested for unit shutdown							
	Х		Visual Verification installation certification document has been requested (certify@ace-bcx.com)and completed							
1	1		Remote Smoke Detector Enunciators and Resets							
1	х	55	A remote smoke detector enunciator and reset has been installed in the managers office for each package unit							
1	Х	56	RTU 1 supply side smoke detector alarm sets off the visual and audible remote After triggering RTU 1 supply side smoke detector alarm, resetting the remote							
	Х	5/	smoke detector reset for RTU 1 returns RTU 1 to normal operation							
	Х	58	RTU 1 return side smoke detector alarm sets off the visual and audible remote enunciator alarms and shuts down RTU 1							
	х	59	After triggering RTU 1 return side smoke detector alarm, resetting the remote smoke detector reset for RTU 1 returns RTU 1 to normal operation							
1	х	60	RTU 2 supply side smoke detector alarm sets off the visual and audible remote enunciator alarms and shuts down RTU 2							
	Х	61	After triggering RTU 2 supply side smoke detector alarm, resetting the remote							
1	X		smoke detector reset for RTU 2 returns RTU 2 to normal operation RTU 2 return side smoke detector alarm sets off the visual and audible remote							
	^		enunciator alarms and shuts down RTU 2 After triggering RTU 2 return side smoke detector alarm, resetting the remote							
1	Х	63	smoke detector reset for RTU 2 returns RTU 2 to normal operation Visual Verification installation certification document has been requested							
	Х		(certify@ace-bcx.com)and completed							
	1		Power Exhauster							
1	X		Power Exhauster has been installed Power Exhauster "On" setpoint has been set and turns on and off at correct							
1	хΙ	68						1	1	1

_							CAUTI	ON: IF TH	HIS SHEET IS NOT 22"x34" IT IS A REDUCED PRINT
			Installation, Start Up and Pre-Com	miss	ioni	ng Checklis	t		
						sponsible Party	,	nt er)	
				Initi	ial Wh	nen Completed		CA-Commissioning Agent Functional Verification (CA Contracted by Owner	GPD GROUP
ΙΤΟ	Multi-Speed RTU	#		<u>.</u>	cal .	anical ng ance		CA-Commissioning Age Functional Verification (CA Contracted by Owr	Glaus, Pyle, Schomer, Burns & DeHaven, Inc.
Standard RTU	ti-Spee	rence #	DDOCECC	GC - Genera Contractor	EC - Electrica Contractor	MC-Mechan Contractor PC-Plumbing Contractor AB-Air Balan	2	Sommi ctional Contra	520 S. MAIN STREET, SUIT 2531 AKRON, OH 44311 330.572.2100 FAX: 330.572.2102
Stan	<u> </u>	9 Refere	PROCESS	GC - Cont	Cont	MC-Me Contrac PC-Plun Contrac AB-Air B	Remarks	CA-(Fun (CA	Copyright, Glaus, Pyle, Schomer, Burns & DeHaven, Inc. 2021
V	V	70	Fire Supression System Shutdown TBANS-1 has been installed per plan location						
X	X		TBANS-1 has dedicated power to terminals TB-PWR	•					
х	Х	73	TBANS terminals TB1-1 and TB1-2 are wired to "Closed when Cocked" terminals ${f c}$ fire suppression system microswitch per detail						
X	X	74 75	RTU 1 and RTU 2 low voltage control power is wired through terminals in TBANS-1 If present, electronic gas valve is wired through TBANS						
	Х	76	If required, TBANS to hoodstat has been wired for EF-1 on during supressant discharge event						
х	Х	77	Visual Verification installation certification document has been requested (certify@ace-bcx.com)and completed						
П	#	78	(certify@ace bex.com/and completed						
Ц	#	79 80	Thermostat						
Х	Х	81	Thermostats are wired to package units per thermostat and unit wiring diagrams						
Х	Х	82	Package units equiped with two stage cooling have each cooling stage individualy wired and controled from their thermostat.						
x	Х	83	Package units equiped with two stage heating have each heating stage individualy wired and controled from their thermostat.						
	Х	84	Thermostats are wired to TBCCB Control Box per Detail on plan sheet E-6						
Х	+		Thermostats are programmed to Taco Bell parameters Visual Verification installation certification document has been requested						
X	Х	86 87	(certify@ace-bcx.com)and completed						
		88	Hoodstat						
X	X	90	Hoodstat has been installed in duct or hood per plan Hoodstat is wired to terminals TB2 of the TBCCB Control Box						
Х	Х	91 92	Hoodstat microswitch closes at 85 degrees						
	+	93 94	TBCCB & Interlock						
х	Х	95	Unswitched power is provided to H=HOT and N=Neutral and G=Ground terminals in the TBCCB Control Box						
Х	Х	96	Hoodstat wires are landed on terminals TB2 of the TBCCB Control Box Low voltage wiring has been completed between RTU 1 and TB-1 of the TBCCB						
Х	Х	97	Control Box						
\sqcup	_	98	Low voltage wiring has been completed between RTU 2 and TB-1 of the TBCCB Control Box						
П	╅	100	Photocell is wired to the TBCCB per detail						
Н	\dashv	101	Any optional switches, if used, have been installed to TBCCB per schematic "Occupied" and "Unoccupied" times for the building have been programmed into						
H	+		Channel/Switch 1 of the Timeclock in TBCCB Control Box "Open" and "Closed" times for Taco Bell sales have been programmed into						
X	X	102	Channel/Switch 2 of the Timeclock in TBCCB Control Box Visual Verification installation certification document has been requested						
Х		103	(certify@ace-bcx.com)and completed						DATE REMARKS
	_	104105	Visual Verification						08.09.22 IFB
х	х	106	Visual Verification installation certificate has been received for Smoke Detectors						
Х	Х	107	Visual Verification installation certificate has been received for Remote Smoke Detectors Ennunciators and Resets						
х	х	108	Visual Verification installation certificate has been received for Thermostat and Remote Sensors installation						CONTRACT DATE: 10.05.21
Х	Х	109	Visual Verification installation certificate has been received for TBANS-1 installation						BUILDING TYPE: END. MED20
х	х	110	Visual Verification installation certificate has been received for TBCCB						PLAN VERSION: MARCH 2021
х	Х	111	Visual Verification installation certificate has been provided to designated authority (Owner, GC, Air Balancing Agency, Commissioning Agency)						BRAND DESIGNER: DICKSON SITE NUMBER: 315672
	_	112 113							SITE NUMBER: 315672 STORE NUMBER: 455386
		114	Lighting						PA/PM: JG
	_	115	Interior lights are wired through the TBCCB per plan and schematic						DRAWN BY.:
		117	Occupancy sensor controlled lighting installed in restrooms Daylighting and dimming box (DDCB-ACI) is installed in jurisdictions requiring						JOB NO.: 2021088.52
Х	Х	118	daylight harvesting and or dimming of interior lights Photocell is wired to the TBCCB control box per plan and schematic						TACO BELL
X	Х	120	Exterior lights are wired to the TBCCB control box per plan and schematic Sign lights are wired to the TBCCB control box per plan and schematic						1551 West River Rd.
X	_		TBCCB timeclock is programmed to Taco Bell parameters Manual override of TBCCB control box timeclock activates lighting circuits						Elyria, OH
H	_	123 124	Commissioning						
Х	Х		All Visual Verification installation certificates have been received						
	-		Air Balance Supplement Ralancing performed in accordance to ASHRAE Standard 111-2008, NERR, TARR of						TACO
Х	Х	128	Balancing performed in accordance to ASHRAE Standard 111-2008, NEBB, TABB of AABC standards Perform full for ground adjustments often exhaust for adjustments and supply air.						BELL.
Х	Х	129	Perform full fan speed adjustments after exhaust fan adjustments and supply air distribution adjustments have been made						ENDEAVOR 2.0
х	х	130	Perform outside air adjustment after all other balance adjustments are complete						INSTALLATION
Х	_		Perform outside air adjustment at full evaporator fan speed operating point						START-UP
H	_		Perform outside air adjustment at medium fan speed operating point Perform outside air adjustment at low fan speed operating point						PRE-COMM
	Х	134	Verify lobby doors closures have been adjusted for ADA compliance Verify lobby doors closure operation during full economizer function of both						CHECK LIST
X			package units and note result in air balance report Verify pressure relief system operation in full economizer operation						SW2.0
		137	Adjust power exhauster "ON" and "OFF" positions to mitigate door closure issues.						3 1 2 1 0
			Note if no power exhauster is available. Provide copy of air balance report to Commissioning Agent						PLOT DATE: 8/9/2022 1:16:08 PM




	08.09.22	IFB	
CON	ITRACT DAT	E:	10.05.21
BUIL	DING TYPE	:	END. MED20
PLA	N VERSION:		MARCH 2021





MECHANICAL – ELECTRICAL (ME) BALANCING & COMMISSIONING SEQUENCE & PROCEDURE

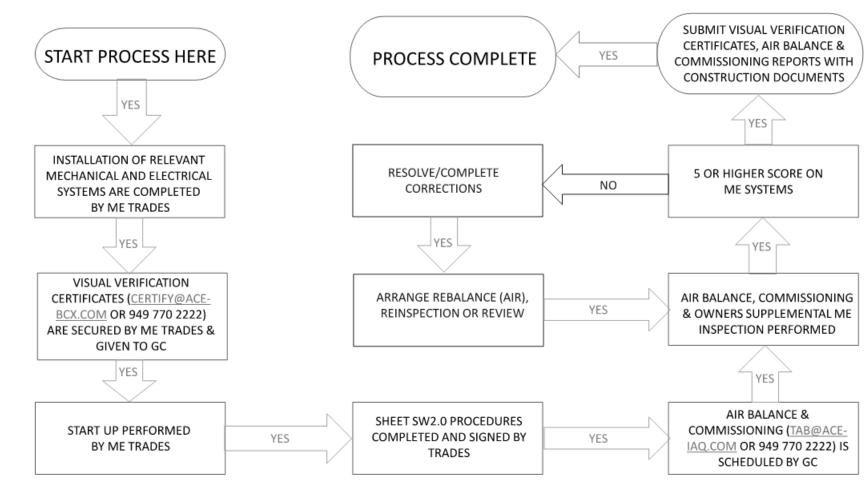

DATE	REMARKS
08.09.22	IFB

CONTRACT DATE: 10.05.21

BUILDING TYPE: END. MED20

PLAN VERSION: MARCH 2021

BRAND DESIGNER:
SITE NUMBER:

STORE NUMBER:

PA/PM: DRAWN BY.:

TACO BELL

1551 West River Rd. Elyria, OH



ENDEAVOR 2.0

BALANCING


AND

COMISSIONING

SEQUENCE

SW2.1



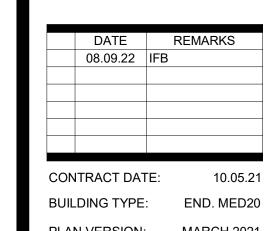

PLAN VERSION: MARCH 2021 BRAND DESIGNER: DICKSON SITE NUMBER: STORE NUMBER: PA/PM: DRAWN BY.:

TACO BELL

2021088.52

1551 West River Rd. Elyria, OH



ENDEAVOR 2.0 SITE **ELECTRICAL PLAN**

PLOT DATE: 8/9/2022 1:14:15 PM

ELECTRICAL SITE PLAN - ELYRIA 1" = 10'-0" 1

8 NOT USED.

11 1" C. - (2) #8, #8 GND.

9 CLEARANCE BAR. REFER TO CIVIL DRAWINGS.

10 LED SITE LIGHTING, REFER TO PHOTOMETRIC DRAWING.

0	
1	1" C (2) #8, #8 GRD. (TYP. FOR ENTIRE CIRCUIT.)
2	REFER TO LIGHTING FIXTURE SCHEDULE ON E4.0 FOR

ADDITIONAL INFORMATION ON LIGHTIN FIXTURES. (TYPICAL)

DIGITAL MENU BOARD. REFER TO CONDUIT SCHEDULE FOR CONDUIT SIZE AND QUANTITY. REFER TO CIVIL DRAWINGS.

4 LED PYLON SIGN.

B 11 B-29

5 UNDERGROUND ELECTRIC SERVICE TO UTILITY CO. TRANSFORMER. REFER TO CIVIL SHEETS FOR LOCATION AND ROUTING. VERIFY AND COORDINATE ALL REQUIREMENTS WITH UTILITY CO.

PROVIDE SEPARATE (2) 2" TELEPHONE AND (2) 2" CABLE (HIGH SPEED INTERNET INCLUDED) CONDUITS TO CONNECTION ON SITE . REFER TO CIVIL SHEETS FOR LOCATION AND ROUTING. VERIFY AND COORDINATE ALL REQUIREMENTS WITH UTILITY

SPEAKER POST AND CANOPY. REFER TO CONDUIT SCHEDULE FOR CONDUIT SIZE AND QUANTITY.

DEVICE	POWER	DATA
DIRECTIONAL	(1) 1"	-
SPEAKER POST	(1) 1"	(1) 1"
MENUBOARD	(1) 1"	(2) 1"

1 4

B-29 2 10 11

B-29 \(\bigcirc 2 \)
A \(\bigcirc 10 \)
11

PROPOSED TACO BELL

PROPOSED TRANSFORMER -


2 10 11 C B-29 J B-8


ONDUIT SCHEDULE					
DEVICE	POWER	DATA	İ		
CTIONAL	(1) 1"	-			
			_		

DEVIOL	1 0 11 211	Bittiit	
IONAL	(1) 1"	-	
ER POST	(1) 1"	(1) 1"	7



AKRON, OH 44311 330.572.2100 FAX: 330.572.2102

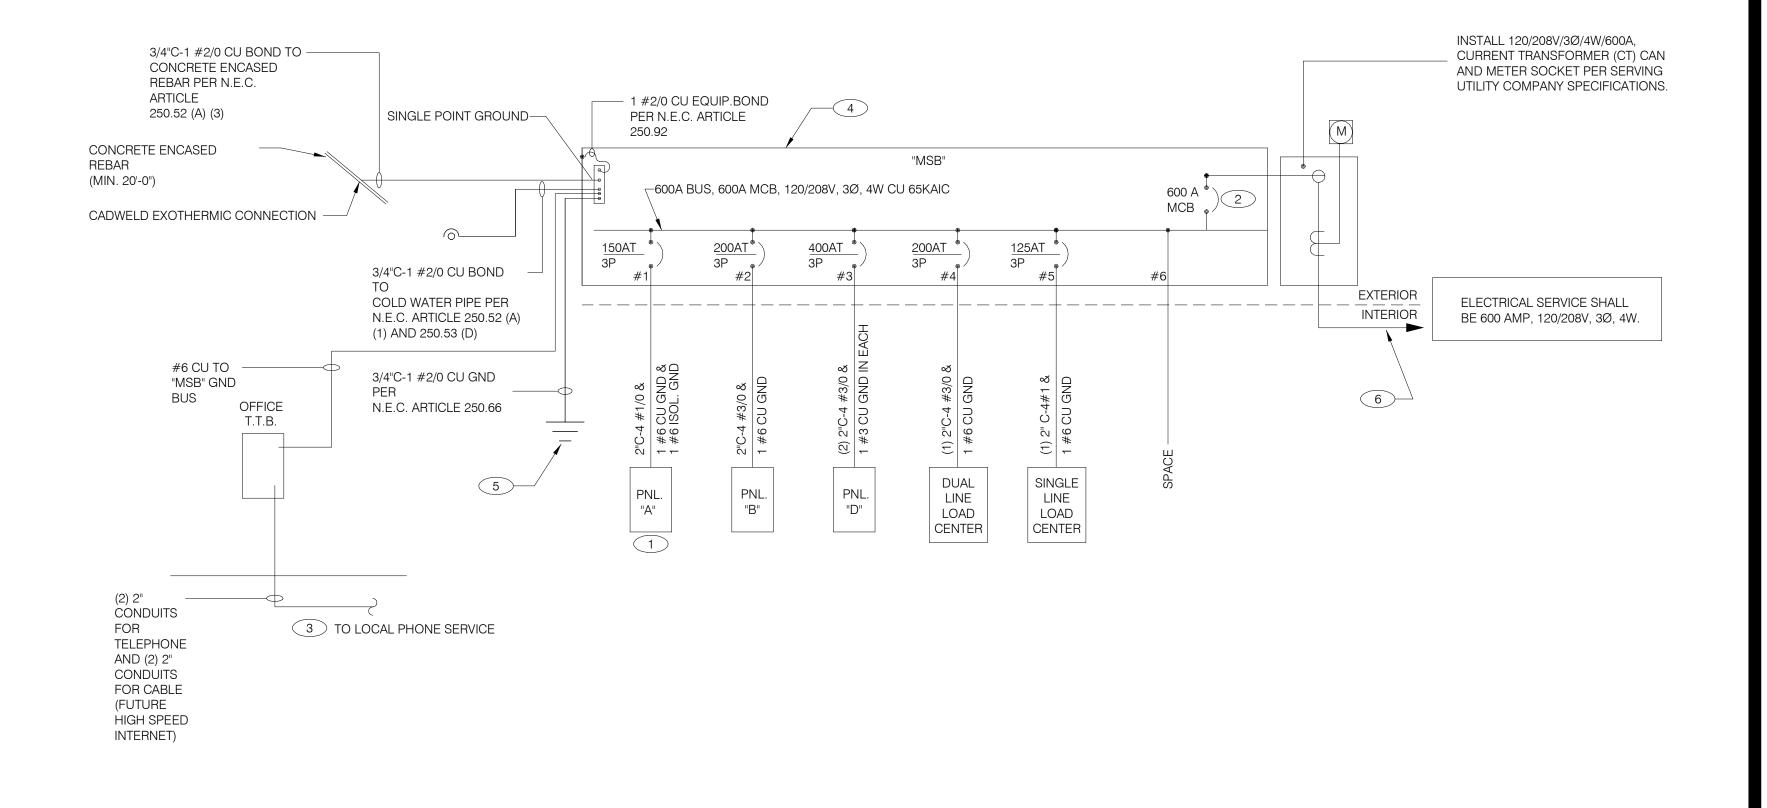

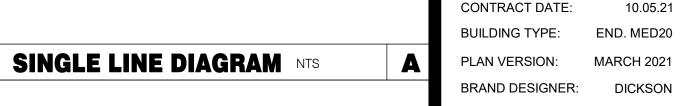

1 WIRE ISOLATED GROUND TO ISOLATION GROUND BUS IN PANEL AND LAND ISOLATED GROUND TO SINGLE POINT GROUND. "DO NOT COMBINE COMMON GND TO ISOLATED GROUND". REF DETAIL 6/E3.1.

2 PROVIDE 100% RATED MAIN CIRCUIT BREAKER IN MDP.

PROVIDE 2" CONDUIT STUBBED INTO BUILDING FROM LATERAL POLE FOR TELEPHONE AND 2" CONDUIT FOR FUTURE HIGH SPEED CABLE.

VERIFY AVAILABLE FAULT CURRENT AT SERVICE ENTRANCE WITH THE UTILITY COMPANY. IF THE AIC RATING AS INDICATED IS NOT SUFFICIENT, CONTACT PROJECT MANAGER AND ENGINEER PRIOR TO BID/PRICING TO UPDATE EQUIPMENT RATING.

(3) 5/8" DIA. x 10'-0" COPPER CLAD GROUND RODS. INSTALL 10'-0" APART AND CONNECT GROUND SYSTEM PER N.E.C. ARTICLE 250

PROVIDE UNDERGROUND SERVICE LATERAL TO UTILITY TRANSFORMER PER SERVING UTILITY COMPANY SPECIFICATIONS. 4#350 KCMIL CU. IN EACH OF (2) 3"C. TO PAD MOUNT TRANSFORMER. GC/ELECT. CONTRACTOR SHALL COORDINATE SERVICE POLES PER LOCAL UTILITY CODE. IF ALUMINUM CONDUCTORS ARE USED PROVIDE 4#500 KCMIL AL. IN EACH (2) 3-1/2"C.

STORE NUMBER:	45538
PA/PM:	J
DRAWN BY.:	AJ
JOB NO.:	2021088.5

315672

SITE NUMBER:

08.09.22 IFB

1551 West River Rd. Elyria, OH

TACO BELL



ENDEAVOR 2.0 ELECTRICAL ONE LINE **DIAGRAMS AND LEGEND**

NL (S) (S) (J)	NIGHTLIGHT CEILING MOUNTED SPEAKER WALL MOUNTED SPEAKER		FUSIBLE DISCONNECT SWITCH WITH STARTER FUSIBLE DISCONNECT SWITCH
(S) (S)	CEILING MOUNTED SPEAKER		WITH STARTER
S			FUSIBLE DISCONNECT SWITCH
	WALL MOUNTED SPEAKER		
	WILL MOONIED OF ENACH		
(J)	WINDSTONE DOW		NON-FUSIBLE DISCONNECT SWITCH
	JUNCTION BOX	PC	PHOTOCELL
-(J)-	WALL MOUNTED JUNCTION BOX	[10]	THOTOGELE
◀	TELEPHONE OUTLET	RS	RAIN SENSOR
\ominus	DEDICATED GROUNDED OUTLET		LED WALL MOUNT FIXTURE
\Leftrightarrow	DUPLEX GROUNDED OUTLET		LED WALL MOONT HATONE
\oplus	DOUBLE DUPLEX GROUNDED OUTLET		EMERGENCY LIGHT
	GROUND FAULT DUPLEX OUTLET	1	SINGLE POLE, SINGLE THROW
\Rightarrow	GROUND FAULT DUPLEX W/ BOTT. HALF SWITCHED	Sos	TOGGLE SWITCH
\leftarrow	GROUND FAULT DEDICATED OUTLET	ŚP	SINGLE POLE, SINGLE THROW TOGGLE SWITCH W/ PILOT LIGHT
\ominus	CEILING DUPLEX OUTLET	<u>.</u>	TOGGLE SWITCH W/ FILOT LIGHT
•	DUPLEX ISOLATED GROUND OUTLET	SOS	WALL MOUNTED OCCUPANCY
=	DOUBLE DUPLEX ISOLATED GROUND OUTLET	R	SENSOR RELAY
•	DEDICATED ISOLATED GROUND		
_			CONDUIT RUN, UNDERGROUND
\bigcirc	CEILING SPECIAL PURPOSE OUTLET	\odot	SMOKE DETECTOR
	ELECTRICAL PANEL. SEE SHEET E2.1		
			EXTERIOR WALL FIXTURE
ı	HOLD OF EMERGENCY BULLON	4	EXTERIOR DECORATIVE WALL FIXTUR
0	ELECTRICAL MOTOR	\'	
[SD]	DUCT MOUNTED SMOKE DETECTOR	4	EXTERIOR DECORATIVE WALL FIXTUR
[C]	CONNECTION TO EQUIPMENT		WEATHERDROOF OF COUNTY FANCE
		WPG	WEATHERPROOF GROUND FAULT
		EI ECTRIC	ALLEGEND NTS
		SPECIAL PURPOSE OUTLET CEILING SPECIAL PURPOSE OUTLET ELECTRICAL PANEL. SEE SHEET E2.1 FOR PANEL SCHED. HOLD UP EMERGENCY BUTTON ELECTRICAL MOTOR DUCT MOUNTED SMOKE DETECTOR	SPECIAL PURPOSE OUTLET CEILING SPECIAL PURPOSE OUTLET ELECTRICAL PANEL. SEE SHEET E2.1 FOR PANEL SCHED. HOLD UP EMERGENCY BUTTON ELECTRICAL MOTOR DUCT MOUNTED SMOKE DETECTOR

CONSTRUCTION ENGINEER FOR A DECISION BEFORE PROCEEDING. COORDINATE AVAILABLE SHORT CIRCUIT CURRENT W/ LOCAL UTILITY AND PROVIDE CIRCUIT BREAKERS W/ SUFFICIENT INTERRUPTING CAPACITY. COORDINATE CT METERING COMPARTMENT SIZE WITH LOCAL UTILITY COMPANY, THE LOCAL ELECTRICAL INSPECTOR AND THE NATIONAL ELECTRICAL CODE TO MEET ALL REQUIREMENTS BEFORE PURCHASE AND INSTALLATION. NEW METER BY LOCAL UTILITY COMPANY. 5. ALL WIRING SHOWN SHALL BE COPPER TYPE "THHN/THWN" EXCEPT FEEDERS FROM UTILITY TRANSFORMER TO SWITCH BOARD MAY BE ALUMINUM. CABLE IS NOT ALLOWED FOR NON-ACCESSIBLE FLOORS, WALLS AND CEILINGS.

THERE SHALL BE U.L. LISTED SERIES RATING BETWEEN CKT. BREAKERS LOCATED AT THE

GENERAL CONTRACTOR IS RESPONSIBLE FOR ALL OTHER ASPECTS OF THE PROJECT

SERVICE ENTRANCE AND DOWNSTREAM 22K A.I.C. RATED CIRCUIT BREAKERS AT PANEL "D."

DISTRIBUTION PANEL AND THE DOWNSTREAM 10k A.I.C. RATED CIRCUIT BREAKERS AT PANELS "A", "B" DUAL-LINE EQUIPMENT CABINET BASED ON THE MAXIMUM FAULT CURRENT AS DETERMINED AT THE

SEE SCOPE OF WORK FOR DETAILS REGARDING OWNER SUPPLIED AND/OR INSTALLED PRODUCTS.

IF UTILITY COMPANY PROPOSES A SERVICE DIFFERENT FROM THAT ILLUSTRATED, CONTACT THE

ARMOR CABLE ACCEPTABLE FOR THE LAST 6'-0" FROM A JUNCTION BOX TO LIGHT FIXTURES. ARMOR

ONE LINE DIAGRAM GENERAL NOTES NTS C

ONE LINE DIAGRAM KEY NOTES NTS

	Location:		Vo	lts: 1	20/208	Wve		A.I.C. Rating	65 KAIC			
	Supply From:			es: 3		vvyc	Mains Type: MCB					
	Mounting: SURFACE			res: 4				Mains Rating				
	Enclosure: NEMA-3R							MCB Rating				
Notes:							10	0% RATED CIRC		KER		
СКТ	Circuit Desc	cription	WII		# of Poles	Frame Size	Trip Rating	Load	Remark	s		
1	PANELBOARD A	····•	1/		3	225 A	150 A	29000 VA				
2	PANELBOARD B		3/	0	3	225 A	200 A	15863 VA				
3	PANELBOARD D		3/	0	3	400 A	400 A	64237 VA				
4	DUAL COOK LINE PANEL		3/	0	3	225 A	200 A	52000 VA				
5	SINGLE COOK LINE		1		3	225 A	125 A	28800 VA				
6	Space							0 VA				
						То	tal Conn. Load					
							Total Amps	: 527 A				
	ssification	Connected Load	Demand		tor	Estimated De			Panel	Totals		
HVAC		32020 VA	100.0			32020 VA						
Kitchen		11958 VA	65.0			7773 VA				189900 VA		
ighting		8332 VA	125.0			10415 VA	١			187798 VA		
Other		975 VA	100.0			975 VA		Total Conn.				
Power		112712 VA	100.0			112712 V/		tal Est. Demand	Current:	521 A		
Receptacl		6524 VA	100.0			6524 VA						
Refrigerati	on	17379 VA	100.0	UU%		17379 VA	١					

Panel: B

Location:

Supply From: MSB Mounting: Recessed Enclosure: Type 1				Phases: 3 Wires: 4								Mains Type: M.L.O. Mains Rating: 200 A MCB Rating: N/A						
Notes:																		
NOTES C	KT	Load Name	Trip	Poles		4	i i	В		C	Poles	Trip	Load Name	CKT NOTE				
		DINING LTS	20 A	1	616 VA	1500					1	20 A	EXTERIOR SIGNAGE	2				
	3	EXTERIOR SCONCE LTS.	20 A	1			216 VA	216 VA			1	20 A	UTILITY RECEPT	4 GFCI				
	5	KITCHEN/ BOH/ RESTROOM LTS	20 A	1					1297	91 VA	1		EMERGENCY LTS INT/EXT, EXIT SIGNS	6				
		LTG - SHOW WINDOW	20 A	1	600 VA	500 VA					1		CLEARANCE BAR	8				
		LTG - SHOW WINDOW	20 A	1			600 VA	500 VA			1		TBCCB	10				
		LTG - COOLER & FREEZER	20 A	1					800 VA	500 VA	1	20 A	E1AN TBANS	12				
		PATIO LIGHTING	20 A	1	27 VA	0 VA					1	20 A	Spare	14				
	_	DIGITAL MENU BOARD/SPEAKER POST	20 A	1			360 VA	0 VA			1	20 A	Spare	16				
•	17	SPEAKER POST	20 A	1					500 VA	0 VA	1	20 A	Spare	18				
		CANOPY LIGHTING	20 A	1	200 VA	0 VA					1	20 A	•	20				
	21	LTG - PYLON SIGN	20 A	1			500 VA	0 VA			1	20 A	Spare	22				
		CLEARANCE BAR	20 A	1					500 VA	0 VA	1	20 A	Spare	24				
	25	Spare	20 A	1	0 VA	0 VA					1	20 A	Spare	26				
		Spare	20 A	1			0 VA	0 VA			1	20 A	Spare	28				
		LTG - SITE LIGHTING	20 A	1					1560	0 VA	1	20 A	Spare	30				
		EF-1	20 A	1	1120	0 VA					1	20 A	Spare	32				
3	33	EF-2	20 A	1			660 VA	1500			1	20 A	PURPLE WALLWASH LIGHTS	34				
		Spare	20 A	1					0 VA	1500	1	20 A	PURPLE WALLWASH LIGHTS	36				
		Spare	20 A	1	0 VA	0 VA					1	20 A	•	38				
3	39	Spare	20 A	1			0 VA	0 VA			1	20 A	Spare	40				
	41	Spare	20 A	1					0 VA	0 VA	1	20 A	Spare	42				
			Tot	al Load:	456	4 VA	4552	2 VA	6748	3 VA								
			Tota	al Amps:	38	3 A	38	3 A	56	6 A	-							
L	ege	end:																

Volts: 120/208 Wye

Load Classification	Connected Load	Demand Factor	Estimated Demand	Panel	Totals
Other	975 VA	100.00%	975 VA		
Power	3360 VA	100.00%	3360 VA	Total Conn. Load:	15863 VA
Lighting	8332 VA	125.00%	10415 VA	Total Est. Demand:	17946 VA
HVAC	1780 VA	100.00%	1780 VA	Total Conn. Current:	44 A
Receptacle	1416 VA	100.00%	1416 VA	Total Est. Demand Current:	50 A

CIRCUIT BREAKER/MISC. ACC. ABBREVIATIONS:

A.I.C. Rating: SERIES

GF - GROUND FAULT CIRCUIT INTERRUPTER
AF - ARC-FAULT CIRCUIT INTERRUPTER
ST - SHUNT TRIP
HL-ON - HANDLE-LOCK ON DEVICE
HL-OFF - HANDLE-LOCK OFF DEVICE
EPD - EQUIPMENT PROTECTION DEVICE
IG - ISOLATED GROUND

Panel: A Location: A.I.C. Rating: SERIES Volts: 120/208 Wye Supply From: MSB Phases: 3 Mains Type: M.L.O. Mounting: Recessed Wires: 4 Mains Rating: 150 A Enclosure: Type 1 MCB Rating: N/A PROVIDE ISOLATED GROUND BAR NOTES CKT CKT NOTES Load Name 20 A 1 180 VA 300 VA 1 P-417 TIMER 1 20 A F-040 OFFICE COMPUTER 2 IG 1 20 A DRIVE THRU POS/ORDER ENTRY 1 GF 3 S-546 ICED TEA 480 VA 720 VA 4 5 OFFICE QUAD RECEPTACLE 20 A 1 1 180 VA 480 VA 1 20 A S-546 BREWER 6 GF 1 20 A U-011 7 J-BOX SECURITY SYSTEM / DVR 20 A 1 1180... 180 VA 8 20 A 1 1800... 540 VA 1 20 A RECEPTACLES - OFFICE 10 9 S-026 HEAT CABINET 860 VA 648 VA 1 20 A S-204 D/T TIMING SYSTEM IG 11 U-050 CREDIT CARD SAT. ROUTER JUNC. 20 A 1 12 1 20 A R-009 FULL HEIGHT FREEZER 13 F-090 20 A 1 1540... 1140... 14 GF 20 A 1 1540... 1140... 15 A 1 1428... 2013... 2013 2 30 A P-452 HOT WATER SYSTEM 16 18 GF 15 BEVERAGE DISPENSER D/T 30 A 2 2013... 240 VA 2013... 2013... 1 20 A C-107 RETHERMALIZER 20 A 1 600 VA 0 VA 1 0 A SHUNT TRIP SPACE 17 19 P-452 HOT WATER SYSTEM 20 GF 21 SECURITY CAMERA POWER 22 ST 972 VA 100 VA 1 15 A C-400 COOK TIMER 3 GF 23 C-026 FRYER 24 ST 25 SHUNT TRIP SPACE 1 20 A INTERIOR DIGITAL MENUBOARD 26 0 A 1 0 VA 500 VA 20 A 1 0 VA 500 VA 1 20 A OCB SWITCH 27 Spare 680 VA 1800... 1 20 A L-045 WARMER 30 GF 29 DINING POS ENTRY 2 20 A 1 IG 31 DRIVE THRU MONITORS 20 A 1 180 VA 360 VA 1 20 A SAFE W/TOUCHSCREEN CONTROLS 32 1 20 A DINING POS ENTRY 1 34 IG 33 RECIRCULATION PUMP 200 VA 1180... 200 VA 700 VA 1 20 A AUTO FAUCET POWER IG 35 KIOSK POWER - FRONT COUNTER 36 37 MAINTENANCE RECEPTACLE... 1 20 A Spare 38 20 A | 1 | 180 VA | 0 VA | 40 IG 39 PRE PAY WINDOW P.O.S. POWER 720 VA 0 VA 1 20 A Spare 180 VA 0 VA 1 20 A Spare 42 41 PRE PAY WINDOW MONITORS **Total Load:** 7993 VA 10181 VA 10826 VA Total Amps: 67 A 88 A 93 A Legend: **Load Classification Connected Load Demand Factor Estimated Demand** Panel Totals 23624 VA 100.00% 23624 VA 2808 VA 100.00% 2808 VA Total Conn. Load: 29000 VA Receptacle Total Est. Demand: 29000 VA Total Conn. Current: 80 A **Total Est. Demand Current:** 80 A

CIRCUIT BREAKER/MISC. ACC. ABBREVIATIONS:

GF - GROUND FAULT CIRCUIT INTERRUPTER AF - ARC-FAULT CIRCUIT INTERRUPTER

ST - SHUNT TRIP
HL-ON - HANDLE-LOCK ON DEVICE
HL-OFF - HANDLE-LOCK OFF DEVICE
EPD - EQUIPMENT PROTECTION DEVICE

IG - ISOLATED GROUND

PARKING LOT LIGHTING AND SIGNAGE SHALL PASS THROUGH TBCCB

NOTE

NOTE TO CONTRACTORS

ALL CONTRACTORS PRIOR TO BID SUBMISSION PROCESS SHALL VISIT PROPOSED WORK SITE AND FIELD VERIFY ALL EXISTING CONDITIONS. ANY CONDITION THAT DIFFERS FROM THAT SHOWN ON THESE PLANS SHALL BE REPORTED TO THE TENANT'S ARCHITECT/ENGINEER SO THAT NEW AND REVISED BID DRAWINGS OR INFORMATION MAY BE ISSUED. MODIFICATION TO THE SCOPE OF WORK WHICH RESULTS FROM THE CONTRACTORS NEGLECT TO VISIT THE SITE PRIOR TO SUBMITTING BID, SHALL BE THE CONTRACTORS SOLE RESPONSIBILITY.

GENERAL NOTE:

FOR PARKING LOT (SITE) LIGHTS AND OUTSIDE SIGNS: PROVIDE (5) 1"C FROM PANEL "B" AND STUB OUT 10'-0" AWAY FROM THE BUILDING. VERIFY EXACT LOCATION OF STUB PRIOR TO ROUGH-IN. LOADS MAY VARY WITH LOCATION. VERIFY OUTDOOR VOLTAGE DROP FOR ALL PARKING LIGHTING (SITE) CIRCUITS.

KEY NOTES:

1 PROVIDE LOCK-ON BREAKER.

2 CIRCUITS TO BE WIRED THROUGH COMBINED CONTROL BOX CONTACTOR. SEE SHEETS 6.0 AND 6.1.

PROVIDE 5mA GFI BREAKER. CIRCUIT TO BE WIRED THROUGH TBANS. SEE SHEETS E7.0 AND E7.1.

GPDGROUP
Glaus, Pyle, Schomer, Burns & DeHaven, Inc.

520 S. MAIN STREET, SUIT 2531
AKRON, OH 44311
330.572.2100
FAX: 330.572.2102

	DATE	REMARKS
	08.09.22	IFB

CONTRACT DATE: END. MED20 BUILDING TYPE: PLAN VERSION: MARCH 2021 BRAND DESIGNER: DICKSON SITE NUMBER: 315672 STORE NUMBER: 455386 PA/PM: JG DRAWN BY.: 2021088.52 JOB NO.:

TACO BELL

1551 West River Rd. Elyria, OH



ENDEAVOR 2.0
ELECTRICAL
SCHEDULES

E2.1

	COMMERCIAL KITCHEN EQUIPMENT SCHEDULE																
		EQUIPMENT IDENTIFICATION	EQUIPMENT ELECTRICAL CHARACTERISTICS						EQUIPMENT CIRCUI	EQUIPMENT DISCONNET							
TAG	TYPE	EQUIPMENT NAME	V/Ph - WATTS	FLA/RLA	MCA	TIME DELAY FUSE	INVERSE-TIME BREAKER	SETS	BRANCH CIRCUIT	WIRE TYPE	CONDUIT TYPE	TYPE	SIZE	NEMA	SUPPLIED BY	INSTALLED BY	NOTES
B-223	0	B-223 WATER HEATER IGNITION	120 V/1-744 VA	6.2	7.2	20	20	1	#12 W/#12 G IN 3/4"C	CU	ST	C&P	20	5-20	ES	ES	2
B-381	0	CO2 CARBON DIOXIDE SENSOR / WARNING	120 V/1-156 VA	1.0	1.3	20	20	1	#12 W/#12 G IN 3/4"C	CU	ST	C&P	20	5-20	ES	ES	2
C-026	KR	FRYER	120 V/1-972 VA	8.1	9.8	20	20	1	#12 W/#12 G IN 3/4"C	CU	ST	C&P	20	5-20	ES	ES	1,2
C-107	0	RETHERMALIZER	120 V/1-240 VA	2.0	2.5	20	20	1	#12 W/#12 G IN 3/4"C	CU	ST	C&P	20	5-20	ES	ES	1,2
C-400	0	COOK TIMER	120 V/1-100 VA	0.3	0.4	15	15	1	#12 W/#12 G IN 3/4"C	CU	ST	C&P	15	5-15	ES	ES	2
DCL	0	DUAL COOK LINE	208 V/3-52000 VA	145	145	200	200	1	4#3/0 W/#6 G IN 2"C	CU	ST	DIRECT	200	J-BOX	ES	ES	8
E1AN	0	TBANS SHUNT PANEL	120 V/1-500 VA	6.3	7.9	20	20	1	#12 W/#12 G IN 3/4"C	CU	ST	DIRECT	20	1	ES	ES	8
F-040	0	OFFICE COMPUTER	120 V/1-300 VA	2.5	3.1	20	20	1	#12 W/#12 G IN 3/4"C	CU	ST	C&P	20	5-20	ES	ES	2
F-050	0	CREDIT CARD SATELLITE ROUTER JUNCTION	120 V/1-500 VA	4.0	5.0	20	20	1	#12 W/#12 G IN 3/4"C	CU	ST	C&P	20	5-20	ES	ES	2
F-090	0	UPS	120 V/1-500 VA	4.0	5.0	20	20	1	#12 W/#12 G IN 3/4"C	CU	ST	C&P	20	5-20	ES	ES	2
F-174	0	SAFE W/TOUCHSCREEN CONTROLS	120 V/1-360 VA	3.0	3.8	20	20	1	#12 W/#12 G IN 3/4"C	CU	ST	C&P	20	5-20	ES	ES	2
IR-01	0	IRRIGATION TIMER	120 V/1-500 VA	2.0	3.0	20	20	1	#12 W/#12 G IN 3/4"C	CU	ST	DIRECT	20	1	ES	ES	8
L-044	KR	WARMER R TO L	120 V/1-1800 VA	16.0	16.0	20	20	1	#12 W/#12 G IN 3/4"C	CU	ST	C&P	20	5-20	ES	ES	2
L-045	KR	WARMER R TO L	120 V/1-1800 VA	16.0	16.0	20	20	1	#12 W/#12 G IN 3/4"C	CU	ST	C&P	20	5-20	ES	ES	2
N-043	KR	POWER SOAK	208 V/2-4740 VA	11.4	14.25	15	15	1	#12 W/#12 G IN 3/4"C	CU	ST	DIRECT	20	J-BOX	ES	ES	8
N-044	0	S-204 D/T TIMING SYSTEM	120 V/1-216 VA	7.2	9.0	20	20	1	#12 W/#12 G IN 3/4"C	CU	ST	C&P	20	5-20	ES	ES	2
P-417	0	TIMER - 8 CHANNEL	120 V/1-180 VA	0.5	0.7	20	20	1	#12 W/#12 G IN 3/4"C	CU	ST	C&P	20	5-20	ES	ES	2
P-452	KR	HOT WATER SYSTEM	208 V/2-4026 VA	19.6	24.5	30	30	1	#10 W/#10 G IN 3/4"C	CU	ST	C&P	30	6-30	ES	ES	2
R-009	KM	R-009 FULL HEIGHT FREEZER	120 V/1-1140 VA	9.5	11.9	20	20	1	#12 W/#12 G IN 3/4"C	CU	ST	C&P	20	5-20	ES	ES	2
S-204	0	S-204 D/T TIMING SYSTEM	120 V/1-216 VA	7.2	9.0	20	20	1	#12 W/#12 G IN 3/4"C	CU	ST	C&P	20	5-20	ES	ES	2
S-284	KM	BEVERAGE DISPENSER S/S	120 V/1-1116 VA	9.3	12	20	20	1	#12 W/#12 G IN 3/4"C	CU	ST	C&P	20	5-20	ES	ES	2
S-285	KM	S-284 BEVERAGE DISPENSER (D/T)	120 V/1-1428 VA	11.9	14.9	20	20	1	#12 W/#12 G IN 3/4"C	CU	ST	C&P	20	5-20	ES	ES	2
S-289	0	CREDIT CARD SATELLITE ROUTER JUNCTION	120 V/1-200 VA	4.0	5.0	20	20	1	#12 W/#12 G IN 3/4"C	CU	ST	C&P	20	5-20	ES	ES	2
S-513	KM	CARBONATOR	120 V/1-138 VA	2.3	2.9	15	15	1	#12 W/#12 G IN 3/4"C	CU	ST	C&P	15	5-15	ES	ES	2
S-540	0	PEPSI BOOSTER TANK	120 V/1-564 VA	4.7	5.9	20	20	1	#12 W/#12 G IN 3/4"C	CU	ST	C&P	20	5-20	ES	ES	2
S-544	0	ICED TEA	120 V/1-240 VA	2.0	2.5	20	20	1	#12 W/#12 G IN 3/4"C	CU	ST	C&P	20	5-20	ES	ES	2
S-546	0	BREWER	120 V/1-480 VA	4.0	5.0	20	20	1	#12 W/#12 G IN 3/4"C	CU	ST	C&P	20	5-20	ES	ES	2
S-550	0	BAG IN BOX RACK	120 V/1-564 VA	4.7	5.9	20	20	1	#12 W/#12 G IN 3/4"C	CU	ST	C&P	20	5-20	ES	ES	2
S-552	KM	W-075-2 WALK-IN FREEZER	208 V/3-0 VA	11.6	14.5	20	20	1	#12 W/#12 G IN 3/4"C	CU	ST	DIRECT	20	J-BOX	ES	ES	2
S-570	KM	CARBONATOR	120 V/1-138 VA	2.3	2.9	15	15	1	#12 W/#12 G IN 3/4"C	CU	ST	C&P	15	5-15	ES	ES	2
	t	<u> </u>					T 1			—				—	—		

TYPE: H-HEATING, C-COOLING, KR-KITCHEN RESISTIVE, KM-KITCHEN MOTOR, WH-WATER HEATER, OM-OTHER MOTORS, O-OTHER DISCONNECT TYPE: HP-HP RATED SWITCH, C&P-CORD & PLUG, LC&P-LOCKING CORD & PLUG, F-FUSED, NF-NON-FUSED, MCCB-MOLDED CASE CIRCUIT BREAKER SUPPLIED/INSTALLED BY: EC-ELECTRICAL CONTRACTOR, HC-HVAC CONTRACTOR, PC-PLUMBING CONTRACTOR, ES-EQUIPMENT SUPPLIER *VOLTAGE DROP CALCULATION FORMULAS COURTESY OF COOPER BUSSMANN.*

NOTES: 1 - REQUIRES SHUNT TRIP PROTECTION

W-XX1 KM W-075-2 WALK-IN FREEZER

S-739 KM S-739 FROZEN BEVERAGE DISPENSER

U-011 O BASE STATION - D/T COMM. SYSTEM

U-050 O CREDIT CARD SATELLITE ROUTER JUNCTION

SCL O SINGLE COOK LINE (OPTIONAL)

U-061 O RECEIPT PRINTER U-070 O CREDIT CARD READER

- 2 CORD & PLUG SUPPLIED AND INSTALLED BY ES. EC SHALL PROVIDE RECEPTACLE.
- 3 CORD & PLUG SUPPLIED AND INSTALLED BY ES. RECEPTACLE SUPPLIED BY ES AND INSTALLED BY EC. 7 OUTLETS SUPPLIED AND INSTALLED BY ES. CONDUIT & WIRING PROVIDED BY EC. 4 - CORD, PLUG & RECEPTACLE SUPPLIED AND INSTALLED BY EC.
- 5 SINGLE PHASE, THREE WIRE EQUIPMENT. PROVIDE NEUTRAL CONDUCTOR AND GROUND.
- 6 THREE PHASE, FOUR WIRE EQUIPMENT. PROVIDE NEUTRAL CONDUCTOR AND GROUND.
 - 8 HARDWIRED CONNECTION BY E.C.

208 V/2-3120 VA 31.6 39.5 30 30 1 #10 W/#10 G IN 3/4"C CU ST C&P 30 6-30 ES ES 2

208 V/3-28800 VA 80 80 125 125 1 4#1 W/#6 G IN 2"C CU ST DIRECT 200 J-BOX ES ES 8 120 V/1-180 VA 2 .24 20 20 1 #12 W/#12 G IN 3/4"C CU ST C&P 20 5-20 ES ES 2

120 V/1-180 VA 1.5 1.9 20 20 1 #12 W/#12 G IN 3/4"C CU ST C&P 20 5-20 ES ES 2 208 V/3-0 VA 11.6 14.5 20 20 1 #12 W/#12 G IN 3/4"C CU ST DIRECT 20 J-BOX ES ES 2

1.5 | 1.9 | 20 | 20 | 1 | #12 W/#12 G IN 3/4"C | CU | ST | C&P | 20 | 5-20 | ES | ES | 2

1.5 | 1.9 | 20 | 20 | 1 | #12 W/#12 G IN 3/4"C | CU | ST | C&P | 20 | 5-20 | ES | ES | 2

REFER TO ARCHITECTURAL EQUIPMENT SCHEDULE FOR ALL KITCHEN EQUIPMENT AND FINAL COORDINATION

Panel: D

Location: Supply From: MSB Mounting: Recessed Enclosure: Type 1

Volts: 120/208 Wye

Phases: 3

A.I.C. Rating: SERIES Mains Type: M.L.O. Mains Rating: 400 A MCB Rating: N/A

NOTES	СКТ	Load Name	Trip	Poles		Α		В		3	Poles	Trip	Load Name	СКТ	NOTES
GF	1	CARBONATOR	15 A	1	276 VA	0 VA					1	20 A	Spare	2	
GF	3	B-223 WATER HEATER IGNITION	20 A	1			744 VA	1000			1	20 A	ALTERNATE PAYMENT ROUTER BOX	4	
	5	OC SWITCHED RECEPTACLE	20 A	1					180 VA	680 VA	1	20 A	IRRIGATION TIMER AND RECEPTACLE	6	GF
GF	7	S-540 PEPSI BOOSTER TANK	20 A	1	564 VA	500 VA					1	20 A	MUSIC SYSTEM J-BOX AND	8	
	9	RECEPTACLES - ROOF	20 A	1			540 VA	1560			0 00 4 0 700 FD07FN PEV PIOP		C 720 EDOZEN DEV DICD	10	GF
	11	CONVENIENCE RECEPTACLES	20 A	1					360 VA	1560	2	30 A S-739 FROZEN BEV. DISP.		12	GF
	13	GENERAL PURPOSE RECEPTACLES	20 A	1	1440	1600						20.4	IOE MAKED COMPENSED DA	14	
GF	15	DRINK FOUNTAIN - S-284 AND R-XX1	20 A	1			1254	1600			2	20 A	ICE MAKER CONDENSER D/T	16	
	17	IOE MAKED CONDENCED	00.4	0					1600	1600		00.4	LOE MAKED CONDENCED	18	
	19	ICE MAKER CONDENSER	20 A	2	1600	1600					2	20 A	ICE MAKER CONDENSER	20	
GF	21	S-550 BAG IN BOX RACK	20 A	1			564 VA	2370				00.4	DOMED COAK	22	05
	23	B-381 AMPROBE CO2 MONITOR	20 A	1					156 VA	2370	2	20 A	POWER SOAK	24	GF
	25				5040	500 VA					1	20 A	MUSIC SYSTEM (MUZAK)	26	
	27	TU-1	50 A	3			5040	1200						28	
	29								5040	1200	3	15 A	WALK-IN COOLER	30	
	31				5040	1200					1			32	
	33	RTU-2	90 A	3			5040	1393						34	
	35								5040	1393	3	20 A	WALK-IN FREEZER	36	
	37	Spare	20 A	1	0 VA	1393					1			38	
	39	Spare	20 A	1			0 VA	0 VA			1	20 A	Spare	40	
	41	Spare	20 A	1					0 VA	0 VA	1	20 A	Spare	42	
			Total	al Load:	2075	3 VA	2230	5 VA	2117	9 VA			•		
			Tota	l Amps:		3 A	18	6 A	17	7 A	1				
	Lege	end:		•											
Load Cla	eeifi	ication	Con	nected l	l nad	Der	mand Fa	ctor	Fetim	nated De	mand		Panel Totals		

Connected Load Demand Factor Estimated Demand Panel Totals Load Classification 4928 VA 100.00% 4928 VA HVAC Total Conn. Load: 64237 VA 30240 VA 100.00% 30240 VA 2300 VA 100.00% 2300 VA **Total Est. Demand:** 60951 VA Receptacle Total Conn. Current: 178 A Total Est. Demand Current: 169 A

CIRCUIT BREAKER/MISC. ACC. ABBREVIATIONS:

GF - GROUND FAULT CIRCUIT INTERRUPTER AF - ARC-FAULT CIRCUIT INTERRUPTER ST - SHUNT TRIP HL-ON - HANDLE-LOCK ON DEVICE HL-OFF - HANDLE-LOCK OFF DEVICE EPD - EQUIPMENT PROTECTION DEVICE IG - ISOLATED GROUND



08.09.22 IFB

CONTRACT DATE: BUILDING TYPE: END. MED20 PLAN VERSION: MARCH 2021 BRAND DESIGNER: DICKSON SITE NUMBER: STORE NUMBER: PA/PM: DRAWN BY.: 2021088.52

TACO BELL


1551 West River Rd. Elyria, OH



ENDEAVOR 2.0 ELECTRICAL SCHEDULES

PLOT DATE: 8/9/2022 1:14:19 PM



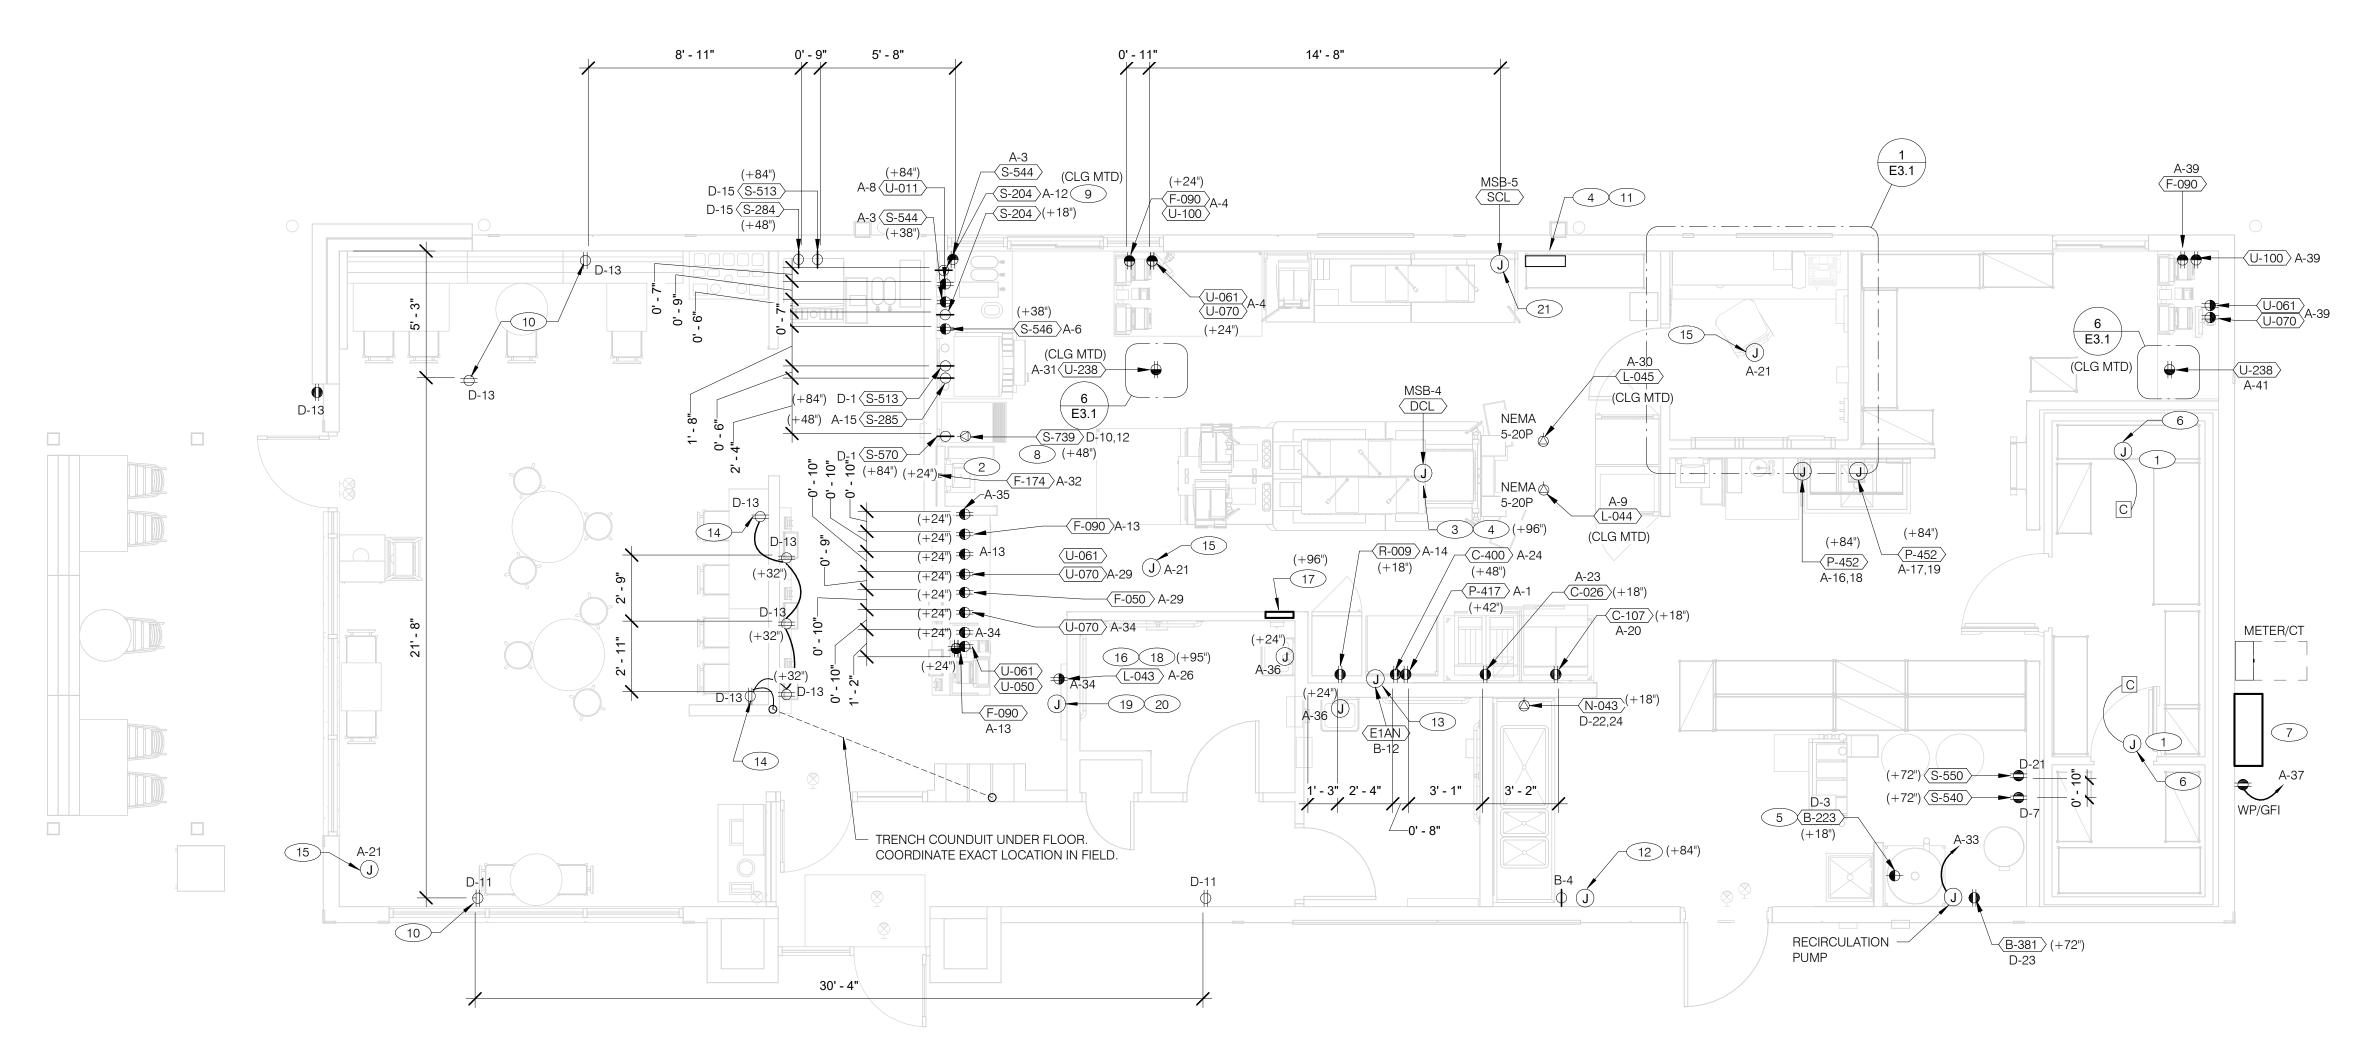

RECEPTACLE NOTE:

ALL RECEPTACLES IN PUBLIC AREAS SHALL BE TAMPER RESISTANT.

<u>NOTE</u>

5mA GFCI BREAKERS <u>MUST</u> BE USED WHERE OUTLETS REQUIRING GFCI PROTECTION ARE NOT ACCESSIBLE FOR COMPLIANCE WITH NEC 210.8. WHERE GFCI PROTECTION AND SHUNT TRIP IS REQUIRED, THE CIRCUIT SHALL HAVE A GFCI BREAKER AND PASS THROUGH THE TBANS PANEL.REFER TO DETAILS IN E7.0 AND E7.1.

(10) PROVIDE TAMPER RESISTANT DUPLEX RECEPTACLE WITH TWO (2)

(11) VERIFY PANEL LOCATION OF COOK LINE WITH TACO BELL CONSTRUCTION MANAGER PRIOR TO INSTALLATION.

USB CHARGING PORTS.

A 3 POLE, 200 AMP CIRCUIT BREAKER IN MAIN SWITCHBOARD. SEE SHEET E2.0. VERIFY

PROVIDE J-BOX FOR POWER SOAK INDICATOR LIGHT. (OPTIONAL)

13 VERIFY LOCATION OF JUNCTION BOX WITH CONSTRUCTION (14) E.C. SHALL PROVIDE, INSTALL AND WIRE A DUPLEX RECEPTACLE

TABLE, AT EACH END OF THE TABLE. PROVIDE GALVANIZED COVER PLATE TO MATCH BOX. PROVIDE POWER FOR SECURITY CAMERAS. COORDINATE WITH

WITH (2) USB POWER PORTS IN SINGLE-GANG BOX PROVIDED WITH

CAMERA VENDOR, SECURITY, AND CONSTRUCTION SUPERVISOR PRIOR TO ROUGH-IN.

(16) QUAD RECEPTACLE FOR FUTURE DIGITAL MENUBOARD. TYPICAL OF

✓ 2-GANG FLUSH BOX WITH DEAD-FRONT GFCI DEVICES. MOUNT CENTER OF BOX AT 48" A.F.F.. REFER TO E7.0.

(18) EC / GC TO INSTALL A TOTAL OF (2) QUAD OUTLETS IN (2) QUAD BOXES ON FRONT OF VALANCE WALL AS SHOWN. OUTLETS TO BE STRAIGHT BLADE. OUTLETS TO BE ON AN ISOLATED/DEDICATED GROUNDED CIRCUIT THAT IS NOT CONNECTED TO ANY RESTAURANT POWER MANAGEMENT SYSTEM.

(19) EC / GC TO INSTALL (1) OPEN DATA JUNCTION BOX (JB) IN VALANCE WALL. CONDUIT TERMINATED ABOVE CEILING TO HAVE BUSHING.

(20) EC / GC TO RUN (3) ORANGE CAT 6 LINES FROM NETWORK SWITCH TO DATA JUNCTION BOX. CAT6 LINES SHOULD HAVE BOTH ENDS PROPERLY TERMINATED WITH RJ-45 CONNECTORS. EXCESS CAT6 CABLE TO BE COILED INTO SERVICE LOOPS AT EACH END AND LEFT ACCESSIBLE FOR DMB INSTALL TEAM. CAT6 TO BE RUN IN ACCORDANCE WITH ALL LOCAL MUNICIPALITY CODE REQUIREMENTS.

POWER PLAN 1/4" = 1'-0"

(21) CONNECT PRODUCTION LINE CIRCUIT BREAKER PANEL VIA UTILITY CHASE IN CEILING TO A 3 POLE, 125 AMP CIRCUIT BREAKER IN MAIN SWITCHBOARD. SEE SHEET E2.0. VERIFY ALL REQUIREMENTS WITH ACTUAL EQUIPMENT SPECIFIED. THE MANUFACTURER WILL FULLY PRE-WIRE THE COMPLETE MAPS LINE AT THE FACTORY. THE UNITS WILL THEN BE PULLED APART FOR SHIPPING PURPOSES. ALL CONNECTION POINTS WILL BE MARKED. THE CONDUIT RUNS WILL BE COILED UP FOR FIELD INSTALLATION. SOME ELECTRICAL COMPONENTS MAY BE REMOVED FOR EASE OF DISASSEMBLING THE LINE-UP. THE ELECTRICA CONTRACTOR WILL BE FULLY RESPONSIBLE FOR MAKING THE PROPER FIELD CONNECTIONS FROM THE ROUGH-IN LOCATION TO THE MANUFACTURER PROVIDED BREAKER PANEL BOX. IN ADDITION, THE ELECTRICAL CONTRACTOR WILL BE RESPONSIBLE FOR ANY SPLICE POINTS AND/OR JUNCTION BOXES THAT NEED TO BE RECONNECTED. SOME ELECTRICAL COMPONENT ASSEMBLY MAY ALSO BE REQUIRED.

CONTRACT DATE: BUILDING TYPE: END. MED20

08.09.22 IFB


PLAN VERSION: MARCH 2021 BRAND DESIGNER: DICKSON SITE NUMBER: 315672 STORE NUMBER:

TACO BELL

2021088.52

DRAWN BY.

1551 West River Rd.

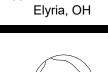



ENDEAVOR 2.0 ELECTRICAL POWER PLAN

ALL DIMENSIONS TO J-BOXES ARE FROM FACE OF STUD TO CENTER OF BOX,

ALL CONDUIT DROPS ARE INSIDE WALLS U.O.N. SEE ARCH. DWGS FOR WALL

ALL J-BOX CIRCUITS, CONDUITS, FIXTURES, ETC. SHALL BE AS INDICATED ON THE ELECT. DWGS AND SPECS.

CONTRACTOR SHALL VERIFY UNDERGROUND CONDUIT LOCATIONS PRIOR TO POURING SLAB. IT IS THE RESPONSIBILITY OF THE CONTRACTOR TO COORDINATE THIS DATA ON THE

DWGS AND THE EQUIPMENT ACTUALLY SUPPLIED, AND TO CONFIRM THE CORRECTNESS OF ANY DIMENSIONS HEREIN.

LOCATION OF ELECT. ROUGH-INS WITH INFO PROVIDED ON THE ARCH. AND STRUCT.

LOCATIONS OF ALL OUTLETS MAY BE RELOCATED TO NEAREST STUD. DO <u>NOT</u> CUT INTO STUDS.

FOR EXACT LOCATIONS OF KITCHEN & MECHANICAL EQUIPMENT AND POINTS OF CONNECTION, REFER TO KITCHEN & MECHANICAL EQUIPMENT DRAWINGS AND MANUFACTURER'S SHOP DRAWINGS.

ALL CIRCUIT FEEDERS AND DISCONNECTS SHALL BE SIZED BY NEC.

CONTRACTOR SHALL VERIFY CIRCUIT BREAKER, DISCONNECT SWITCH, STARTER AND FUSE SIZES WITH SELECTED EQUIPMENT MANUFACTURER'S SHOP DRAWINGS PRIOR TO PLACING ORDER AND PROVIDE EVERYTHING AS REQUIRED.

ELECTRICAL EQUIPMENT ENCLOSURES SHALL BE NEMA-1 FOR INTERIOR AND NEMA 3R FOR EXTERIOR. IN COASTAL REGIONS THE STANDARD FOR OUTSIDE SHALL BE NEMA-4X.

PER SECTION 210.8 NEC 2020, ALL SINGLE PHASE RECEPTACLE RATED 150 VOLTS TO GROUND OR LESS, 50 AMPERES OR LESS AND THREE-PHASE RECEPTACLES RATED 150 VOLTS TO GOUND OR LESS, 100 AMPERERS OR LESS, SHALL BE PROVIDED WITH GFCI PERSONNEL PROTECTION.

DO NOT MEASURE/LOCATE OUTLETS ON DRAWINGS. USE DIMENSIONS PROVIDED.

M. CONDUIT MAY RUN UNDER SLAB AT G.C.'S DISCRETION.

E.C. SHALL PROVIDE A PREPRINTED SELF-ADHESIVE LABEL ON ALL POS RECEPTACLES STATING "POS USE ONLY".

PROVIDE ESCUTCHEON PLATES AND SEALANT AT ALL UTILITY PENETRATIONS INTO WALLS, CEILING, AND FLOORS. DO NOT USE CAULKS OR EXPANSION FOAM FOR SEALANT.

ARMOR CABLE (BX) ALLOWED WHERE ACCEPTABLE BY CODE. ALL WIRE SHALL BE CONCEALED O.N.U.

FOR ALL CIRCUITS NOT SHOWN ON EQUIPMENT SCHEDULE, CONTRACTOR SHALL PROVIDE CONDUCTOR AND CONDUIT SIZES AS SHOWN ON BRANCH CIRCUIT WIRING SCHEDULE SHOWN ON E2.2. IF SIZES DIFFER FROM N.E.C., THE MORE STRINGENT (LARGER) SIZE SHALL BE PROVIDED.

OUTLETS WITHIN FOH TO BE AT 18" AFF FOR ADA ACCESS.

CONDUITS NEAR DRIVE THRU WINDOW AREA TO BE ROUTED FROM ABOVE CEILING OR STUBBED UP FROM UNDER SLAB SO AS TO NOT INTERFERE WITH WINDOW FRAMING.

5 LOCATED INSIDE SHELL OF HEATER.

(4) EQUIPMENT CABINET.

REFER TO ROOF PLAN.

(6) INSTALL CONTROL CABLE FROM FREEZER/COOLER FAN COIL TO ROOF MOUNTED

2 INSTALL IN CONDUIT RUNNING ON SURFACE OF KITCHEN SIDE OF CABINETRY REAR

3 CONNECT PRODUCTION LINE CIRCUIT BREAKER PANEL VIA UTILITY CHASE IN CEILING TO

ALL REQUIREMENTS WITH ACTUAL EQUIPMENT SPECIFIED. THE MANUFACTURER WILL

PULLED APART FOR SHIPPING PURPOSES. ALL CONNECTION POINTS WILL BE MARKED.

THE CONDUIT RUNS WILL BE COILED UP FOR FIELD INSTALLATION. SOME ELECTRICAL

COMPONENTS MAY BE REMOVED FOR EASE OF DISASSEMBLING THE LINE-UP. THE

ELECTRICAL CONTRACTOR WILL BE FULLY RESPONSIBLE FOR MAKING THE PROPER

RESPONSIBLE FOR ANY SPLICE POINTS AND/OR JUNCTION BOXES THAT NEED TO BE

RECONNECTED. SOME ELECTRICAL COMPONENT ASSEMBLY MAY ALSO BE REQUIRED.

PROVIDED BREAKER PANEL BOX. IN ADDITION, THE ELECTRICAL CONTRACTOR WILL BE

FIELD CONNECTIONS FROM THE ROUGH-IN LOCATION TO THE MANUFACTURER

FULLY PRE-WIRE THE COMPLETE MAPS LINE AT THE FACTORY. THE UNITS WILL THEN BE

(7) LOCATE SWITCHGEAR PER GUIDELINES ON SHEET A4.1.

(8) PROVIDE BOOST TRANSFORMER (208V, 1-PHASE IN, 240V, 1-PHASE OUT) FOR FROZEN BEVERAGE DISPENSER.


9 CEILING MOUNTED RECEPTACLE FOR WALL MOUNTED HME. SEE 7/E3.1


GENERAL NOTES - ELECTRICAL POWER PLAN NTS

KEY NOTES - ELECTRICAL POWER PLAN NTS

GPD GROUP

520 S. MAIN STREET, SUIT 2531 AKRON, OH 44311 330.572.2100 FAX: 330.572.2102

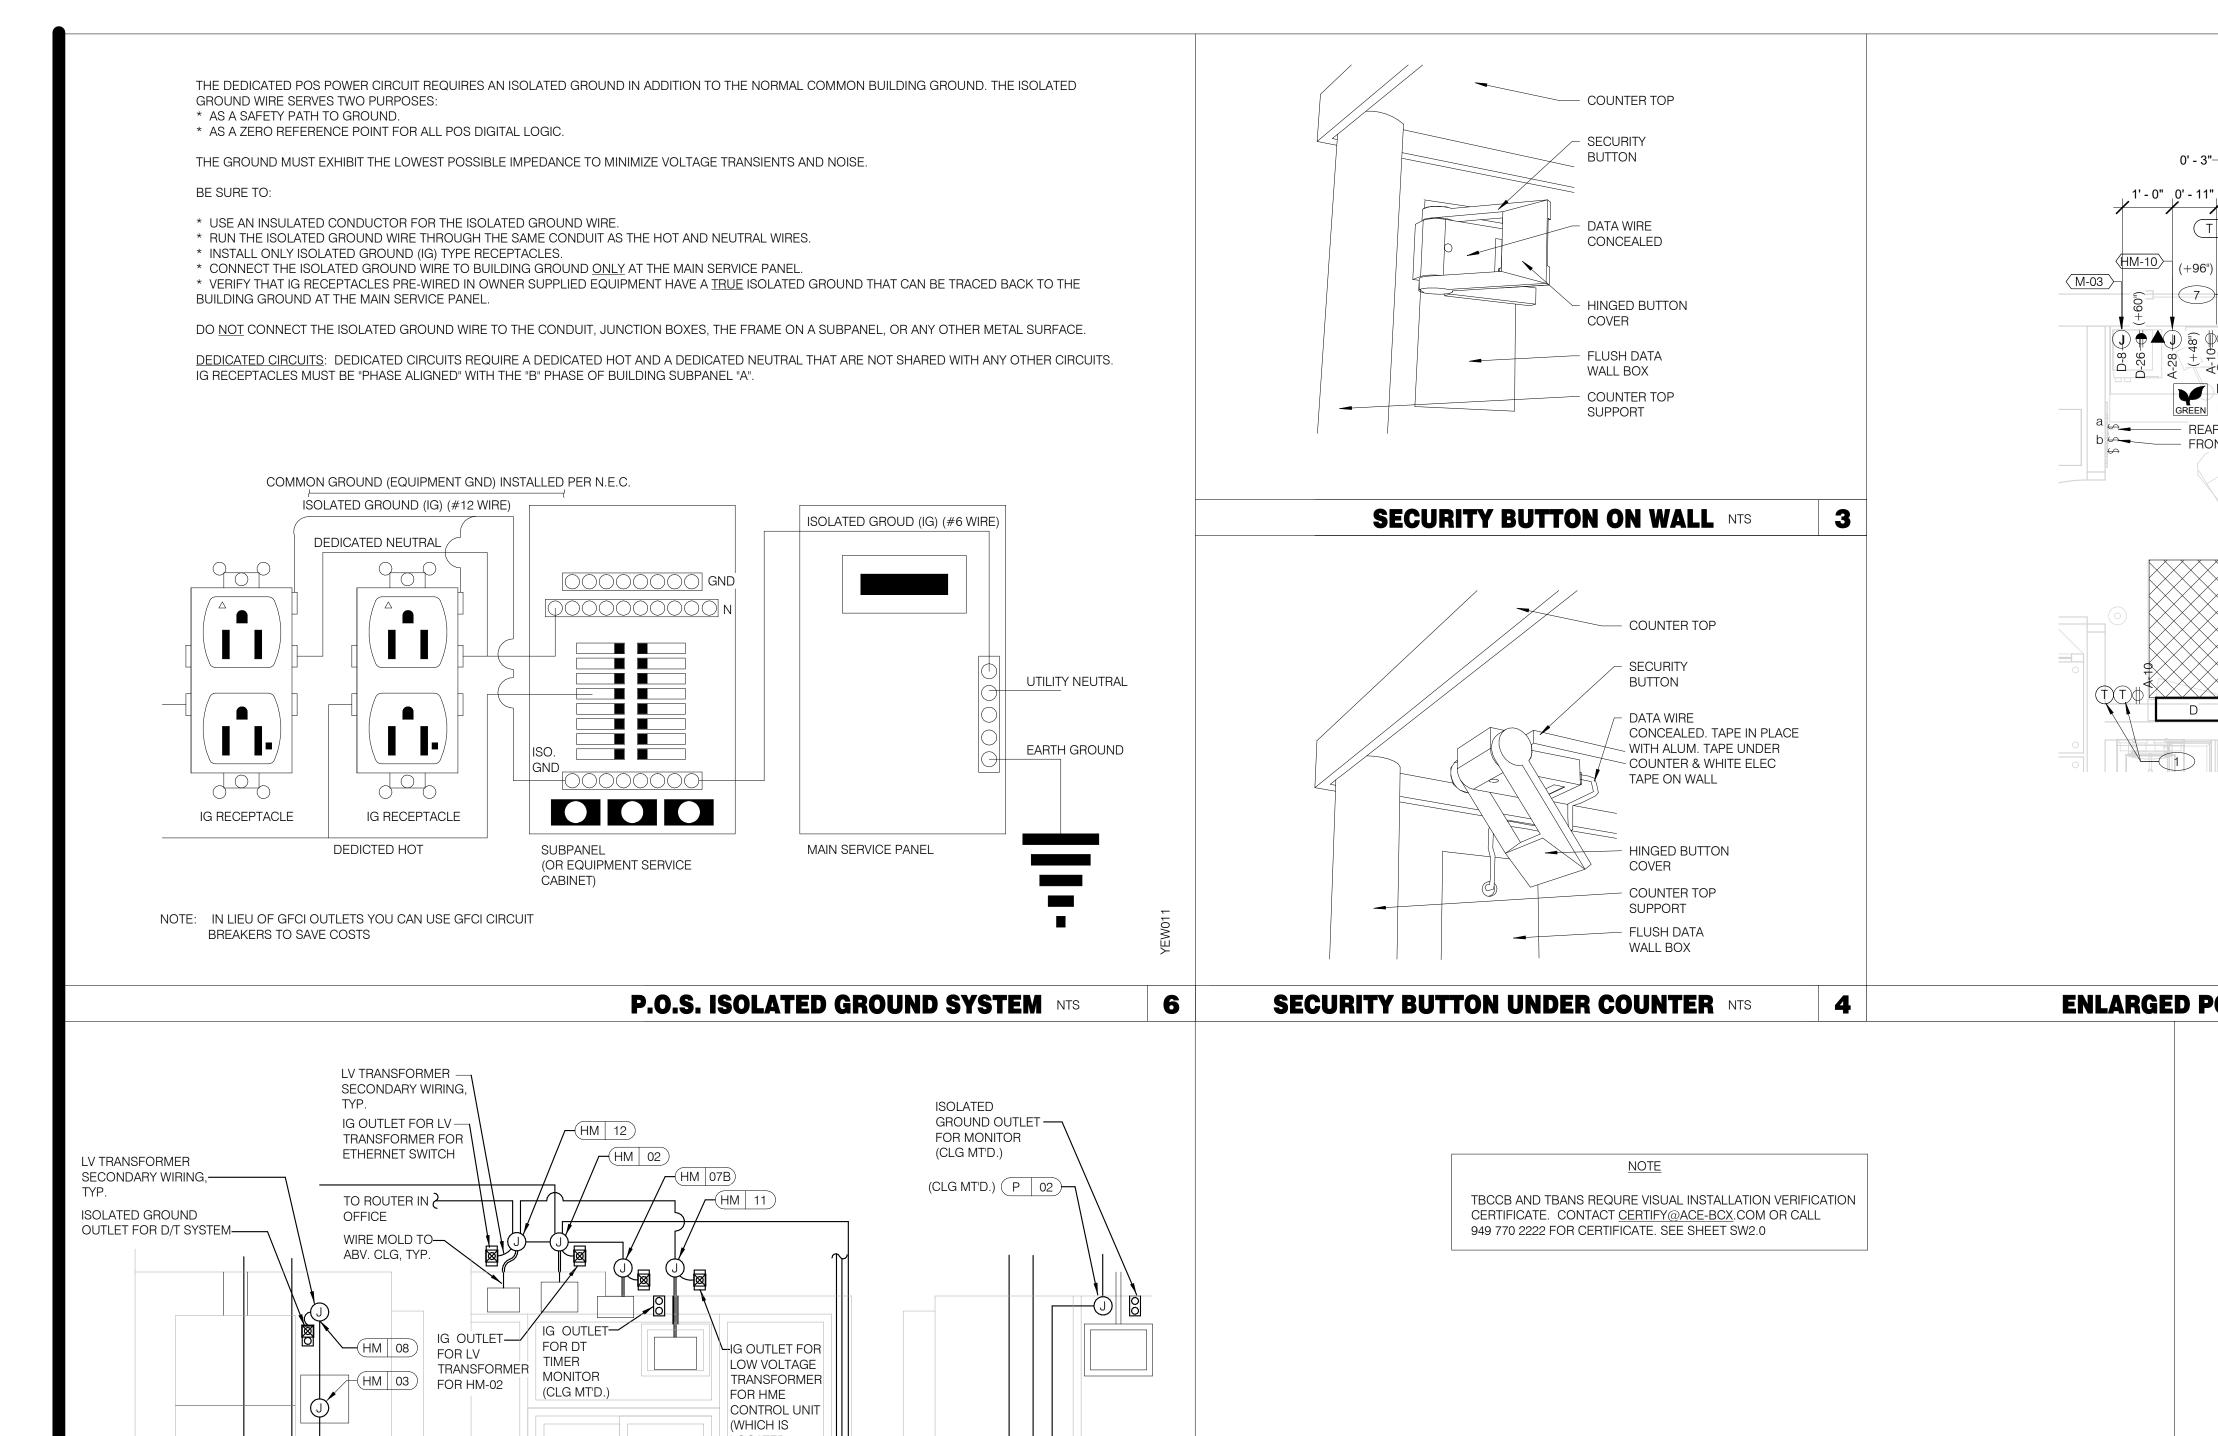

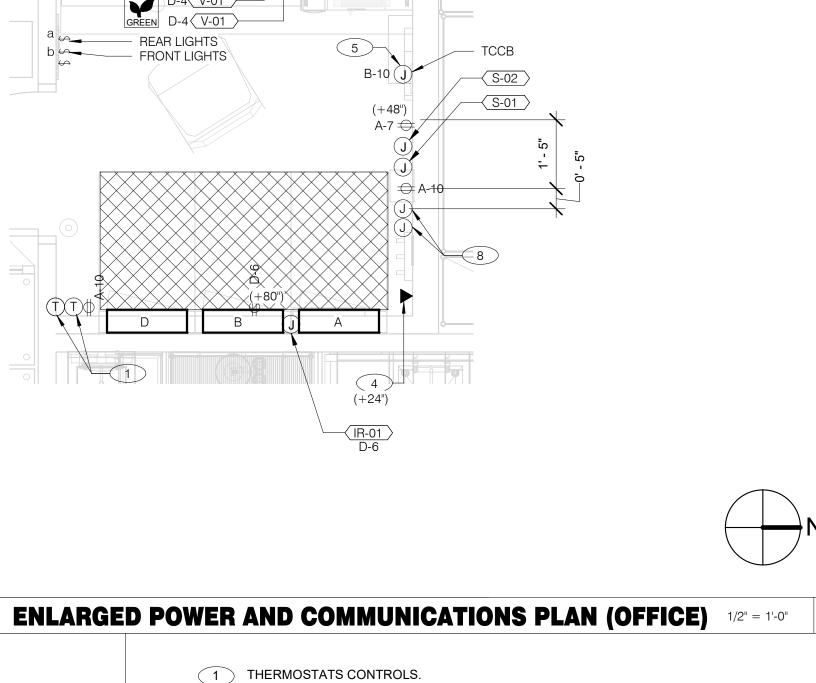

08.09.22 IFB

CONTRACT DATE: **BUILDING TYPE:** END. MED20 PLAN VERSION: MARCH 2021 BRAND DESIGNER: DICKSON SITE NUMBER: STORE NUMBER: PA/PM: DRAWN BY.

TACO BELL

2021088.52

1551 West River Rd. Elyria, OH



ENDEAVOR 2.0 ENLARGED POWER PLAN AND DETAILS

2 NOT USED.

3 NOT USED.

4 PHONE JACK FOR MODEM.

5 LOCATION OF TBCCB COMBINED CONTROL BOX. COORDINATE EXACT LOCATION IN THE FIELD. CONSIDER OPERATOR NEED TO ACCESS SWITCHES ON THE FRONT OF THE CONTROL BOX AND BUILT IN OCCUPANCY SENSOR FOR MANAGERS OFFICE.

6 DATA JACK FOR TECH-IN-A-BOX WITH 2 PORTS.


7 ROUTE CIRCUIT THROUGH TBCCB OCCUPANCY SENSOR FOR CONTROLLED RECEPTACLE.


PROVIDE BACK-BOX AND CONDUIT WITH PULLSTRING FOR REMOTE TEST STATIONS PROVIDED BY MECHANICAL. COORDINATE REQUIREMENTS WITH MECHANICAL.

LOCATED BEHIND MONITOR) —(HM | 07A) SURFACE V 02 P 04 P 07)— P 07 (HM 04)— $(P \mid 04)$ (1) 1" DIA. CONDUIT — ISOLATED GROUND OUTLET-FOR VSAT & ALT. PAYMENT CONDUIT IN WALL (TYP.) SEE-ROUTER SCHEDULE FOR SIZE ISOLATED GROUND OUTLET-

REFER TO COMMUNICATIONS SCHEDULE ON SHEET E5.0 FOR EQUIPMENT DESCRIPTIONS/MOUNTING HTS.

520 S. MAIN STREET, SUIT 2531 AKRON, OH 44311 330.572.2100 FAX: 330.572.2102

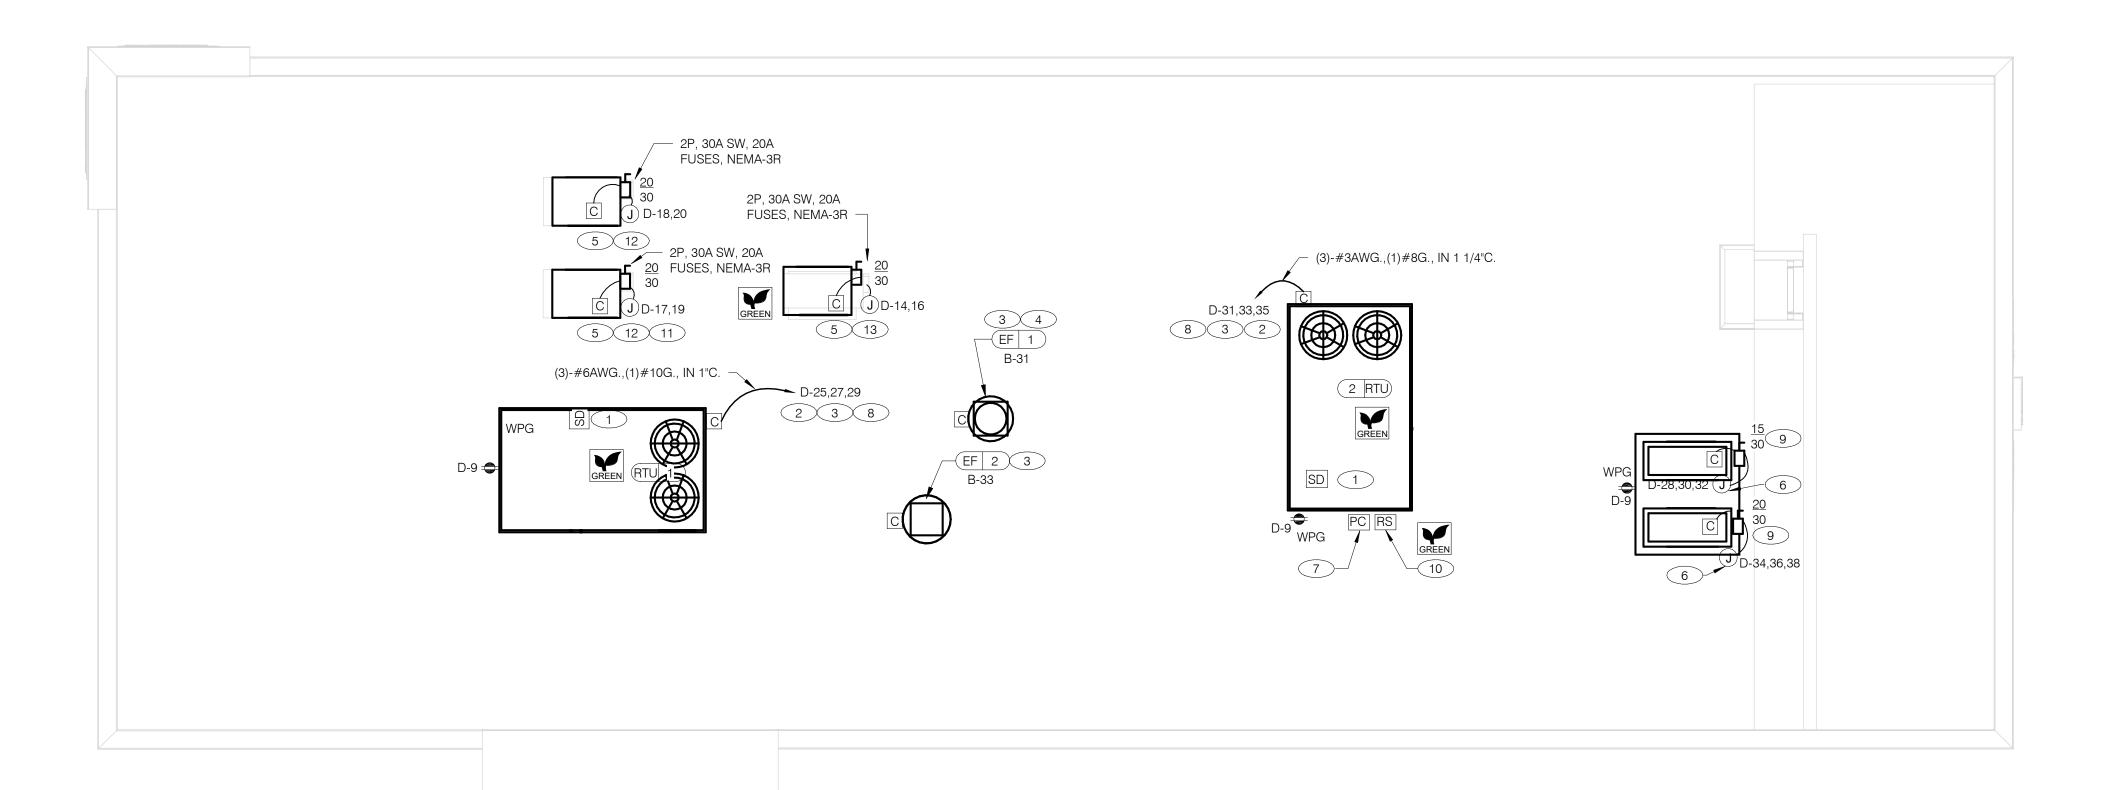

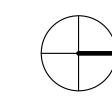

- A. NO CONDUIT SHALL BE FASTENED DIRECTLY TO OR THROUGH ROOFING MEMBRANE.
- B. ALL CUTS IN ROOFING MEMBRANE SHALL BE MINIMAL AND IN ACCORDANCE WITH ROOFING MFR'S AND INSTALLER'S REQ'S.
- C. REFER TO MECH. DWGS FOR MECHANICAL EQUIPMENT ELECTRICAL REQ'S.
- ALL EXPOSED ELECTRICAL CONDUITS SHALL PENETRATE ROOF MEMBRANE AT PIPE HOODS U.O.N.
- REFER TO ELECT. EQUIP. SCHEDULE AND ELECT. ROUGH-IN PLAN.
- ALL CONDUITS FROM EXHAUST FANS SHALL BE ROUTED INSIDE OF CURB.
- G. ALL CONDUITS TO AND FROM RTU SHALL BE ROUTED INSIDE OF RTU CURB. COORDINATE WITH RTU MFR RECOMMENDATIONS.
- H. REFER TO GENERAL NOTES SHEET E2.0 FOR IMPORTANT INFORMATION.
- I. ALL WIRING AND CONDUITS SHALL BE CONCEALED. NO CONDUITS PERMITTED TO RUN EXPOSED ACROSS ROOF DECK. ROUTE ALL CONDUITS THROUGH EQUIPMENT ROOF CURBS OR ARCHITECT SPECIFIED ROOF PENETRATIONS.
- J. ARMOR CABLE (BX) IS ONLY TO BE ALLOWED WHERE ACCEPTABLE BY AUTHORITY HAVING

MECHANICAL CONTRACTOR SHALL PROVIDE CONNECTIONS BETWEEN RTU FACTORY SMOKE DETECTORS AND REMOTE ENNUNCIATOR, TEST AND RESET DEVICE IN MANAGER OFFICE. ELECTRICAL CONTRACTOR SHALL PROVIDE ANY NECESSARY CONDUITS FOR LOW VOLTAGE WIRING

- 2 SPECIFIED RTU IS SUPPLIED WITH UNPOWERED, WEATHERPROOF GFCI CONVIENENCE OUTLET AND FACTORY INSTALLED HACR CIRCUIT BREAKER WITH WEATHER TIGHT ENCLOSURES AND ACCESS THRU SWINGING DOOR.
- POWER AND CONTROL IN FLEXIBLE WATERPROOF CONDUIT (LFMC CONDUIT) TO ENTER FROM SIDE OF THE CURB AND UP TO FACTORY PROVIDED DISCONNECT SWITCH. COORDINATE WITH MECHANICAL CONTRACTOR.
- CONNECT TO APPROPRIATE TERMINALS OF TBCCB CONTROL BOX. SEE E6.1 FOR DETAILS.
- 5 1/2" C, WITH REQ'D CONDUCTORS TO J-BOX IN CEILING ABOVE ICE MACHINE. MAKE CONNECTION TO ICE MACHINE AND CONDENSING UNIT.
- 6 REFER TO POWER PLAN FOR CONTINUATION TO COOLER / FREEZER.
- CONNECT TO APPROPRIATE PHOTOCELL TERMINALS OF TBCCB CONTROL BOX. SEE E6.1 FOR DETAILS.
- 8 RTU'S SHALL BE PROVIDED WITH BUILT-IN DISCONNECT AND SINGLE POINT WIRING.
- 9 CONTRACTOR SHALL VERIFY CIRCUIT BREAKER TYPE, STARTER, DISCONNECT SWITCH, AND FUSE SIZE (IF REQUIRED) WITH SELECTED EQUIPMENT MANUFACTURER'S SHOP DRAWINGS PRIOR TO PLACING ORDER AND FURNISH AND INSTALL EVERYTHING AS REQUIRED.
- 10 RAIN SENSOR. GREEN GREEN
- ELECTRICAL CONTRACTOR SHALL MAKE ALL ELEC. CONNECTIONS INCLUDING ALL NECESSARY INTERCONNECTIONS BETWEEN THE COMPRESSOR ON THE ROOF & THE EVAPORATOR IN THE ICE MACHINE AS REQ'D. REFER TO THE MFR'S SHOP DWGS FOR EXACT INSTALL. & INTERCONNECTION RQMTS, PRIOR TO ROUGH-IN INSTALL.

POWER ROOF PLAN 1/4" = 1'-0"

13 1/2" C, WITH REQ'D CONDUCTORS TO J-BOX IN CEILING ABOVE FROZEN BEVERAGE MACHINE. MAKE CONNECTION TO BEVERAGE MACHINE AND ASSOCIATED CONDENSING UNIT.

CONTRACT DATE: 10.05.21
BUILDING TYPE: END. MED20
PLAN VERSION: MARCH 2021

BUILDING TYPE: END. MED20
PLAN VERSION: MARCH 2021
BRAND DESIGNER: DICKSON
SITE NUMBER: 315672
STORE NUMBER: 455386
PA/PM: JG

DRAWN BY.: AJR

JOB NO.: 2021088.52

TACO BELL

1551 West River Rd. Elyria, OH



ENDEAVOR 2.0
ELECTRICAL
POWER ROOF
PLAN


E3.2

PLOT DATE: 8/9/2022 1:14:26 F

B



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120 V/1-3 VA

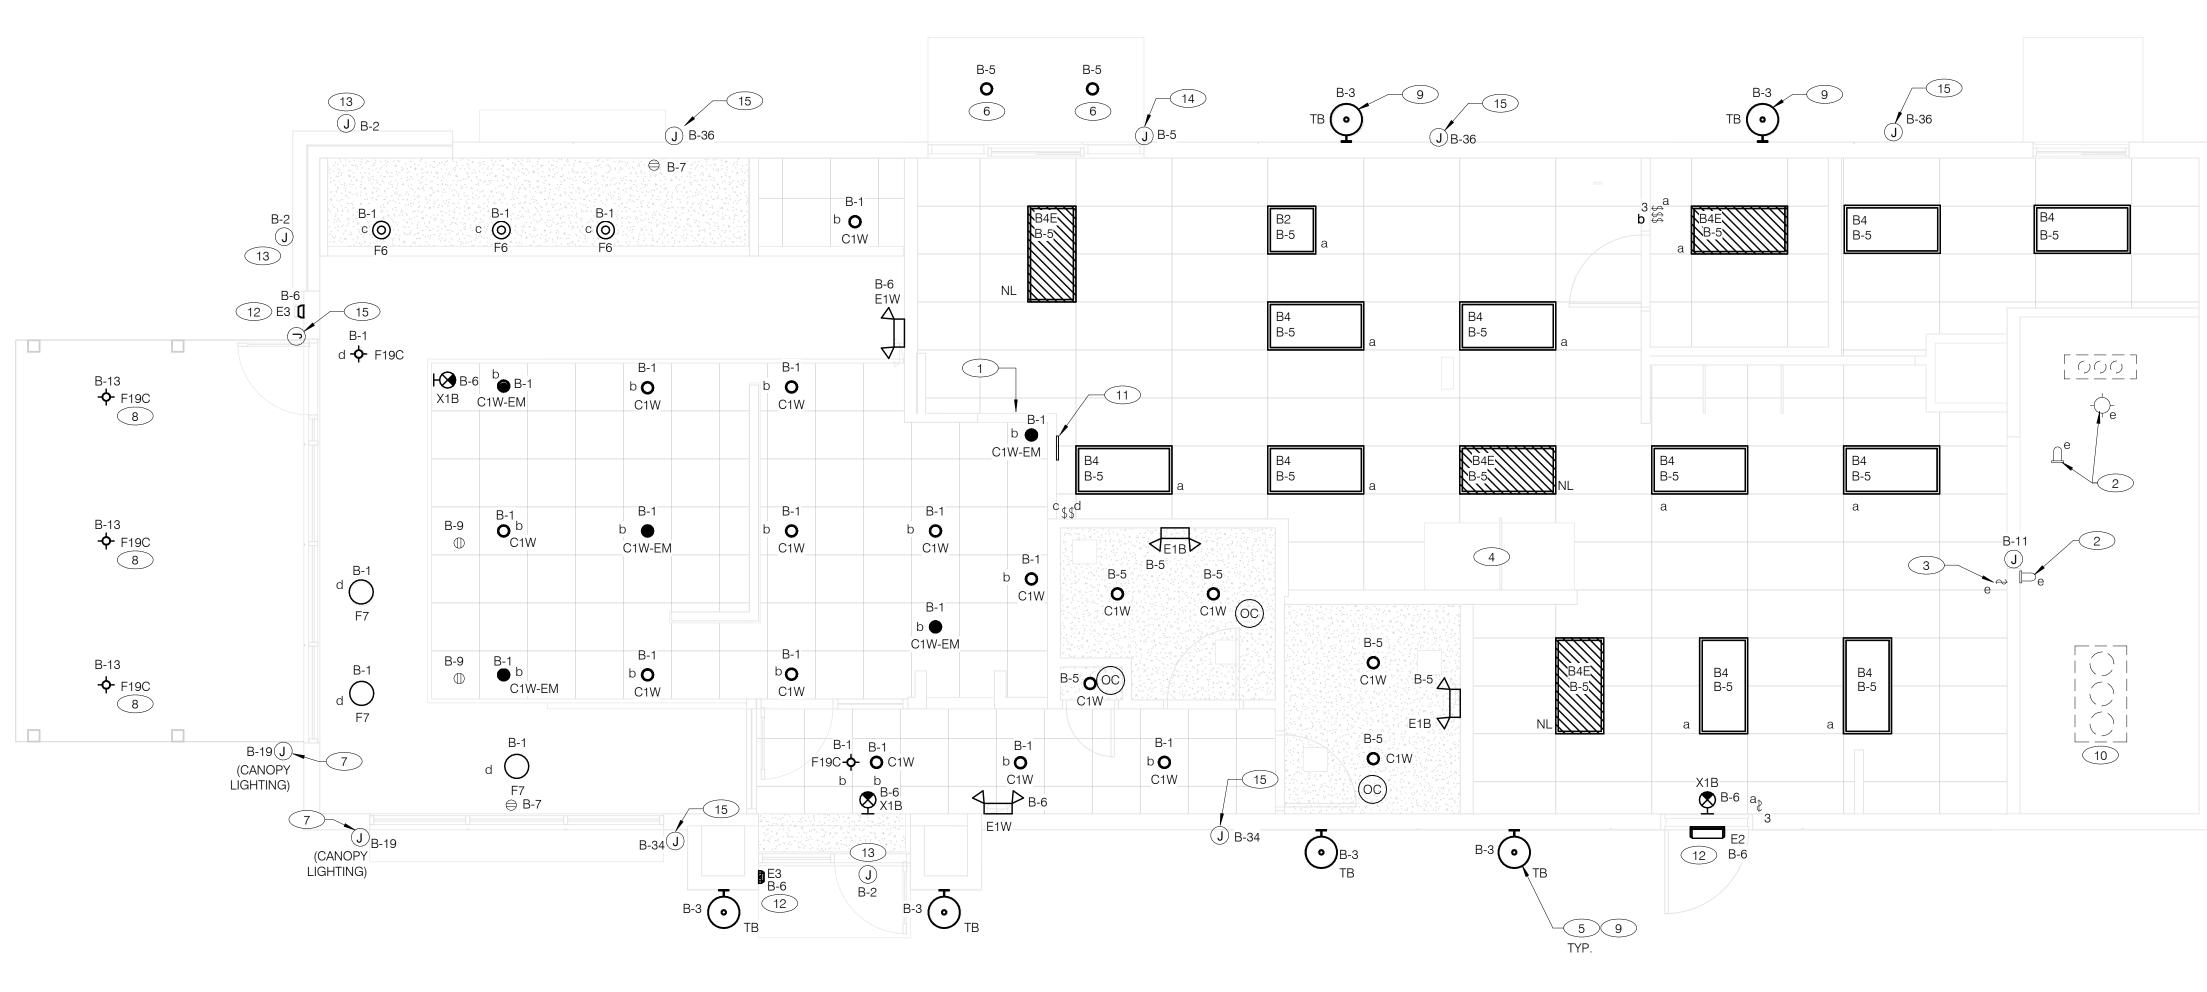GENERAL NOTES:

CONFIRM LIGHTING FIXTURE QUANTITIES WITH SUPPLIER.

EMERGENCY AND NORMAL LIGHTING MARKED WITH "NL" SUBSCRIPT SHALL OPERATE CONTINUOUSLY. PROVIDE <u>UNSWITCHED</u> HOT TO NORMAL AND EMERGENCY BALLAST.

LIGHTING SWTICH AS INDICATED. PROVIDE <u>UNSWITCHED</u> CONSTANT HOT TO EMERGENCY BALLAST AND <u>SWITCHED</u> HOT TO NORMAL BALLAST.

ALL CONDUITS ENTERING OR LEAVING COOLER/FREEZER SHALL BE PROVIDED WITH SEAL-OFF

FITTING WITH COMPOUND PER NEC 300-(7a).

ALL INTERIOR LIGHTING CIRCUITS TO BE WIRED THROUGH TBCCB. SEE E6.0 AND E6.1. CONTRACTOR TO FIELD VERIFY CEILING TYPE AND PROVIDE PROPER MOUNTING HARDWARE.

ALL FIXTURES SUPPLIED WITH LAMPS.

ALL EXTERIOR NON-EMERGENCY LIGHT FIXTURES, BUILDING SIGNS, AND EXTERIOR SIGNS SHALL BE CONTROLLED THROUGH PHOTOCELL AND LIGHTING CONTROL RELAYS. SEE E6.0 AND E6.1 FOR ADDITIONAL DETAILS.

ELECTRICAL LIGHTING PLAN	1/4" = 1'-0"
---------------------------------	--------------

NO.	MANUFACTURER	CATALOG NUMBER	DESCRIPTION	MOUNTING	LAMP #/TYPE	TYPE	ELECTRICAL DATA	REMARKS
A	HUBBELL LIGHTING	VP-2-320L-315-4K7-3-UNV-A-DBT	LED POLE LIGHT	25' LIGHT POLE	LED LAWF #/TIFL	NA NA	120 V/1-312 VA	KLIVIAIKKS
В	HUBBELL LIGHTING	VP-2-320L-315-4K7-4W-UNV-A-DBT	LED POLE LIGHT	25' LIGHT POLE	LED	NA	120 V/1-312 VA	-
B2	ABB	FLP22-D53W40	2X2 LED TROFFER	23 EIGITI FOLL	LED	INA	120 V/1-312 VA	-
B4	ABB	FLP24-D53W40	2X4 LED TROFFER		LED		120 V/1-45 VA	-
B4E	ABB	FLP24-D53W40-EM	2X4 LED TROFFER		LED		120 V/1-45 VA	PROVIDE 90 MIN. BACK UP
		FLF24-D53W40-EIW	ZA4 LED TROFFER		LED			BATTERY
С	HUBBELL LIGHTING	VP-2-320L-315-4K7-5QW-UNV-A-DBT	LED POLE LIGHT	25' LIGHT POLE	LED	NA	120 V/1-312 VA	-
C1W	MAXLITE	B6IC-AT-W- LED14DR5630KB95	LED TRIM 14W 6" RECESSED 30K 80CRI WHITE TRIM, W/ ELITE B6IC-AT-W 6" IC AIR SHUT HOUSING		LED		120 V/1-14 VA	-
C1W-EM	MAXLITE	B6IC-AT-W- LED14DR5630KB95	LED TRIM 14W 6" RECESSED 30K 80CRI WHITE TRIM, W/ ELITE B6IC-AT-W 6" IC AIR SHUT HOUSING		LED		120 V/1-14 VA	PROVIDE 90 MIN. BACK UP BATTERY
E1B	ELITE	ELM-809-B	EMERGENCY LIGHT FROG EYE - BLACK	WALL, TOP @ 9'-4" U.O.N.	-	EM	120 V/1-12 VA	-
E1W	ELITE	ELM-809-W	EMERGENCY LIGHT FROG EYE - WHITE	WALL, TOP @ 9'-4" U.O.N.	-	EM	120 V/1-12 VA	-
E2	ELITE	ELM-807-SDT-BZ	CAMRAY LED EM WALL MNT, DRK BRNZ, CLD WEATHER	UNIVERSAL	-	EM	120 V/1-16 VA	-
E3	LITHONIA	AFF-PEL-DDBTXD-UVOLT-LTP-SDR T-WT-CW	SELF-POWERED EMERGENCY WALLPACK W/ PHOTOCELL	8'-6"	LED	EM	120 V/1-20 VA	
F6	KICHLER	43852OZ	9.75" GLASS PENDANT AVERY WITH MED BASE SOCKET RATED 100W MAX OLDE BRONZE FINISH	PENDANT, 6'-0" A.F.F.	1/LED AAMSCO LED-6W-ST64HYBRID-DIM	NA	120 V/1-100 VA	PLACEHOLDER INCLUDES LAMP
F7	HI-LITES	H24212-96-CB15-20WLBL-6OP	12" GALVANIZED PENDANT WITH BLACK CORD AND CANOPY MED BASE SOCKET	PENDANT, 6'-0" A.F.F.	1/LED 10A19D0D27K	NA	120 V/1-20 VA	-
F19C	SPECTRUM LIGHTING	SPCO304INC-MWL(25W)PAR20-CM- 180"-MB	LED PENDANT - 3"		1/LED LR20/40/27K/975/BK		120 V/1-9 VA	-
ТВ	ACCUSERV	05247-051/052	WALL SCONCE, CUSTOM DARK BRONZE FINISH	SEE EXTERIOR ELEVATIONS	18W PAR38 LED		120 V/1-36 VA- 0 V/1-0 VA	

-/LED

LED UNIVERSAL MNTG THERMOPLASTIC UNIVERSAL

EXIT, RED LETTERS, BLACK HSNG

LIGHTALARMS

GRANNRB

1 PRE-FABRICATED & PRE-FINISHED SOFFIT. REFER TO A7.1 FOR SPECIFICS. (OPTIONAL).

FOR LIGHTING FIXTURES, CONDUIT, CONDUCTORS AND INSTALLATION RESPONSIBILITIES, REFER TO SCOPE OF WORK.

FIXTURE AND SWITCH FACTORY INSTALLED WITH UNIT. G.C. TO COMPLETE CIRCUITING.

EXHAUST HOOD LIGHT FIXTURES SUPPLIED WITH HOOD AND MTD IN PRE-WIRED J-BOX. COMPLETE CIRCUITING PER SHEET E6.1.

5 COORD. J-BOX LOCATION WITH WOOD FRAMING SO IT REMAINS CONCEALED BEHIND FIXTURE. VERIFY MOUNTING HEIGHT

WITH ARCH. DWGS.

6 PROVIDE POWER TO DRIVE THRU CANOPY LIGHTING FIXTURES. COORDINATE EXACT LOCATION AND REQUIREMENTS WITH CANOPY VENDOR AND CONSTRUCTION SUPERVISOR PRIOR TO CONNECTIONS.

PROVIDE POWER CONNECTION TO CANOPY AT FACTORY INSTALLED DISCONNECT SWITCH FOR CANOPY LIGHTS. LIGHTS ARE

FURNISHED WITH CANOPY. PROVIDE ALL REQUIRED FIELD WIRING. COORDINATE REQUIREMENTS WITH MANUFACTURUER. 8 PROVIDE POWER FOR FREE STANDING CANOPY LIGHTING. E.C. SHALL RUN FEEDERS THROUGH COLUMNS TO LIGHTING FIXTURES. COORDINATE EXACT LOCATION AND REQUIREMENTS WITH LIGHTING VENDOR AND CONSTRUCTION SUPERVISOR

9 REFER TO ARCHITECTURAL EXTERIOR ELEVATIONS ON A4.0 AMD A4.1 FOR DIMENSIONED LOCATION OF FIXTURE.

10 SEAL ALL ELECTRICAL CONDUITS INTO THE WALK-IN COOLER.

ALERT LIGHT: ONLY APPLIES WHEN A GEN IV POWER SOAK IS USED. DISREGARD IF GEN III POWER SOAK IS NOT USED. SEE SHEET E3.0 FOR POWER REQUIREMENTS.

(12) MOUNT "E3" AT 8'-6" A.F.G. TO CENTER OF FIXTURE.

(13) Verify mounting height for Sign Power with Architectural elevations and Sign Vendor.

PROVIDE POWER CONNECTION TO CANOPY AT FACTORY INSTALLED DISCONNECT SWITCH FOR CANOPY LIGHTS. LIGHTS ARE FURNISHED WITH CANOPY. PROVIDE ALL REQUIRED FIELD WIRING. COORDINATE REQUIREMENTS WITH MANUFACTURUER.

PROVIDE POWER CONNECTION TO PURPLE WALLWASH LIGHTS FURNISHED BY SIGN VENDOR. PROVIDE ALL REQUIRED FIELD WIRING. CONTROL FIXTURES WITH EXTERIOR LIGHTING FIXTURES. WIRING. CONTROL FIXTURES WITH EXTERIOR LIGHTING FIXTURES. COORDINATE EXACT LOCATIONS WITH ARCHITECTURAL ELEVATIONS. COORDINATE REQUIREMENTS WITH VENDOR.

	DATE	REMARKS
	08.09.22	IFB

CONTRACT DATE: END. MED20 BUILDING TYPE: PLAN VERSION: MARCH 2021

BRAND DESIGNER: DICKSON SITE NUMBER: STORE NUMBER: 455386

PA/PM: DRAWN BY.: JOB NO.:

TACO BELL

2021088.52

1551 West River Rd. Elyria, OH



ENDEAVOR 2.0 LIGHTING PLAN **AND DETAILS**

B



PROVIDE 2" Ø CONDUIT UNDERGROUND FOR FUTURE HIGH SPEED INTERNET. RUN TO ABOVE OFFICE CEILING. 0 01 1' - 5"— 25' - 6" T 05) (HM 08 (HM 03 (HM 07A) TV 02 VOLUME CONTROL NOTES: 1) PATIO SPEAKER: DEDICATED WALL-MOUNT VOLUME CONTROL IN LOCATION OF HEAD-END (TYP. MANAGER'S 2) DINING ROOM SPEAKERS: DEDICATED WALL-MOUNT

COMMUNICATIONS PLAN 1/4" = 1'-0"

DOOR CONTACT (LINKED TO AUDIO / VISUAL ALARM) HOLD-UP BUTTON (MOUNT 2-1/2" BEHIND COUNTER EDGE) "SOUND ALERT" DEVICE MUSIC SYSTEM SPEAKERS KP KEYPAD (MTD AT 48" A.F.F.) SECURITY STROBE AS ALARM SIREN ABOVE CLG J-BOX B BUMP PAD (MOUNT AT FRONT COUNTER) 2" x 4" J-BOX W/ DATA PORTS

OFFICE).

SPEAKER.

MANAGER'S OFFICE).

MANAGER'S OFFICE).

VOLUME CONTROL IN LOCATION OF HEAD-END (TYP.

3) KITCHEN SPEAKERS: IF CONNECTED TO THE SOUND SYSTEM, CAN EITHER HAVE VOLUME CONTROL BUILT INTO THE SPEAKER ITSELF, OR HAVE A THIRD DEDICATED WALL-MOUNT VOLUME CONTROL IN LOCATION OF HEAD-END (TYP.

4) RESTROOM SPEAKERS: VOLUME CONTROL BUILT INTO

FS HOOD FIRE SUPPRESSION SYSTEM PULL STATION

MOTION DETECTOR OCCUPANCY SENSOR. CEILING

MOUNTED. SEE DETAILS 1 & 2 / E7.0

COMMUNICATIONS LEGEND NTS

C

•C→ USB OUTLET

SUPPLY AND INSTALL OUTLETS AND CONDUIT FOR OWNER SUPPLIED AND INSTALLED CABLE AND LOW VOLTAGE WIRING (U.O.N.). TELEPHONE AND MUSIC SYSTEM WIRING SHALL BE SUPPLIED AND INSTALLED. SEE SCOPE OF WORK SHEETS.

SEE SHEETS E3.0 AND E3.1 FOR ELECT. INFO ON POS, SECURITY SYSTEM, CCTV SYSTEM, (OFFICE) COMPUTER, DRIVE-THRU TIMER AND DRIVE-THRU COMMUNICATION SYSTEM.

THIS PLAN INCLUDES CONDUITS AND J-BOXES FOR POS, SECURITY SYSTEM, CCTV SYSTEM, (OFFICE) COMPUTER, TELEPHONE SYSTEM, MUSIC SY DRIVE-THRU TIMER AND DRIVE-THRU COMMUNICATION SYSTEM.

ALL OUTLETS AND BOXES MOUNTED IN THE SERVING COUNTER CAE ARE TO BE 24" AFF. INSTALL JUNCTION BOXES WITH CONDUIT UNDE CABINET TO NEAREST WALL AND TO ABOVE CEILING.

COMMUNICATIONS NOTES NTS

	В
BINETR ER	Y
SYSTEM	l,

	COMMUNICATIONS ROUGH-IN SCHEDULE								
COMM. TYPE	COMM. #	EQUIPMENT ITEM	ELEVATION	REMARKS					
Н	01	UNDER COUNTER HOLD-UP BUTTON		SEE DETAIL 6/E3.1.					
Н	02	WALL MOUNTED HOLD-UP BUTTON	+18" A.F.F.	SURFACE MTD. 2X4 J-BOX ON INSIDE OF WALK-IN FREEZER HINGE WALL W/ (1) 1/2" CONDUIT TO ABOVE KITCHEN CEILING. BUTTON FACING DOWN. SEE DETAIL 3/E3.1					
НМ	02	D/T TIMER SIGNAL PROCESSOR J-BOX	+126" A.F.F	4X4X4" DEEP (MIN.) J-BOX ABV. CLG. W/ (1) 1" CONDUIT TO HM-07B, (1) 1" CONDUIT TO HM-04, (1) 1-1/2" CONDUIT TO HM-08 & (1) 1" CONDUIT TO HM-12. SEE DET. 5/E3.1.					
НМ	03	D/T BASE STATION J-BOX	+72" A.F.F.	4X4 J-BOX @ D/T BASE STATION W/ (1) 1-1/2" C TO HM-08 & (1) 1-1/2" C TO HM-07A. SEE DETAIL 7/E3.1.					
НМ	07A	D/T TIMER DISPLAY J-BOX	+62" A.F.F.	2X4 J-BOX W/ (1) 1-1/2" CONDUIT TO HM-03 & (1) 1" C TO HM-04. SEE DETAIL 7/E3.1.					
НМ	07B	D/T TIMER DISPLAY J-BOX	+126" A.F.F.	2X4 J-BOX ABV. CEILING W/ (1) 1" CONDUIT TO HM-02. SEE DETAIL 7/E3.1					
НМ	08	D/T J-BOX	+96" A.F.F.	4X4X4" DEEP (MIN.) J-BOX W/ (1) 1-1/2" CONDUIT TO HM-03 & (1) 1-1/2" CONDUIT TO HM-02. SEE DETAIL 7/E3.1.					
НМ	11	D/T CONTROL UNIT J-BOX	+126" A.F.F.	2X4 J-BOX ABV. CEILING W/ (1) 1" CONDUIT TO HM-12. SEE DETAIL 7/E3.1.					
НМ	12	D/T/ ETHERNET SWITCH J-BOX	+126" A.F.F.	2X4 J-BOX ABV. CEILING W/ (1) 1" CONDUIT TO HM-11, (1) 1" CONDUIT TO HM-02 & (1) 1" CONDUIT TO OFFICE ROUTER.					
М	01	SPEAKER, CEILING MOUNTED	CEILING	SPEAKER WIRING FROM SPEAKERS IN DINING ROOM TO AMPLIFIER IN OFFICE. FOR EXACT LOCATION OF SPEAKERS, SEE LIGHTING PLAN SHEET E4.0.					
Р	02		CEILING	2X4 J-BOX FLUSH @ CEILING. FOR M.A.P.S. LINE MONITOR J-BOX.					
Р	03	KITCHEN MONITOR J-BOX	+84" A.F.F.	2X4 J-BOX W/ (1) 3/4" CONDUIT TO ABOVE CIELING					
Р	04	BUMP PAD J-BOX	+24" A.F.F.	2X4 J-BOX W/ (1) 3/4" CONDUIT TO P-03.					
Р	07	POS J-BOX W/ 2-1/2" DIA HOLE IN COVER PLATE	+24" A.F.F.	6X6X4" DEEP J-BOX W/ 2-1/2" CONDUIT IN WALL TO ABV. CEILING, WITH PULL STRING FOR POS.					
S	03	J-BOX SECURITY SYSTEM	+30" A.F.F.	2X4 J-BOX W/ (1) 1/2" CONDUIT TO ABV. CLG. FOR HOLD-UP BUTTON SIGNAL WIRE.					
S	04	J-BOX SECURITY SYSTEM	+84" A.F.F.	2X4 J-BOX W/ COVER & (1) 1/2" CONDUIT TO ABOVE CEILING.					
S	05		+24" A.F.F.	2X4 J-BOX W/ 3/4" CONDUIT TO S-05 AND TO ABOVE CEILING.					
S	06	J-BOX SECURITY SYSTEM	+48" A.F.F.	2X4 J-BOX W/ (1) 1/2" CONDUIT TO ABOVE CEILING FOR SECURITY SYSTEM KEYPAD.					
S	07	J-BOX SECURITY SYSTEM	TOP OF JAMB	2X4 J-BOX W/ (1) 1/2" CONDUIT TO ABOVE CEILING FOR DOOR CONTACT.					
S	08	"SOUND ALERT" DEVICE	CEILING	CONNECT TO SECURITY SYSTEM.					
S	09	SECURITY STROBE LIGHT	CEILING	CONNECT TO SECURITY SYSTEM.					
S	10	ALARM SIREN	ABV. CEILING	CONNECT TO SECURITY SYSTEM.					
S	11	MOTION / HEAT DETECTOR	+78" A.F.F.	STUB 1/2" CONDUIT. D5835 OR D5820. MOUNT 90" A.F.F. FOR OFFICE					

	T = = = = = =	T		
COMM. TYPE	COMM. #	EQUIPMENT ITEM	ELEVATION	REMARKS
T	03	VOICE LINE PHONE JACK	+42" A.F.F.	2X4 J-BOX W/ DOUBLE RJ-11 PHONE JACK & 1" CONDUIT TO ABOVE CEILING.
Т	04	COMPUTER LINE PHONE JACK	+42" A.F.F.	2X4 J-BOX W/ RJ-11 PHONE JACK AND 1" CONDUIT TO ABOVE CEILING.
Т	05		+24" A.F.F.	2X4 J-BOX W/ 1" CONDUIT TO ABOVE CEILING.
TV	02	SECURITY CAMERA	+96" A.F.F.	MINI-DOME CAMERA MTD. TO BTM. OF MENU BOARD BULKHEAD. 2X4 J-BOX W/ (1) 1/2" CONDUIT TO ABOVE CEILING MTD. ON BACK SIDE OF BULKHEAD (6 TOTAL).
V	02	CREDIT CARD READER (VSAT)	+24" A.F.F.	2X4 J-BOX W/ 1/2" CONDUIT TO ABOVE CEILING FOR ETHERNET CABLES.
S	01	J-BOX SECURITY SYSTEMS	+48" A.F.F.	4X4 J-BOX AT SECUIRTY SYSTEM CONTROL PANEL W/ (1) 2" CONDUIT TO S-02
S	02	J-BOX SECURITY SYSTEMS	+106" A.F.F.	4X4 J-BOX ADJACENT TO T-02 W/ (1) 2" CONDUIT TO S-01
S	12	J-BOX SECURITY DVR	+42" A.F.F.	2X4 J-BOX FOR SECURITY DVR
Т	02	SECURITY SYSTEM PHONE JACK	+106" A.F.F.	2X4 J-BOX ADJACENT TO S-02 W/ RJ-31X PHONE JACK
V	01	ALTERNATE PAYMENT ROUTER BOX	+90" A.F.F.	4X4 J-BOX W/ 1/2" CONDUIT TO ABOVE CEILING FOR ETHERNET CABLES (DOUBLE JACK)
НМ	10	OCB SWITCH	+52" A.F.F.	2X4 J-BOX W/ 1" CONDUIT TO ABOVE CEILING
IR	01	IRRIGATION TIMER	+80" A.F.F.	4X4 J-BOX W/ 1" CONDUIT TO IRRIGATION VALVES
0	01	(4) 1" DATA CONDUITS	CEILING	FROM MENU BOARD/SPEAKER POST TO ABOVE CEILING FOR OCB AND D/T COMM. SYST. SEE DETAIL 3/7.0
НМ	04	OCB SWITCH	+80" A.F.F.	4X4 J-BOX W/ 1" CONDUIT TO IRRIGATION VALVES
Т	01	TELEPHONE SERVICE BOX PER LOCAL TELEPHONE COMPANY. PROVIDE 24"X24"X3/4" PLYWOOD PANEL AT CLG. PROVIDE PULL STRING IN 2" CONDUIT.	+24" A.F.F.	PROVIDE (1) 25 PAIR TELEPHONE CABLE. ONLY (2) LINES TO BE USED. LINE ONE FOR VOICE/FAX. LINE (2) FOR COMPUTER MODEM.
TV	01	CLOSED CIRCUIT TELEVISION (CCTV)		CCTV INSTALLATION IS BASED ON THE CRIME INDEX AS DETERMINED BY YUM! LOSS PREVENTION MANAGER. THE STANDARD CCTV PACKAGE WILL CONSIST OF (1) CCTV MONITOR W/ WALL BRACKET AND (1) MINI DOME CAMERA MTD. ON BACK SIDE OF BULKHEAD (7 TOTAL)

CONTRACT DATE:	10.05.21
BUILDING TYPE:	END. MED20
PLAN VERSION:	MARCH 2021
BRAND DESIGNER:	DICKSON
SITE NUMBER:	315672
STORE NUMBER:	455386
PA/PM:	JG

08.09.22 IFB

DRAWN BY.: 2021088.52

TACO BELL

1551 West River Rd. Elyria, OH



ENDEAVOR 2.0 COMMUNICATIONS **PLAN**

PLOT DATE: 8/9/2022 1:14:33 PM

The intent of the BMS Control Box (TBCCB-3-WOS) is to activate or deactivate the following:

- Kitchen Lighting
- Dining Room Lighting
- Exterior Lighting
- Exterior Signs
- Exhaust hood exhaust fan
- Exhaust hood lighting
- Make up air / replacement air fan
- Rest room / cook line exhaust fan
- Managers Office lighting & at least one duplex outlet

Sequence of Operation

(Building) Occupied Mode

When the Occupied/Unoccupied selector switch on the front of the TBCCB-3-WOS panel is in the "Auto" position, Channel 1 of the Timeclock in the Control Box is programmed to place the building in Occupied mode 15 minutes before the first Team Member arrives on the premises. This commands on the following:

- The Parking Lot Lights, provided the photo cell indicates it is dark enough for them to be on
- The restroom and cook line exhaust fan marked "EF-2"
- Dining Room Lights, provided their local switch is in the ON position
- Kitchen and rest room lights, provided their local switch and or occupancy sensors are in the ON position
- The exhaust hood exhaust fan marked "EF-1"
- The make up air replacement air fan (evaporator fan) in RTU 1 and RTU 2.

Occupied mode may also be invoked when any of the following occur:

- an Occupancy sensor on the front of the TBCCB-3-WOS panel senses motion
- when an optional remote Occupancy sensor senses motion
- when a remote Occupied switch is in the Occupied position
- when the Occupied/Unoccupied switch on the front of the TBCCB-3-WOS is placed in the MANUAL OCCUPIED position

(Building) Unoccupied Mode

When the Occupied/Unoccupied selector switch on the front of the TBCCB-3-WOS panel is in the "Auto" position, Channel 1 of the Timeclock in the Control Box is programmed to place the building in Unoccupied mode 15 minutes after the last Team Member leaves the premises. This commands OFF the following:

- The Parking Lot Lights
- The restroom and cook line exhaust fan marked "EF-2"
- Dining Room Lights
- Kitchen room lights
- The exhaust hood exhaust fan marked "EF-1"

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- The make up air replacement air fan (evaporator fan) in RTU 1 and RTU 2.

In the event of a rise in temperature above 85 degrees in the exhaust hood, the exhaust fan (EF-1) and the make up air source (RTU 1 and 2) will be activated. When in Unoccupied mode and the temperature under the hood drops below 85 degrees, the exhaust fan and make up air source will turn off fifteen minutes after the I85 degree setting is achieved.

Any detection by the Occupancy sensor in the

TBCCB-3-WOS or the optional Remote Occupancy
Sensor or the optional Remote Occupancy Switch or ON
position of the Manual Occupied switch will override the
Timeclock and keep the building in OCCUPIED
mode.

(Sales) OPEN mode

When the OPEN/CLOSED selector switch on the front of the TBCCB-3-WOS panel is in the "Auto" position, Channel 2 of the Timeclock in the Control Box is programmed to place the building in OPEN (FOR SALES) mode. This commands on the following:

- The Exterior Building Lights, provided the photo cell indicates it is dark enough for them to be on
- The Exterior Signs, provided the photo cell indicates it is dark enough for them to be on

OPEN for sales mode may also be invoked when any of the following occur:

- when an optional remote OPEN (for sales) switch is in the OPEN position
- when the OPEN/CLOSED switch on the front of the TBCCB-3-WOS is placed in the MANUAL OPEN position

(Sales) CLOSED mode

When the OPEN/CLOSED selector switch on the front of the TBCCB-3-WOS panel is in the "Auto" position, Channel 2 of the Timeclock in the Control Box is programmed to place the building in CLOSED (FOR SALES) mode. This commands OFF the following:

- The Exterior Building Lights
- The Exterior Signs,

Manual CLOSED Mode

When a Team Member places the OPEN/CLOSED switch in the MANUALCLOSED position it turns off the Signs and Exterior Lights until the switch is placed back in AUTOMATIC or MANUAL OPEN position

- FIELD WIRE BY OTHERS

CONDUIT ENTRY HUBS

This panel is Listed to applicable UL

Standards and requirements by UL. Field wiring or field components are not

Listed under this mark.

THIS PANEL ENCLOSURE IS RATED TYPE 1.

TO PRESERVE RATING USE TYPE 1


External Operations Not Part Of The Control Box

Operation But Required To Be Installed


The following operations should take place between the package units and various components:

- Control voltage for RTU 2 shall pass through contacts in the fire suppression system for the exhaust hood so that RTU 2 evaporator fan shuts down upon an activation of the fire suppressant into the hood. The system shall be wired directly between the fire suppression system and RTU 2 or TBANS control box. See sheet E-7.1.
- A remote smoke detector system featuring testing, annunciation and remote unit reset shall be installed in the manager's office for each RTU. The system shall be wired directly between each RTU and its respective testing, annunciation and reset device.

TACO BELL COMPONENT RELATIONSHIP

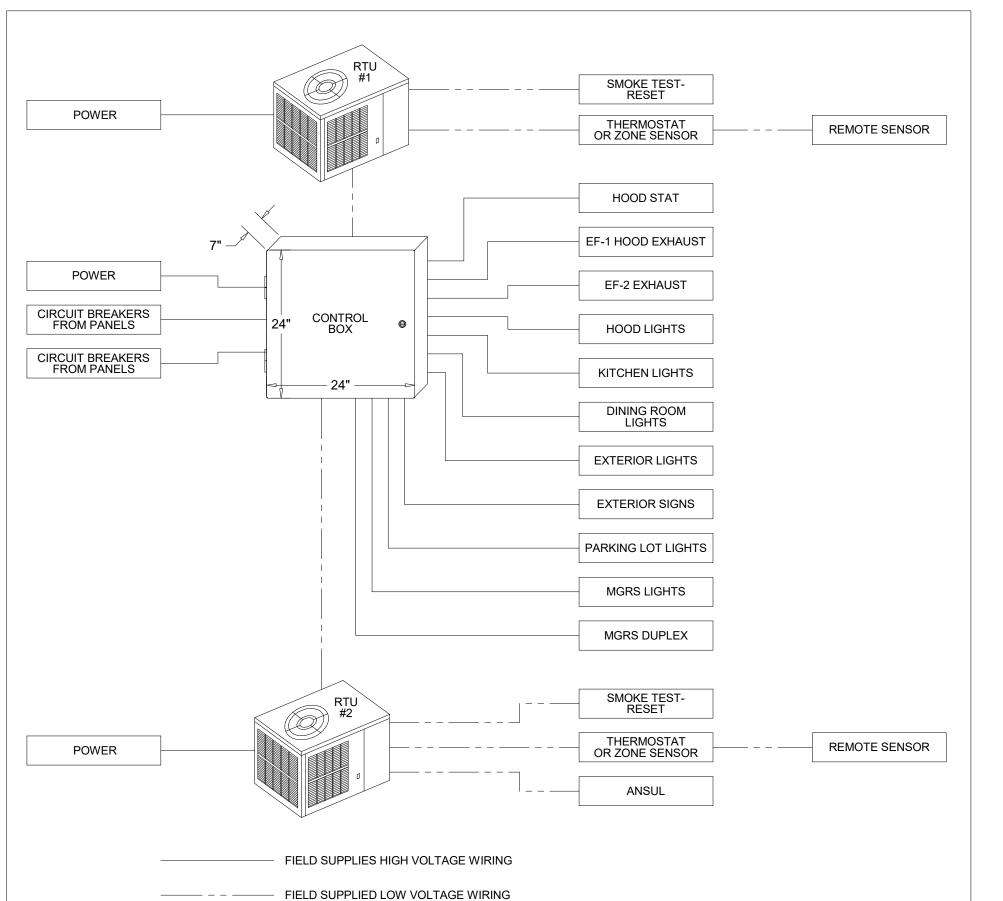

24.3" PANEL FRONT

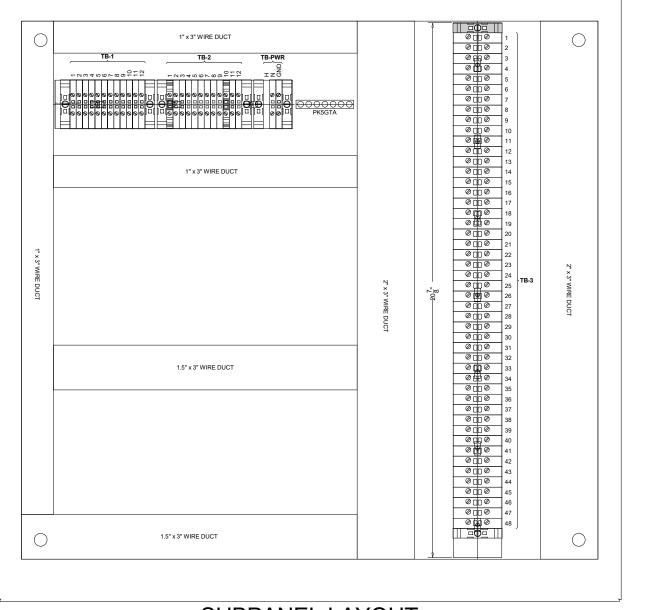

SUBPANEL LAYOUT

CONTROL BOX

TACO BELL'S SUPPLIER OF THE CONTROL BOX IS AIR CARE EXPERTS. UNLESS NOTED OTHERWISE, TBCCB-3-WOS CONTROL BOX TO BE PURCHASED AND INSTALLED BY THE ELECTRICAL CONTRACTOR. NOTE: TBCCB-3 WOS MAY BE INCLUDED IN THE LIGHTING PACKAGE. ELECTRICAL CONTRACTOR IS RESPONSIBLE TO VERIFY. TBCCB-3-WOS INCLUDES ALL WIRING AND COMPONENTS SHOWN FACTORY INSTALLED WITHIN THE BOX. PRIMARY CONTACT: CHUCK MCCABE

PHONE: 949 770 2222 EMAIL: INFO@ACE-EMS.COM FOR REFERENCE ONLY

DATE REMARKS

08.09.22 IFB

CONTRACT DATE: 10.05.21
BUILDING TYPE: END. MED20
PLAN VERSION: MARCH 2021
BRAND DESIGNER: DICKSON
SITE NUMBER: 315672
STORE NUMBER: 455386
PA/PM: JG
DRAWN BY.: AJR

2021088.52

TACO BELL

1551 West River Rd. Elyria, OH



ENDEAVOR 2.0
ELECTRICAL
DETAILS TBCCB

E6.0

PLOT DATE: 8/9/2022 1:14:33 PM

TBCCB-3-WOS

TBCCB-3-WOS

REFERENCE ONLY

08.09.22 IFB

CONTRACT DATE: BUILDING TYPE: END. MED20 PLAN VERSION: MARCH 2021 BRAND DESIGNER: SITE NUMBER: STORE NUMBER:

455386 PA/PM: DRAWN BY.: JOB NO.: 2021088.52

315672


TACO BELL

1551 West River Rd. Elyria, OH



ENDEAVOR 2.0 ELECTRICAL DETAILS -TBCCB

PLOT DATE: 8/9/2022 1:14:33 PM

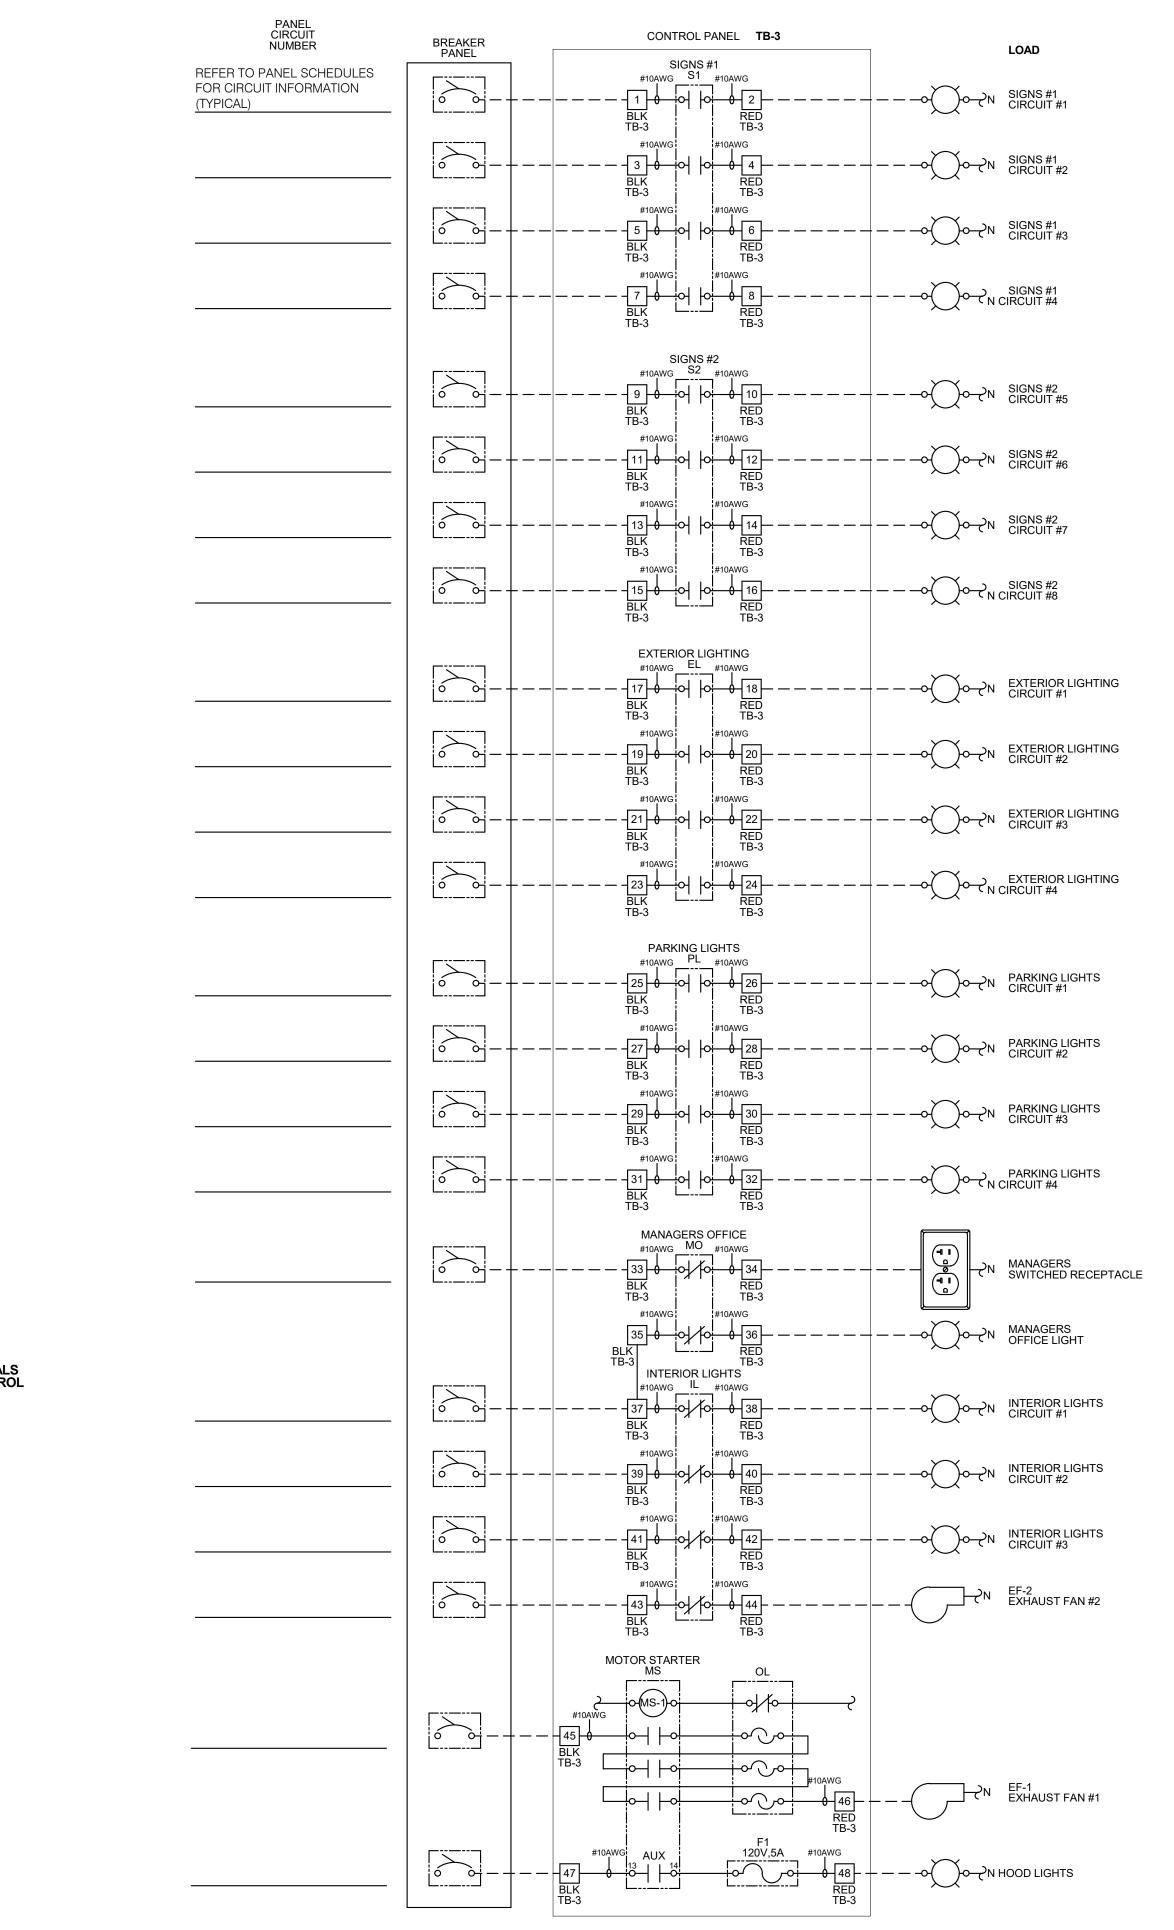

FOR

- - - FIELD WIRE BY OTHERS THIS PANEL ENCLOSURE IS RATED TYPE 1. TO PRESERVE RATING USE TYPE 1 CONDUIT ENTRY HUBS

> LISTED

This panel is Listed to applicable UL Standards and requirements by UL. Field wiring or field components are not Listed under this mark.

NOTES:

1. VISUAL VERIFICATION OF THIS INSTALLATION IS REQUIRED. SEE SHEET M5.0

2. PANEL IS SURFACE MOUNT

3. PROTECT INTERIOR FROM METAL SHAVINGS &

CONTROL BOX

TACO BELL'S SUPPLIER OF THE CONTROL BOX IS AIR CARE EXPERTS. UNLESS NOTED OTHERWISE, TBCCB-3-WOS CONTROL BOX TO BE PURCHASED AND INSTALLED BY THE ELECTRICAL CONTRACTOR.

NOTE: TBCCB-3 WOS MAY BE INCLUDED IN THE LIGHTING PACKAGE. ELECTRICAL CONTRACTOR IS RESPONSIBLE TO VERIFY.

TBCCB-3-WOS INCLUDES ALL WIRING AND COMPONENTS SHOWN FACTORY INSTALLED WITHIN THE BOX.

PRIMARY CONTACT: CHUCK MCCABE

PHONE: 949 770 2222

EMAIL: INFO@ACE-EMS.COM

24.3" CHANNEL #2 - BUSINESS ON = OPEN OFF = CLOSED — 24.3" — PANEL FRONT OPTION A TB-1 OPTION B TB-1 TB-2 TB-PWR 778459786770 170 120 10 10 10 10 10 10 10 10 ΙΖΌ TERMINALS IN CONTROL PANEL 111 H N | RG RG RG RG RTU-1 RTU-2 RTU-3 RTU-4 AUX-1 AUX-2 AUX-3 AUX-4 FIELD CONNECTION FOR RTU WITH STANDARD THERMOSTAT - 1004700 × 0011 _____ R OC R OC R OC RTU-2 RTU-3 RTU-4 PHOTO CELL REMOVE JUMPER REMOVE JUMPER
IF OPTIONAL IF OPTIONAL
REMOTE SWITCH IS USED
REMOTE SWITCH IS USED

KNOCKOUT KNOCKOUT KNOCKOUT

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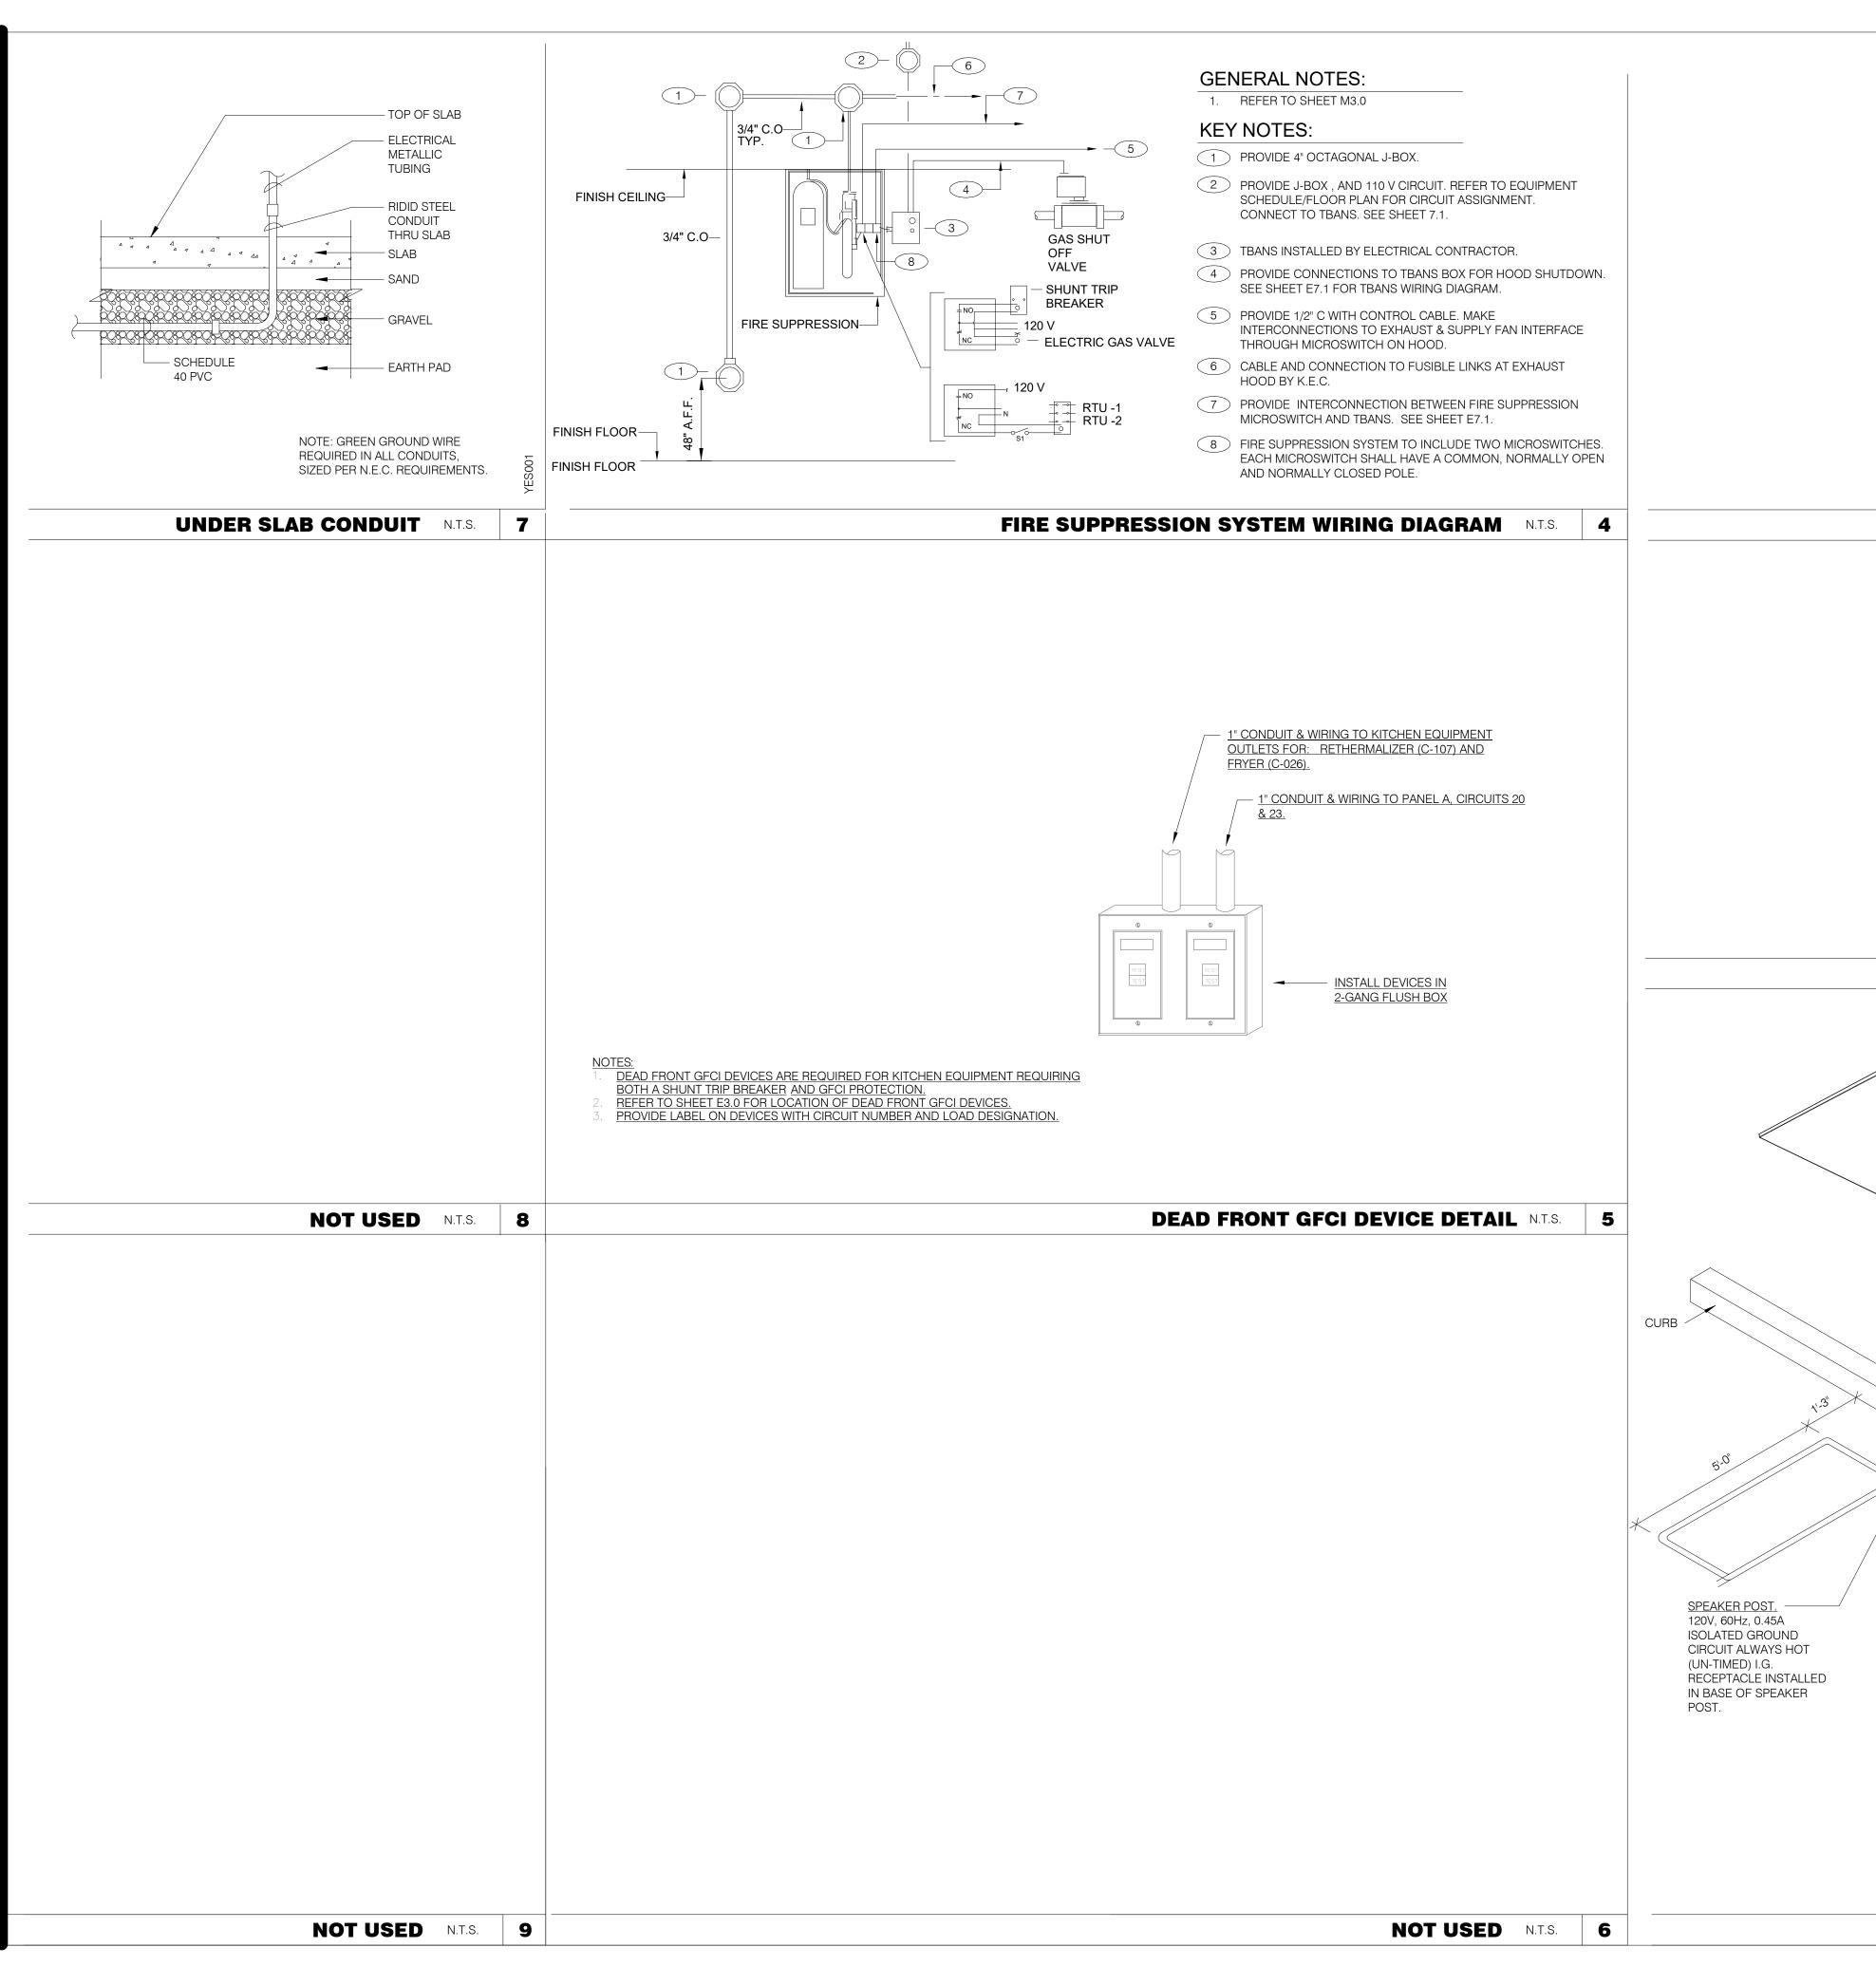
RTOCOCH CHOC CS8500 THERMOS'


LENNOX CS8500 THERMOSTAT RTU-1 (TYPICAL FOR ALL RTU'S)

GPD GROUP

520 S. MAIN STREET, SUIT 2531

AKRON, OH 44311 330.572.2100 FAX: 330.572.2102



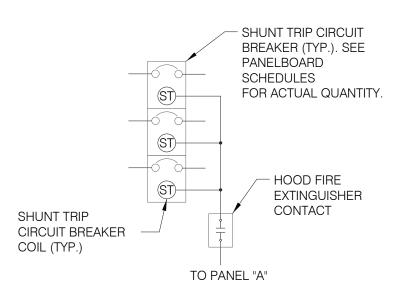

SEQUENCE OF OPERATION:

UPON ACTIVATION OF ANY HOOD FIRE SUPPRESSION SYSTEM RELAY, A
RELAY IN THAT FIRE SUPPRESSION SYSTEM SHALL CAUSE ALL SHUNT
TRIP CIRCUIT BREAKERS TO OPERATE, THUS REMOVING POWER FROM
ALL DEVICES CONNECTED TO EQUIPMENT LOCATED UNDER THE GREASE
HOOD. EXHAUST FANS SHALL NOT BE AFFECTED BY THIS ACTION AND
SHALL CONTINUE TO BE CONTROLLED AS INDICATED IN THE SEQUENCE
OF OPERATIONS INDICATED ON CONTROLS SHEETS E6.0 AND
E6.1

SHUNT TRIP DETAIL N.T.S.

WATTSTOPPER DT-355 LINE VOLTAGE
DUAL TECHNOLOGY CEILING
SENSOR

LOAD

HOT
A
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NEUTRAL

GREEN
GROUND


WATTSTOPPER DT-355 LINE VOLTAGE
DUAL TECHNOLOGY CEILING
SENSOR

SYMBOL ON PLAN - ©

GREEN
GROUND

CEILING OCCUPANCY SENSOR WIRING DIAGRAM N.T.S.

DRIVE-THRU COMMUNICATIONS ISOMETRIC N.T.S.

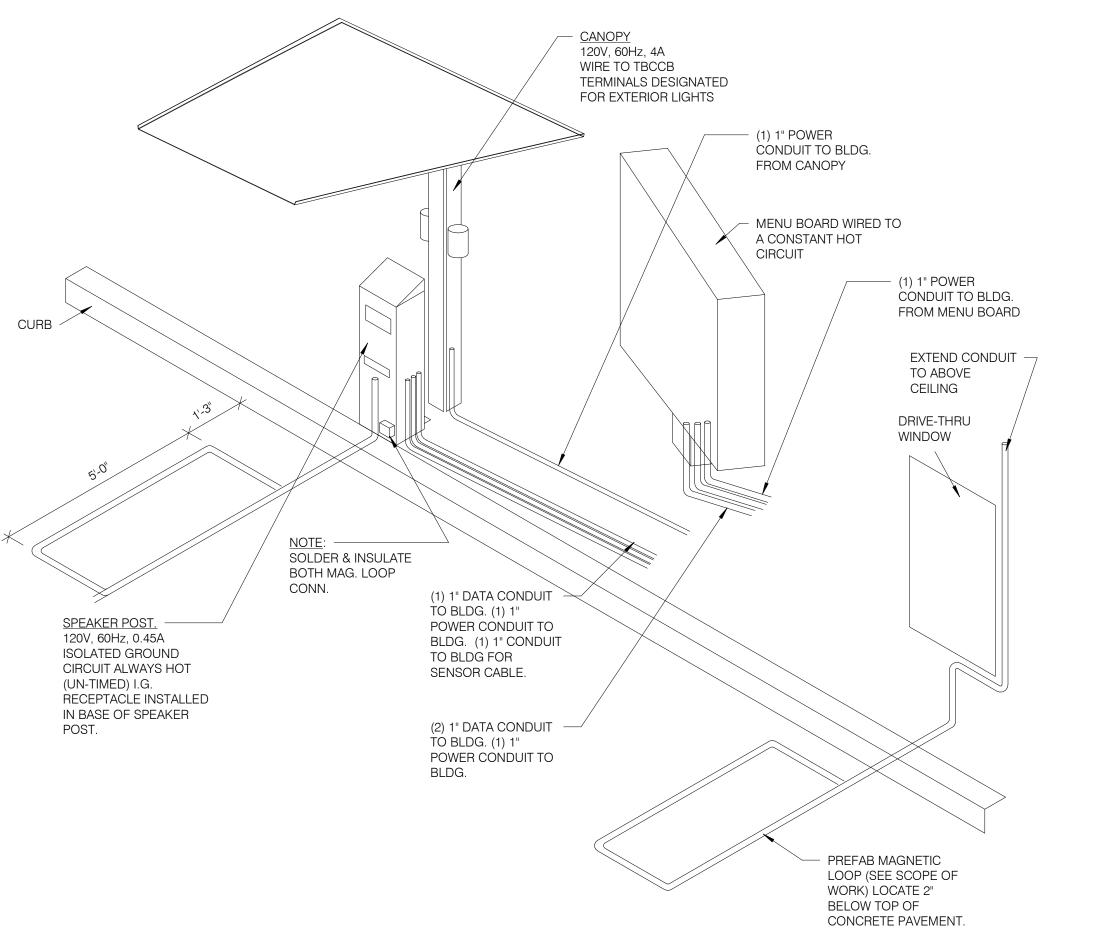

DATE	REMARKS
08.09.22	IFB

CONTRACT DATE: 10.05.21
BUILDING TYPE: END. MED20
PLAN VERSION: MARCH 2021
BRAND DESIGNER: DICKSON
SITE NUMBER: 315672
STORE NUMBER: 455386
PA/PM: JG
DRAWN BY.: AJR
JOB NO.: 2021088.52

TACO BELL

1551 West River Rd. Elyria, OH



ENDEAVOR 2.0
ELECTRICAL
DETAILS

E7.0PLOT DATE: 8/9/2022 1:14:34 PM

LTB-1 IN TRANE RTU (REMOVE METAL JUMPER BETWEEN TERMINALS)

RTU-2 TRANE LTB-1

LENNOX PRODIGY

TERMINAL (SMOKE)

DI1

TBCCB

TERMINAL

TB2-9

NTS

(5)

NTS

RTU-1 TRANE

TBANS TO TRANE RTU SHUTDOWN

RTU-1 LENNOX PRODIGY

TERMINAL (SMOKE)

TBANS TO LENNOX PRODIGY SHUTDOWN

J-BOX ON

EXHAUST HOOD

HOODSTAT

WIRES

LENNOX PRODIGY TERMINALS

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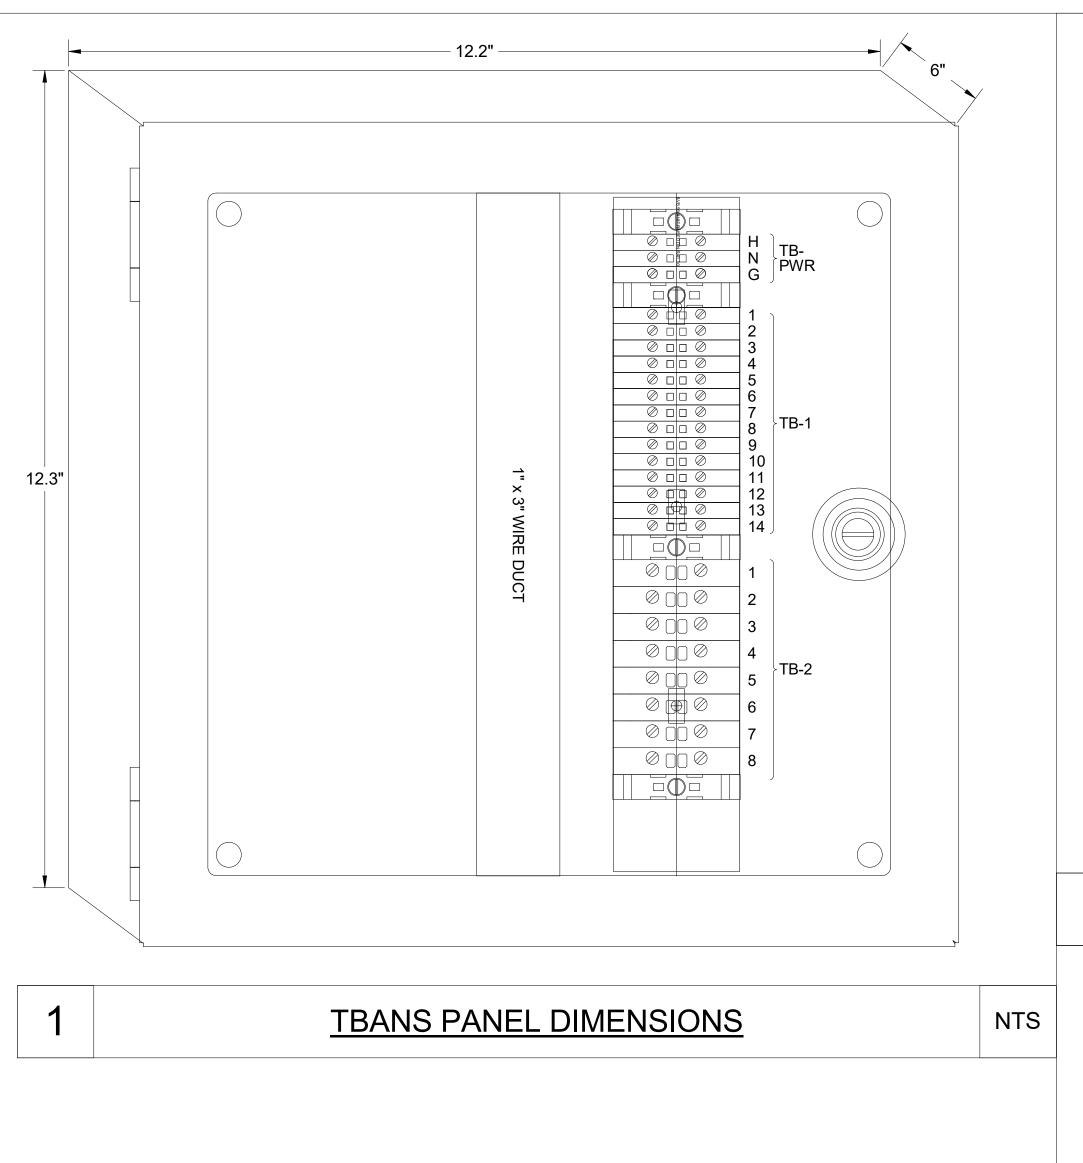
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TBCCB

TERMINAL

TB2-8


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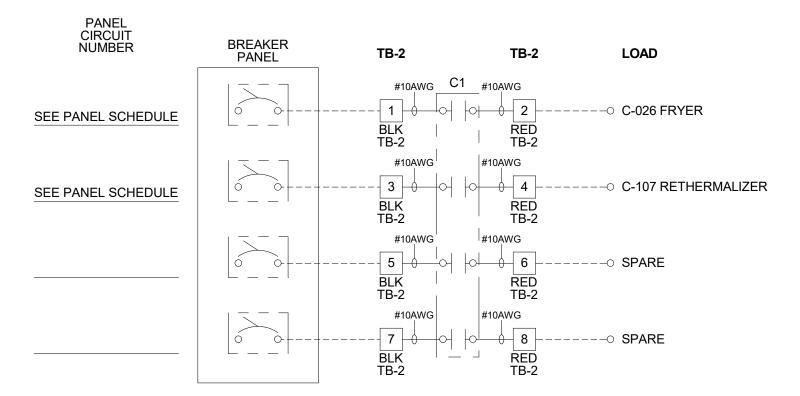
SEQUENCE OF OPERATION: ACTIVATION OF HOOD FIRE SUPPRESSION SYSTEM RELAY SHALL CAUSE TBANS TO DE-ENERGIZE LOAD, THUS REMOVING POWER FROM ALL DEVICES CONNECTED TO EQUIPMENT LOCATED UNDER THE GREASE

CONTROL BOX TACO BELL'S SUPPLIER OF THE CONTROL BOX IS AIR CARE EXPERTS. UNLESS NOTED OTHERWISE, TBANS CONTROL BOX TO BE PURCHASED AND INSTALLED BY THE ELECTRICAL CONTRACTOR. NOTE: TBANS MAY BE INCLUDED IN THE LIGHTING PACKAGE. ELECTRICAL CONTRACTOR IS RESPONSIBLE TO **YERNS** INCLUDES ALL WIRING AND COMPONENTS SHOWN FACTORY INSTALLED WITHIN THE BOX. PRIMARY CONTACT: CHUCK MCCABE PHONE: 949 770 2222 EMAIL: <u>INFO@ACE-EMS.COM</u>

TACO BELL REQUIRES VISUAL CERTIFICATION OF THIS INSTALLATION SEE SHEET M5.0 CONTACT CERTIFY@ACE-BCX.COM OR (949)-770-2222



TBANS FIELD CONNECTIONS - VARIOUS 2

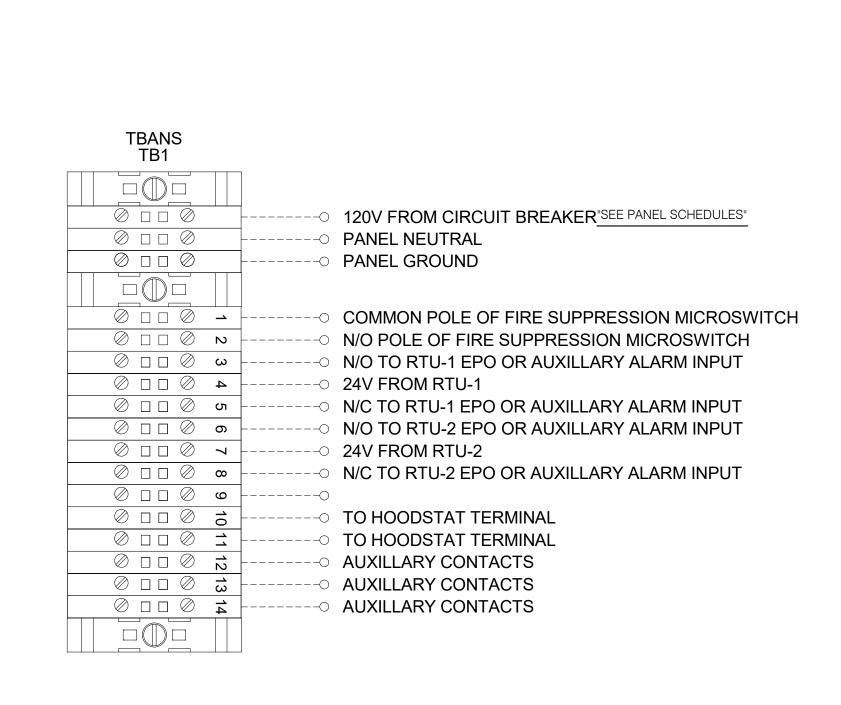

TBANS FIELD CONNECTIONS - APPLIANCES

NTS

TBANS TO HOODSTAT TO TBCCB

TBANS

TERMINALS

TB1-11

TBANS

TERMINALS

TB1-10

FOR REFERENCE ONLY

08.09.22 IFB **CONTRACT DATE: BUILDING TYPE:** END. MED20

PLAN VERSION: MARCH 2021 **BRAND DESIGNER:** DICKSON SITE NUMBER: 315672 STORE NUMBER: 455386 PA/PM: JG DRAWN BY.

TACO BELL

2021088.52

JOB NO.:

1551 West River Rd. Elyria, OH



ENDEAVOR 2.0 ELECTRICAL DETAILS

PLOT DATE: 8/9/2022 1:14:34 PM

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 3.3
 3.4
 END 20 *\dots \dots .0 3.4 3.7 4. 5.0 5.6 6.1 7.0 7 8 8 3 7 9 6.0 4.6 3.7 2.7 2.0 1.5 1.0 0.7 0.5 0.4 0.2 0.3 0.4 0.5 0.9 2.0 3.9 5.3 5.8 5.8 5.8 5.8 0.4 0 5 0 7 1 0 1/4 1.9 2.5 3.1 4.0 5.4 5.7 5.3 4.5 3.8 3.3 2.9 2.5 2.1 2.0 2.0 2.3 2.5 2.8 2.9 2.9 3.1 3.6 4.3 4.9 3 3.8 6.4 6.7 7 7/4 8.0 8.4 8.3 7.4 3 7.4 3.0 2.4 1/.6 1.1 0.8 0.6 0.5 0.3 0.4 0.5 0.6 0.9 1.3 2.1 3.4 5.0 5.9 5.8 5.4 4.8 4.2 3.6 3.1 2.6 2.2 2.0 2.0 2.3 2.7 3.4 4.2 5.1 6.0 5.4 6.3 6.3 6.5 6.9 7.5 1.8 3.2 8.2 8.2 1.8 2.0 8.2 8.2 1.9 1.3 0.9 0.6 0.4 0.3 0.3 0.4 0.5 0.7 1. 3.5 5.2 6.2 6.2 6.2 5.7 5,4 4.4 3.8 3.2 2.6 2.2 2.0 2.0 2.0 2.3 2.8 3.5 5.7 7.0 7.9 7.8 7.7 7.8 7.5 7.7 8.1 8.0 8.3 3.6 8.7 7.8 8.5 7.1 3.2 3.8 2.1 1.4 1.0 0.7 0.5 0.2 0.2 0.3 0.4 0.5 0.9 2.0 3.7 5.0 5.5 5.4 5.3 4.9 4.3 3.7 5.1 2.6 2.1 1.9 1.9 2.0 2.5 3.1 4.1 5.4 6.8 7.8 8.0 7.8 7.9 7.9 7.9 7.9 8.1 7.9 8.0 7.9 7.9 8.1 7.5 7.2 4.6 7.1 2.1 1.4 1.0 0.7 0.5 0.1 0.1 0.1 0.2 0.2 0.4 0.8 1.4 1.9 2.1 2.1 2.0 2.0 1.9 1.8 1.7 1.1 0.8 0.5 0.4 0.0 0.1 0.1 0.1 0.1 0.2 0.3 0.4 0.4 0.5 0.5 0.5 0.5 0.5 0.5 0.5 0.6 0.6 0.7 0.9 1.1 1.3 1.5 1.0 1.8 1.8 1.8 1.7 1.7 1.6 1.6 1.7 1.7 1.8 1.8 1.8 1.8 1.7 1.5 1.3 1.0 0.8 0.6 0.4 0.3 TOTAL 53' 12" W 74.59'

56.85,

TACO BELL

1551 W. RIVER RD. N.

ELYRIA, OH

PREPARED BY: JOHN BUJAKE

ACCUSERV LIGHTING & EQUIPMENT

877-707-7378

jbujake@accu-serv.com

MAY 25, 2022

 Calculation Summary
 Avg
 Max
 Min
 Avg/Min
 Max/Min

 EXTENDED
 2.51
 9.1
 0.0
 N.A.
 N.A.

 PARKING LOT & DRIVE-THRU SURFACE
 5.09
 9.1
 2.0
 2.55
 4.55

Symbol Qty Label Arrangement Luminaire LLF Luminaire Description				Description			
				Lumens		Watts	
$-\Box$	1	A	SINGLE	45277	0.900	312	VP-2-320L-315-4K7-3-UNV-A-DBT / SES-25-40-01-F-B4-DBT
Ð	3	В	SINGLE	44436	0.900	312	VP-2-320L-315-4K7-4W-UNV-A-DBT / SES-25-40-01-F-B4-DBT
$-$ E \Box	1	С	Single	45496	0.900	312	VP-2-320L-315-4K7-5QW-UNV-A-DBT / SES-25-40-01-F-B4-DBT

FOR REFERENCE ONLY

	DATE	REMARKS
	08.09.22	IFB

CONTRACT DATE: 10.05.21
BUILDING TYPE: END. MED20
PLAN VERSION: MARCH 2021
BRAND DESIGNER:

SITE NUMBER:
STORE NUMBER:
PA/PM:

DRAWN BY.:

TACO BELL

2021088.52

1551 West River Rd. Elyria, OH




ENDEAVOR 2.0
PHOTOMETRIC
PLAN

E8.0

IMPROVEMENT PLANS

TACO BELL

1551 WEST RIVER ROAD ELYRIA, OHIO MAY, 2022

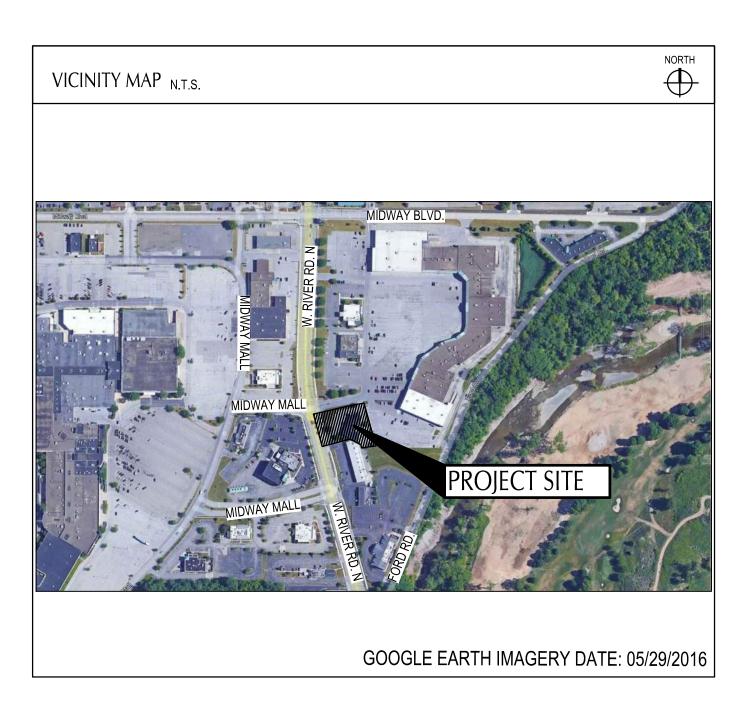

PROJECT DESCRIPTION

THIS 0.9191 ACRE SITE IS HOME TO AN ABANDONED BUILDING TO BE DEMOLISHED ALONG WITH ASSOCIATED PARKING LOT AND UTILITIES. THE IMPROVEMENTS TO THIS SITE WILL INCLUDE BUT NOT LIMITED TO A NEW TACO BELL RESTAURANT, NEW PARKING LOT, CONCRETE SIDEWALKS, RETAINING WALL, ALL APPURTENANT UTILITY CONNECTIONS, GRADING AND LANDSCAPING.

OHIO SPECIFICATION

THE STANDARD SPECIFICATIONS OF THE STATE OF OHIO, DEPARTMENT OF TRANSPORTATION, INCLUDING CHANGES AND SUPPLEMENTAL SPECIFICATIONS LISTED IN THE PROPOSAL SHALL GOVERN THIS IMPROVEMENT.

PLAN REPRODUCTION WARNING
THE PLANS HAVE BEEN PREPARED
FOR PRINTING ON ANSI D (22"x34")
SHEETS. PRINTING ON OTHER SIZE
SHEETS MAY DISTORT SCALES.
REFER TO GRAPHIC SCALES.

INDEX OF DRAWINGS TITLE SHEET TS-001 ALTA . . .1 OF 2 AND 2 OF 2 GENERAL NOTES C-001 SWPPP NOTES C-010 SWPPP DETAILS. C-011 SWPP PLAN. C-012 DEMOLÍTION PLAN C-101 SIŢĘ PĻĄŅ C-111 GRADING PLAN C-121 UTILITY PLAN C-131 DETAILS. . C-501 DETAILS. . C-502 DETAILS. C-503 LANDSCAPE GENERAL NOTES. L-001 LANDSCAPE PLAN L-101 LANDSCAPE DETAILS L-501

OWNER AND DEVELOPER
STEVE PULCHEON
1900 COLONEL SANDERS LANE
LOUISVILLE, KY 40213





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CONTRACT DATE:	_
BUILDING TYPE:	-
PLAN VERSION:	-
BRAND DESIGNER:	-
SITE NUMBER:	-

TACO BELL

1551 WEST RIVER ROAD ELYRIA, OHIO 44035

STORE NUMBER:



TITLE SHEET

TS-001

GPD GROUP

Situated in the City of Elyria, County of Lorain and State of Ohio, and bounded and described as follows:

And being known as Sub lot Nos. 15, 16, 17 and 44 part of vacated Shirley Avenue as shown in Deed Volume 676, Page 33, dated September 10, 1956 and Deed Volume 694, Page 434, dated May 1, 1957 and being part of the Buckley–Evers Realty Co.'s Golfview Subdivision as shown by the recorded plat in Volume 13, Page 12 of Lorain County Records and part of Original Elyria Township Lot No. 172, West of the Black River and more definitely described as follows: Beginning at the intersection of the centerline of West River Road and the northerly line of Original Lot 172; thence South 3° 24' 05" West in the centerline of West River Road, a distance of 8.70 feet to an angle point in said centerline; thence South 13° 46' 15" East in the centerline of West River Road, a distance of 187.66 feet to a point; said point is the principal place of beginning; thence continuing South 13° 46' 15" East in the centerline of West River Road, a distance of 135.00 feet to a point in the Southerly line of land now or formerly owned by Meyer Goldberg and Frances Simon Goldberg by deed dated February 23, 1968 and recorded in Deed Volume 961, Page 533 and 535, and by deed dated September 22, 1972 and recorded in Deed Volume 1062, Page 104 of Lorain County Deed Records.

The following four (4) courses are in the Goldberg's southerly line; thence South 87° 38' 15" East, a distance of 136.71 feet to a point; thence South 62° 11' 09" East, a distance of 44.69 feet to a point; thence South 1° 30' 45" West, a distance of 12.48 feet to a point; thence South 87° 19' 25" East, a distance of 74.59 feet to a point; thence North 13° 46" 15" West in a line parallel to and 233 feet distant; thence South 80° 10' 56" West, a distance of 233.55 feet to a point in the centerline of West River Road and the principal place of beginning; enclosing a parcel of land containing 0.919 acres, be the same more or less, but subject to all legal highways.

SURVEYOR'S DESCRIPTION:

Situated in the State of Ohio, County of Lorain, City of Elyria, part of original Elyria Township Lot 172 West of Black River, being all of sublots 15, 16, 17 and 44, and part of sublots 14, 42, 43, 45 and 46 in the Buckley-Evers Realty Co.'s Golfview Subdivision as recorded in Plat Book 13, Page 12, part of Vacated Shirley Ave, as recorded in Deed Volume 676, Page 33 and Deed Volume 694, Page 434, and being all of a parcel conveyed to West River Plaza, LLC, by Instrument Number 2020-0762070 of said county

COMMENCING at the northwest corner of sublot 14 and the southwest corner of sublot 15 of said Golfview Subdivision, and on the east right of way line of West River Road (width varies) said point being referenced by a 5/8 inch rebar (found) North 78 degrees 27 minutes 44 seconds West, a distance of 0.54 feet, and the POINT OF BEGINNING of the parcel herein described;

1. Thence along the north line of said T.S. Elyria Partners, LLC, South 89 degrees 47 minutes 58 seconds West, a distance of 34.35 feet, to a point in the centerline of said West River Road;

2. Thence along said centerline, North 16 degrees 20 minutes 02 Seconds West, a distance of 135.02 feet, to the southwest corner of a tract conveyed to At Midway Elyria OH, LLC, by instrument number 2016-094641;

3. Thence along a south line of said At Midway Elyria OH, LLC, North 77 degrees 39 minutes 46 Seconds East, passing over the east right of way line of said West River Road at 33.36 feet, being referenced by a Mag Nail (found), North 84 degrees 32 minutes 06 seconds West, a distance of 0.28 feet, a 5/8 inch rebar capped "KS" (found) at 58.05 feet, a total distance of 233.57 feet, to a 1 inch hollow pipe (found) at a northwest corner of a tract conveyed to TG3 Real Estate — Elyria, LLC, by instrument number 2017-0619097:

4. Thence along a west line of said TG3 Real Estate-Elyria, LLC, South 16 degrees 20 minutes 01 seconds East, a distance of 219.55 feet, to a 1-inch pipe (found) at a southwest corner of said TG 3 Real Estate-Elyria, LLC, and on the north line of lands conveyed to Cole CG Elyria, LLC by Instrument Number 2012001922;

5. Thence along the north line of said Cole CG Elyria, LLC, and a north line of said T.S. Elyria Partners, LLC, North 89 degrees 53 minutes 12 seconds West, passing over a 1 inch pipe (found) at 56.85 feet at a northeast corner said T.S. Elyria Partners, LLC, a

6. Thence along an east line of said T.S. Elyria Partners, LLC, North 01 degree 03 minutes 02 seconds West, a distance of 12.48 feet to a point, referenced by a 5/8 inch rebar (found) South 62 degrees 39 minutes 24 seconds East, a distance of 1.51 feet;

7. Thence with said east line, North 64 degrees 44 minutes 56 seconds West, a distance of 44.69 feet to the southeast corner of sublot 15, a northeast corner of sublot 14, and the southwest corner of sublot 44 of said Golfview Subdivision, being referenced by a 5/8 inch rebar with cap "BRAMHALL" (found) North 49 degrees 21 minutes 04 seconds East, a distance of 0.32 feet;

8. Thence along a north line of said T.S. Elyria Partners, LLC, South 89 degrees 47 minutes 58 seconds West, a distance of 102.36 feet to the Point of Beginning, containing 0.9191 acres, of which the present road occupies 0.1063 acres, and being part

of Lorain County Auditor's Parcel Number 0624172000024. The bearings for this description are based on Grid North, of the Ohio State Plane Coordinate System, North Zone, NAD83(2011),

PART OF ORIGINAL ELYRIA TOWNSHIP LOT 172 WEST OF BLACK RIVER

CITY OF ELYRIA COUNTY OF LORAIN STATE OF OHIO



LOCATION MAP

GENERAL NOTES

REFERENCES:

2. DEEDS AS REFERENCED ON SURVEY.

3. GOLFVIEW SUBDIVISION P.B. 13, PG. 12

1. COUNTY TAX MAP.

4. TITLE REPORT

1. THE DESCRIBED REAL ESTATE IS IN ZONE X, AS INDICATED BY THE FEDERAL EMERGENCY MANAGEMENT AGENCY'S NATIONAL FLOOD INSURANCE PROGRAM PANEL NO. 39093C0138D, EFFECTIVE DATE OF 8/19/2008.

2. THE EXISTENCE AND/OR LOCATION OF UTILITIES WERE OBTAINED BY FIELD CHECKS AND RESEARCH OF AVAILABLE GUARANTEE TO THEIR ACCURACY OR COMPLETENESS. EXACT UTILITY LOCATIONS MUST BE FIELD VERIFIED AT THE TIME OF

3. THIS SURVEY IS NOT FOR THE PURPOSE OF LOCATING OR IDENTIFYING ANY POLLUTANTS OR HAZARDOUS MATERIALS ON

4. GPD GROUP AND/OR THE SURVEYORS COMMENTS REGARDING BOUNDARIES, LOCATION AND/OR LIMITS OF THE RIGHTS OF WAY. EASEMENTS AND/OR SERVITUDES AS SHOWN HEREON ARE SOLELY RELATED TO THE LOCATION OF SAID ITEMS AND IS BASED ON THE INFORMATION GATHERED DURING THE FIELD SURVEY AND A REVIEW OF THE INFORMATION PROVIDED IN THE TITLE COMMITMENT REFERENCED HEREON. COMMENTS REGARDING TITLE ITEMS DO NOT REPRESENT A LEGAL OPINION ON THE EXISTENCE, TERMINATION, AFFECTS OR BENEFITS OF SAID ITEMS, AS THAT IS A QUESTION OF LAW AND OUTSIDE THE

5. NO CLEARLY IDENTIFIABLE PARKING SPACES (STRIPING) OBSERVED DURING THE TIME OF THE SURVEY.

SCHEDULE B - SECTION II:

Chicago Title Company File Number: 2153620657

Effective Date: 9/27/2021 at 6:59 a.m.

16. Reservations, restrictions, covenants, limitations, easements, and/or conditions, as established in instrument, filed for record March 3, 1931, in Deed Volume 257, Page 342, of the Lorain County, Ohio Records. RESERVATION/RESTRICTIONS/EASEMENTS ARE BLANKET IN NATURE. NO PLOTTABLE ITEMS.

17. Easement to The Ohio Public Services Co., filed for record March 25, 1936, in Deed Volume 277, Page 340, of the Lorain County, Ohio Records. RESERVATION/RESTRICTIONS/EASEMENTS ARE BLANKET IN NATURE. NO PLOTTABLE ITEMS.

18. Easement contained in deed from Mayer Goldberg and Frances Simon Goldberg, husband and wife to Citizens Home and Savings Association Co., filed for record May 23, 1977, in Deed Volume 1175, Page 469 of the Lorain County, Ohio Records.

19. Easement to Ohio Edison Company, an Ohio corporation, filed for record July 20, 1977, in Deed Volume 1181, Page 7, of the Lorain County, Ohio Records. PLOTTED AND SHOWN

20. Temporary Right of Way Agreement by and between Citizens Home and Savings Association Co. and the City of Elyria, filed for record September 17, 1979, in Deed Volume 1244, Page 831 of the Lorain County, Ohio Records. PLOTTED AND SHOWN

ZONING:

INFORMATION NOT PROVIDED BY TITLE INSURER.

RECORDS, AS REQUIRED BY O.R.C. 153.64. IT IS BELIEVED THAT THEY ARE ESSENTIALLY CORRECT; THE SURVEYOR MAKES NO

RESPONSIBILITIES OF THE SURVEYOR.

CERTIFICATION:

TO: TACO BELL OF AMERICA, LLC, A DELAWARE LIMITED LIABILITY COMPANY AND CHICAGO TITLE INSURANCE COMPANY,


THIS IS TO CERTIFY THAT THIS MAP OR PLAT AND THE SURVEY ON WHICH IT IS BASED WERE MADE IN ACCORDANCE WITH THE 2021 MINIMUM STANDARD DETAIL REQUIREMENTS FOR ALTA/NSPS LAND TITLE SURVEYS, JOINTLY ESTABLISHED AND ADOPTED BY ALTA AND NSPS, AND INCLUDES ITEMS 1, 2, 3, 4, 5, 6(a), 6(b), 7(a), 7(b1), 8, 9, 10, 11(b), 13, 18, 19 AND 20 (TACO BELL SURVEY REQUIREMENTS) OF TABLE A THEREOF. FIELD WORK WAS COMPLETED ON MARCH 15, 2022

WHATE OF O. STEVEN L MULLANEY S-7900 STEVEN L. MULLANEY, OHIO PROFESSIONAL SURVEYOR NO. 7900

ISSUED FOR: PERMIT CONSTRUCTION RECORD PROJECT MANAGER DESIGNER

SLM

2021088.52

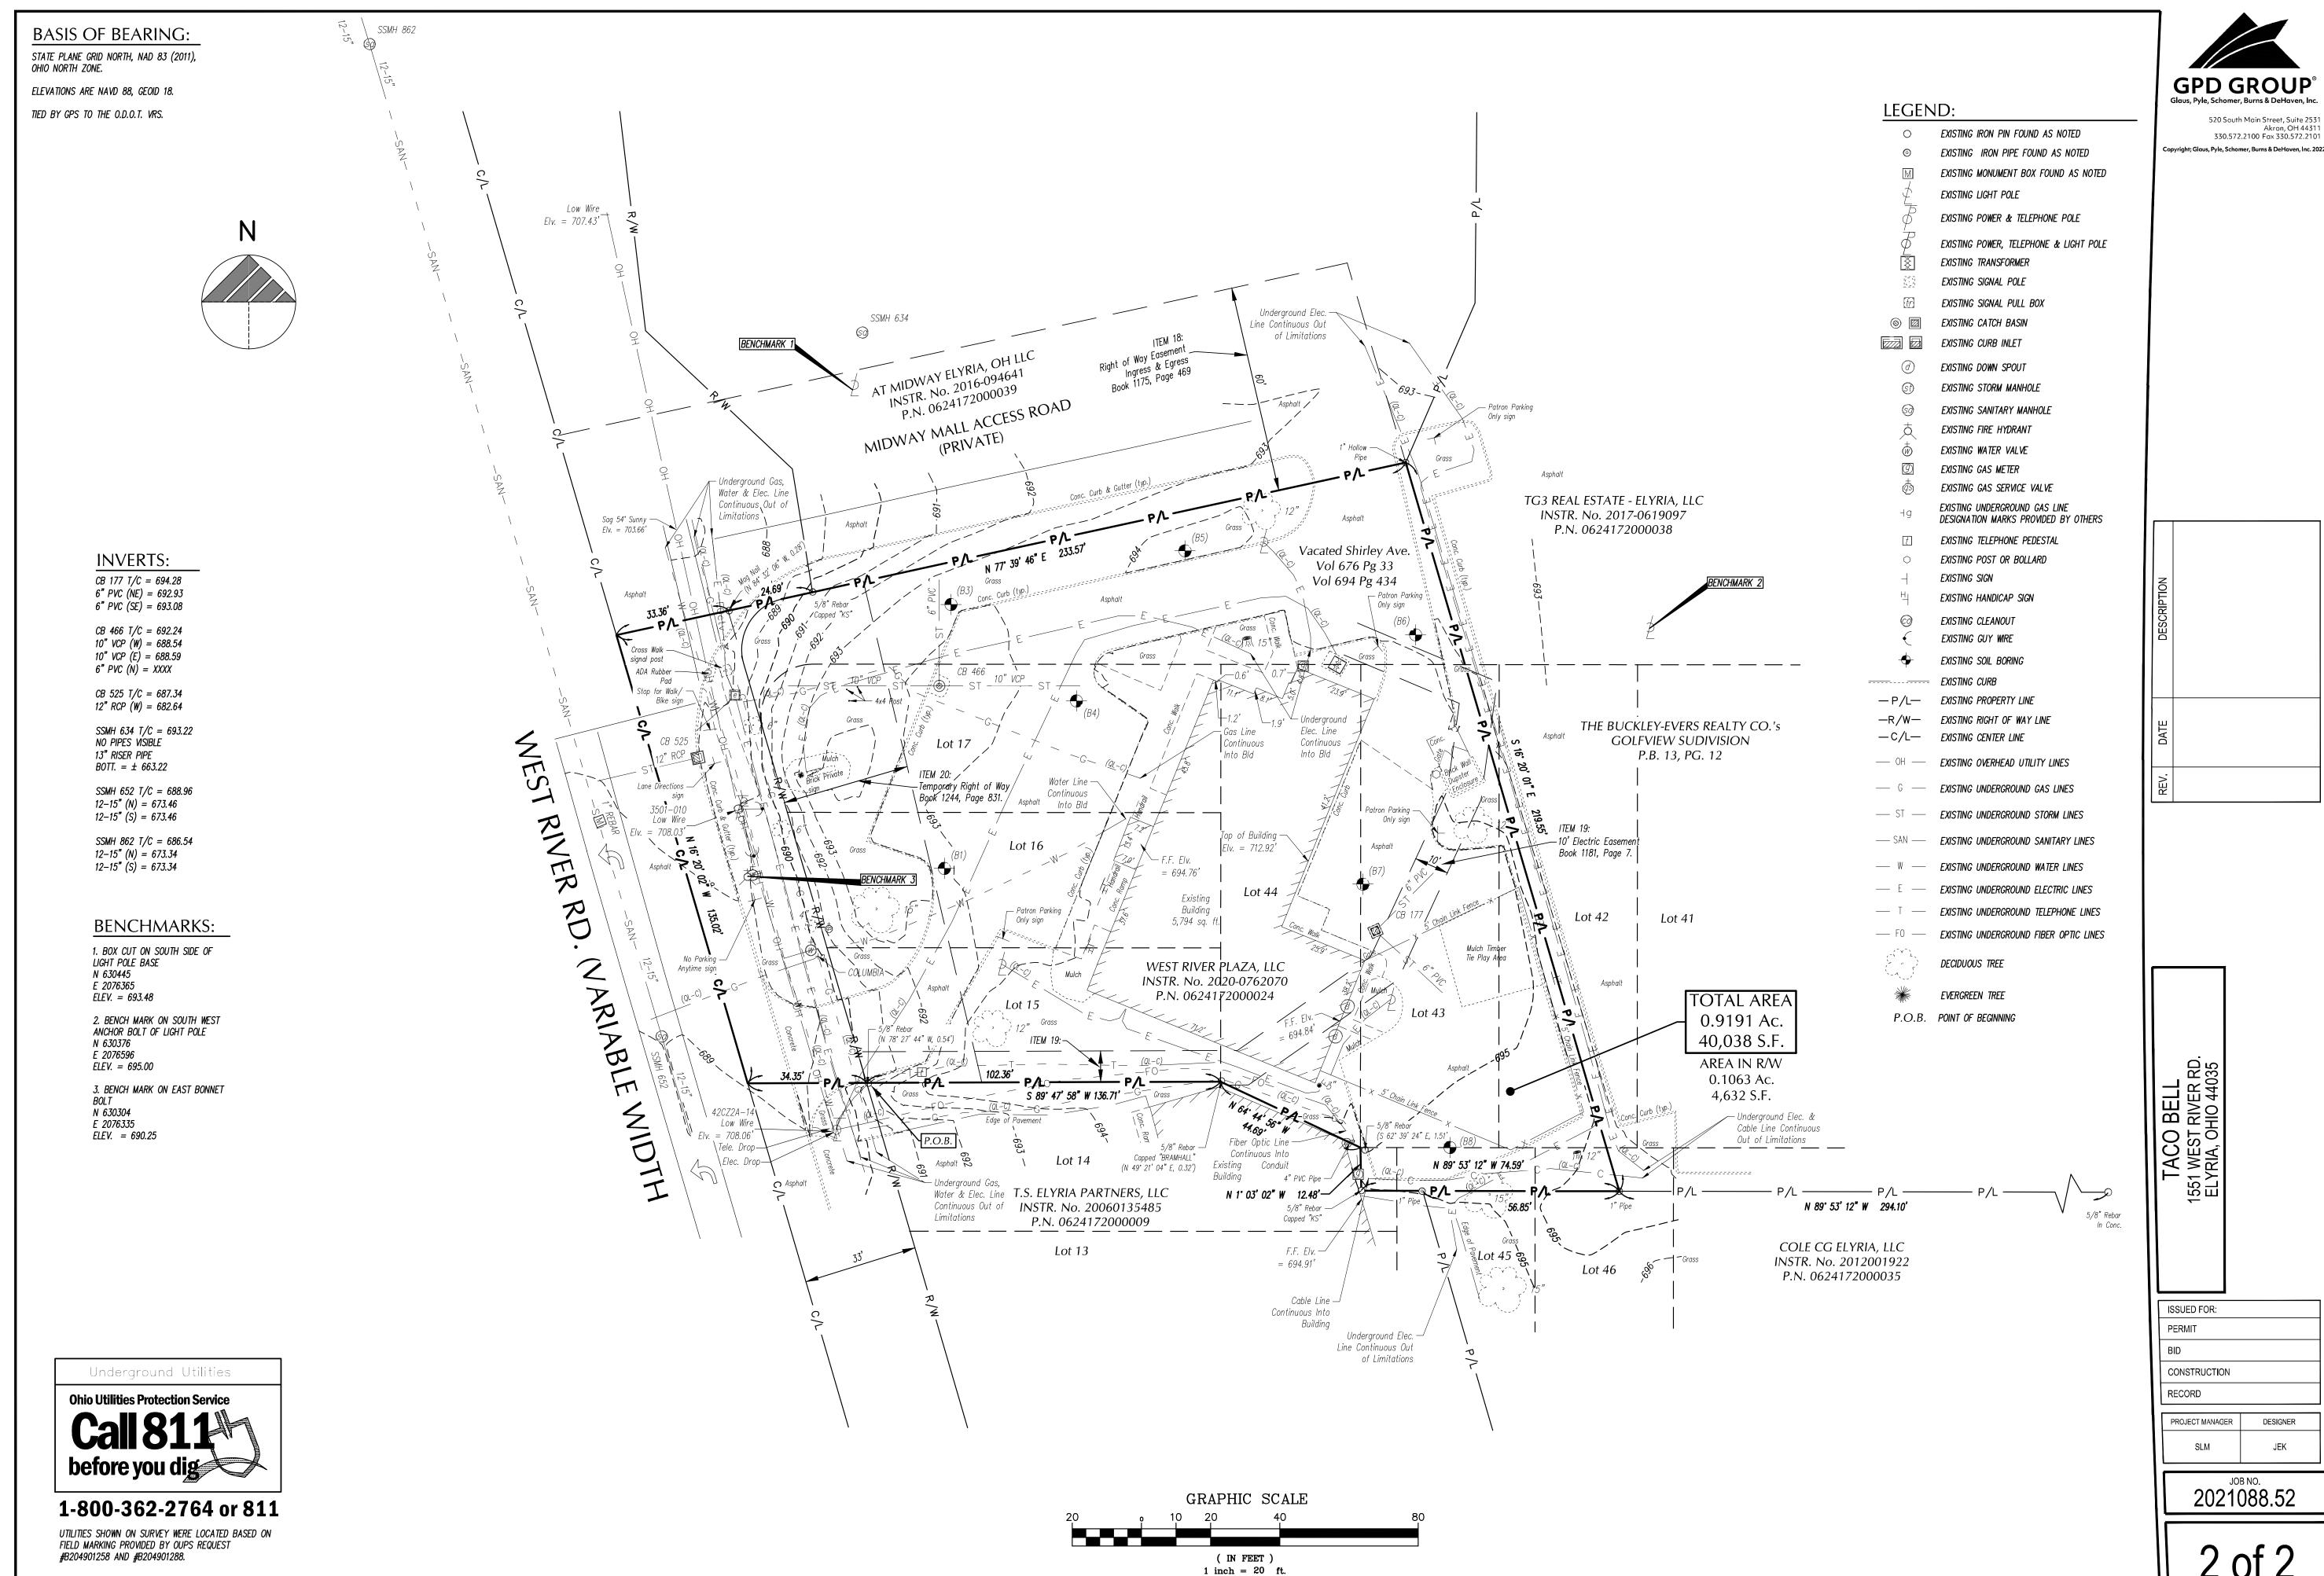

2 of 2

DEMOLITION NOTES

CONTRACTOR SHALL OBTAIN ALL REQUIRED PERMITS PRIOR TO ANY DEMOLITION PROCESS. CERTAIN ACTIVITIES ASSOCIATED WITH CONSTRUCTION WILL REQUIRE AIR PERMITS INCLUDING BUT NOT LIMITED TO: MOBILE CONCRETE BATCH PLANTS, MOBILE ASPHALT PLANTS, CONCRETE CRUSHERS, LARGE GENERATORS, ETC. THESE ACTIVITIES WILL REQUIRE SPECIFIC CURRENT STATE'S EPA OR LOCAL GOVERNING AUTHORITIES AIR PERMITS FOR INSTALLATION AND OPERATION. CONTRACTORS MUST SEEK AUTHORIZATION FROM THE CORRESPONDING GOVERNING BODIES, FOR DEMOLITION OF ALL COMMERCIAL SITES, A NOTIFICATION FOR RESTORATION AND DEMOLITION MUST BE SUBMITTED TO THE CURRENT STATE'S EPA AND LOCAL GOVERNING AUTHORITIES TO DETERMINE ANY CORRECTIVE ACTIONS THAT MAY BE REQUIRED.

DEMOLITION INCLUDES THE FOLLOWING:

OR MECHANICAL CONDITIONS.

- 2.A. TRANSFER BENCHMARK CONTROL TO NEW LOCATIONS OUTSIDE THE DISTURBED AREA PRIOR TO COMMENCING DEMOLITION OPERATIONS (WHEN APPLICABLE).
- DEMOLITION AND REMOVAL OF SITE IMPROVEMENTS NECESSARY FOR THE PROPOSED CONSTRUCTION OF NEW IMPROVEMENTS.
- REROUTING, RELOCATING, DISCONNECTING, CAPPING OR SEALING, AND ABANDONING/REMOVING SITE UTILITIES IN PLACE (WHICHEVER IS APPLICABLE).
- REMOVE AND LEGALLY DISPOSE OF ITEMS CALLED OUT TO BE REMOVED. REMOVE AND TRANSPORT DEBRIS IN A MANNER THAT WILL PREVENT SPILLAGE ON ADJACENT SURFACES AND AREAS. THOSE ITEMS INDICATED TO BE REINSTALLED, SALVAGED, OR TO REMAIN SHALL BE CLEANED, SERVICED, AND OTHERWISE PREPARED FOR REUSE. CONTRACTOR TO STORE AND PROTECT AGAINST DAMAGE. REINSTALL ITEMS IN LOCATIONS INDICATED.
- PROTECT ITEMS INDICATED TO REMAIN AGAINST DAMAGE AND SOILING THROUGHOUT CONSTRUCTION. WHEN PERMITTED BY THE CONSTRUCTION MANAGER OR OWNER, ITEMS MAY BE REMOVED TO A SUITABLE, PROTECTED STORAGE LOCATION THROUGHOUT CONSTRUCTION AND THEN CLEANED AND REINSTALLED IN THEIR ORIGINAL LOCATIONS. PROMPTLY REPAIR DAMAGES TO ADJACENT FACILITIES CAUSED BY DEMOLITION OPERATIONS AT THE CONTRACTORS COST.
- CONTRACTOR SHALL SCHEDULE DEMOLITION ACTIVITIES WITH THE CONSTRUCTION/PROJECT MANAGER INCLUDING THE FOLLOWING:
- i.A. DETAILED SEQUENCE OF DEMOLITION AND REMOVAL WORK, WITH STARTING AND ENDING DATES
- DATES FOR SHUTOFF, CAPPING, AND CONTINUATION OF UTILITY SERVICES
- IDENTIFY AND ACCURATELY LOCATE UTILITIES AND OTHER SUBSURFACE STRUCTURAL, ELECTRICAL,
- REGULATORY REQUIREMENTS: COMPLY WITH GOVERNING EPA NOTIFICATION REGULATIONS BEFORE STARTING DEMOLITION. COMPLY WITH HAULING AND DISPOSAL REGULATIONS OF AUTHORITIES HAVING JURISDICTION
- MAINTAIN EXISTING UTILITIES INDICATED TO REMAIN IN SERVICE AND PROTECT THEM AGAINST DAMAGE THROUGHOUT CONSTRUCTION OPERATIONS.
- DO NOT INTERRUPT EXISTING UTILITIES SERVING OCCUPIED OR OPERATING FACILITIES, EXCEPT WHEN AUTHORIZED IN WRITING BY OWNER'S REPRESENTATIVE AND AUTHORITIES HAVING JURISDICTION. PROVIDE TEMPORARY SERVICES DURING INTERRUPTIONS TO EXISTING UTILITIES, AS ACCEPTABLE TO OWNER AND TO GOVERNING AUTHORITIES.
- LOCATE, IDENTIFY, DISCONNECT, AND SEAL OR CAP OFF INDICATED UTILITY SERVICES SERVING THE SITE. ARRANGE TO SHUT OFF AND CAP UTILITIES WITH UTILITY COMPANIES AND FOLLOW THEIR RESPECTIVE UTILITY KILL AND CAP POLICIES. DO NOT START DEMOLITION WORK UNTIL UTILITY DISCONNECTING AND SEALING HAVE BEEN COMPLETED AND VERIFIED IN WRITING BY THE UTILITY
- CONDUCT DEMOLITION OPERATIONS TO PREVENT INJURY TO PEOPLE AND DAMAGE TO ADJACENT BUILDINGS AND FACILITIES TO REMAIN. ENSURE SAFE PASSAGE OF PEOPLE AROUND DEMOLITION AREA. SAFE PASSAGE INCLUDES THE ERECTION OF TEMPORARY PROTECTION AND/OR BARRICADES AS PER LOCAL GOVERNING AUTHORITIES AND IN ACCORDANCE WITH THE CURRENT ADA REGULATIONS. USE OF EXPLOSIVES WILL NOT BE PERMITTED.
- D. CLEAN ADJACENT BUILDINGS AND IMPROVEMENT OF DUST, DIRT, AND DEBRIS CAUSED BY DEMOLITION OPERATIONS. RETURN ADJACENT AREAS TO CONDITION EXISTING BEFORE START OF DEMOLITION.
- PROMPTLY DISPOSE OF DEMOLISHED MATERIALS. DO NOT ALLOW DEMOLISHED MATERIALS TO ACCUMULATE ON-SITE. STORAGE OR SALE OF REMOVED ITEMS OR MATERIALS ON-SITE WILL NOT BE PERMITTED. NO BURNING OF ANY MATERIALS ON SITE SHALL BE PERMITTED.
- 2. IT IS NOT EXPECTED THAT ASBESTOS WILL BE ENCOUNTERED IN THE COURSE OF THIS CONTRACT. IF ANY MATERIALS SUSPECTED OF CONTAINING ASBESTOS ARE ENCOUNTERED, DO NOT DISTURB THE MATERIALS. IMMEDIATELY NOTIFY THE CONSTRUCTION MANAGER AND THE OWNER.
- 3. SURVEY THE CONDITION OF THE STRUCTURE TO DETERMINE WHETHER REMOVING ANY ELEMENT MIGHT RESULT IN A STRUCTURAL DEFICIENCY OR UNPLANNED COLLAPSE OF ANY PORTION OF THE STRUCTURE OR ADJACENT STRUCTURES THROUGHOUT CONSTRUCTION.
- 4. DEMOLISH BUILDING AND STRUCTURAL PADS COMPLETELY AND REMOVE FROM THE SITE. USE METHODS REQUIRED TO COMPLETE WORK WITHIN LIMITATIONS OF GOVERNING REGULATIONS AND AS ALTERNATE ROUTES AROUND CLOSED OR OBSTRUCTED TRAFFIC WAYS.
- 14.A. DISPOSE OF DEMOLISHED ITEMS AND MATERIALS PROMPTLY.
- 14.B. DEMOLISH CONCRETE AND MASONRY IN SMALL SECTIONS. 14.C. BREAK UP AND REMOVE CONCRETE SLABS ON GRADE.
- 5. BELOW-GRADE DEMOLITION: DEMOLISH FOUNDATION WALLS, PAVEMENTS, AND OTHER
- BELOW-GRADE DEMOLITION. AS FOLLOWS: 5.A. COMPLETELY REMOVE BELOW-GRADE DEMOLITION, INCLUDING FOUNDATION WALLS FOOTINGS, KNOWN AND UNKNOWN PAVEMENT SECTIONS INCLUDING UNDERLYING CONCRETE SLABS, AND OTHER BELOW GRADE CONCRETE SLABS FOUND DURING DEMOLITION (INCLUDING ITEMS WHICH MAY NOT BE IDENTIFIED HEREIN).
- 5. FILLING BELOW-GRADE AREAS: COMPLETELY FILL BELOW-GRADE AREAS AND VOIDS RESULTING FROM DEMOLITION OF BUILDINGS, PAVEMENTS, AND OTHER REMOVED ITEMS WITH SOIL MATERIALS ACCORDING TO REQUIREMENTS PER SOILS REPORT AND ON-SITE GEOTECHNICAL ENGINEER'S REPRESENTATIVE. CONTRACTOR SHALL CONTACT GEOTECHNICAL ENGINEER PRIOR 15. ALL DIMENSIONS, GRADES, AND UTILITY LOCATIONS SHOWN ON THESE PLANS WERE BASED TO FILLING ANY AREAS TO OBSERVE FILL PROCEDURES.
- CONDUCT DEMOLITION OPERATIONS AND REMOVE DEBRIS TO ENSURE MINIMUM INTERFERENCE WITH ROADS. STREETS, WALKS, AND OTHER ADJACENT OCCUPIED AND USED FACILITIES. DO NOT CLOSE OR OBSTRUCT STREETS, WALKS, OR OTHER ADJACENT OCCUPIED OR USED FACILITIES WITHOUT PERMISSION FROM OWNER AND AUTHORITIES HAVING JURISDICTION. PROVIDE ALTERNATE ROUTES AROUND CLOSED OR OBSTRUCTED TRAFFIC WAYS IF REQUIRED BY GOVERNING REGULATIONS.
- 8. CONTRACTOR TO WET SAWCUT EXISTING PAVEMENT TO REMAIN AT NEXT NEAREST JOINT PRIOR TO REMOVALS OF CURB, GUTTER, PAVEMENT, ETC.
- 9. THE CONTRACTOR SHALL REMOVE EXISTING PAVEMENT MARKINGS WITH SMALL HANDHELD GRINDERS OR SCARIFIERS OR OTHER METHODS, WITH THE APPROVAL OF THE CONSTRUCTION MANAGER. TAKE CARE DURING MARKING REMOVAL NOT TO SCAR, DISCOLOR, OR OTHERWISE DAMAGE THE PAVEMENT SURFACE. DO NOT OVERPAINT OR USE OTHER METHODS OF COVERING MARKINGS INSTEAD OF RFMOVAL
- O. IF UNDERGROUND TANKAGE IS CALLED FOR DEMOLITION, THE CONTRACTOR SHALL COORDINATE REMOVAL AND REPLACEMENT WITH THE STATE BUREAU OF UNDERGROUND STORAGE TANK REGULATIONS (BUSTR). UNDERGROUND TANK REMOVAL SHALL ALSO INCLUDE THE REMOVAL OF ANY 17. THE CONTRACTOR SHALL RUN AN INDEPENDENT VERTICAL CONTROL TRAVERSE TO CHECK MONITORING WELLS, OIL/GAS WELLS, AND MINE SHAFTS, IN ACCORDANCE WITH GOVERNING AUTHORITIES HAVING JURISDICTION.
- 1. CONTRACTOR SHALL FULLY SECURE WORK AREA WITH THE APPROPRIATE SIGNAGE, FENCING, AND BARRICADES WHICH ACCOMMODATE VISUALLY IMPAIRED PERSONS AS AGREED UPON WITH SITE CONSTRUCTION/PROJECT MANAGER AND OWNER TO WARN AND KEEP PEOPLE OUT OF THE SITE WORK AREA FOR THE DURATION OF THE PROJECT.

GENERAL PLAN AND SURVEY NOTES

- 1. PRIOR TO STARTING CONSTRUCTION THE CONTRACTOR SHALL BE RESPONSIBLE FOR MAKING SURE THAT ALL REQUIRED PERMITS AND APPROVALS HAVE BEEN OBTAINED. NO CONSTRUCTION OR FABRICATION SHALL BEGIN UNTIL THE CONTRACTOR HAS RECEIVED AND THOROUGHLY REVIEWED ALL PLANS AND OTHER DOCUMENTS APPROVED BY ALL OF THE PERMITTING AUTHORITIES.
- 2. THE CONTRACTOR'S ATTENTION IS DIRECTED TO THE SECTION OF THESE NOTES ENTITLED "GRADING PLAN NOTES" FOR DEFINITIONS AS MAY BE NECESSARY FOR "GEOTECHNICAL ENGINEER" AND "SOILS REPORT"
- 3. ALL WORK SHALL BE PERFORMED IN ACCORDANCE WITH THESE PLANS, SPECIFICATIONS AND THE REQUIREMENTS AND STANDARDS OF THE LOCAL GOVERNING AUTHORITY. THE SOILS REPORT AND RECOMMENDATIONS SET FORTH THEREIN ARE A PART OF THE REQUIRED CONSTRUCTION DOCUMENTS AND TAKE PRECEDENCE UNLESS SPECIFICALLY NOTED OTHERWISE ON THE PLANS. THE CONTRACTOR SHALL NOTIFY THE CONSTRUCTION/PROJECT MANAGER OF ANY DISCREPANCY BETWEEN SOILS REPORT AND PLANS, ETC.
- 4. THE CONTRACTOR SHALL, UPON BECOMING AWARE OF SUBSURFACE OR LATENT PHYSICAL CONDITIONS DIFFERING FROM THOSE DISCLOSED BY THE ORIGINAL SOIL EXPLORATION WORK, PROMPTLY NOTIFY THE OWNER VERBALLY TO PERMIT VERIFICATION OF THE CONDITIONS AND IN WRITING, AS TO THE NATURE OF THE DIFFERING CONDITIONS. NO CLAIM BY THE CONTRACTOR FOR ANY CONDITIONS DIFFERING FROM THOSE ANTICIPATED IN THE PLAN AND SPECIFICATIONS AND DISCLOSED BY THE SOIL STUDIES WILL BE ALLOWED UNLESS THE CONTRACTOR HAS SO NOTIFIED THE OWNER, VERBALLY AND IN WRITING AS REQUIRED ABOVE, OF SUCH DIFFERING CONDITIONS.
- 5. ALL WORK WITHIN THE RIGHTS OF WAY SHALL BE IN ACCORDANCE WITH THE GOVERNING JURISDICTION AND SPECIFICATIONS.
- 6. CONTRACTOR SHALL COORDINATE ANY MAINTENANCE OF TRAFFIC WITH THE OWNER'S REPRESENTATIVE AND THE LOCAL JURISDICTION PRIOR TO CONSTRUCTION.
- 7. CONTRACTOR SHALL AT ALL TIMES ENSURE THAT SWPP MEASURES PROTECTING EXISTING DRAINAGE FACILITIES BE IN PLACE PRIOR TO THE COMMENCEMENT OF ANY PHASE OF THE SITE CONSTRUCTION OR LAND ALTERATION. (SEE SWPP PLANS).
- 8. ALL WORK SHALL BE COMPLETED IN A NEAT AND ORDERLY MANNER REMOVING ALL EXCESS MATERIAL AND WASTE FROM THE SITE INCLUDING TIMELY REMOVAL OF ANY CONCRETE SPLATTER. UPON COMPLETION OF PROJECT. CONTRACTOR SHALL CLEAN THE PAVED AREAS PRIOR TO REMOVAL OF TEMPORARY SEDIMENT CONTROLS, AS DIRECTED BY THE CITY AND/OR CONSTRUCTION/PROJECT MANAGER. IF POWER WASHING IS USED, NO SEDIMENT LADEN WATER SHALL BE WASHED INTO THE STORM SYSTEM. ALL SEDIMENT LADEN MATERIAL ON PAVEMENT OR WITHIN THE STORM SYSTEM SHALL BE COLLECTED AND REMOVED FROM THE SITE AT CONTRACTOR'S EXPENSE (SEE SWPP PLANS).
- 9. THESE PROJECT CONSTRUCTION DOCUMENTS SHALL NOT CONSTITUTE A CONTRACTUAL RELATIONSHIP BETWEEN GPD GROUP: GLAUS, PYLE, SCHOMER, BURNS & DEHAVEN, INC. AND THE CONTRACTOR / SUBCONTRACTOR / OR OTHER AFFILIATED PARTIES.
- 10. THE ENGINEER WILL NOT BE RESPONSIBLE FOR CONSTRUCTION OR SAFETY, MEANS, METHODS, TECHNIQUES, SEQUENCES OR PROCEDURES UTILIZED IN CONSTRUCTION BY THE CONTRACTOR OR SUBCONTRACTORS. ANY SEQUENCING OR SUGGESTED NOTATIONS WHICH MAY APPEAR IN THE PLANS IS INTENDED TO ASSIST IN THE UNDERSTANDING OF PROJECT INTENT.
- 11. DETAILS, NOTES, AND OTHER REFERENCES CONTAIN HEREIN MAY HAVE BEEN ATTAINED FROM OUTSIDE REFERENCE SOURCE LOCATIONS SUCH AS, BUT NOT LIMITED TO, LOCAL AUTHORITY AGENCIES, DESIGN REFERENCE MANUALS, MANUFACTURE'S RECOMMENDED DOCUMENTATION, OR OTHER INDUSTRY SOURCES. GPD DOES NOT WARRANT INFORMATION OR REPRESENTATION OF SAID CONTENT CONTAINED HEREIN, IT IS SHOWN SOLELY FOR REFERENCE ONLY OF DESIGN INTENT AT THE TIME OF PLAN PREPARATION. THE CONSTRUCTION TEAM MEMBERS (CONTRACTOR AND CONSTRUCTION MANAGER, WHERE APPLICABLE) SHALL OBTAIN THE MOST CURRENT DETAILED INFORMATION FROM THE RESPECTIVE SOURCE TO CONSTRUCT THE IMPROVEMENTS UNDER THE AUTHORITY OF THE RESPECTIVE GOVERNING AGENCIES. IF ANY DISCREPANCIES ARE DISCOVERED BETWEEN THE ORIGINAL DESIGN INTENT AND THE CONSTRUCTION TEAM OBTAINED REFERENCE MATERIAL, THE CONSTRUCTION MANAGER OR THE PROJECT'S CONTACT PERSON SHALL BE NOTIFIED PRIOR TO COMMENCING OF ASSOCIATED WORK.
- 12. CONDUCT CONSTRUCTION OPERATIONS TO ENSURE MINIMUM INTERFERENCE WITH ROADS STREETS, WALKS, AND OTHER ADJACENT OCCUPIED AND USED FACILITIES. DO NOT CLOSE OR OBSTRUCT STREETS, WALKS, OR OTHER ADJACENT OCCUPIED OR USED FACILITIES WITHOUT PERMISSION FROM OWNER AND AUTHORITIES HAVING JURISDICTION. PROVIDE
- 13. THE ALTA/NSPS LAND TITLE SURVEY BY GPD GROUP: GLAUS, PYLE, SCHOMER, BURNS & DEHAVEN, INC, DATED 04/13/2022 SHALL BE CONSIDERED A PART OF THESE PLANS. THE G.C. IS RESPONSIBLE FOR LOCATING IMPROVEMENTS PER THESE PLANS.
- 14. THE LOCATIONS OF UNDERGROUND FACILITIES SHOWN ON THE PLANS ARE BASED ON ALTA/NSPS LAND TITLE SURVEY. IT SHALL BE THE CONTRACTOR'S FULL RESPONSIBILITY TO BECOME FAMILIAR WITH THE SITE'S POSSIBLE BELOW GRADE FEATURES, INCLUDING BUT NOT LIMITED TO, ROOMS, VAULTS, UTILITIES, ETC. AND SHALL CONDUCT A WALK THROUGH WITH THE OWNER'S REPRESENTATIVE. CONTRACTOR SHALL CONTACT THE VARIOUS UTILITY COMPANIES TO LOCATE THEIR FACILITIES PRIOR TO STARTING CONSTRUCTION. NO ADDITIONAL COMPENSATION SHALL BE PAID TO THE CONTRACTOR FOR REPAIR TO DAMAGE
- ON THE SURVEY. THE CONTRACTOR SHALL FIELD VERIFY ALL EXISTING CONDITIONS PRIOR TO CONSTRUCTION. CONTRACTOR SHALL NOTIFY CONSTRUCTION/PROJECT MANAGER IF ANY DISCREPANCIES EXIST PRIOR TO PROCEEDING WITH CONSTRUCTION FOR NECESSARY CHANGES. NO EXTRA COMPENSATION SHALL BE PAID TO THE CONTRACTOR FOR WORK HAVING TO BE REDONE DUE TO INFORMATION SHOWN INCORRECTLY ON THESE PLANS IF SUCH NOTIFICATION HAS NOT BEEN GIVEN.
- 16. IN SOME CASES, THE DEVELOPER OR OWNER MAY HAVE PROVIDED THEIR OVERALL DEVELOPMENT PLANS FOR THE PROJECT DESIGN RATHER THAN A FIELD SURVEY. (SEE SITE PLAN FOR NOTES WHEN THIS IS THE CASE). ALL DIMENSIONS, GRADES, AND UTILITY LOCATIONS SHOWN ON THESE PLANS WERE BASED ON AN ALTA SURVEY. THE CONTRACTOR SHALL FIELD VERIFY ALL EXISTING CONDITIONS PRIOR TO CONSTRUCTION. CONTRACTOR SHALL NOTIFY CONSTRUCTION MANAGER IF ANY DISCREPANCIES EXIST PRIOR TO PROCEEDING WITH CONSTRUCTION FOR NECESSARY CHANGES. NO EXTRA COMPENSATION SHALL BE PAID TO THE CONTRACTOR FOR WORK HAVING TO BE REDONE DUE TO INFORMATION SHOWN INCORRECTLY ON THESE PLANS IF SUCH NOTIFICATION HAS NOT BEEN GIVEN.
- BENCHMARKS AND A HORIZONTAL CONTROL TRAVERSE THROUGH THE REFERENCED PROJECT CONTROL DATUM TO CONFIRM GEOMETRIC DATA. IT IS THE CONTRACTORS RESPONSIBILITY TO NOTIFY THE CONSTRUCTION MANAGER OF ANY DISCREPANCIES PRIOR TO THE START OF CONSTRUCTION.

CONCRETE NOTES AND SPECIFICATIONS

- 1. ALL EXTERIOR SITE SPECIFIC PORTLAND CEMENT CONCRETE (PCC) (I.E. SIDEWALK, PAVEMENT OR CURBING) SHALL MEET THE MINIMUM REQUIREMENTS OF THE LATEST EDITIONS OF THE STATE DEPARTMENT OF TRANSPORTATION (DOT) AND THE AMERICAN CONCRETE INSTITUTE (ACI) SPECIFICATIONS USING THE RESPECTIVE ASTM STANDARDS FOR MATERIALS USED. MIXING. TRANSPORTATION, FORMING, PLACEMENT, CURING, AND SEALING. THE MINIMUM STRENGTH FOR NORMAL WEIGHT CONCRETE IS 4000 PSI AT 28 DAY STRENGTH. CONTRACTOR SHALL REFER TO DETAILS, NOTES, AND SPECIFICATIONS WITHIN THE CONSTRUCTION DOCUMENTS FOR VARIATIONS TO THIS SPECIFICATION. MIX DESIGN SHOP DRAWINGS SHALL BE TAILORED TO THE ACTUAL FIELD PLACEMENT CONDITIONS AND BE SUBMITTED TO THE CONSTRUCTION/PROJECT MANAGER IN ACCORDANCE WITH THE PROJECT REQUIREMENTS.
- ALL EXTERIOR CONCRETE CURBS SHALL HAVE JOINTS PER ACI 330. CURB JOINTS ARE TO ALIGN WITH CONCRETE PAVEMENT JOINTS WHERE APPLICABLE, TYPICALLY BEING 10 FT TO 12 FT. ALL EXTERIOR VEHICULAR CONCRETE PAVEMENT AND FLATWORK SHALL HAVE CONTROL JOINTS PER TABLE BELOW AND EXPANSION JOINTS PER ACI 330 TYPICAL RECOMMENDATIONS.

SLAB THICKNESS - " T "	MAXIMUM JOINT SPACING
LESS THAN 4 INCHES	8 FEET
4 - < 5 INCHES	10 FEET
5 - < 6 INCHES	12.5 FEET
6 INCHES - < 8 INCHES	15 FEET
8 INCHES - 10 INCHES	15 FEET

- ALL JOINTS, INCLUDING SAWED JOINTS, SHALL BE SEALED. JOINTS SHALL BE CLEANED AND DRIED PRIOR TO SEALING. JOINT SEALING MATERIALS SHALL COMPLY WITH ASTM D 3406 FOR HOT APPLIED ELASTOMERIC, TT-S-001543A FOR SILICONE RUBBER, AND TT-S-00230S FOR SINGLE COMPONENT ELASTOMERIC. SEALER WIDTH, DEPTH, AND PREPARED APPLICATION SURFACES SHALL BE PER MANUFACTURES RECOMMENDATIONS. JOINT FILLER MATERIAL SHALL CONFORM TO ASTM D1751 OR ASTM D8139 AND EXTEND THE FULL DEPTH OF CONTACTING SURFACE.
- 4. ALL CONCRETE PANELS SHALL BE SQUARE WITH A LENGTH TO WIDTH RATIO NO GREATER THAN 1.25 TO 1 AND HAVE A MEDIUM BROOM FINISH (TRANSVERSE, SLIP RESISTANT FOR PEDESTRIAN PATHWAYS) WHICH SHALL BE TO MINIMUM STRENGTH PRIOR TO OPENING FOR VEHICULAR TRAFFIC AREAS. STAGGERED/OFFSET JOINT, INTERIOR CORNERS, ANGLES LESS THAN 60 DEGREES, SLABS LESS THAN 18-INCHES WIDE, AND ODD SHAPES SHALL NOT BE PERMITTED. BLOCKOUTS AROUND ALL PAVEMENT CASTINGS SHALL BE PROVIDED IN ACCORDANCE WITH ACI RECOMMENDATIONS.
- ALL JOINTING (IF) SHOWN HEREIN IS ONLY A GENERAL GUIDELINE OF DESIGN INTENT. THE CONTRACTOR SHALL BE FULLY RESPONSIBLE FOR FINAL LAYOUT OF THE JOINTING WHICH COINCIDES WITH THEIR MEANS AND METHODS TO ENSURE NO UNDESIRED CRACKS FORM THROUGH ANY PLACED CONCRETE. JOINTS SHALL BE APPROPRIATELY PLACED AS SOON AS POSSIBLE TO KEEP UNNECESSARY CRACKS FROM DEVELOPING. CONTRACTOR SHALL SUBMIT SHOP DRAWING OF THEIR PAVEMENT JOINT LAYOUT TO OWNER / CONSTRUCTION MANAGER PRIOR TO PLACEMENT FOR RECORD. THE CONTRACTOR SHALL REPLACE ANY CRACKED CONCRETE, WHICH HAS NOT BEEN PLACED/FINISHED IN ACCORDANCE WITH ACI STANDARDS, TO THE NEXT JOINT PAST THE EFFECTED AREA AT NO ADDITIONAL COST TO THE PROJECT WITHIN ONE YEAR OF PROJECT COMPLETION.
- 6. DESIGN INTENT CONCRETE AND SHALL CONFORM TO THE FOLLOWING MINIMUM AND MAXIMUM

VALU	ES:	TO THE POLLOWING MINIMON AND MACHINE
a.	STRENGTH	PER MIX DESIGN, MINIMUM 4000 PSI
b.	PORTLAND CEMENT CONTENT	550 LB / CY (ASTM C150 TYPE I/II)
C.	POZZOLAN MATERIALS	SILICA FUME MAY REPLACE MAX. 7% CEMENT
	(SEE NOTES BELOW)	FLY ASH OR SLAG CEMENT MAY REPLACE
		MAX. 20% CEMENT
d.	MAX W/C RATIO	PER MIX DESIGN, MAXIMUM 0.45
e.	ENTRAINED AIR	6.5% AVG ± 1.5% (7.0% TARGET) ASTM C260
f.	SLUMP	4" MAX WITHOUT WATER REDUCER
g.	SLUMP WITH HRWR OR MID RANGE WR	6" TO 8"
h.	WATER REDUCER	NORMAL TYPE A (ASTM C494)
i.	RETARDER	NORMAL TYPE B OR D AS NEEDED (REQUIRED
		IF CONCRETE TEMPERATURE EXCEEDS 85F)
j.	CONCRETE TEMPERATURE AT PLACEMENT	
k.	ACCELERATOR	NON-CHLORIDE TYPE ONLY - CALCIUM
		CHLORIDE IS PROHIBITED
l.	FIBERS TO BE USED	POLYPROPYLENE OR POLYETHYLENE
	FOR SHRINKAGE CRACK CONTROL	MiCRO SYNTHETIC FIBERS @ 1.5 LBS / CY
	- (CURBS, WALKS, STEPS, RAMPS)	(FIBERMESH 300 OR APPROVED EQUAL)
	- FOR USE AS W.W.F. REPLACEMENT	MACRO SYNTHETIC FIBERS @ 4.0 LBS / CY
	(VEHICULAR TRAFFIC PAVEMENT)	(TUF-STRAND SF OR APPROVED EQUAL)
ALL S	YNTHETIC FIBERS SHALL BE TYPE III PER AS	TM C1116 AND ASTM D7508. MACRO FIBERS

- 7. ALL SYNTHETIC FIBERS SHALL BE TYPE III PER ASTM C1116 AND AS I M D/508. MACKO FIBERS SHALL BE 1.5 TO 2.25 INCHES IN LENGTH.
- 8. ALL REINFORCING STEEL SHALL CONFORM TO ASTM A615, ASTM A1064, ASTM A307, AND ASTM A775. WHEN USED, ALL W.W.F. SLAB REINFORCEMENT SHALL BE SUPPORTED ON CHAIRS AND BE FLAT SHEETS ONLY. ZINC REPAIR MATERIAL SHALL CONFORM TO ASTM A780.
- 9. CONCRETE SHALL ARRIVE AT JOB SITE WITH APPROPRIATE W/C RATIO. NO WATER SHALL BE ADDED TO CONCRETE ON SITE WHICH EXCEEDS THE MAXIMUM ALLOWED W/C RATIO AS INDICATED BY THE WRITTEN BATCH PLANT TICKET FROM THE SUPPLIER. SUPERPLASTICIZER AND/OR OTHER ADMIXTURES MAY BE UTILIZED TO ACHIEVE DESIRED WORKABILITY OR TO ACCOUNT FOR ADVERSE PLACEMENT CONDITIONS. ADMIXTURES SHALL BE UTILIZED ONLY IN ACCORDANCE WITH THE MANUFACTURES WRITTEN INSTRUCTIONS AND MEET THE REQUIREMENTS OF ASTM C494 AND/OR ASTM C1017.
- CAUSED BY THEIR WORK FORCE TO FACILITIES WHICH ARE NOT INTENDED TO BE DISTURBED 10. CONTRACTOR SHALL HAVE A MIN. 5 YEARS EXPERIENCE WITH SUCCESSFUL PLACEMENT OF CONCRETE UTILIZING POZZOLAN MATERIALS. MIX DESIGNS WHICH UTILIZED POZZOLAN MATERIALS SHALL BE IN ACCORDANCE WITH LOCAL DOT SPECIFICATIONS AND ACI STANDARDS. FLY ASH SHALL MEET THE REQUIREMENTS OF ASTM C618, CLASS C OR CLASS F, EXCEPT THE LOSS ON IGNITION MUST NOT EXCEED 5%. SLAG CEMENT ACCORDING TO ASTM C989, GRADE 100 MINIMUM. SILICA FUME SHALL BE DRY DENSIFIED MEETING THE REQUIREMENTS OF ASTM C1240. USE OF MATERIALS SHALL BE IN ACCORDANCE WITH ACI 211.1.
 - 11. AGGREGATES SHALL BE LOW-SHRINKAGE / WELL GRADED PER ASTM C33 AND THE LOCAL DOT SPECIFICATIONS WHICH ARE RESISTANT TO FREEZE / THAW, SULFATE ATTACK, AND ARE NOT ALKALI-CARBONATE AGGREGATES OR SUSCEPTIBLE TO ALKALI-AGGREGATE REACTIVITY. SLAG AGGREGATES SHALL NOT BE PERMITTED IN ANY CONCRETE MIX.
 - 12. LIQUID MEMBRANE FORMING CURING COMPOUNDS SHALL BE PER ASTM C1315 TYPE II CLASS A IN ACCORDANCE WITH ACI 308. LIQUID MEMBRANE FORMING CURING COMPOUNDS SHALL BE WHITE PIGMENTED AND TWO COATS APPLIED IN TWO PERPENDICULAR UNIFORM APPLICATIONS PER MANUFACTURES RECOMMENDATIONS WITHIN THE ALLOWABLE TIME PERIODS. APPLICATIONS SHALL BE PHOTOGRAPH DOCUMENTED FOR EVEN AND CONSISTENT COVERAGE SIMILAR TO THE APPEARANCE OF A BLANK WHITE SHEET OF COPY PAPER. NO POOLING OF MATERIAL SHALL BE ACCEPTED.
 - 13. CONCRETE SEALER SHALL BE APPLIED IN ACCORDANCE WITH MANUFACTURER'S WRITTEN INSTRUCTIONS. A WRITTEN STATEMENT FROM THE MANUFACTURE FOR THE SEALER AND CURING PROPOSED GENERAL LEGEND COMPOUND SHALL BE PROVIDED GUARANTEEING COMPATIBILITY.
 - 14. REFER TO ACI INDUSTRY STANDARDS FOR CONCRETE PLACEMENT AND INSTALLATION. CONTRACTOR SHALL INCLUDE PROVISIONS IN ACCORDANCE WITH ACI 305R AND 306R FOR HOT AND COLD WEATHER PLACEMENT WHEN PROJECT SCHEDULE TIMING FALLS WITHIN THE REQUIRED TEMPERATURE RANGES PER ACI AND THE LOCAL DOT.

GRADING PLAN NOTES

- A GEOTECHNICAL REPORT HAS BEEN PREPARED BY PSI, DATED MARCH 25, 2022 (REVISED MARCH 29, 2022) AND SHALL BE CONSIDERED TO BE A PART OF THIS PLAN SET.
- 2. BEFORE STARTING GRADING OPERATIONS, SEE STORMWATER POLLUTION PREVENTION PLAN, NOTES AND DETAILS (SWPP), LANDSCAPE PLAN AND SOILS REPORT FOR TREATMENT OF EXISTING GRADE.
- PRIOR TO SITE CONSTRUCTION ACTIVITY, THE CONTRACTOR SHALL INSTALL ALL SWPP MEASURES TO PROTECT EXISTING DRAINAGE FACILITIES. CONTRACTOR SHALL PREVENT SILTATION FROM LEAVING THE SITE AT ALL TIMES.
- . STRIP BUILDING AND PAVEMENT AREAS OF ALL ORGANIC TOPSOILS. STOCKPILE SUITABLE TOPSOILS FOR RESPREADING ONTO LANDSCAPE AREAS. ALL EXCESS EXCAVATED MATERIALS SHALL BE REMOVED FROM THE SITE AT THE CONTRACTOR'S EXPENSE. SEE GEOTECHNICAL REPORT FOR STRIPPING AND TOPSOIL REQUIREMENTS.
- 5. OBTAIN APPROVED BORROW SOIL MATERIALS OFF-SITE WHEN SUFFICIENT SATISFACTORY SOIL MATERIALS ARE NOT AVAILABLE ON-SITE.
- 6. SITE GRADING SHALL BE PERFORMED IN ACCORDANCE WITH THESE PLANS AND SPECIFICATIONS AND THE RECOMMENDATIONS SET FORTH IN THE GEOTECHNICAL REPORT. THE CONTRACTOR SHALL BE RESPONSIBLE FOR REMOVING ALL SOFT, YIELDING OR UNSUITABLE MATERIALS AND REPLACING WITH SUITABLE MATERIALS AS SPECIFIED IN THE GEOTECHNICAL REPORT. UNLESS OTHERWISE SPECIFIED IN THE PLANS, SPECIFICATIONS, OR GEOTECHNICAL REPORT THE SITE GRADING, EXCAVATION, AND EMBANKMENT SHALL BE IN ACCORDANCE WITH THE STATE DEPARTMENT OF TRANSPORTATION CONSTRUCTION AND MATERIAL SPECIFICATIONS.
- 7. AT A MINIMUM ALL EXCAVATED OR FILLED AREAS SHALL BE COMPACTED TO 98% OF STANDARD PROCTOR MAXIMUM DRY DENSITY PER A.S.T.M. TEST D-698. MOISTURE CONTENT AT TIME OF PLACEMENT SHALL NOT EXCEED 2% ABOVE NOR 2% BELOW OPTIMUM. THE CONTRACTOR SHALL FOLLOW THE RECOMMENDATIONS OF THE GEOTECHNICAL REPORT AND RETAIN A QUALIFIED SOILS ENGINEER REGISTERED WITHIN THE STATE TO ENSURE COMPLIANCE WITH THE GEOTECHNICAL REPORT, MAKE GEOTECHNICAL RECOMMENDATIONS BASED ON FIELD CONDITIONS, AND ENSURE THAT ALL SHORING AND DEWATERING MEANS AND METHODS WILL NOT COMPROMISE THE STABILITY OF EXISTING OR PROPOSED FOOTINGS/FOUNDATIONS. THE OWNER SHALL RECEIVE ALL COMPACTION REPORTS PREPARED BY THE CONTRACTOR'S GEOTECHNICAL ENGINEER, VERIFYING THAT ALL FILLED AREAS AND SUBGRADE AREAS WITHIN THE BUILDING PAD AREA AND AREAS TO BE PAVED HAVE BEEN COMPACTED IN ACCORDANCE WITH THESE PLANS AND SPECIFICATIONS AND THE RECOMMENDATIONS SET FORTH IN THE GEOTECHNICAL REPORT. NOTIFY PROJECT CONSTRUCTION MANAGER IF ANY UNSUITABLE SOILS ARE FOUND.
- 8. FOLLOWING GRADING OF SUBSOIL TO SUBGRADE ELEVATIONS THE CONTRACTOR SHALL PLACE TOPSOIL TO A 6" DEPTH (UNLESS OTHERWISE SPECIFIED IN LANDSCAPING DETAILS) IN ALL DISTURBED AREAS WHICH ARE NOT TO BE PAVED. SMOOTHLY FINISH GRADE TO MEET SURROUNDING LAWN AREAS AND ENSURE POSITIVE DRAINAGE. STOCKPILED TOPSOIL SHALL BE SCREENED PRIOR TO RESPREADING. TOPSOIL SHALL BE FREE OF SUBSOIL, DEBRIS, BRUSH AND STONES LARGER THAN 1" IN ANY DIMENSION. ROCK HOUNDING IN PLACE WILL NOT BE PERMITTED. ALL EXCESS TOPSOIL SHALL BE LEGALLY DISPOSED OF OFF SITE.
- ELEVATIONS GIVEN ARE AT BOTTOM FACE OF CURB AND/OR FINISHED PAVEMENT GRADE UNLESS OTHERWISE SPECIFIED ON GRADING PLAN. ALL PAVEMENT SHALL BE LAID ON A STRAIGHT, EVEN, AND UNIFORM GRADE WITH A MINIMUM OF 1% SLOPE TOWARD THE COLLECTION POINTS UNLESS OTHERWISE SPECIFIED ON THE GRADING PLAN. DO NOT ALLOW NEGATIVE GRADES OR PONDING OF WATER.
- 10. SLOPE BUILDING SIDEWALK AWAY FROM THE BUILDING AT A MAXIMUM OF 1.5% (UNLESS OTHERWISE INDICATED ON THE GRADING PLAN).
- 11. WHEN CONSTRUCTING ASPHALTIC CONCRETE PAVEMENTS, CONTRACTOR SHALL PROVIDE BUTT END JOINT TO MEET EXISTING PAVEMENT IN ELEVATION AT DRIVE RETURNS AND ENSURE POSITIVE DRAINAGE.

- 1. CONTRACTOR SHALL CONTACT ALL UTILITY COMPANIES IMMEDIATELY AFTER BID IS AWARDED AND ENSURE THE UTILITY COMPANIES HAVE THE ESSENTIALS REQUIRED FOR COMPLETE SERVICE INSTALLATION. CONTRACTOR SHALL NOTIFY CONSTRUCTION MANAGER OF ANY TIME FRAMES ESTABLISHED BY UTILITY COMPANIES WHICH WILL NOT MEET OPENING DATE.
- 2. CONTRACTOR SHALL VERIFY THE SIZE, LOCATION, INVERT ELEVATION, AND CONDITION OF EXISTING UTILITIES WHICH ARE INTENDED TO BE UTILIZED AS A CONNECTION POINT FOR ALL PROPOSED UTILITIES PRIOR TO ANY CONSTRUCTION. CONTRACTOR TO ENSURE EXISTING UTILITIES ARE IN GOOD CONDITION AND FREE FLOWING (IF APPLICABLE). IF ELEVATIONS, SIZE, OR LOCATION DIFFER FROM WHAT IS SHOWN ON PLANS, CONTRACTOR SHALL NOTIFY CONSTRUCTION MANAGER IMMEDIATELY.
- 3. WHERE PLANS PROVIDE FOR PROPOSED WORK TO BE CONNECTED TO, OR CROSS OVER AN EXISTING SEWER OR UNDERGROUND UTILITY, THE CONTRACTOR SHALL LOCATE THE EXISTING PIPES OR UTILITIES BOTH AS TO LINE AND GRADE BEFORE STARTING THE PROPOSED WORK. IF IT IS DETERMINED THAT THE ELEVATION OF THE EXISTING CONDUIT, OR EXISTING APPURTENANCE RESULTS IN A CHANGE IN THE PLAN, THE CONSTRUCTION MANAGER SHALL BE NOTIFIED BEFORE STARTING CONSTRUCTION OF ANY PORTION OF THE PROPOSED WORK WHICH WOULD BE AFFECTED BY THE INTERFERENCE WITH AN EXISTING FACILITY. PAYMENT FOR ALL THE OPERATIONS DESCRIBED ABOVE SHALL BE INCLUDED IN THE CONTRACT PRICE FOR THE PERTINENT ITEM.
- 4. UTILITY SERVICE PROVIDERS RULES AND REQUIREMENTS TAKE PRECEDENCE OVER INFORMATION HEREIN. IF DISCREPANCY ARISES, CONTRACTOR SHALL FULLY COORDINATE WITH UTILITY SERVICE PROVIDER PRIOR TO START OF CONSTRUCTION.

SANITARY SEWER NOTES

- 1. SANITARY SEWER LATERAL INVERT AT BUILDING SHALL BE A MINIMUM OF 6' BELOW FINISH
- 2. CLEAN-OUTS TO BE INSTALLED AT ALL PIPE BENDS AND ANGLES, UNLESS A MANHOLE IS INDICATED.
- 3. THE CONTRACTOR SHALL HIRE A LOCAL PLUMBER LICENSED WITH THE LOCAL SANITARY JURISDICTION TO MAKE ALL CONNECTIONS FROM THE BUILDING TO THE EXISTING SEWER. CONTRACTOR SHALL SECURE A SANITARY SEWER CONNECTION PERMIT PRIOR TO ANY CONSTRUCTION. THE CONTRACTORS PRICE FOR SANITARY SEWER INSTALLATION SHALL INCLUDE ALL FEES AND APPURTENANCES REQUIRED BY THE LOCAL SANITARY JURISDICTION TO PROVIDE A COMPLETE WORKING SERVICE. COORDINATE ALL WORK WITH JOHN SCHNEIDER @ CITY OF ELYRIA, ENGINEERING DEPARTMENT.
- 4. ALL SANITARY PIPE MATERIAL SHALL BE 6" PVC, SDR 35 CONFORMING TO ASTM D 3034, WITH JOINTS PER ASTM 3212 UNLESS OTHERWISE REQUIRED BY THE LOCAL JURISDICTION.

PROPOSED CATCH BASIN PROPOSED DIRECTIONAL



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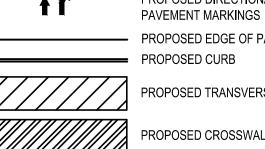
PROPOSED ELECTRIC TRANSFORME

PROPOSED LIGHT POLE PROPOSED WHEEL STOP

PROPOSED CLEAN OUT

PROPOSED EXTERIOR

GREASE INTERCEPTOR



PROPOSED PAINTED ADA SYMBOL

 PROPOSED EDGE OF PAVEMENT PROPOSED CURB

PROPOSED TRANSVERSE STRIPING

PROPOSED CROSSWALK STRIPING

MINIMUM COVER OF 60" OR BELOW FROST LINE, WHICHEVER IS GREATER. 2. CONSTRUCTION AND MATERIALS PROVIDED BY THE WATER COMPANY:

3. CONSTRUCTION AND MATERIALS PROVIDED BY THE CONTRACTOR:

b. FURNISH AND INSTALL CURB STOP & BOX AND WATER METER.

SCHNEIDER @ CITY OF ELYRIA, ENGINEERING DEPARTMENT.

- a. FURNISH AND INSTALL COPPER SERVICE LINE FROM METER TO BUILDING.
- b. ALL TRENCHING AND BACKFILLING.

STORM SEWER NOTES

(OR APPROVED EQUAL).

IN PLANS.

a. TAP MAIN.

WATER NOTES

4. CONTRACTOR SHALL PROVIDE 100% IRRIGATION PER CONSTRUCTION/PROJECT MANAGER AND CITY REQUIREMENTS. COORDINATE SLEEVE LOCATIONS WITH THE CONSTRUCTION/PROJECT MANAGER AND IRRIGATION CONSULTANT PRIOR TO PAVEMENT AND

c. COORDINATE ALL WORK WITH JOHN SCHNEIDER @ CITY OF ELYRIA, ENGINEERING

I. ALL STORM SEWER PIPE 12" OR GREATER IN DIAMETER SHALL BE CORRUGATED HIGH DENSITY

PIPE SHALL CONFORM TO ASTM D 3350 AND JOINTS PER ASTM F477. STORM SEWER LESS

INSTALLATION, PIPE MATERIAL AND TAP CONNECTION. COORDINATE ALL WORK WITH JOHN

3. ALL DRAINAGE STRUCTURES AT PAVEMENT SUMPS SHALL HAVE FINGER DRAINS PER DETAILS

I. WATER SERVICE MATERIALS SHALL BE COPPER TYPE "K" UNLESS OTHERWISE NOTED ON

PLANS. DIAMETER SHALL BE AS NOTED ON THESE PLANS AND SHALL BE INSTALLED WITH A

2. THE CONTRACTOR SHALL BE RESPONSIBLE FOR ALL TRENCHING, BACKFILLING AND PIPE

POLYETHYLENE (HDPE) SMOOTH INTERIOR PIPE (UNLESS OTHERWISE NOTED ON PLAN). HDPE

THAN 12" IN DIAMETER SHALL BE PVC. SDR 35. PER ASTM D 3034 AND JOINTS PER ASTM D 3212

CURB INSTALLATION.

EXISTING GENERAL LEGEND EXISTING IRON PIN FOUND AS NOTED EXISTING IRON PIPE FOUND AS NOTED EXISTING MONUMENT BOX FOUND AS NOTED EXISTING LIGHT POLE EXISTING POWER & TELEPHONE POLE EXISTING POWER, TELEPHONE & LIGHT POLE EXISTING TRANSFORMER EXISTING SIGNAL POLE EXISTING SIGNAL PULL BOX EXISTING CATCH BASIN

EXISTING DOWN SPOUT EXISTING STORM MANHOLE EXISTING SANITARY MANHOLE

EXISTING CURB INLET

EXISTING FIRE HYDRANT EXISTING WATER VALVE

EXISTING GAS SERVICE VALVE EXISTING UNDERGROUND GAS LINE DESIGNATION MARKS PROVIDED BY OTHERS

EXISTING GAS METER

EXISTING TELEPHONE PEDESTAL

EXISTING CLEANOUT

EXISTING POST OR BOLLARD EXISTING SIGN

EXISTING HANDICAP SIGN

EXISTING GUY WIRE EXISTING SOIL BORING

EXISTING CURB — P/L— EXISTING PROPERTY LINE

EXISTING RIGHT OF WAY LINE EXISTING CENTER LINE

— OH — EXISTING OVERHEAD UTILITY LINES — G — EXISTING UNDERGROUND GAS LINES

— ST — EXISTING UNDERGROUND STORM LINES

— SAN — EXISTING UNDERGROUND SANITARY LINES — W — EXISTING UNDERGROUND WATER LINES

EXISTING UNDERGROUND ELECTRIC LINES EXISTING UNDERGROUND TELEPHONE LINES

— FO — EXISTING UNDERGROUND FIBER OPTIC LINES DECIDUOUS TREE

EVERGREEN TREE


EXISTING 10' ELECTRIC EASEMENT.

PROPOSED CONCRETE PROPOSED STANDARD DUTY ASPHALT PROPOSED HEAVY DUTY ASPHALT



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330.572.2100 Fax 330.572.2101

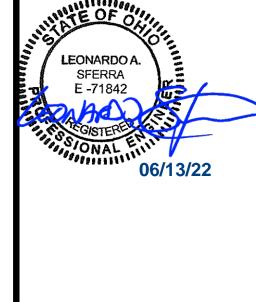

CONTRACT DATE **BUILDING TYPE:**

> STORE NUMBER: 2021088.52 TACO BELL

> > 1551 WEST RIVER ROAD

ELYRIA, OHIO 44035

PLAN VERSION:

SITE NUMBER

BRAND DESIGNER



GENERAL

GENERAL NOTES

- ALL WORK SPECIFIED AS A DEPARTMENT OF TRANSPORTATION ITEM SHALL BE GOVERNED BY THE OHIO DEPARTMENT OF TRANSPORTATION CONSTRUCTION AND MATERIAL SPECIFICATIONS AS WELL AS THE CURRENT EDITION OF THE LOCAL JURISDICTION STORM WATER MANAGEMENT MANUAL. IT IS THE CONTRACTOR'S RESPONSIBILITY TO POSSESS AND TO BE FAMILIAR WITH APPLICABLE SECTIONS.
- 2. THESE CONTRACT DRAWINGS SHALL BE MADE AVAILABLE ON SITE AT ALL TIMES AND PRESENTED UPON REQUEST. IF UNFORESEEN STORM WATER POLLUTION IS ENCOUNTERED, ADDITIONAL STORM WATER POLLUTION PREVENTION (SWPP) MEASURES SHALL BE IMPLEMENTED TO MANAGE THE CURRENT SITE CONDITIONS WHICH MAY BE REQUESTED BY THE OWNER, COUNTY ENGINEER, PROJECT ENGINEER OR SOIL AND WATER CONSERVATION SERVICE REPRESENTATIVE AT ANYTIME. SUCH REQUESTS AND CHANGE IN SITE CONDITIONS SHALL BE IMPLEMENTED IMMEDIATELY AT CONTRACTOR'S EXPENSE.
- 3. ALL STORM WATER POLLUTION PREVENTION PRACTICES SHALL BE INSTALLED BEFORE ANY OTHER EARTH MOVING OCCURS.
- 4. SEDIMENT BARRIERS SHALL BE INSTALLED DOWNSLOPE OF DISTURBED AREAS. SEDIMENT BARRIERS SHALL BE INSTALLED ALONG LEVEL CONTOURS. MAXIMUM CONTRIBUTING DRAINAGE AREA TO SEDIMENT BARRIERS SHALL BE PER THE CURRENT STATE'S EPA OR THE LOCAL AUTHORITY REQUIREMENTS. COMPOSITE FILTER SOCKS USED IN LIEU OF SILT FENCE SHALL BE A MINIMUM OF 12 INCHES IN DIAMETER.
- 5. SILT BARRIERS SHALL BE INSTALLED AROUND ALL EXISTING AND NEW STORM INLETS, CATCH BASINS AND YARD DRAINS. INSTALL ROCK CHECK DAMS FOR HEADWALL INLETS FOR STORM WATER POLLUTION PREVENTION.
- 6. STORM WATER POLLUTION PREVENTION MEASURES SHALL BE INSTALLED AROUND ALL DIRT OR TOPSOIL STOCKPILES AND OTHER TEMPORARILY DISTURBED AREAS AS MAY BE SHOWN ON THESE PLANS AND/OR AS DIRECTED BY THE ENGINEER OR THE LOCAL AUTHORITY HAVING JURISDICTION.
- 7. SILT BARRIERS, CONSTRUCTION ENTRANCES, AND SILT PERIMETER CONTROLS SHALL REMAIN IN PLACE UNTIL A GOOD STAND OF GRASS HAS BEEN OBTAINED AND/OR PAVING OPERATIONS ARE COMPLETE. CONTRACTOR SHALL KEEP SILT FROM ENTERING ANY STORM DRAINAGE SYSTEM. ONCE SITE HAS BEEN COMPLETELY STABILIZED, ANY SILT IN PIPES AND DRAINAGE SWALES SHALL BE REMOVED WITHIN 10 DAYS.
- 8. ALL EXISTING WATER COURSES WITHIN THE PROJECT LIMITS SHALL BE TEMPORARILY PROTECTED DURING LAND CLEARING AND GRADING OPERATIONS. SOILS WITHIN 50 FEET OF SAID WATER COURSES SHALL BE STABILIZED WITHIN 2 DAYS OF THE INITIAL CLEARING / GRADING OPERATION.
- 9. CONSTRUCTION ENTRANCE SHALL BE UTILIZED. IF CONDITIONS ARE SUCH THAT MUD IS COLLECTING ON VEHICLE TIRES, THE TIRES MUST BE CLEANED BEFORE THE VEHICLES ENTER THE PUBLIC ROADWAY. THE SITE ENTRANCE SHALL BE MAINTAINED IN A CONDITION THAT WILL PREVENT THE TRACKING OR FLOW OF MUD ONTO THE PUBLIC RIGHT-OF-WAY. ALL MATERIALS SPILLED, DROPPED, WASHED OR TRACKED FROM VEHICLES ONTO THE ROADWAY MUST BE REMOVED PROMPTLY.
- 10. IF FOR ANY REASON, THE PROJECT IS SUSPENDED, THE CONTRACTOR SHALL ENSURE THAT ALL INSTALLED EROSION MEASURES ARE FUNCTIONING AND PROPERLY MAINTAINED DURING THIS PERIOD, AND THAT ALL BARE SOILS ARE SEEDED AND MULCHED WITH TEMPORARY SEED MIXTURE.
- 11. CONCRETE WASHOUT FACILITY (IF APPLICABLE) SHALL BE CONSTRUCTED IN ACCORDANCE WITH PLAN DETAILS AND LOCAL GOVERNING AUTHORITY REGULATIONS AND INSTRUCTIONS.
- 12. IMPLEMENTATION OF EROSION AND SEDIMENT CONTROLS SHALL CONFORM TO STATE OF OHIO CONSTRUCTION GENERAL PERMIT #OHC000005 AND THE CITY OF ELYRIA CODIFIED ORDINANCES. IF A CONFLICT EXISTS BETWEEN THE TWO REGARDING EROSION AND SEDIMENT CONTROL IMPLEMENTATION, THE MORE RESTRICTIVE SHALL APPLY.
- 13. DISTURBED AREAS WITHIN 50' OF A STREAM SHALL HAVE PERMANENT STABILIZATION APPLIED WITHIN 2 DAYS OF FINAL GRADE.
- 14. DISTURBED AREAS WHICH WILL REMAIN DORMANT FOR OVER 1 YEAR OR ARE AT FINAL GRADE SHALL HAVE PERMANENT STABILIZATION APPLIED WITHIN 7 DAYS OF LAST EARTHWORK DISTURBANCE.

INSPECTION NOTES

- 1. CONTRACTOR SHALL INSPECT ALL SWPP MEASURES DAILY AND LOGGED BY THE CONTRACTOR FOR INSPECTION. LOGGING SHALL BE WEEKLY AND AFTER EVERY 1/2" RAINFALL EVENT. REPAIR AS NECESSARY TO PREVENT EROSION. SILTATION SHALL BE REMOVED FROM AREAS WHERE FAILURES HAVE OCCURRED AND CORRECTIVE ACTION TAKEN WITHIN 24 HOURS TO MAINTAIN ALL SWPP.
- 2. CONTRACTORS INSPECTOR SHALL BE A QUALIFIED INDIVIDUAL. ONLY A QUALIFIED INSPECTION PERSONNEL IS TO PERFORM THE INSPECTIONS. SITE INSPECTIONS SHALL BE DONE WEEKLY AND WITHIN 24 HRS AFTER EVERY RAINFALL EVENT EXCEEDING 1/2" OF RAINFALL. ALL NECESSARY REPAIRS SHOULD BE IMPLEMENTED IMMEDIATELY AFTER SUCH INSPECTIONS.
- 3. CONTRACTOR'S INSPECTOR SHALL BE RESPONSIBLE FOR PREPARING AND SIGNING WEEKLY AND ALL INTERMEDIATE EROSION CONTROL INSPECTION REPORTS AFTER EVERY INSPECTION, WHICH INCLUDE BUT NOT LIMITED TO (DISTURBED AREAS, MATERIAL STORAGE AREAS, EROSION AND SEDIMENT CONTROLS; DISCHARGE LOCATIONS AND VEHICLE ENTRANCE/EXIT LOCATIONS). SUCH REPORTS SHALL BE MADE AVAILABLE TO OWNER, ENGINEER AND CITY / STATE OFFICIALS UPON THEIR REQUEST.
- 4. REPORTS SHALL BE KEPT FOR 3 YEARS AFTER TERMINATION OF THE CONSTRUCTION
- 5. CONTRACTOR MAY SUBMIT A WAIVER REQUEST TO THE LOCAL AND STATE GOVERNING AUTHORITIES FOR A REDUCTION TO MONTHLY INSPECTIONS IF THE SITE WILL BE STABILIZED AND DORMANT FOR A LONG PERIOD. AND/OR THE RUNOFF IS UNLIKELY DUE TO WEATHER CONDITIONS FOR AN EXTENDED PERIOD OF TIME (FROZEN GROUND).
- 6. FOR BMPS THAT REQUIRE REPAIR OR MAINTENANCE NON SEDIMENT POND BMPS ARE TO BE REPAIRED WITHIN 3 DAYS OF INSPECTION AND SEDIMENT PONDS ARE TO BE REPAIRED OR CLEANED OUT WITHIN 10 DAYS OF INSPECTION.
- 7. FOR BMPS THAT DO NOT MEET THE INTENDED FUNCTION, A NEW BMP SHALL BE INSTALLED WITHIN 10 DAYS OF THE INSPECTION.
- 8. FOR MISSING BMPS REQUIRED, THE MISSING BMPS SHALL BE INSTALLED WITHIN 10 DAYS OF THE INSPECTION.

SPILLS AND CONTAMINATION

- 1. CONSTRUCTION PERSONNEL, INCLUDING SUBCONTRACTORS WHO MAY USE OR HANDLE HAZARDOUS OR TOXIC MATERIALS, SHALL BE MADE AWARE OF THE FOLLOWING GENERAL GUIDELINES REGARDING DISPOSAL AND HANDLING OF HAZARDOUS AND CONSTRUCTION
- a. PREVENT SPILLS
- a. USE PRODUCTS UP
- FOLLOW LABEL DIRECTIONS FOR DISPOSAL
- REMOVE LIDS FROM EMPTY BOTTLES AND CANS WHEN DISPOSING IN TRASH RECYCLE WASTES WHENEVER POSSIBLE
- DON'T POUR INTO WATERWAYS, STORM DRAINS OR ONTO THE GROUND
- DON'T POUR DOWN THE SINK, DOOR DRAIN OR SEPTIC TANKS
- DON'T BURY CHEMICALS OR CONTAINERS
- DON'T BURN CHEMICALS OR CONTAINERS DON'T MIX CHEMICALS TOGETHER
- 2. ANY DISCHARGE OF PETROLEUM OR PETROLEUM PRODUCTS OF LESS THAN 25 GALLONS ONTO A PERVIOUS SURFACE SHALL BE LEGALLY REMOVED AND PROPERLY TREATED OR PROPERLY DISPOSED OF, OR OTHERWISE REMEDIATED, SO THAT NO CONTAMINATION FROM THE DISCHARGE REMAINS ON-SITE. SPILLS OF 25 GALLONS OR MORE OF PETROLEUM PRODUCTS SHALL BE REPORTED TO THE OHIO'S EPA. THE LOCAL FIRE DEPARTMENT, AND THE LOCAL EMERGENCY PLANNING COMMITTEE WITHIN 30 MINUTES OF THE DISCOVERY OF THE RELEASE. ALL SPILLS WHICH CONTACT WATERS OF THE STATE MUST BE REPORTED TO THE CURRENT STATE'S EPA.
- 3. SPILL REPORTING REQUIREMENTS: SPILLS ON PAVEMENT SHALL BE ABSORBED WITH SAWDUST OR KITTY LITTER AND DISPOSED OF WITH THE TRASH AT A LICENSED SANITARY LAND FILL. HAZARDOUS OR INDUSTRIAL WASTES SUCH AS MOST SOLVENTS, GASOLINE, OIL-BASED PAINTS, AND CEMENT CURING COMPOUNDS REQUIRE SPECIAL HANDLING. SPILLS SHALL BE REPORTED TO THE OHIO'S EPA.
- 4. CONTAINERS SHALL BE PROVIDED FOR THE PROPER COLLECTION OF ALL WASTE MATERIAL INCLUDING CONSTRUCTION DEBRIS, TRASH, PETROLEUM PRODUCTS AND ANY HAZARDOUS MATERIALS USED ON-SITE. CONTAINERS SHALL BE COVERED AND NOT LEAKING. ALL WASTE MATERIAL SHALL BE DISPOSED OF AT FACILITIES APPROVED FOR THAT MATERIAL. CONSTRUCTION DEMOLITION AND DEBRIS (CD&D) WASTE MUST BE DISPOSED OF AT THE OHIO'S EPA APPROVED CD&D LAND FILL.
- 5. PROCESS WASTE WATER/LEACHATE MANAGEMENT: EPA'S CONSTRUCTION GENERAL PERMIT ONLY ALLOWS THE DISCHARGE OF STORM WATER AND DOES NOT INCLUDE OTHER WASTE STREAMS/DISCHARGES SUCH AS VEHICLE AND/OR EQUIPMENT WASHING, ON-SITE SEPTIC LEACHATE CONCRETE WASH OUTS, WHICH ARE CONSIDERED PROCESS WASTEWATERS. ALL PROCESS WASTEWATERS MUST BE COLLECTED AND PROPERLY DISPOSED AT AN APPROVED DISPOSAL FACILITY. IN THE EVENT, LEACHATE OR SEPTAGE IS DISCHARGED; IT MUST BE ISOLATED FOR COLLECTION AND PROPER DISPOSAL AND CORRECTIVE ACTIONS TAKEN TO ELIMINATE THE SOURCE OF WASTE WATER.
- 6. WASTES GENERATED BY CONSTRUCTION ACTIVITIES (I.E. CONSTRUCTION MATERIALS SUCH AS PAINTS, SOLVENTS, FUELS, CONCRETE, WOOD, ETC) MUST BE DISPOSED OF IN ACCORDANCE WITH LOCAL REGULATIONS. HAZARDOUS AND TOXIC SUBSTANCES ARE USED ON VIRTUALLY ALL CONSTRUCTION SITES. GOOD MANAGEMENT OF THESE SUBSTANCES IS ALWAYS NEEDED.
- 7. NO CONSTRUCTION RELATED WASTE MATERIALS ARE TO BE BURIED OR BURNED ON-SITE.
- 8. HANDLING CONSTRUCTION CHEMICALS: MIXING, PUMPING, TRANSFERRING OR OTHER HANDLING OF CONSTRUCTION CHEMICALS SUCH AS FERTILIZER, LIME, ASPHALT, CONCRETE DRYING COMPOUNDS, AND ALL OTHER POTENTIALLY HAZARDOUS MATERIALS SHALL BE PERFORMED IN AN AREA AWAY FROM ANY WATERCOURSE, DITCH OR STORM DRAIN.
- 9. EQUIPMENT FUELING AND MAINTENANCE, OIL CHANGING, ETC., SHALL BE PERFORMED AWAY FROM WATERCOURSES, DITCHES OR STORM DRAINS, IN AN AREA DESIGNATED FOR THAT PURPOSE. THE DESIGNATED AREA SHALL BE EQUIPPED FOR RECYCLING OIL AND CATCHING SPILLS, SECONDARY CONTAINMENT SHALL BE PROVIDED FOR ALL FUEL OIL STORAGE TANKS. THESE AREAS MUST BE INSPECTED EVERY SEVEN DAYS AND WITHIN 24 HRS. OF A 0.5 INCH OR GREATER RAIN EVENT TO ENSURE THERE ARE NO EXPOSED MATERIALS WHICH WOULD CONTAMINATE STORM WATER. SITE OPERATORS MUST BE AWARE THAT SPILL PREVENTION CONTROL AND COUNTERMEASURES (SPCC) REQUIREMENTS MAY APPLY. AN SPCC PLAN IS REQUIRED FOR SITES WITH ONE SINGLE ABOVE GROUND TANK OF 660 GALLONS OR MORE, ACCUMULATIVE ABOVE GROUND STORAGE OF 1330 GALLONS OR MORE, OR 42,000 GALLONS OF UNDERGROUND STORAGE. CONTAMINATED SOILS MUST BE PROPERLY DISPOSED OF IN ACCORDANCE WITH LOCAL GOVERNING AUTHORITY REGULATIONS. SPCC PLAN AND APPROVALS ARE THE RESPONSIBILITY OF THE CONTRACTOR.
- 10. CONTAMINATED SOILS: IF SUBSTANCES SUCH AS OIL, DIESEL FUEL, HYDRAULIC FLUID, ANTIFREEZE, ETC. ARE SPILLED, LEAKED, OR RELEASED ONTO THE SOIL, THE SOIL SHOULD BE DUG UP AND DISPOSED OF AT LICENSED SANITARY LAND FILL OR OTHER APPROVED PETROLEUM CONTAMINATED SOIL REMEDIATION FACILITY (NOT A CONSTRUCTION / DEMOLITION DEBRIS LAND FILL). NOTE THOSE STORM WATER RUNOFFS ASSOCIATED WITH CONTAMINATED SOILS ARE NOT BE AUTHORIZED UNDER CURRENT REGULATIONS OF CONSTRUCTION ACTIVITIES.
- 11. CONTRACTOR SHALL TAKE PREVENTIVE MEASURES FOR WATER DISCHARGES FROM CONTAMINATED SOILS BY ANY MEANS POSSIBLE, INCLUDING THE FOLLOWING: 11.1. THE USE OF BERMS, TRENCHES, AND PITS TO COLLECT CONTAMINATED RUNOFF AND
- PREVENT DISCHARGES. 11.2. PUMPING RUNOFF INTO A SANITARY SEWER (WITH PRIOR WRITTEN APPROVAL OF THE SANITARY SEWER SERVICE OPERATOR) OR INTO A CONTAINER FOR TRANSPORT TO AN APPROPRIATE TREATMENT/DISPOSAL FACILITY.
- 11.3. COVERING AREAS OF CONTAMINATION WITH TARPS OR OTHER METHODS THAT PREVENT STORMWATER FROM COMING INTO CONTACT WITH CONTAMINATED MATERIALS.

TEMPORARY SEEDING

- 1. STRUCTURAL EROSION AND SEDIMENT CONTROL PRACTICES SUCH AS DIVERSIONS AND SEDIMENT TRAPS SHALL BE INSTALLED AND STABILIZED WITH TEMPORARY SEEDING PRIOR TO GRADING THE REST OF THE CONSTRUCTION SITE.
- 2. TEMPORARY SEEDING / STABILIZATION SHALL BE APPLIED WITHIN THE FOLLOWING TIME FRAMES FOR VARIOUS AREAS OF THE SITE:
- 2.1. ANY DISTURBED AREA WITHIN 50 FEET OF A WATERCOURSE AND NOT AT FINAL GRADE SHALL BE SEEDED AND MULCHED WITHIN 2 DAYS OF THE MOST RECENT DISTURBANCE, IF THAT AREA WILL REMAIN IDLE FOR MORE THAN 14 DAYS.
- 2.2. ALL CONSTRUCTION ACTIVITIES IN ANY DISTURBED AREA, INCLUDING SOIL STOCKPILES THAT WILL BE IDLE FOR MORE THAN 14 DAYS BUT LESS THAN ONE YEAR, AND NOT WITHIN 50 FEET OF A WATERCOURSE SHALL BE SEEDED AND MULCHED WITHIN 7 DAYS OF THE MOST RECENT DISTURBANCE IN THE AREA.
- 2.3. DISTURBED AREAS THAT WILL BE IDLE OVER THE WINTER SHALL BE SEEDED AND MULCHED PRIOR TO NOVEMBER 1.
- 3. THE SEED BED SHOULD BE PULVERIZED AND LOOSE TO ENSURE THE SUCCESS OF ESTABLISHING VEGETATION. TEMPORARY SEEDING SHOULD NOT BE POSTPONED IF IDEAL SEED BED PREPARATION IS NOT POSSIBLE.
- 4. TEMPORARY VEGETATION SEEDING RATES SHALL ESTABLISH ADEQUATE STANDS OF VEGETATION, WHICH MAY REQUIRE USE OF SOIL AMENDMENTS. BASE RATES FOR LIME AND FERTILIZER SHALL BE USED.
- 5. ALL SEED MIXES AND SEEDING RATES USED SHALL BE APPROVED BY THE LOCAL GOVERNING AUTHORITY AND THE OWNER.
- 6. SEED SHALL BE APPLIED UNIFORMLY WITH A CYCLONE SPREADER, DRILL, CULTIPACKER, SEEDER, OR HYDROSEEDER. WHEN FEASIBLE, SEED THAT HAS BEEN BROADCAST SHALL BE COVERED BY RAKING OR DRAGGING AND THEN LIGHTLY TAMPED INTO PLACE USING A ROLLER OR CULTIPACKER. IF HYDROSEEDING IS USED, THE SEED AND FERTILIZER WILL BE MIXED ON-SITE AND THE SEEDING SHALL BE DONE IMMEDIATELY AND WITHOUT INTERRUPTION.
- 7. APPLICATIONS OF TEMPORARY SEEDING SHALL INCLUDE MULCH, WHICH SHALL BE APPLIED DURING OR IMMEDIATELY AFTER SEEDING. SEEDINGS MADE DURING OPTIMUM SEEDING DATES ON FAVORABLE, VERY FLAT SOIL CONDITIONS MAY NOT NEED MULCH TO ACHIEVE ADEQUATE STABILIZATION. IF MULCH IS USED, FOLLOW THE REQUIREMENTS AND INSTRUCTIONS IN THE MULCH APPLICATION.

1. MULCH AND OTHER APPROPRIATE VEGETATIVE PRACTICES SHALL BE APPLIED TO DISTURBED AREAS WITHIN 7 DAYS OF GRADING IF THE AREA IS TO REMAIN DORMANT (UNDISTURBED) FOR MORE THAN 21 DAYS OR ON AREAS AND PORTIONS OF THE SITE WHICH CAN BE BROUGHT TO FINAL GRADE.

2. MULCH SHALL CONSIST OF ONE OF THE FOLLOWING:


- 2.1. STRAW SHALL BE UNROTTED SMALL GRAIN STRAW APPLIED AT THE RATE OF 2 TONS/AC. OR 90 LB./1,000 SQ. FT. (TWO TO THREE BALES) THE STRAW MULCH SHALL BE SPREAD UNIFORMLY BY HAND OR MECHANICALLY SO THE SOIL SURFACE IS COVERED. FOR UNIFORM DISTRIBUTION OF HAND-SPREAD MULCH, DIVIDE AREA INTO APPROXIMATELY 1,000 SQ. FT. SECTIONS AND PLACE TWO 45-LB BALES OF STRAW IN EACH SECTION.
- WOOD CELLULOSE FIBER SHOULD BE USED AT 2,000 LB.AC, OR 46 LB/1,000 SQ. FT. 2.3. ACCEPTABLE MULCHES INCLUDE MULCH MATTINGS AND ROLLED EROSION CONTROL
- PRODUCTS APPLIED ACCORDING TO MANUFACTURER'S RECOMMENDATIONS OR WOOD MULCH/CHIPS APPLIED AT 10-20 TONS/AC.
- 3. MULCH SHALL BE ANCHORED IMMEDIATELY TO MINIMIZE LOSS BY WIND OR RUNOFF. THE FOLLOWING ARE ACCEPTABLE METHODS FOR ANCHORING MULCH.
- 3.1. USE A DISK, CRIMPER, OR SIMILAR TYPE TOOL SET STRAIGHT TO PUNCH OR ANCHOR THE MULCH MATERIAL INTO THE SOIL. STRAW MECHANICALLY ANCHORED SHALL NOT BE FINELY CHOPPED BUT BE LEFT GENERALLY LONGER THAN 6 INCHES.
- USE MULCH NETTINGS ACCORDING TO THE MANUFACTURER'S RECOMMENDATIONS FOLLOWING ALL PLACEMENT AND ANCHORING REQUIREMENTS. USE IN AREAS OF WATER CONCENTRATION AND STEEP SLOPES TO HOLD MULCH IN PLACE.
- FOR STRAW MULCH, SYNTHETIC BINDERS SUCH AS ACRYLIC DLR (AGRI-TAC), DCA-70, PETROSET. TERRA TACK OR EQUAL MAY BE USED AT RATES RECOMMENDED BY THE MANUFACTURER. ALL APPLICATIONS OF SYNTHETIC BINDERS MUST BE CONDUCTED IN SUCH A MANNER WHERE THERE IS NO CONTACT WITH WATERS OF THE STATE.
- WOOD CELLULOSE FIBER MAY BE USED FOR ANCHORING STRAW. THE FIBER BINDER SHALL BE APPLIED AT A NET DRY WEIGHT OF 750 LB/AC. THE WOOD CELLULOSE FIBER SHALL BE MIXED WITH WATER AND THE MIXTURE SHALL CONTAIN A MAXIMUM OF 50 LB/100 GAL. OF WOOD CELLULOSE FIBER.


DUST CONTROL NOTES

- 1. DUST CONTROL SHALL BE MAINTAINED THROUGHOUT CONSTRUCTION. IF POSSIBLE GRADING SHALL BE DONE BY PHASING IN ORDER TO MINIMIZE THE AMOUNT OF LAND DISTURBANCE AT ONE TIME. IF PHASING IS NOT AN OPTION. DUST SHALL BE CONTROLLED WITH WATER DURING EARTHWORK OPERATIONS. AFTER EARTHWORK OPERATIONS, THE EXPOSED SOILS SHALL BE COVERED WITH STRAW OR MULCH UNTIL SEEDED.
- 2. DUST CONTROL OR DUST SUPPRESSANTS MAY BE USED TO PREVENT NUISANCE CONDITIONS WHEN APPROVED BY THE LOCAL AUTHORITY HAVING JURISDICTION. WHEN USED, SUPPRESSANTS SHALL BE APPLIED IN ACCORDANCE WITH THE MANUFACTURER'S SPECIFICATIONS AND IN A MANNER, WHICH PREVENTS A DISCHARGE TO WATERS OF THE STATE. SUFFICIENT DISTANCE MUST BE PROVIDED BETWEEN APPLICATIONS AND NEARBY BRIDGES, CATCH BASINS, AND OTHER WATERWAYS. APPLICATION (EXCLUDING WATER) MAY NOT OCCUR WHEN RAIN IS IMMINENT AS NOTED IN THE SHORT TERM FORECAST. OIL MAY NOT BE APPLIED FOR DUST CONTROL.
- 3. SUGGESTED METHODS OF CONSTRUCTION DUST CONTROL MAY INCLUDE THE FOLLOWING: 3.1. CONSTRUCTION SEQUENCING AND DISTURBING ONLY SMALL AREAS AT A TIME CAN GREATLY REDUCE PROBLEMATIC DUST FROM THE SITE. IF LAND MUST BE DISTURBED, ADDITIONAL TEMPORARY STABILIZATION MEASURES SHOULD BE CONSIDERED PRIOR TO DISTURBANCES.
- 3.2. APPLY TEMPORARY OR PERMANENT SEEDING AND MULCH TO AREAS THAT WILL REMAIN IDLE FOR OVER 14 DAYS. SAVING EXISTING TREES AND LARGE SHRUBS WILL ALSO REDUSE SOIL AND AIR MOVEMENT ACROSS DISTURBED AREAS.
- 3.3. SPRAY DISTURBED SITE WITH WATER UNTIL THE SURFACE IS WET BEFORE AND DURING GRADING AND REPEAT AS NEEDED, ESPECIALLY ON HAUL ROADS AND OTHER HEAVY TRAFFIC ROUTES. WATERING SHALL BE DONE AT A RATE THAT PREVENTS DUST BUT DOES NOT CAUSE SOIL EROSION. WETTING AGENTS MAY BE UTILIZED ACCORDING TO MANUFACTURERS INSTRUCTIONS.
- 3.4. GRADED ROADWAYS AND OTHER SUITABLE AREAS MAY BE STABALIZED USING CRUSHED STONE OR COARSE GRAVEL AS SOON AS PRACTICABLE AFTER REACHING AN INTERIM OR FINAL GRADE. CRUSHED STONE OR COARSE GRAVEL CAN BE USED AS A PERMANENT COVER TO PROVIDE CONTROL OF SOIL EMISSIONS.
- 3.5. EXISTING WINDBREAK VEGETATION SHALL BE MARKED AND PRESERVED TO THE EXTENT POSSIBLE. SNOW FENCING OR OTHER SUITABLE BARRIER MAY BE PLACED PERPENDICULAR TO PREVAILING AIR CURRENTS AT INTERVALS OF ABOUT 15 TIMES THE BARRIER HEIGHTS TO CONTROL AIR CURRENTS AND BLOWING SOIL.
- 3.6. WHEN TEMPORARY DUST CONTROL MEASURES ARE USED; REPETITIVE TREATMENT SHOULD BE APPLIED AS NEED TO ACCOMPLISH SATISFACTORY CONTROL.
- 3.7. PAVED AREAS THAT HAVE ACCUMULATED SEDIMENT FROM CONSTRUCTION SHOULD BE CLEANED DAILY, OR AS NEEDED, UTILIZING A STREET SWEEPER OR BUCKET-TYPE ENDLOADER OR SCRAPER.



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TACO BELL

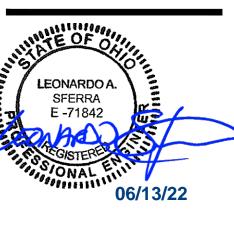
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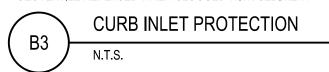
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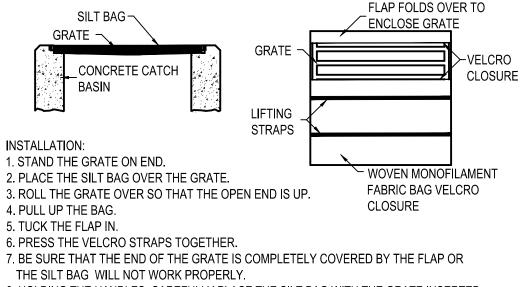
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- INLET PROTECTION SHALL BE CONSTRUCTED EITHER BEFORE UPSLOPE LAND DISTURBANCE BEGINS OR BEFORE THE INLET BECOMES FUNCTIONAL.
- CONSTRUCT A WOODEN FRAME OF 2-BY-4-IN. CONSTRUCTION-GRADE LUMBER. THE END SPACERS SHALL BE A MINIMUM OF 1 FT. BEYOND BOTH ENDS OF THE THROAT OPENING. THE ANCHORS SHALL BE NAILED TO 2-BY-4-IN. STAKES DRIVEN ON THE OPPOSITE SIDE OF THE CURB.
- 3. THE WIRE MESH SHALL BE OF SUFFICIENT STRENGTH TO SUPPORT FABRIC AND STONE. IT SHALL BE A CONTINUOUS PIECE WITH A MINIMUM WIDTH OF 30 IN. AND 4 FT. LONGER THAN THE THROAT LENGTH OF THE INLET, 2 FT. ON EACH SIDE.
- GEOTEXTILE CLOTH SHALL HAVE AN EQUIVALENT OPENING SIZE (EOS) OF 20-40 SIEVE AND BE
- RESISTANT TO SUNLIGHT. IT SHALL BE AT LEAST THE SAME SIZE AS THE WIRE MESH. THE WIRE MESH AND GEOTEXTILE CLOTH SHALL BE FORMED TO THE CONCRETE GUTTER AND AGAINST THE FACE OF THE CURB ON BOTH SIDES OF THE INLET AND SECURELY FASTENED TO THE 2-BY-4-IN FRAME.
- TWO-INCH STONE SHALL BE PLACED OVER THE WIRE MESH AND GEOTEXTILE IN SUCH A MANNER AS TO PREVENT WATER FROM ENTERING THE INLET UNDER OR AROUND THE GEOTEXTILE CLOTH.
- THIS TYPE OF PROTECTION MUST BE INSPECTED FREQUENTLY AND THE STONE AND/OR GEOTEXTILE REPLACED WHEN CLOGGED WITH SEDIMENT.

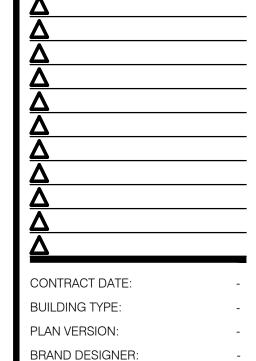



6. PRESS THE VELCRO STRAPS TOGETHER. 7. BE SURE THAT THE END OF THE GRATE IS COMPLETELY COVERED BY THE FLAP OR


8. HOLDING THE HANDLES, CAREFULLY PLACE THE SILT BAG WITH THE GRATE INSERTED INTO THE CATCH BASIN FRAME.

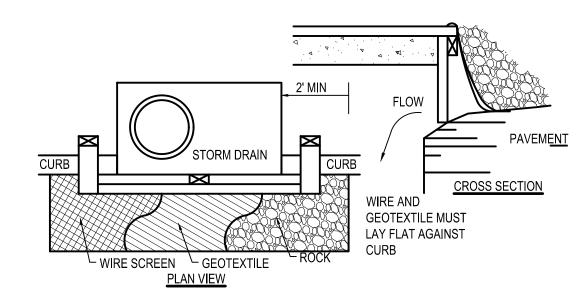TO ENSURE PROPER OPERATION REMOVE SILT, SEDIMENT, AND DEBRIS FROM THE SURFACE AND THE VICINITY OF THE UNIT WITH A SQUARE POINT SHOVEL OR STIFF BRISTLE BROOM AWAY FROM ENVIRONMENTALLY SENSITIVE AREAS AND WATERWAYS IN MANNER SATISFACTORY TO THE ENGINEER/INSPECTOR. REMOVE FINE MATERIAL FROM INSIDE SILT BAG AS NEEDED. DISPOSE OF SILT BAG NO LONGER IN USE AT AN APPROPRIATE RECYCLING OR SOLID WASTE FACILITY.

MAINTENANCE:


TO INSPECT INLET, REMOVE SILT BAG WITH GRATE INSIDE, INSPECT CATCH BASIN AND REPLACE SILT BAG BACK INTO GRATE FRAME.

PONDING IS LIKELY IF SEDIMENT IS NOT REMOVED REGULARLY. THE SILT BAG MUST NEVER BE USED WHERE OVERFLOW MAY ENDANGER AN EXPOSED SLOPE.

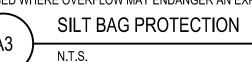


CONSTRUCTION ENTRANCE NOTES

- 1. STONE SIZE NO. 2 STONE SHALL BE USED, OR RECYCLED CONCRETE EQUIVALENT.
- 2. THE CONSTRUCTION ENTRANCE SHALL COINCIDE WITH THE PROPOSED DRIVE AS SHOWN ON THE PLAN.
- 3. PAVEMENT THICKNESS STONE LAYER SHALL BE 6" THICK FOR STANDARD DUTY ACTIVITY AND 10" THICK FOR HEAVY DUTY ACTIVITY.
- 4. DRIVEWAY WIDTH THE ENTRANCE SHALL BE AT LEAST 20' WIDE. CONTRACTOR SHALL ENSURE ALL VEHICLES UTILIZE THE CONSTRUCTION ENTRANCE UNTIL PAVEMENT IS IN
- 5. BEDDING-A GEOTEXTILE SHALL BE PLACED OVER THE ENTIRE AREA PRIOR TO PLACING STONE. IT SHALL BE COMPOSED OF STRONG ROT-PROOF POLYMERIC FIBERS AND MEET THE SPECIFICATIONS SHOWN BELOW.
- 6. CULVERT-A PIPE OR CULVERT SHALL BE CONSTRUCTED UNDER THE ENTRANCE IF NEEDED TO PREVENT SURFACE WATER FLOWING ACROSS THE ENTRANCE OR TO PREVENT RUNOFF FROM BEING DIRECTED OUT ONTO PAVED SURFACES.
- 7. WATER BAR A WATER BAR SHALL BE CONSTRUCTED AS PART OF THE CONSTRUCTION ENTRANCE IF NEEDED TO PREVENT SURFACE RUNOFF FROM FLOWING THE LENGTH OF THE CONSTRUCTION ENTRANCE AND OUT ONTO PAVED SURFACES.
- 8. MAINTENANCE TOP DRESSING OF ADDITIONAL STONE SHALL BE APPLIED AS CONDITIONS DEMAND, MUD SPILLED, DROPPED, WASHED OR TRACKED ONTO PUBLIC ROADS, OR ANY SURFACE WHERE RUNOFF IS NOT CHECKED BY SEDIMENT CONTROLS, SHALL BE REMOVED IMMEDIATELY. REMOVAL SHALL BE ACCOMPLISHED BY SCRAPING OR SWEEPING.
- 9. CONSTRUCTION ENTRANCES SHALL NOT BE RELIED UPON TO REMOVE MUD FROM VEHICLES AND PREVENT OFF SITE TRACKING. VEHICLES THAT ENTER AND LEAVE THE CONSTRUCTION SHALL BE RESTRICTED FROM MUDDY AREAS.
- 10. THE ENTRANCE SHALL REMAIN IN PLACE UNTIL THE DISTURBED AREA IS STABILIZED OR REPLACED WITH A PERMANENT ROADWAY OR ENTRANCE.

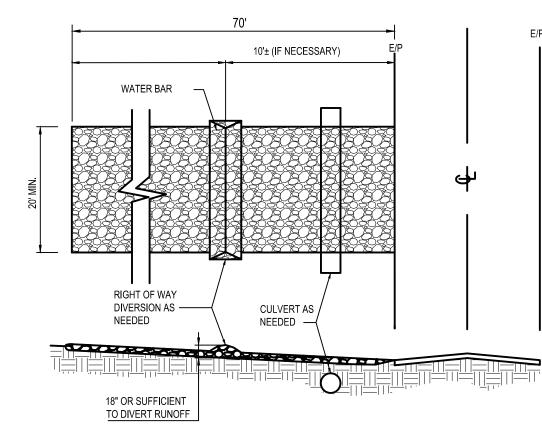




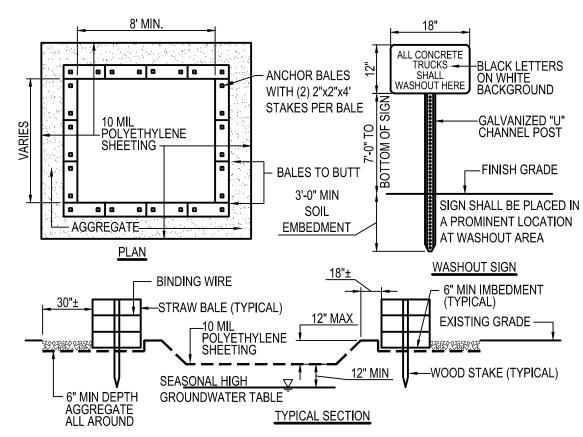

CONTAINMENT MUST BE STRUCTURALLY SOUND AND LEAK FREE AND CONTAIN ALL LIQUID WASTES.

- 2. CONTAINMENT DEVICES MUST BE OF SUFFICIENT QUANTITY OR VOLUME TO COMPLETELY CONTAIN
- THE LIQUID WASTES GENERATED. 3. WASHOUT MUST BE CLEANED OR NEW FACILITIES CONSTRUCTED AND READY TO USE ONCE
- 4. WASHOUT AREA(S) SHALL BE INSTALLED IN A LOCATION EASILY ACCESSIBLE BY CONCRETE TRUCKS 5. ONE OR MORE AREAS MAY BE INSTALLED ON THE CONSTRUCTION SITE AND MAY BE RELOCATED AS CONSTRUCTION PROGRESSES.
- 6. AT LEAST WEEKLY REMOVE ACCUMULATION OF SAND AND AGGREGATE AND DISPOSE OF PROPERLY.

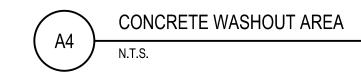

1) SILT FENCE SHALL BE CONSTRUCTED BEFORE UPSLOPE LAND DISTURBANCE BEGINS.

2) ALL SILT FENCE SHALL BE PLACED AS CLOSE TO THE CONTOUR AS POSSIBLE SO THAT WATER WILL NOT CONCENTRATE AT LOW POINTS IN THE FENCE AND SO THAT SMALL SWALES OR DEPRESSIONS WHICH MAY CARRY SMALL CONCENTRATED FLOWS TO THE SILT FENCE ARE DISSIPATED ALONG ITS LENGTH.

3) TO PREVENT WATER PONDED BY THE SILT FENCE FROM FLOWING AROUND THE ENDS, EACH END SHALL BE CONSTRUCTED UPSLOPE SO THAT THE ENDS ARE AT A HIGHER ELEVATION.

4) WHERE POSSIBLE, SILT FENCE SHALL BE PLACED ON THE FLATTEST AREA AVAILABLE.

5) WHERE POSSIBLE, VEGETATION SHALL BE PRESERVED FOR 5 FT. (OR AS MUCH AS POSSIBLE) UPSLOPE FROM THE SILT FENCE. IF VEGETATION IS REMOVED, IT SHALL BE REESTABLISHED WITHIN 7 DAYS FROM THE INSTALLATION OF THE SILT FENCE.

6) THE HEIGHT OF THE SILT FENCE SHALL BE A MINIMUM OF 16 IN. ABOVE THE ORIGINAL GROUND SURFACE.

7) THE FILTER FABRIC SHALL BE PURCHASED IN A CONTINUOUS ROLL CUT TO THE LENGTH OF THE BARRIER TO AVOID THE USE OF JOINTS. WHEN JOINTS ARE NECESSARY, FILTER CLOTH SHALL BE SPLICED TOGETHER ONLY AT A SUPPORT POST, WITH A MINIMUM 6 INCH OVERLAP, AND SECURELY SEALED.

8) POSTS SHALL BE A MINIMUM OF 5 FEET LONG, 2 INCHES IN DIAMETER AND SPACED A MAXIMUM OF 10 FEET APART AT THE BARRIER LOCATION AND DRIVEN SECURELY INTO THE GROUND. WHEN EXTRA STRENGTH FABRIC IS USED WITHOUT THE WIRE SUPPORT FENCE, POST SPACING SHALL NOT EXCEED 6 FEET.

9) THE SILT FENCE SHALL BE PLACED IN A TRENCH CUT A MINIMUM OF 6 INCHES DEEP. THE TRENCH SHALL BE CUT WITH A TRENCHER, CABLE LAYING MACHINE, OR OTHER SUITABLE DEVICE WHICH WILL ENSURE AN ADEQUATELY UNIFORM TRENCH DEPTH.

10) THE SILT FENCE SHALL BE PLACED WITH THE STAKES ON THE DOWNSLOPE SIDE OF THE GEOTEXTILE AND SO THAT 8 IN. OF CLOTH ARE BELOW THE GROUND SURFACE. EXCESS MATERIAL SHALL LAY ON THE BOTTOM OF THE 6 IN. DEEP TRENCH. THE TRENCH SHALL BE BACKFILLED AND COMPACTED.

11) WHEN EXTRA STRENGTH FILTER FABRIC AND CLOSER POST SPACING ARE USED. THE WIRE MESH SUPPORT FENCE MAY BE ELIMINATED. IN SUCH A CASE, THE FILTER FABRIC IS STAPLED OR WIRED DIRECTLY TO THE POSTS.


12) THE STANDARD STRENGTH FILTER FABRIC SHALL BE STAPLED OR WIRED TO THE FENCE, AND 8 INCHES OF THE FABRIC SHALL BE EXTENDED INTO THE TRENCH. THE FABRIC SHALL NOT EXTEND MORE THAN 36 INCHES ABOVE THE ORIGINAL GROUND SURFACE. FILTER FABRIC SHALL NOT BE STAPLED TO EXISTING TREES.

13) SEAMS BETWEEN SECTION OF SILT FENCE SHALL BE OVERLAPPED WITH THE END STAKES OF EACH SECTION WRAPPED TOGETHER BEFORE DRIVING INTO THE GROUND.

14) SILT FENCE SHALL ALLOW RUNOFF TO PASS ONLY AS DIFFUSE FLOW THROUGH THE GEOTEXTILE. IF RUNOFF OVERTOPS THE SILT FENCE, FLOWS UNDER OR AROUND THE ENDS, OR IN ANY OTHER WAY BECOMES A CONCENTRATED FLOW, ONE OF THE FOLLOWING SHALL BE PERFORMED, AS APPROPRIATE: A) THE LAYOUT OF THE SILT FENCE SHALL BE CHANGED, B) ACCUMULATED SEDIMENT SHALL BE REMOVED, OR C) OTHER PRACTICES SHALL BE INSTALLED.

MAINTENANCE:

SILT FENCE SHOULD BE INSPECTED REGULARLY AND FREQUENTLY AS WELL AS AFTER EACH RAINFALL EVENT TO ENSURE THAT THEY ARE INTACT AND THERE ARE NO GAPS AT THE FENCE-GROUND INTERFACE OR TEARS ALONG THE LENGTH OF THE FENCE. IF GAPS OR TEARS ARE FOUND, THEY SHOULD BE REPAIRED OR THE FABRIC REPLACED IMMEDIATELY. ACCUMULATED SEDIMENTS SHOULD BE REMOVED FROM THE FENCE BASE WHEN THE SEDIMENT REACHES ONE-THIRD TO ONE-HALF THE HEIGHT OF THE FENCE. SEDIMENT REMOVAL SHOULD OCCUR MORE FREQUENTLY IF ACCUMULATED SEDIMENT IS CREATING NOTICEABLE STRAIN ON THE FABRIC AND THERE IS THE POSSIBILITY OF THE FENCE FAILING FROM A SUDDEN STORM EVENT. WHEN THE SILT FENCE IS REMOVED, THE ACCUMULATED SEDIMENT SHOULD BE REMOVED.

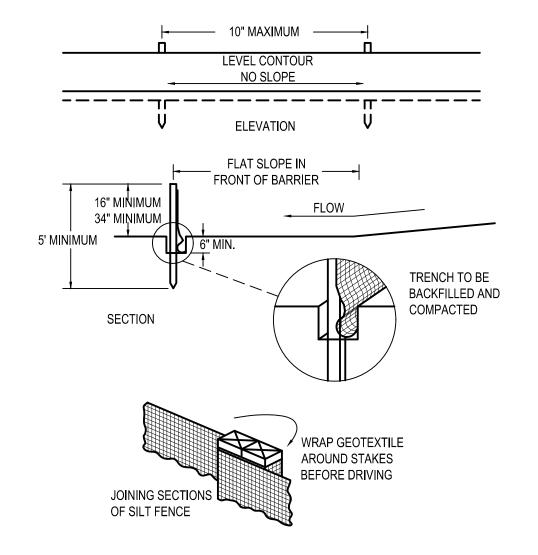

CRITERIA FOR GEOTEXTILE FABRIC SILT FENCE, PER CURRENT STATE'S DOT SPECIFICATIONS

CRITERIA FOR GEOTEXTILE FABRIC SILT FENCE, PER CURRENT STATES DOT SPECIFICATI		
FABRIC PROPERTIES	VALUES	TEST METHOD
MINIMUM TENSILE STRENGTH	120 LB. MINIMUM	ASTM D 4632
MINIMUM BURST STRENGTH	200 PSI MINIMUM	
MINIMUM PERMITTIVITY	1x10-2sec-1	ASTM D 4491
APPARENT OPENING SIZE	AOS ≤ 0.84 mm	ASTM D 4751
UV EXPOSURE STRENGTH RETENTION	70%	ASTM G 4335
MAXIMUM ELONGATION AT 60 LBS.	50%	ASTM D 4632
MINIMUM PUNCTURE STRENGTH	50 LBS (220N)	ASTM D 4833
MINIMUM TEAR STRENGTH	40 LBS (180N)	ASTM D 4533





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CONTRACT DATE

BUILDING TYPE:

PLAN VERSION:

SITE NUMBER:

BRAND DESIGNER:

STORE NUMBER:

TACO BELL

1551 WEST RIVER ROAD


ELYRIA, OHIO 44035

ENDEAVOR

SWPP

DETAILS

2021088.52

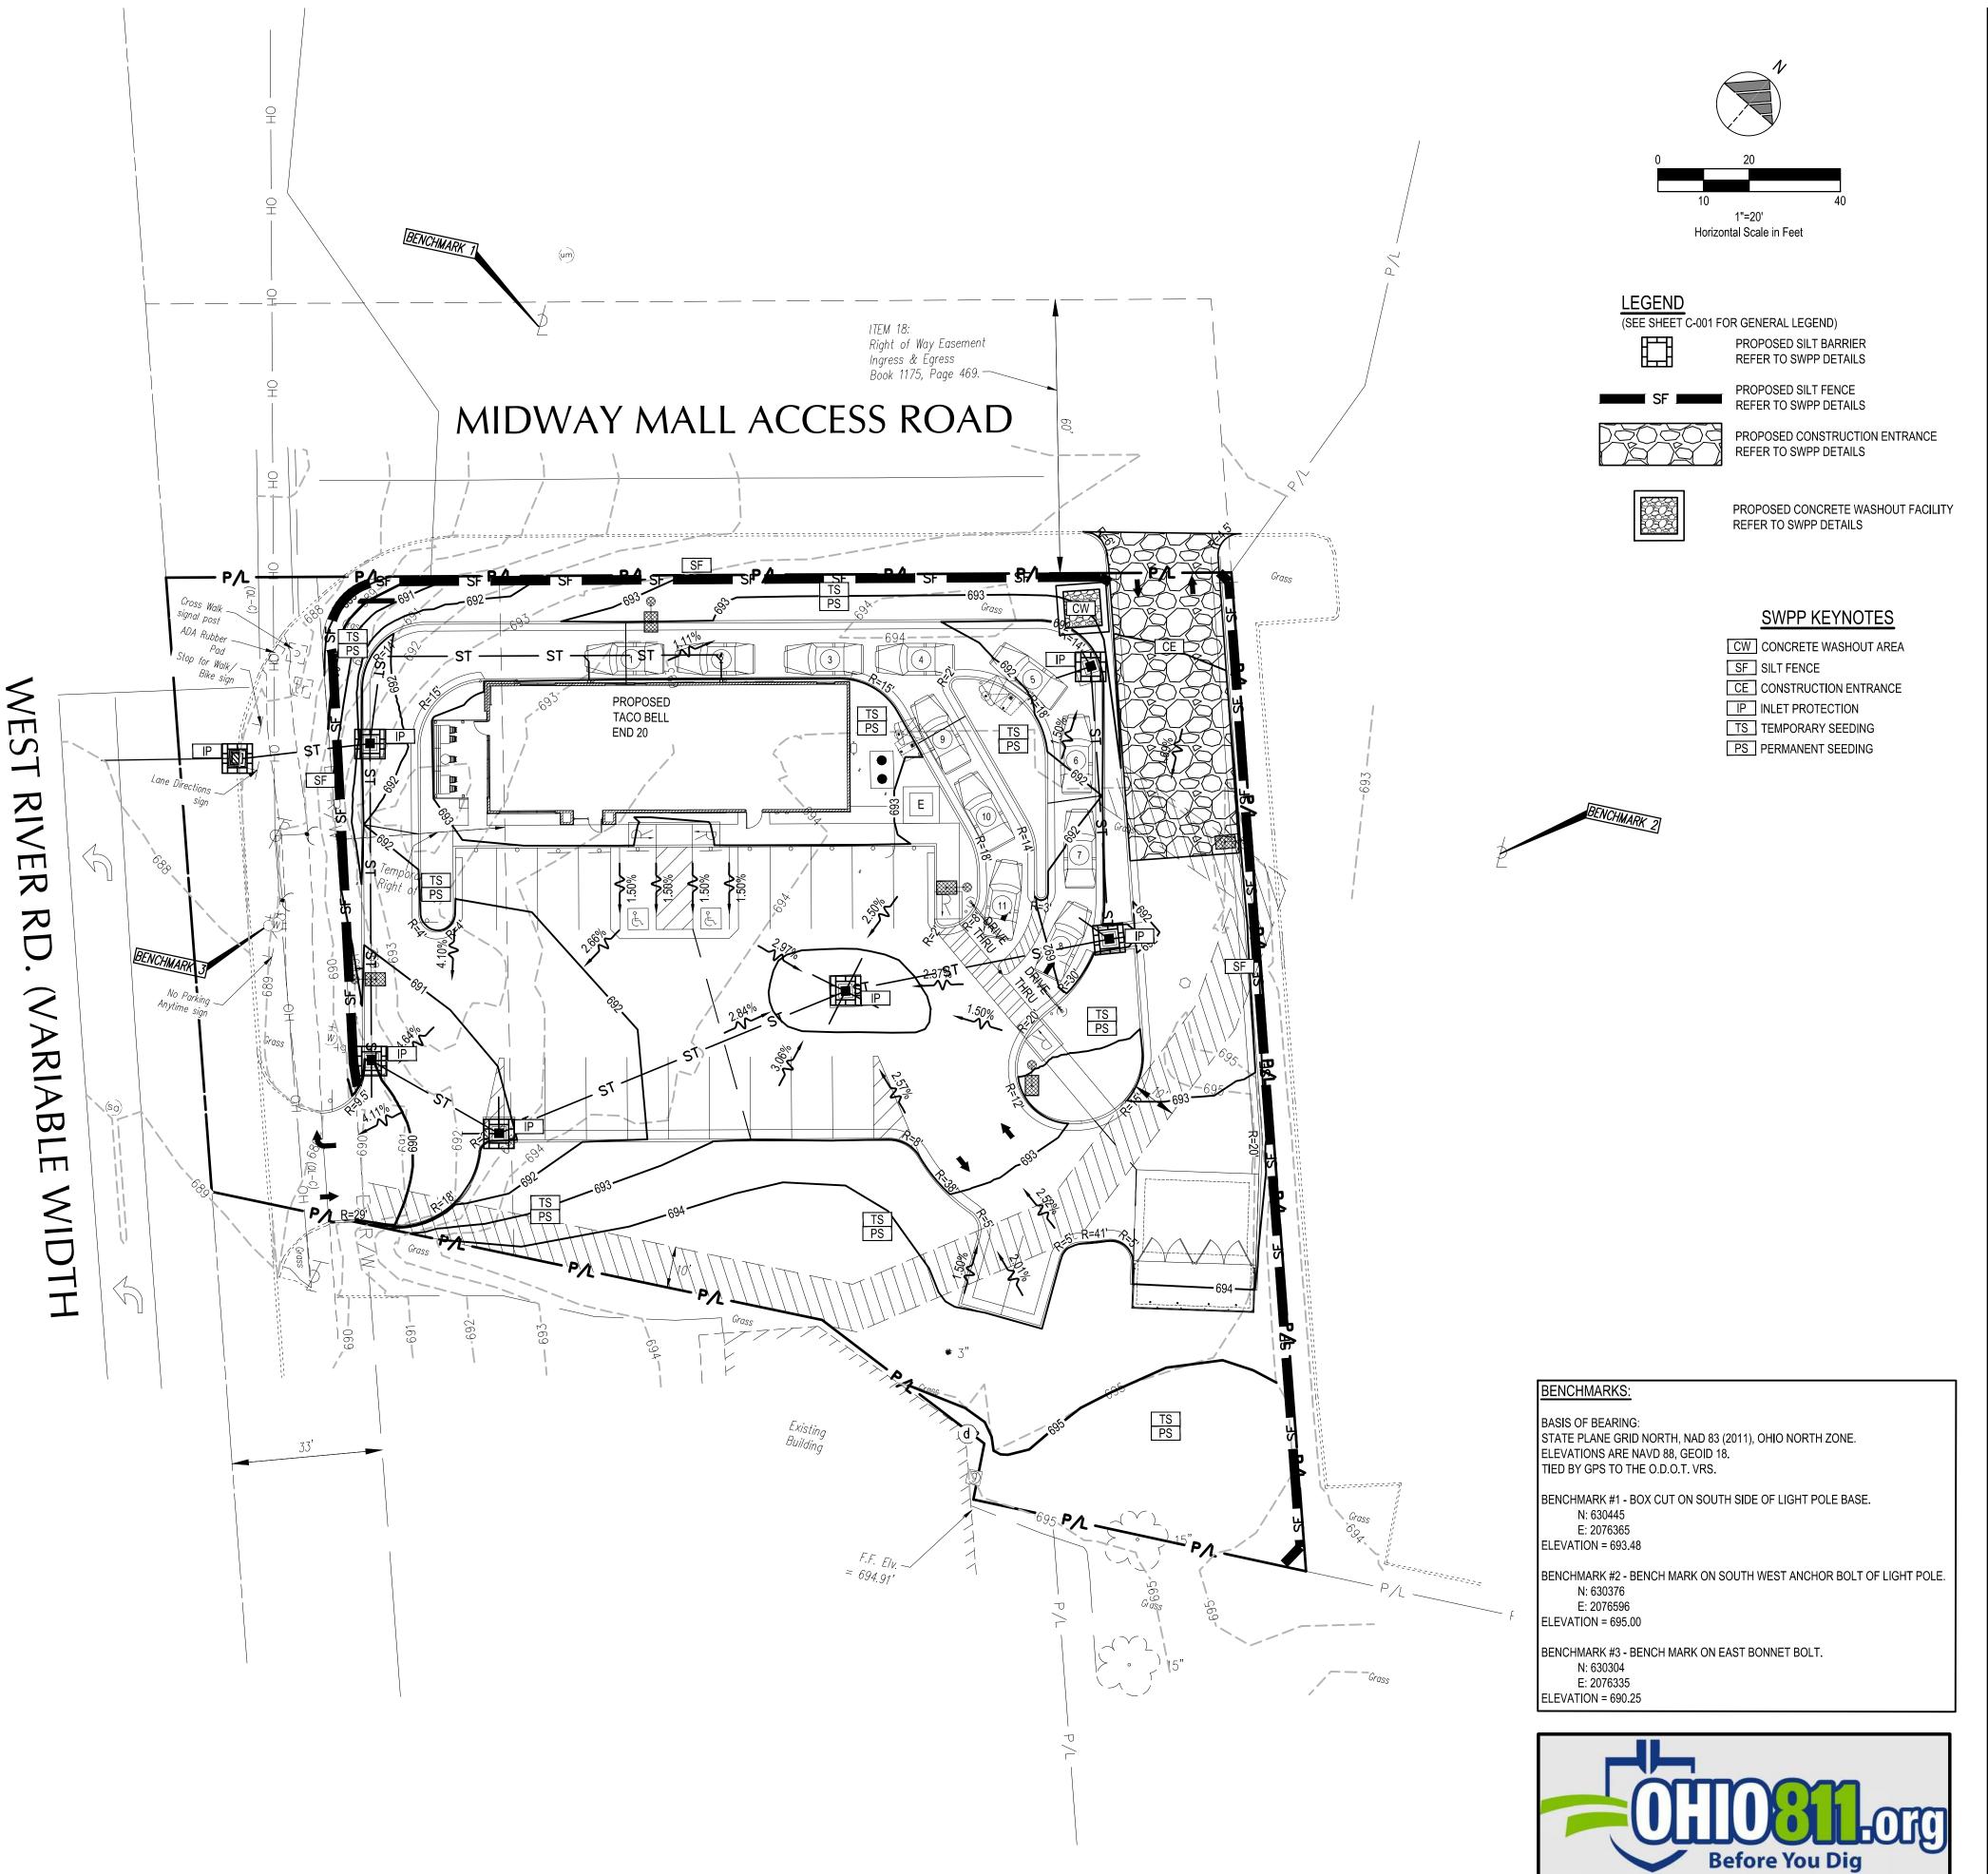



- DURING PRECONSTRUCTION MEETING ALL EROSION & SEDIMENT CONTROL FACILITIES & PROCEDURES SHALL BE DISCUSSED. A GENERAL CONSTRUCTION SEQUENCE FOLLOWS AND MAY NEED TO BE UPDATED BY THE CONTRACTOR TO SUIT THE SPECIFICS OF THE SITE AND INTENDED CONTRACTOR SPECIFIC SEQUENCING.
- 1.1. INSTALL CONSTRUCTION ENTRANCE AS DETAILED ON PLANS. TEMPORARY CONSTRUCTION FENCING SHALL BE INSTALLED AROUND PERIMETER OF CONSTRUCTION SITE. WHERE THERE IS EXISTING FENCE ALONG THE PERIMETER OF THE SITE, IT CAN BE UTILIZED. FENCING SHALL BE USED TO RESTRICT OUTSIDE TRAFFIC TO SITE.
- 1.2. DELIVER CONSTRUCTION TRAILER TO SITE AND INSTALL TEMPORARY POWER AND TELEPHONE, IF REQUIRED. TEMPORARY UTILITY SERVICES ARE THE SOLE
- RESPONSIBILITY OF THE CONTRACTOR. 1.3. STAKE AND/OR FLAG LIMITS OF CLEARING.
- 1.4. CLEAR & GRUB. AS NECESSARY. FOR INSTALLATION OF PERIMETER CONTROLS. INSTALL SILT PERIMETER CONTROLS AS SHOWN ON PLANS. SILT PERIMETER CONTROLS SHALL BE INSTALLED LEVEL, ALONG THE CONTOURS, WITH ENDS TURNED UPSLOPE TO PREVENT CONCENTRATED FLOW AT THE SILT PERIMETER CONTROLS.
- 1.5. INSTALL TEMPORARY SILT INLET PROTECTION ON ALL EXISTING CATCH BASINS AND INLETS, AS DESIGNATED IN THE PLANS. REMOVAL OF SILT INLET PROTECTION FROM DESIGNATED INLETS CAN ONLY OCCUR WHEN A STRUCTURE IS REMOVED, AND AS REQUIRED BY THE PROGRESSION OF THE DEMOLITION AND CONSTRUCTION.
- 1.6. CLEAR & GRUB, AS NECESSARY, FOR INSTALLATION OF TEMPORARY SEDIMENT TRAP/BASIN. INSTALL TEMPORARY SEDIMENT TRAP/BASIN, IF REQUIRED, AS DETAILED IN THE PLANS. CONSTRUCT AND MAINTAIN TEMPORARY DIVERSION SWALE AND / OR DIVERSION BERM DURING FILLING & GRADING ACTIVITIES.
- 1.7. CLEAR & GRUB THE REMAINING SITE AS NECESSARY. TOPSOIL SHALL BE STRIPPED AND
- STOCKPILED ON SITE FOR REUSE, OR REMOVED TO AN APPROVED OFFSITE SPOIL AREA. 1.8. UTILIZE DUST CONTROL MEASURES AS REQUIRED TO MINIMIZE AIR-BORNE POLLUTION BY METHODS APPROVED BY THE AUTHORIZING EPA OFFICE.
- 1.9. BEGIN FILLING & GRADING AS REQUIRED TO REACH SUBGRADE.
- 1.10. ONCE PAVEMENT GRADES HAVE BEEN ESTABLISHED, AS DESIGNATED ON THE PLANS, THE CONTRACTOR SHALL UTILIZE THESE AREAS FOR STRUCTURE CONSTRUCTION.
- 1.11. CONSTRUCT UNDERGROUND UTILITY WORK INCLUDING STORM DRAINAGE FACILITIES. UPON INSTALLATION OF STORM DRAINAGE CATCH BASINS, YARD DRAINS AND INLETS, INSTALL REQUIRED INLET PROTECTION.
- 1.12. DO NOT REPLACE ANY TOPSOIL, SEED OR INSTALL FINAL PAVEMENT PRIOR TO COMPLETION OF BUILDING SHELL. SHOULD SITEWORK BE COMPLETED PRIOR TO THIS DATE, MULCH DISTURBED AREAS TO BE PLANTED AND INSTALL STONE SUBBASE IN DISTURBED AREAS TO BE PAVED.
- 1.13. FOLLOWING COMPLETION OF BUILDING SHELL AND PAVEMENT INSTALLATION, BEGIN LANDSCAPE INSTALLATION.
- 1.14. COMPLETE SITEWORK, PAVEMENT MARKINGS AND FINAL CLEAN-UP. RESEED ANY AREAS THAT MAY REQUIRE ATTENTION IMMEDIATELY. NOTE THAT LAWN AREAS WILL NOT BE DEEMED STABLE UNTIL A MINIMUM 80% VEGETATIVE DENSITY HAS BEEN ACHIEVED.
- 1.15. MAINTAIN EROSION & SEDIMENTATION CONTROL MEASURES UNTIL THE SITE HAS BEEN COMPLETELY STABILIZED. ALL AREAS OF VEGETATIVE SURFACE, WHETHER PERMANENT OR TEMPORARY, SHALL BE CONSIDERED TO BE IN PLACE AND FUNCTIONAL WHEN THE REQUIRED UNIFORM RATE OF COVERAGE (80%) IS OBTAINED.
- 1.16. REMOVE SEDIMENT CONTROLS.



THIS 0.9191 ACRE SITE IS HOME TO AN ABANDONED BUILDING TO BE DEMOLISHED ALONG WITH ASSOCIATED PARKING LOT AND UTILITIES. THE IMPROVEMENTS TO THE SITE WILL INCLUDE BUT NOT LIMITED TO A NEW TACO BELL RESTAURANT, NEW PARKING LOT, CONCRETE SIDEWALKS, RETAINING WALL, ALL APPURTENANT UTILITY CONNECTIONS, GRADING AND LANDSCAPING.

PROJECT COMPLETION STATISTICS

PARCEL SIZE: 0.9191 ACRES TOTAL DISTURBED AREA: 0.9191 ACRES EXISTING LAND USE FOR THE SITE IS AN ABANDONED BUILDING WITH A PARKING LOT. ESTIMATED PRE-CONSTRUCTION IMPERVIOUS AREA: 0.6028 ACRES

ESTIMATED PRE-CONSTRUCTION IMPERVIOUS PERCENT: 65.6% 0.74 PRE-CONSTRUCTION RUN-OFF COEFFICIENT: PROPOSED LAND USE WILL BE A NEW TACO BELL RESTAURANT WITH A PARKING LOT. ESTIMATED POST-CONSTRUCTION IMPERVIOUS AREA: 0.585 ACRES ESTIMATED POST-CONSTRUCTION IMPERVIOUS PERCENT:

PROJECT LOCATION: LATITUDE LONGITUDE 41.3961° -82.1063°

EXISTING SITE SOIL TYPES:

FAC: FITCHVILLE SILT LOAM. REFERENCE: USDA NATIONAL RESOURCES CONSERVATION SERVICE WEB SOIL SURVEY.

WETLAND INFORMATION: THERE ARE NO KNOWN WETLANDS ON THIS SITE.

POST-CONSTRUCTION RUN-OFF COEFFICIENT:

FIRST AND SUBSEQUENT RECEIVING STREAM:

INITIAL RECEIVING WATER IS CITY STORM SEWER AND THE SUBSEQUENT RECEIVING WATER IS THE BLACK RIVER.

POST CONSTRUCTION WQv / BMP DESCRIPTION

THIS SITE IS HOME TO AN ABANDONED BUILDING WITH A TOTAL IMPERVIOUS AREA OF 0.6028

UNDER PROPOSED CONDITIONS, THIS SITE WILL HAVE A TACO BELL RESTAURANT AND A PARKING LOT WITH A TOTAL IMPERVIOUS AREA OF 0.585 ACRES. SINCE THE PROPOSED IMPERVIOUS AREA IS REDUCED FROM THE EXISTING CONDITIONS, THE CITY OF ELYRIA DOES NOT REQUIRE DETENTION AND WATER QUALITY FOR THIS SITE.

OWNER CONTACT: YUM! BRANDS, INC.

STEVE PULCHEON 1900 COLONEL SANDERS LANE LOUISVILLE, KY 40213

949.863.3864 ANTICIPATED TIMING:

CONSTRUCTION BEGIN CONSTRUCTION COMPLETE:


AUGUST, 2022 JANUARY, 2023


CONTRACTOR: T.B.D. CONTACT: PHONE NUMBER:

CONTRACTOR SHALL MAINTAIN A CONSTRUCTION LOG DOCUMENTING ALL GRADING AND STABILIZATION ACTIVITIES.



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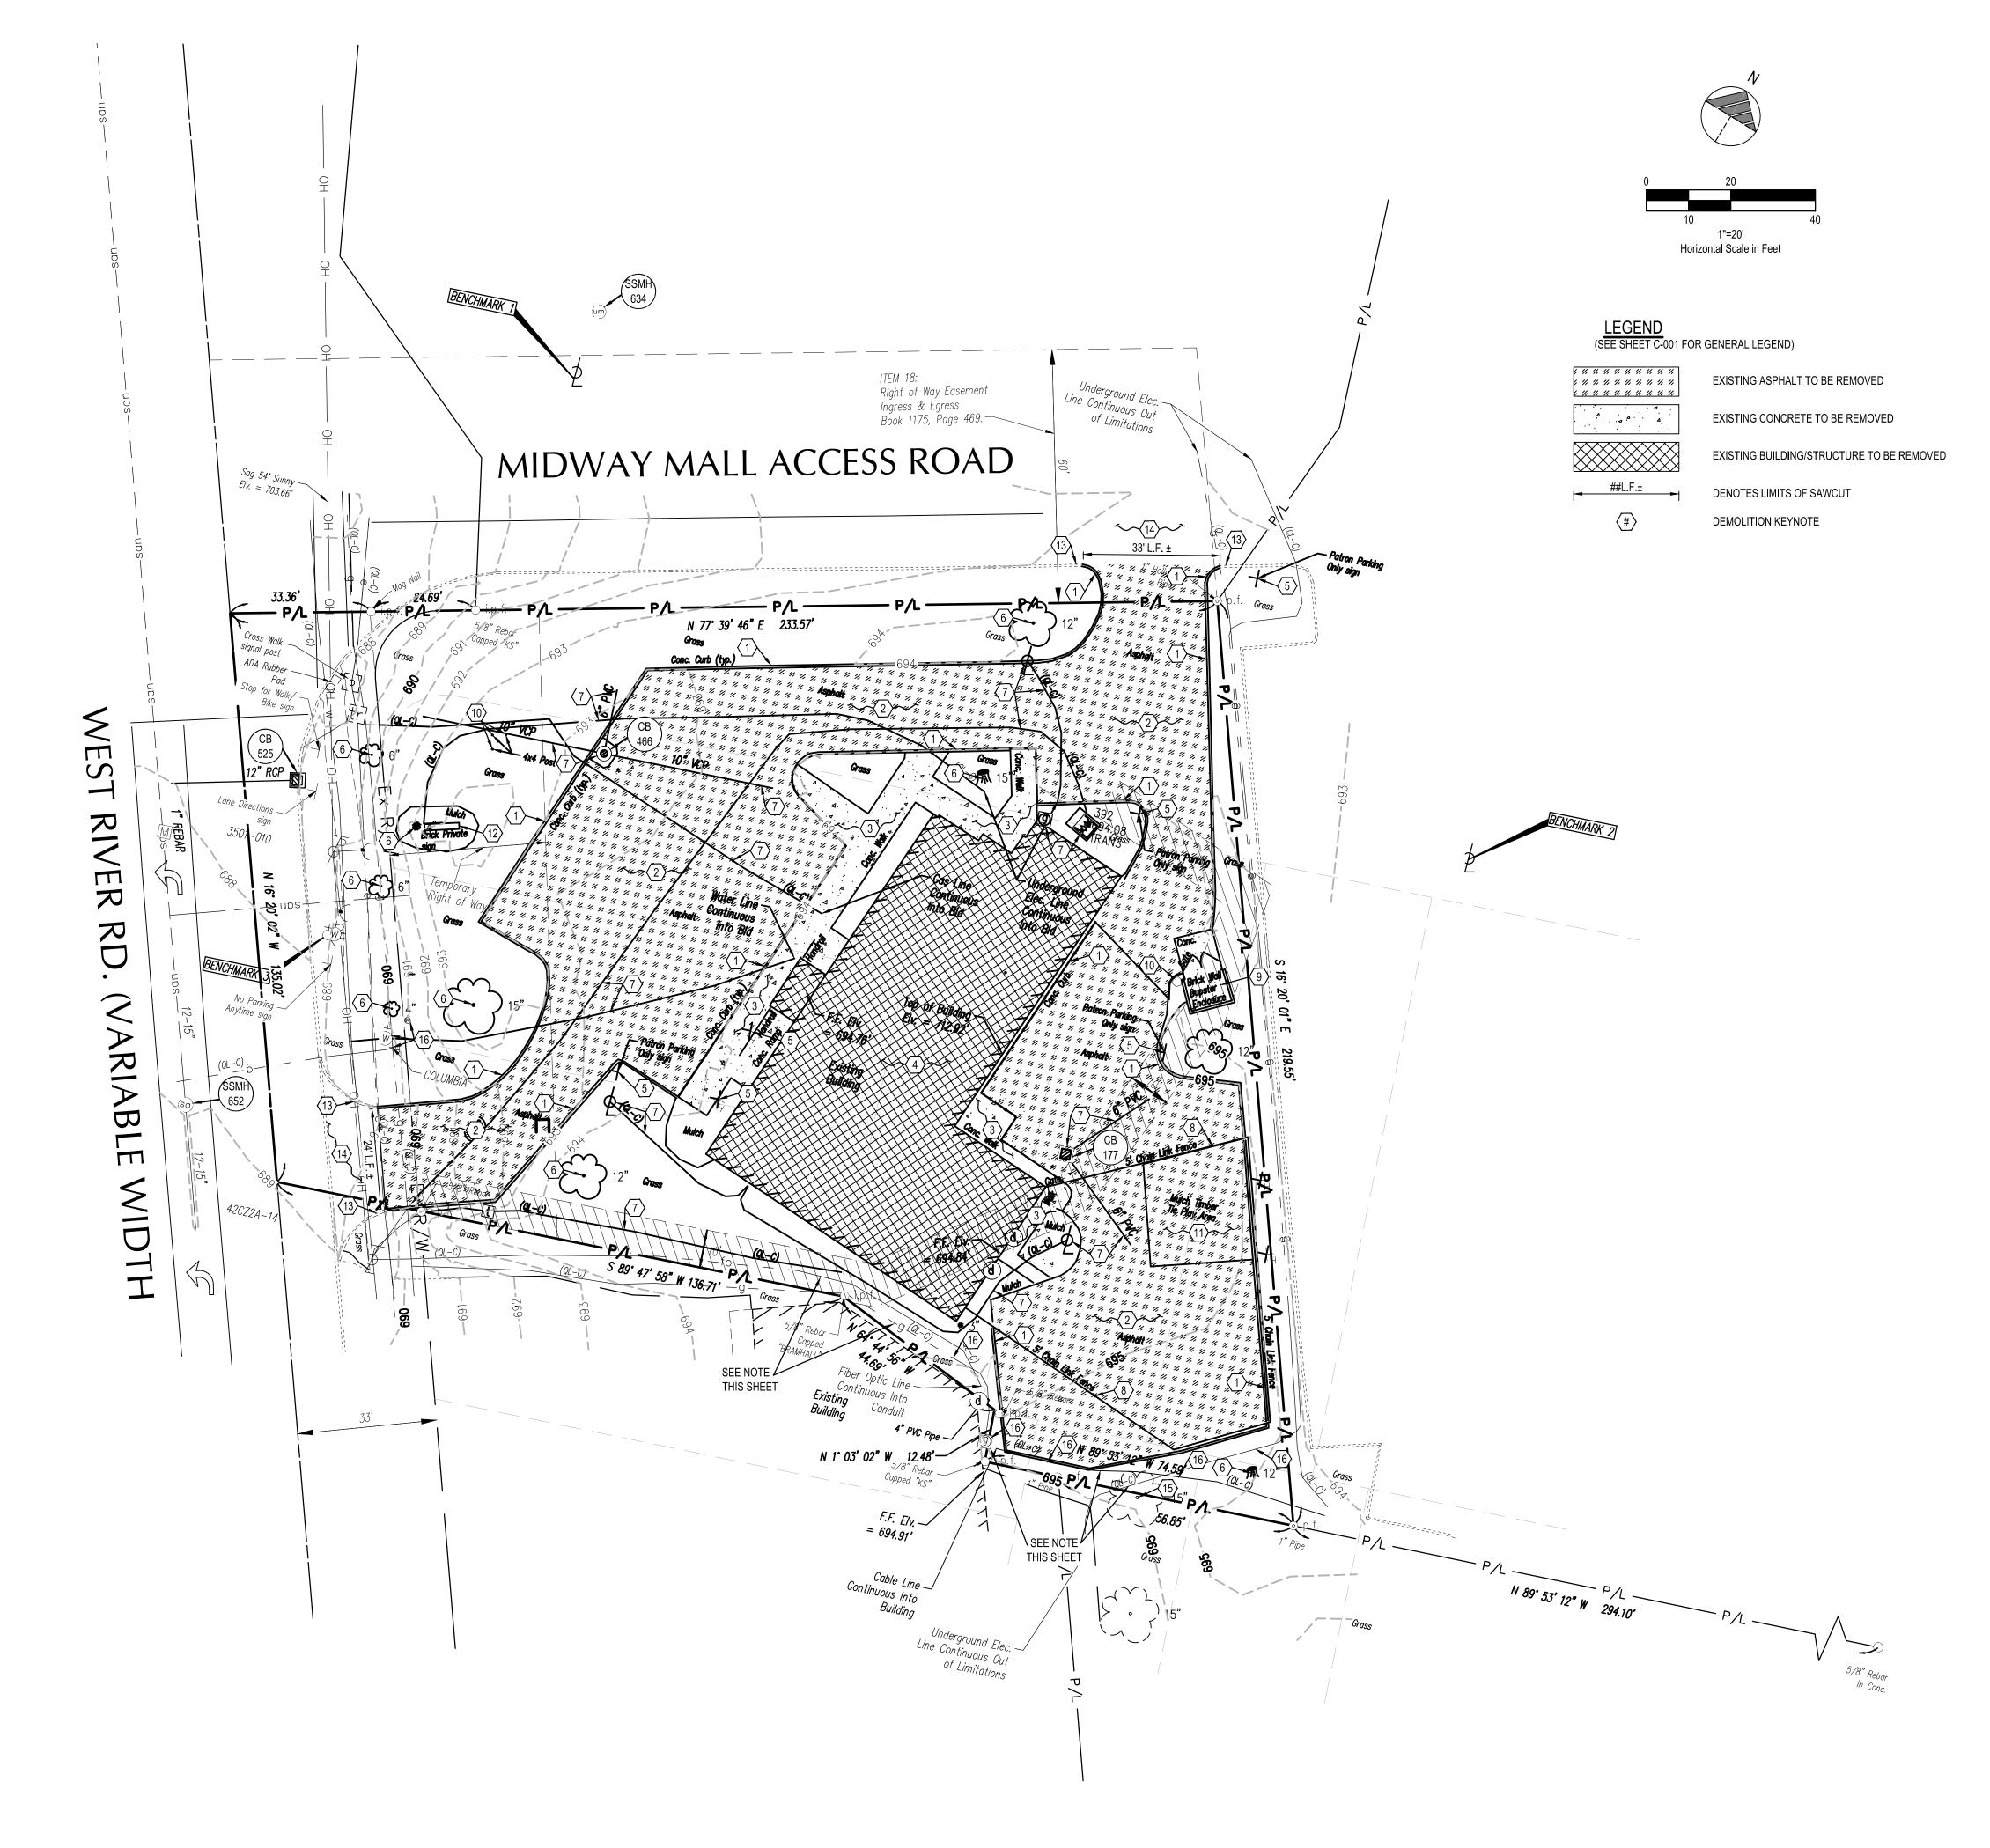
0.74

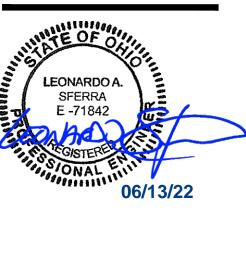TACO BELL

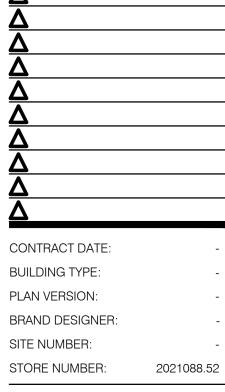1551 WEST RIVER ROAD ELYRIA, OHIO 44035



SWPP



PLAN KEYNOTES (#)

- 1. EXISTING CURB/CURBED WALK TO BE REMOVED.
- 2. EXISTING PAVEMENT TO BE REMOVED.
- 3. EXISTING CONCRETE WALK TO BE REMOVED 4. EXISTING BUILDING/STRUCTURE WITH ASSOCIATED FOUNDATIONS TO BE REMOVED.
- 5. EXISTING SIGNAGE WITH ASSOCIATED FOUNDATIONS TO BE REMOVED.
- 6. EXISTING LANDSCAPING (INCLUDING BUSHES, TREES, ETC.) TO BE REMOVED.
- 7. EXISTING UTILITIES TO BE REMOVED.
- 8. EXISTING CHAIN LINK FENCE TO BE REMOVED.
- 9. EXISTING DUMPSTER ENCLOSURE WITH GATE, CONCRETE SLAB, AND ASSOCIATED FOUNDATION TO BE REMOVED.
- 10. EXISTING POST WITH ASSOCIATED FOUNDATION TO BE REMOVED.
- 11. EXISTING MULCH PLAY AREA TO BE REMOVED.
- 12. EXISTING MONUMENT SIGN WITH ASSOCIATED FOUNDATION TO BE REMOVED.
- 13. EXISTING CURB TO REMAIN AND BE PROTECTED THROUGHOUT CONSTRUCTION. 14. EXISTING PAVEMENT TO REMAIN AND BE PROTECTED THROUGHOUT CONSTRUCTION.
- 15. EXISTING LANDSCAPING (INCLUDING BUSHES, TREES, ETC.) TO REMAIN AND BE
- PROTECTED THROUGHOUT CONSTRUCTION. 16. EXISTING UTILITIES TO REMAIN AND BE PROTECTED THROUGHOUT CONSTRUCTION.

DEMOLITION NOTE:
ALL EXISTING SITE AND SURROUNDING FEATURES SUCH AS UTILITIES, PAVEMENT, CURB, LANDSCAPING, ETC. SHALL REMAIN AND BE PROTECTED THROUGHOUT CONSTRUCTION UNLESS NOTED OTHERWISE, OR ARE REQUIRED TO BE MODIFIED OR REMOVED FOR THE INSTALLATION OF PROPOSED IMPROVEMENTS. ALL DISTURBED FEATURES SHALL BE RESTORED OR RELOCATED AS REQUIRED TO THE SATISFACTION OF THE OWNER. CONTRACTOR SHALL REPAIR/REPLACE ANY SURROUNDING FEATURES DAMAGED AS A RESULT OF CONSTRUCTION ACTIVITIES AT NO ADDITIONAL COST AND TO THE SATISFACTION OF THE OWNER.

NOTE: CONTRACTOR TO TAKE EXTRA PRECAUTION DOING DEMOLITION WORK TO PROTECT UTILITIES SERVING EXISTING BUILDING TO THE SOUTH.



CONTRACT DATE

BUILDING TYPE:

PLAN VERSION:

SITE NUMBER:

BRAND DESIGNER:

STORE NUMBER:

TACO BELL

1551 WEST RIVER ROAD

ELYRIA, OHIO 44035

ENDEAVOR

EXISTING STRUCTURES				
STRCT. ID	STRUCTURE DETAILS			
CB 177	EXISTING CATCH BASIN T/C = 694.28 INV. 6" PVC (NE) = 692.93 INV. 6" PVC (SE) = 693.08			
CB 466	EXISTING CATCH BASIN T/C = 692.24 INV. 10" VCP (W) = 688.54 INV. 10" VCP (E) = 688.59 INV. 6" PVC (N) = XXXX			
CB 525	EXISTING CATCH BASIN T/C = 687.34 INV. 12" (W) = 682.64			
SSMH 634	EXISTING SANITARY SEWER MANHOLE T/C = 693.22 NO PIPES VISIBLE 13" RISER PIPE BOTT. = ± 663.22			
SSMH 652	EXISTING SANITARY SEWER MANHOLE T/C = 688.96 INV. 12-15" (N) = 673.46 INV. 12-15" (S) = 673.46			

BENCHMARKS:

BASIS OF BEARING: STATE PLANE GRID NORTH, NAD 83 (2011), OHIO NORTH ZONE. ELEVATIONS ARE NAVD 88, GEOID 18.

TIED BY GPS TO THE O.D.O.T. VRS.

BENCHMARK #1 - BOX CUT ON SOUTH SIDE OF LIGHT POLE BASE. N: 630445 E: 2076365

ELEVATION = 693.48

BENCHMARK #2 - BENCH MARK ON SOUTH WEST ANCHOR BOLT OF LIGHT POLE. N: 630376

E: 2076596 ELEVATION = 695.00

BENCHMARK #3 - BENCH MARK ON EAST BONNET BOLT.

N: 630304 E: 2076335 ELEVATION = 690.25








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DEMOLITION PLAN



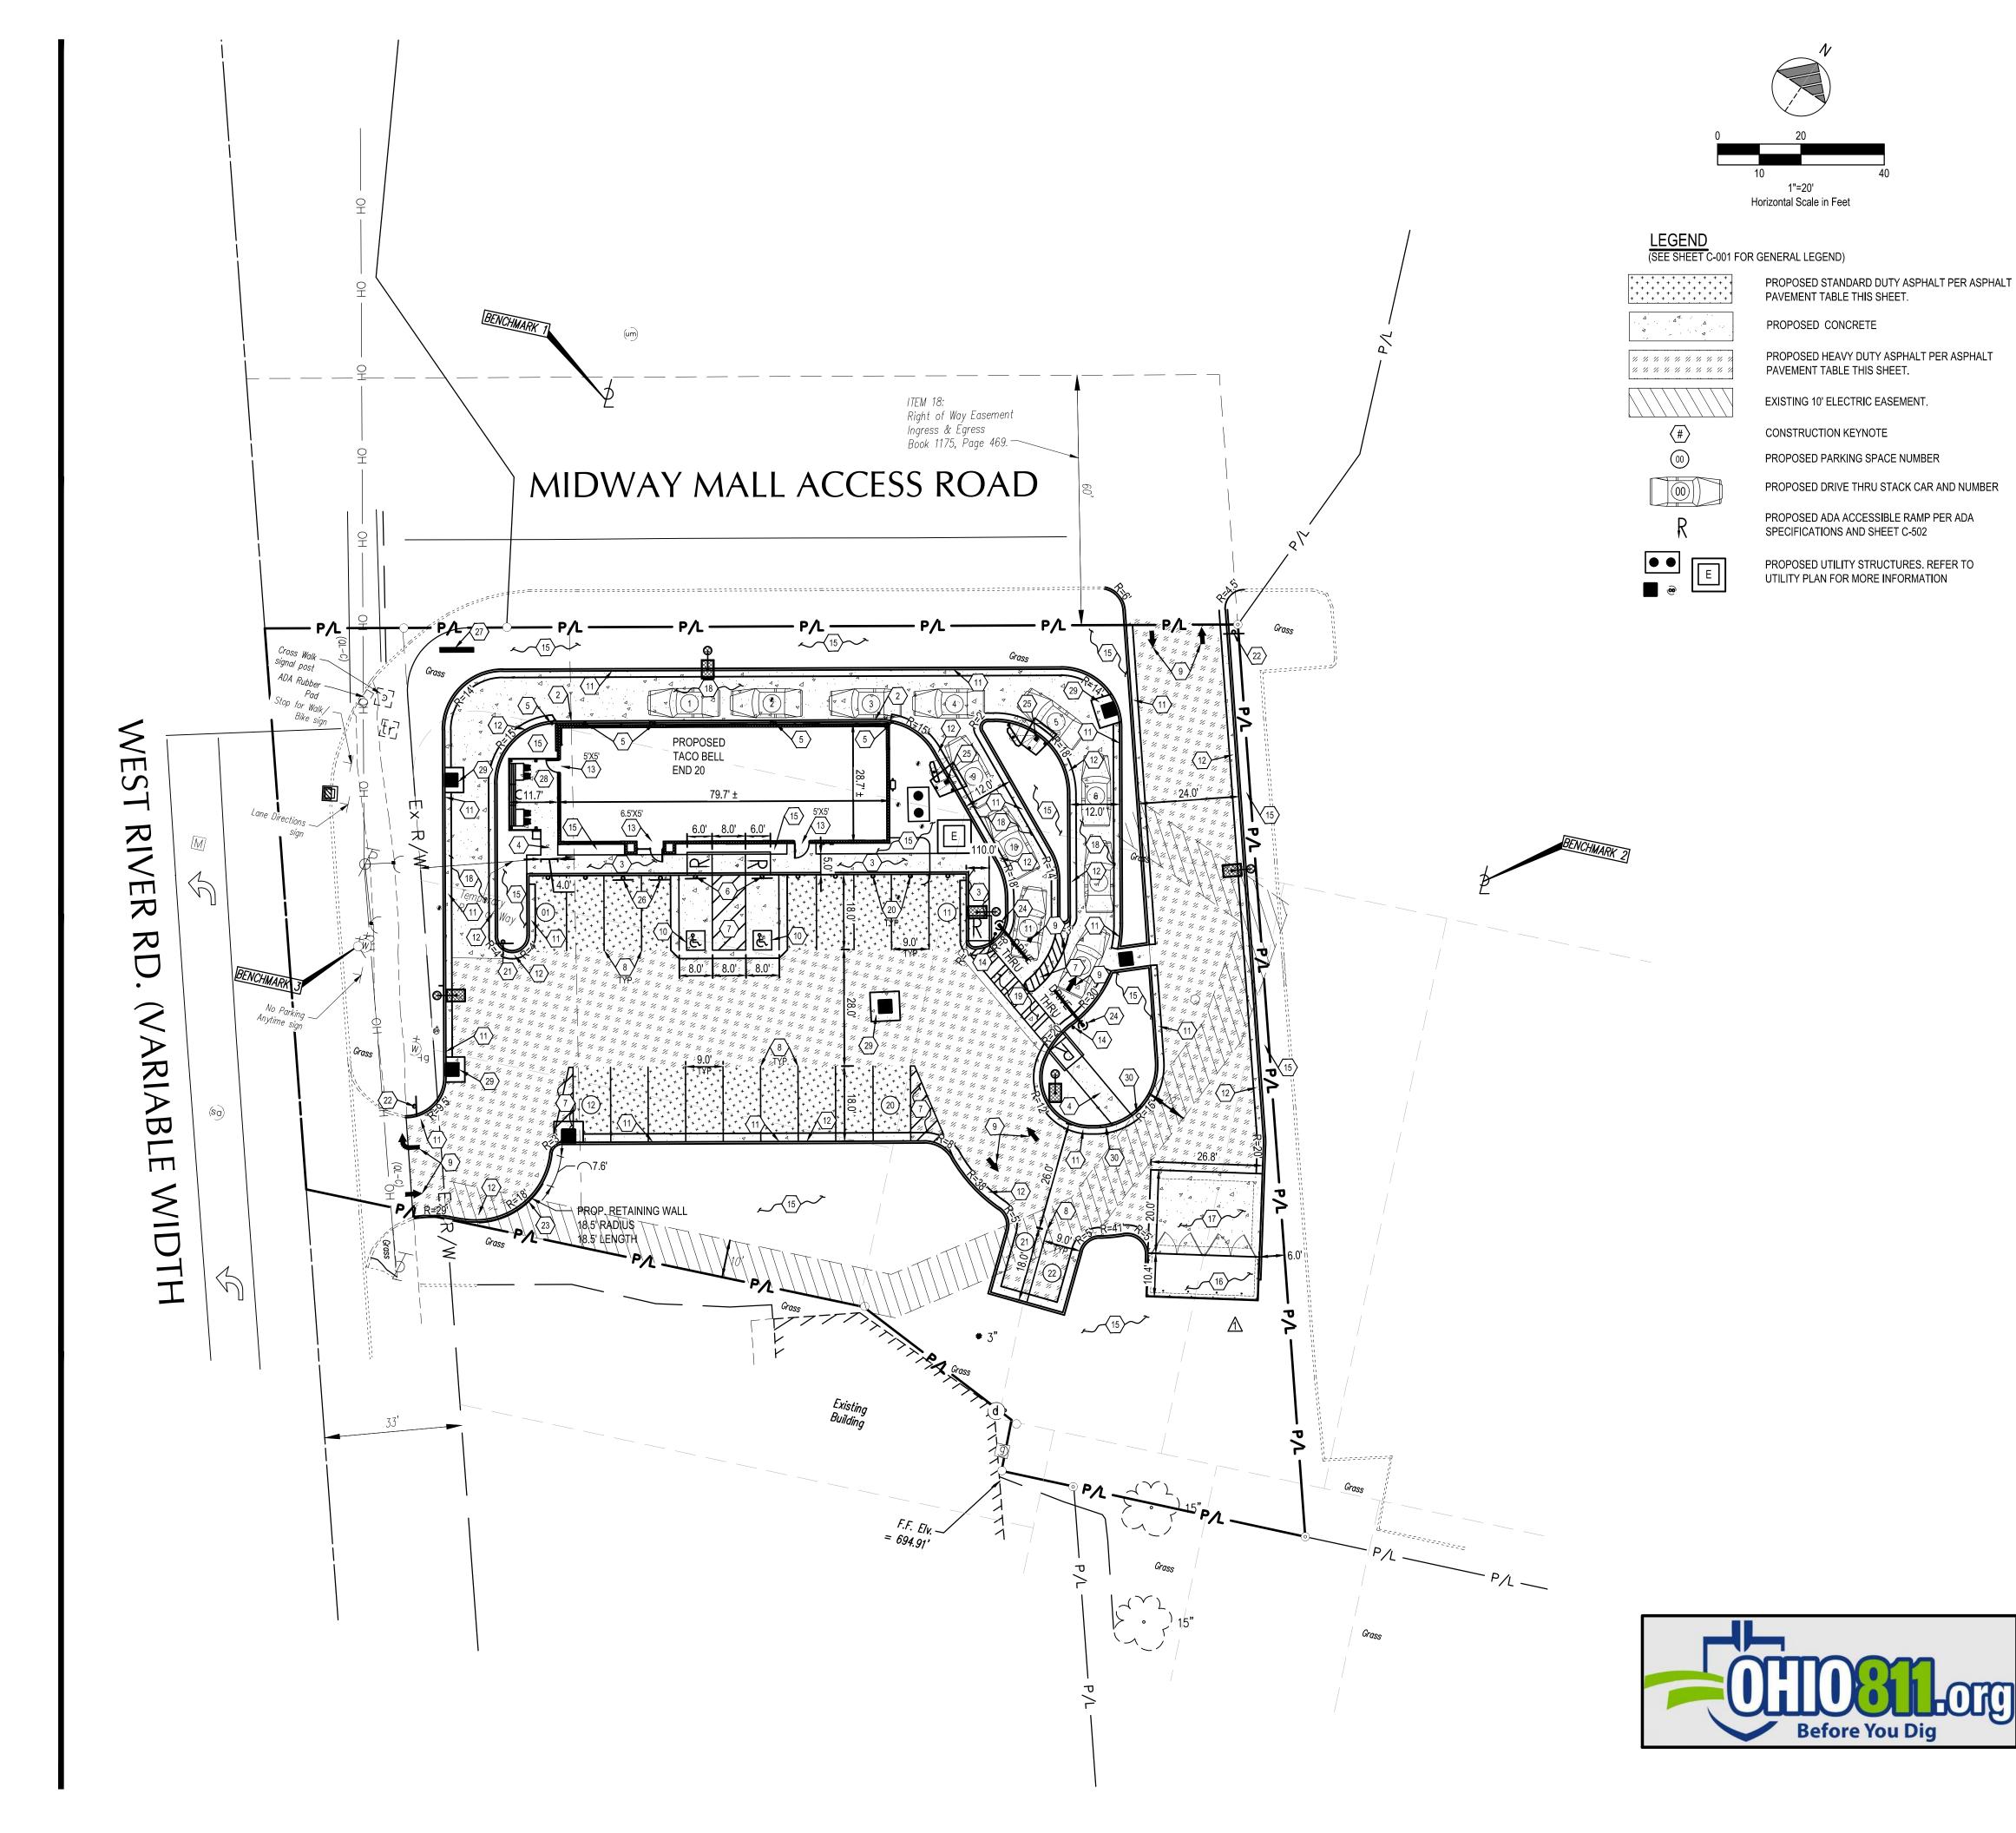

- PROPOSED CONCRETE CURB. SEE SHEET C-501.
- 2. PROPOSED CONCRETE CURB AT DRIVE THRU. SEE SHEET C-501.
- 3. PROPOSED CONCRETE CURBED WALK. SEE SHEET C-501.
- 4. PROPOSED CONCRETE WALK. SEE SHEET C-501.
- 5. PROPOSED DETERRENT BOLLARD IN CURB. SEE SHEET C-501. 6. PROPOSED HANDICAPPED PARKING SIGN. SEE SHEET C-502.
- 7. PROPOSED PAINTED TRANSVERSE STRIPING. SEE SHEET C-501. 8. PROPOSED PAINTED 4" WIDE SOLID STRIPE - WHITE ON ASPHALT, YELLOW ON CONCRETE AND
- BLUE FOR ADA. SEE SHEET C-501. 9. PROPOSED DIRECTIONAL PAVEMENT MARKINGS - WHITE ON ASPHALT, YELLOW ON CONCRETE.
- SEE SHEET C-501.
- 10. PROPOSED PAINTED INTERNATIONAL ADA SYMBOL PER ADA SPECIFICATIONS. SEE SHEET
- 11. PROPOSED CONCRETE CURB AND GUTTER. SEE SHEET C-501.
- 12. PROPOSED CONCRETE CURB AND GUTTER (REVERSE PITCH). SEE SHEET C-501
- 13. PROPOSED FROST SLAB AT DOOR. SEE STRUCTURAL PLANS FOR DETAILS.
- 14. PROPOSED DETERRENT BOLLARD. SEE SHEET C-501.
- 15. PROPOSED LANDSCAPING AREA. SOD ALL DISTURBED AREAS EXCEPT WHERE PLANTING BEDS ARE INDICATED.
- 16. PROPOSED DUMPSTER ENCLOSURE ON P.C.C. PAD. SEE ARCHITECTURAL PLANS.
- 17. PROPOSED HEAVY DUTY 6" P.C.C. PAVEMENT WITH W.W.F. 6" X 6" W2.9 X W2.9 CENTERED (CONTROL JTS. 12'-0" O.C.) OVER 8" CRUSHED AGGREGATE BASE COURSE (ODOT 304) - APPLY LIQUID ASPHALT AT ALL JOINTS BETWEEN CONCRETE AND ASPHALT.
- 18. PROPOSED LIGHT DUTY 5" P.C.C. PAVEMENT WITH W.W.F. 6" X 6" W2.9 X W2.9 CENTERED (CONTROL JTS. 12'-0" O.C.) OVER 6" CRUSHED AGGREGATE BASE COURSE (ODOT 304) - APPLY LIQUID ASPHALT AT ALL JOINTS BETWEEN CONCRETE AND ASPHALT.
- 19. PROPOSED CROSSWALK STRIPING. SEE SHEET C-501.
- 20. PROPOSED CRASH RATED BOLLARD, COUNT (7). SEE SHEET C-501.
- 21. PROPOSED 'DO NOT ENTER' SIGN PER ODOT STANDARDS. SEE SHEET C-501.
- 22. PROPOSED 'STOP' SIGN PER ODOT STANDARDS. SEE SHEET C-501.
- 23. PROPOSED RETAINING WALL. SEE STRUCTURAL PLANS FOR DETAILS.
- 24. PROPOSED EVOLUTION PORTAL CLEARANCE BAR. SEE SHEET C-503.
- 25. PROPOSED MENU BOARD AND ORDER CONFIRMATION BOARD INCLUDING SENSOR LOOP PER SIGN SUPPLIER SPECIFICATIONS. SIGN SUPPLIER TO PROVIDE A TEMPLATE FOR G.C. G.C. TO COORDINATE A MEETING WITH THE CONSTRUCTION/PROJECT MANAGER AND OPERATIONS TO VERIFY LOCATION AND PLACEMENT OF MENU BOARD AND ORDER CONFIRMATION BOARD PRIOR TO ANY CONSTRUCTION. SIGN SUPPLIER SHALL PROVIDE G.C. WITH FOUNDATION DETAILS. G.C. RESPONSIBLE FOR SIGN FOUNDATIONS/ELECTRICAL. SEE SHEET C-503.
- 26. PROPOSED MOBILE ORDER PICK-UP SIGN, IN BOLLARD. CONTRACTOR TO INSTALL SIGN POST AND BOLLARD PER THE HANDICAP SIGN DETAIL. SIGN TO BE PROVIDED BY SIGN VENDOR. 27. PROPOSED MONUMENT SIGN PER SIGN SUPPLIER SPECIFICATIONS. SIGN SUPPLIER SHALL
- DESIGN AND INSTALL FOUNDATION. 28. PROPOSED PATIO AND ASSOCIATED ITEMS INCLUDING FENCE. CONTRACTOR SHALL
- COORDINATE A MEETING WITH THE CONSTRUCTION MANAGER TO VERIFY TYPE, LOCATION AND PLACEMENT OF FENCE PRIOR TO ANY CONSTRUCTION. OUTDOOR SEATING PER CONSTRUCTION MANAGER SPECIFICATIONS.
- 29. PROPOSED CONCRETE COLLAR, SEE DETAIL SHEET C-503.
- 30. PROPOSED CURB TAPER, SEE DETAIL SHEET C-503.

ASPHALT PAVEMENT

		1	
MATERIAL	DEPTH (HVY. DUTY)	DEPTH (STD. DUTY)	ODOT SPECIFICATIONS ITEM
A.C. SURFACE COURSE	1.5"	1.5"	PER ODOT #448
A.C. INTERMEDIATE COURSE	2.0"	1.5"	PER ODOT #448
AGG. BASE COURSE	8"	6"	PER ODOT #304
SUBGRADE COMPACTION	PER SOILS REPORT	PER SOILS REPORT	PER SOILS REPORT

SOILS REPORT GOVERNS IF ANY DISCREPANCIES OCCUR.

BUILDING SET	BACKS		PARKING SPACE	S	
	REQUIRED	PROVIDED		REQUIRED	PROVID
FRONT: W RIVER RD	0'	55'	NUMBER OF SPACES	22	22
REAR: EAST	20'	86'	PARKING REQUIREMENTS	3	
SIDE: ACCESS RD	0'	23'	1 SPACE FOR EACH 100 S	QUARE FEE	T OF FLO
SIDE: SOUTH	0'	94'	AREA		
PARKING SETE	PARKING SETBACKS		THEREFORE: 2,287 / 100 = 22 SPACES REQUIF (ROUNDED DOWN PER DESIGN REVIEW)		
	REQUIRED	PROVIDED		ZOIGIN KEVII	⊏vv)
FRONT: W RIVER RD	0'	58'			
REAR: EAST	20'	70'	LAND USE DATA		
SIDE: ACCESS RD	0'	59'		% OF	AREA
SIDE: SOUTH	0'	24'		SITE AREA	PROVID
LANDSCAPE S	ETBACK	S	BUILDING	5.77%	0.053 A
	REQUIRED	PROVIDED	PAVEMENT/IMPERVIOUS	57.88%	0.532 A
FRONT: W RIVER RD	0'	58'	LANDSCAPING	36.35%	0.334 A
REAR: EAST	20'	70'	TOTAL	100%	0.9191
SIDE: ACCESS RD	0'	59'	CURRENT ZONING: B-G E	SUSINESS	



SIDE: SOUTH

BASIS OF BEARING:

STATE PLANE GRID NORTH, NAD 83 (2011), OHIO NORTH ZONE. ELEVATIONS ARE NAVD 88, GEOID 18.

TIED BY GPS TO THE O.D.O.T. VRS.

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GENERAL DISTRICT



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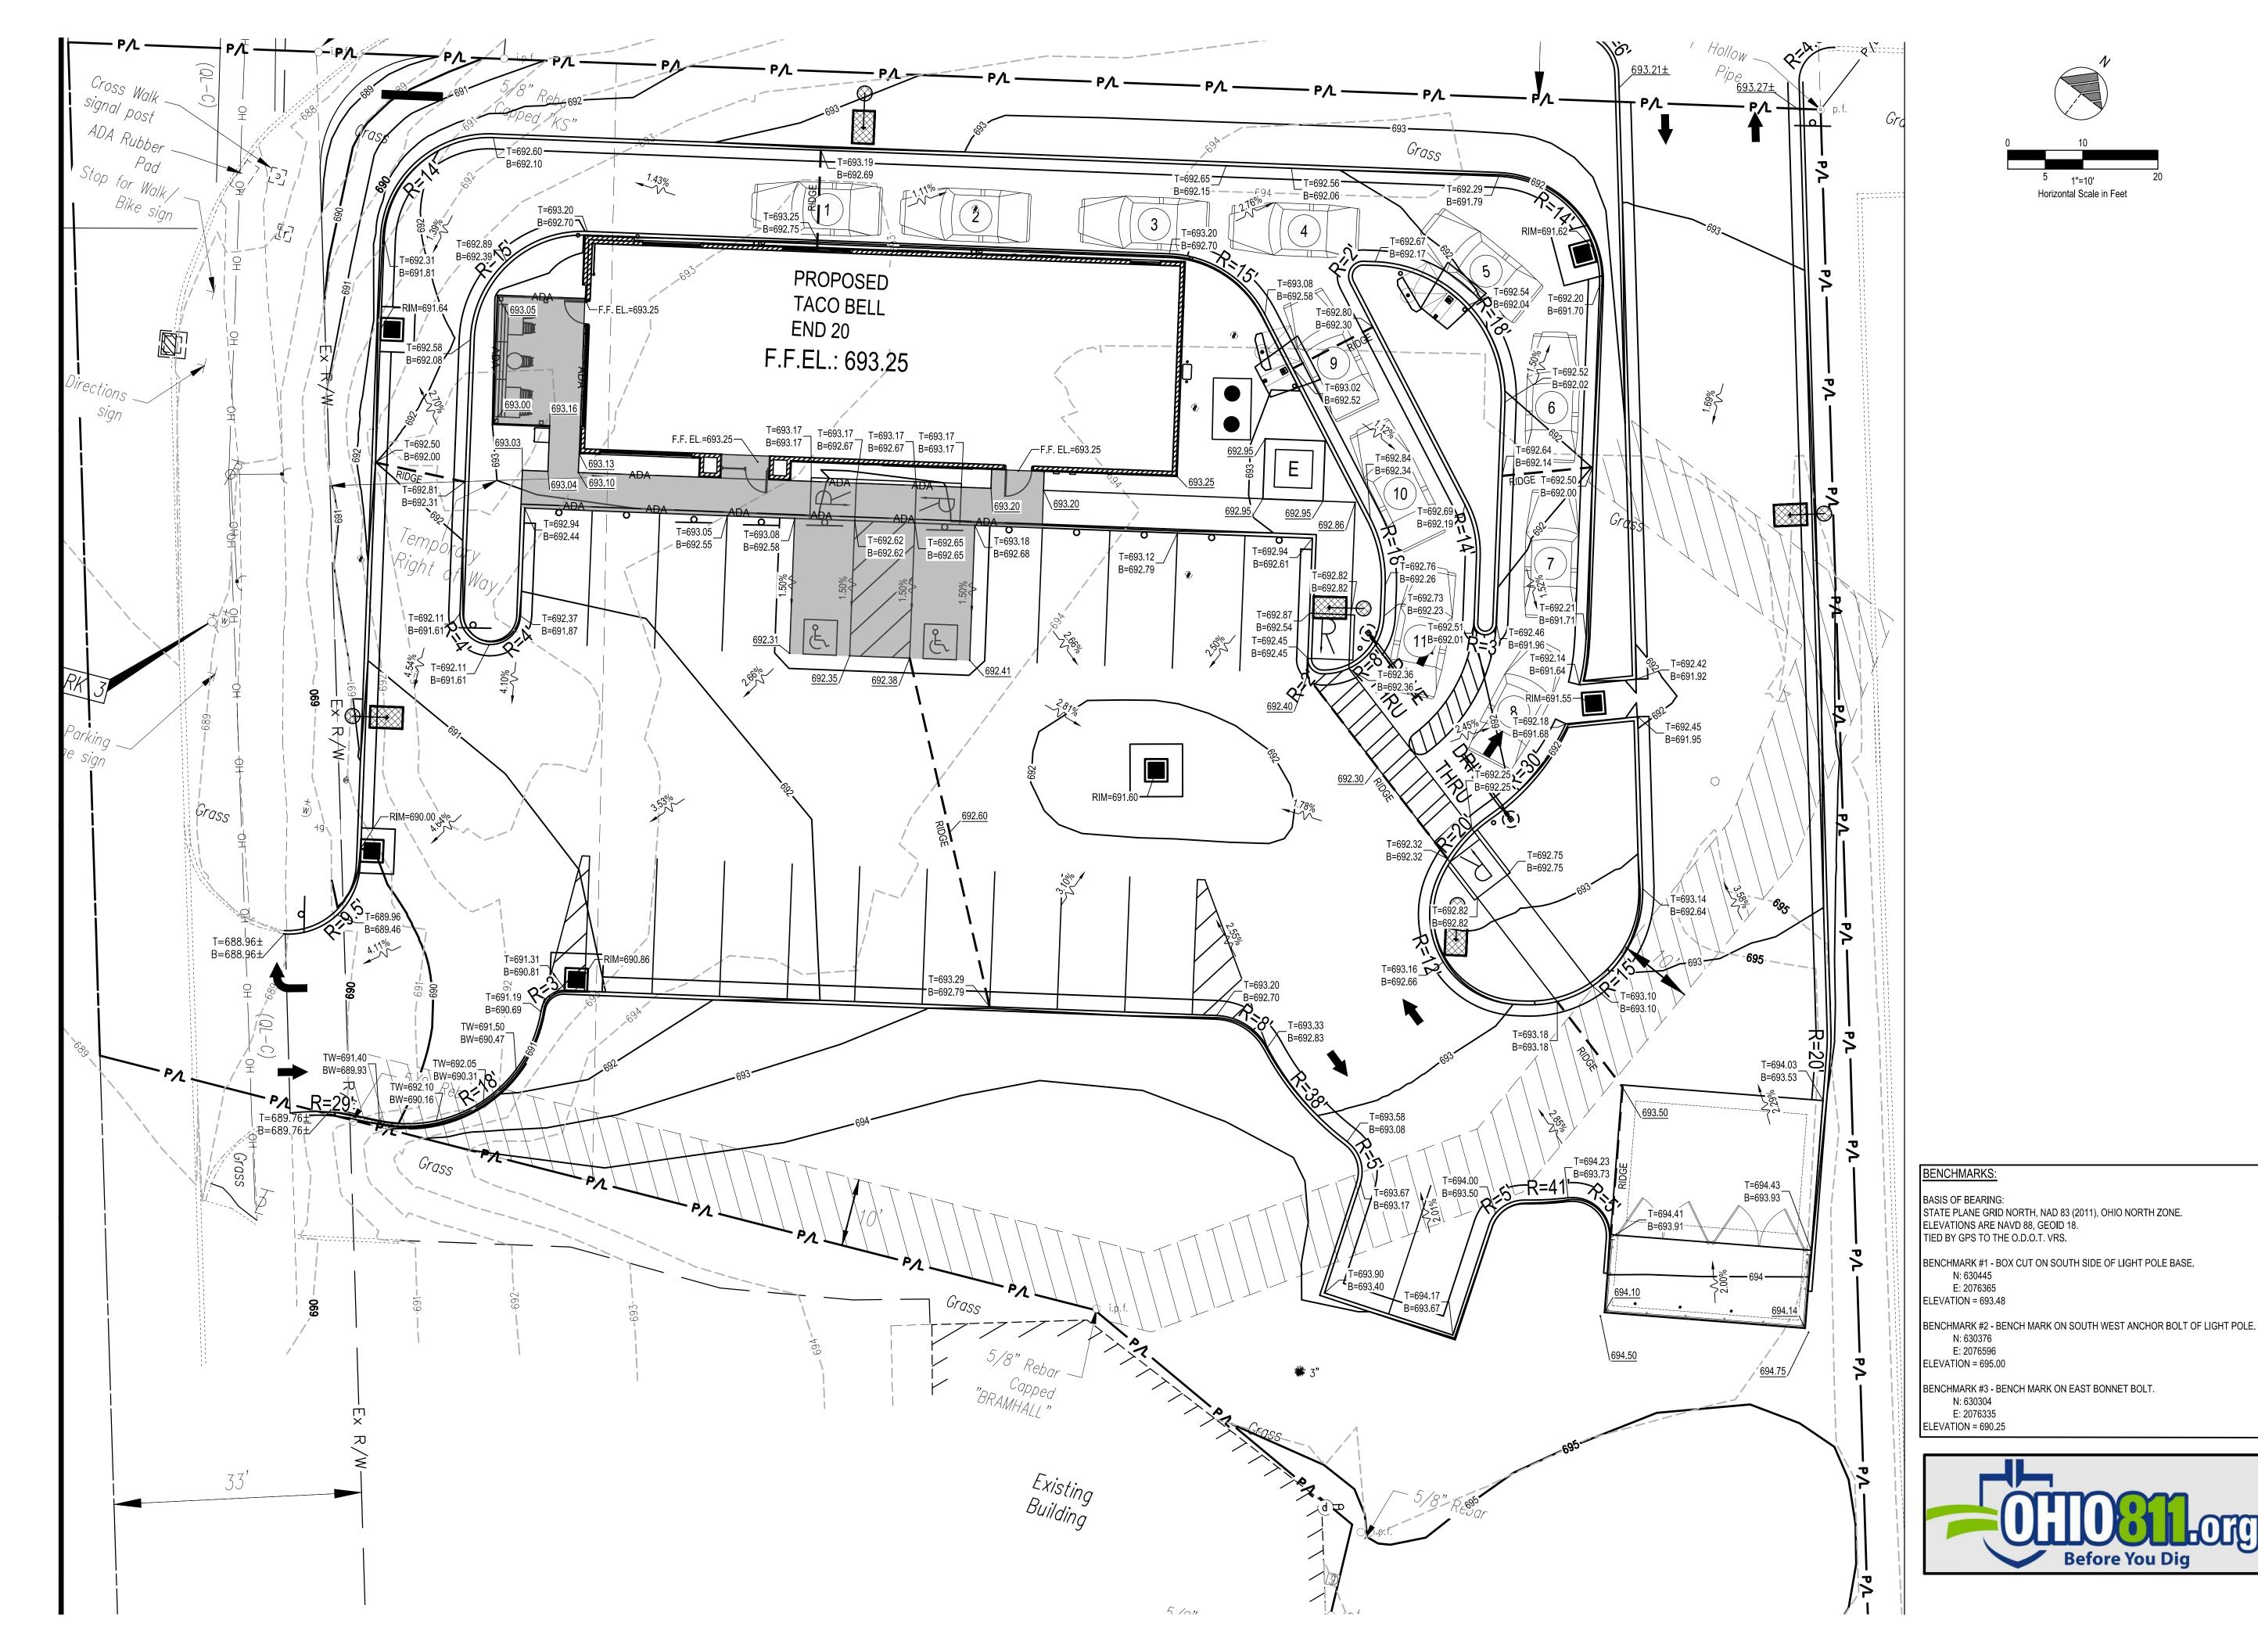
05.19.22 PLANNING COMMENTS **BUILDING TYPE:** PLAN VERSION: BRAND DESIGNER: SITE NUMBER:


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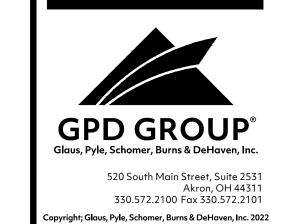
1551 WEST RIVER ROAD


ELYRIA, OHIO 44035

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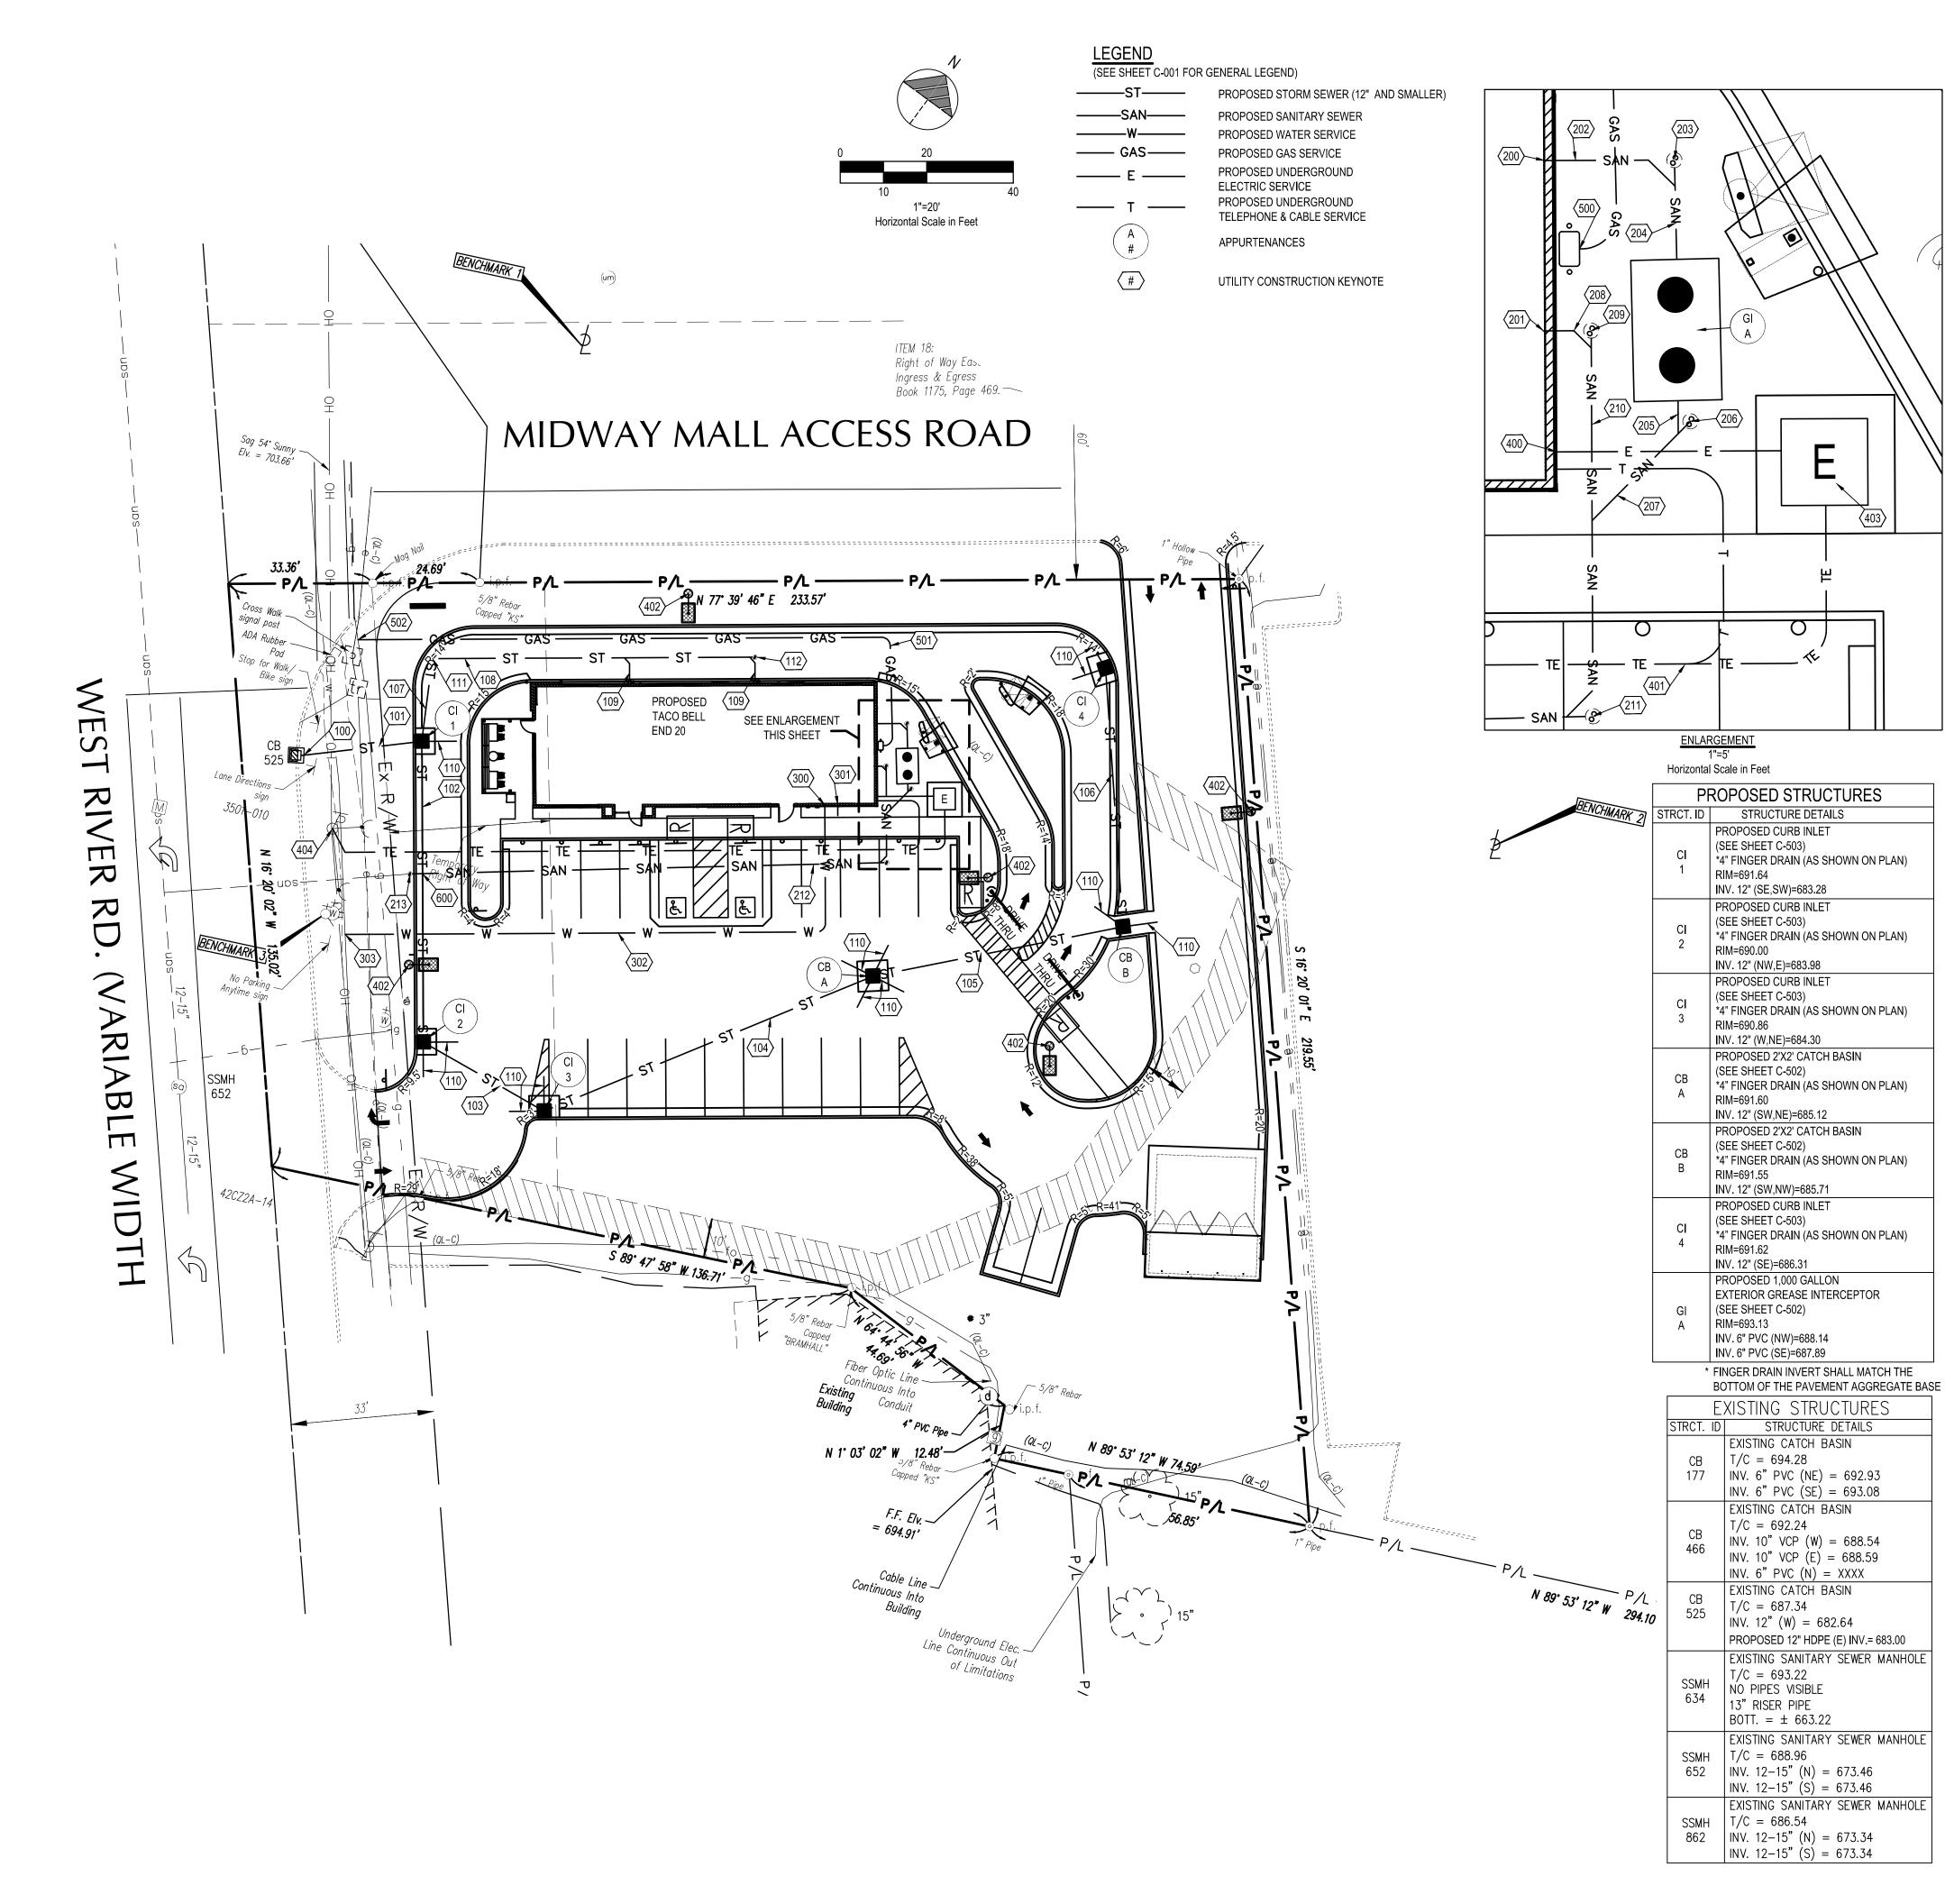
STORE NUMBER:

TACO BELL 1551 WEST RIVER ROAD

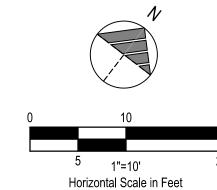

ENDEAVOR

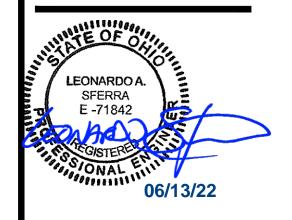GRADING PLAN



| PLAN KEYNOTES (#)

100. PROPOSED CONNECTION TO EXISTING CURB INLET. CONNECTION SHALL BE A WATER TIGHT.

101. PROPOSED 28 L.F. OF 12" HDPE STORM SEWER @ 1.00%.

102. PROPOSED 69.50 L.F. OF 12" HDPE STORM SEWER @ 1.00%. 103. PROPOSED 32 L.F. OF 12" HDPE STORM SEWER @ 1.00%.

104. PROPOSED 82 L.F. OF 12" HDPE STORM SEWER @ 1.00%.

105. PROPOSED 59 L.F. OF 12" HDPE STORM SEWER @ 1.00%.

106. PROPOSED 60 L.F. OF 12" HDPE STORM SEWER @ 1.00%.

107. PROPOSED 19 L.F. OF 6" PVC SDR 35 STORM SEWER @ 1.00%.

108. PROPOSED 75 L.F. OF 6" PVC SDR 35 STORM SEWER @ 1.00%. 109. PROPOSED 6 L.F. OF 6" PVC SDR 35 STORM SEWER @ 1.00%.

110. PROPOSED FINGER DRAIN, SEE DETAIL SHEET C-502. 111. PROPOSED STORM CLEANOUT AND WYE CONNECTION, SEE DETAIL SHEET C-502.

RIM = 691.97, 6" INV. (SE,NE)=683.69. 112. PROPOSED STORM CLEANOUT AND WYE CONNECTION, SEE DETAIL SHEET C-502.

RIM = 692.58, 6" INV. (SW)=684.44.

SANITARY

200. PROPOSED SANITARY CONNECTION TO GREASE INTERCEPTOR INV.=688.25. COORDINATE WITH PLUMBING PLANS.

201. PROPOSED SANITARY CONNECTION INV.=688.25. COORDINATE WITH PLUMBING PLANS. 202. PROPOSED 5 L.F. OF 6" PVC SDR 35 SANITARY SEWER @ 1.00%.

203. PROPOSED SANITARY CLEANOUT AND WYE CONNECTION. SEE DETAIL SHEET C-502. RIM=693.15, INV=688.20.

204. PROPOSED 6 L.F. OF 6" PVC SDR 35 SANITARY SEWER @ 1.00%.

205. PROPOSED 2 L.F. OF 6" PVC SDR 35 SANITARY SEWER @ 1.00%.

206. PROPOSED SANITARY CLEANOUT AND WYE CONNECTION. SEE DETAIL SHEET C-502. RIM= 693.05, INV=687.87.

207. PROPOSED 8 L.F. OF 6" PVC SDR 35 SANITARY SEWER @ 1.00%.

208. PROPOSED 3 L.F. OF 6" PVC SDR 35 SANITARY SEWER @ 3.30%.

209. PROPOSED SANITARY CLEANOUT AND WYE CONNECTION. SEE DETAIL SHEET C-502. RIM=693.20, INV=688.15.

210. PROPOSED 23 L.F. OF 6" PVC SDR 35 SANITARY SEWER @ 3.30%. 211. PROPOSED SANITARY CLEANOUT AND WYE CONNECTION. SEE DETAIL SHEET C-502.

RIM=692.60, INV=687.40. 212. PROPOSED 110 L.F. OF 6" PVC SDR 35 SANITARY SEWER @ 1.00%.

213. PROPOSED SANITARY CLEANOUT AND WYE CONNECTION TO EXISTING SEWER LATERAL. RIM=691.80, INV.=686.70. SEE DETAIL SHEET C-502. CONTRACTOR SHALL FIELD VERIFY EXISTING SANITARY LATERAL LOCATION, SIZE, INVERT AND CONDITION BEFORE START OF ANY SANITARY WORK. CONTRACTOR TO INFORM CONSTRUCTION / PROJECT MANAGER IF POSITIVE DRAINAGE CANNOT BE MAINTAINED. COORDINATE ALL WORK WITH CITY OF ELYRIA.

300. PROPOSED WATER CONNECTION. COORDINATE WITH PLUMBING PLANS. 301. PROPOSED 1" IRRIGATION TAP. COORDINATE WITH PLUMBING PLANS.

302. PPROPOSED 140 L.F. 1-1/2"" TYPE K COPPER WATER SERVICE LINE.

303. PROPOSED WATER SERVICE TAP PER CITY OF ELYRIA STANDARDS AND SPECIFICATIONS

PROPOSED WATER METER AND BACKFLOW PREVENTOR INSIDE BUILDING PER CITY OF ELYRIA STANDARDS AND SPECIFICATIONS. BACKFLOW PREVENTOR SHALL BE LOCATED AFTER THE METER.

ELECTRIC AND COMMUNICATIONS

400. PROPOSED ELECTRIC METER PER ELECTRIC COMPANY SPECIFICATIONS. SEE BUILDING DRAWINGS FOR EXACT LOCATION, ELECTRIC SERVICE LINE TO BE COORDINATED WITH THE

401. PROPOSED ELECTRIC AND TELECOMMUNICATIONS SERVICE CONNECTION TO BE COORDINATED WITH THE UTILITY COMPANIES.

402. PROPOSED LIGHT POLE. SEE ELECTRICAL DRAWINGS FOR SPECIFICATIONS AND DETAILS. 403. PROPOSED ELECTRICAL TRANSFORMER PER ELECTRICAL COMPANY SPECIFICATIONS. G.C.

TO VERIFY EXACT LOCATION AND SIZE WITH UTILITY ENGINEER. 404. PROPOSED ELECTRICAL SERVICE CONNECTION. COORDINATE ALL WORK WITH UTILITY

GAS
500. PROPOSED GAS METER PER GAS COMPANY SPECIFICATIONS. SEE BUILDING DRAWINGS FOR EXACT LOCATION. GAS SERVICE LINE TO BE COORDINATED WITH THE GAS COMPANY.

501. PROPOSED 149 L.F. GAS SERVICE LINE. 502. PROPOSED GAS SERVICE CONNECTION. COORDINATED ALL WORK WITH THE GAS COMPANY.

UTILITY CROSSINGS

COMPANY.

CONTRACTOR SHALL COORDINATE ALL CROSSINGS/RELOCATIONS WITH THE

RESPECTIVE UTILITY COMPANIES. EXISTING AND PROPOSED PRESSURIZED (WATER & GAS) AND SECONDARY (ELECTRIC

& COMMUNICATIONS) UTILITIES SHALL DEFLECT TO MAINTAIN 18" CLEAR AT SANITARY OR STORM SEWER CROSSINGS WHEN CONFLICTS OCCUR. WHEN A PROPOSED PRESSURIZED/SECONDARY UTILITY IS IN CROSSING CONFLICT WITH AN EXISTING PRESSURIZED/SECONDARY UTILITY, THE PROPOSED UTILITY

SHALL DEFLECT TO OBTAIN MINIMUM CLEARANCE.

CONTRACTOR SHALL FIELD LOCATE EXISTING PRESSURIZED/SECONDARY UTILITIES

FOR CLEARANCE BETWEEN PIPES OF LESS THAN 18", THE CONTRACTOR SHALL PROVIDE CONCRETE ENCASEMENT PER SHEET C-503.

PROP. 6" PVC SAN. INV. = 686.73
PROP. 12" STORM INV. = 683.59



BENCHMARKS:

BASIS OF BEARING:

STATE PLANE GRID NORTH, NAD 83 (2011), OHIO NORTH ZONE. ELEVATIONS ARE NAVD 88, GEOID 18. TIED BY GPS TO THE O.D.O.T. VRS.

BENCHMARK #1 - BOX CUT ON SOUTH SIDE OF LIGHT POLE BASE. N: 630445

E: 2076365 ELEVATION = 693.48

ELEVATION = 690.25

BENCHMARK #2 - BENCH MARK ON SOUTH WEST ANCHOR BOLT OF LIGHT POLE.


E: 2076596 ELEVATION = 695.00

BENCHMARK #3 - BENCH MARK ON EAST BONNET BOLT. N: 630304 E: 2076335



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TACO BELL

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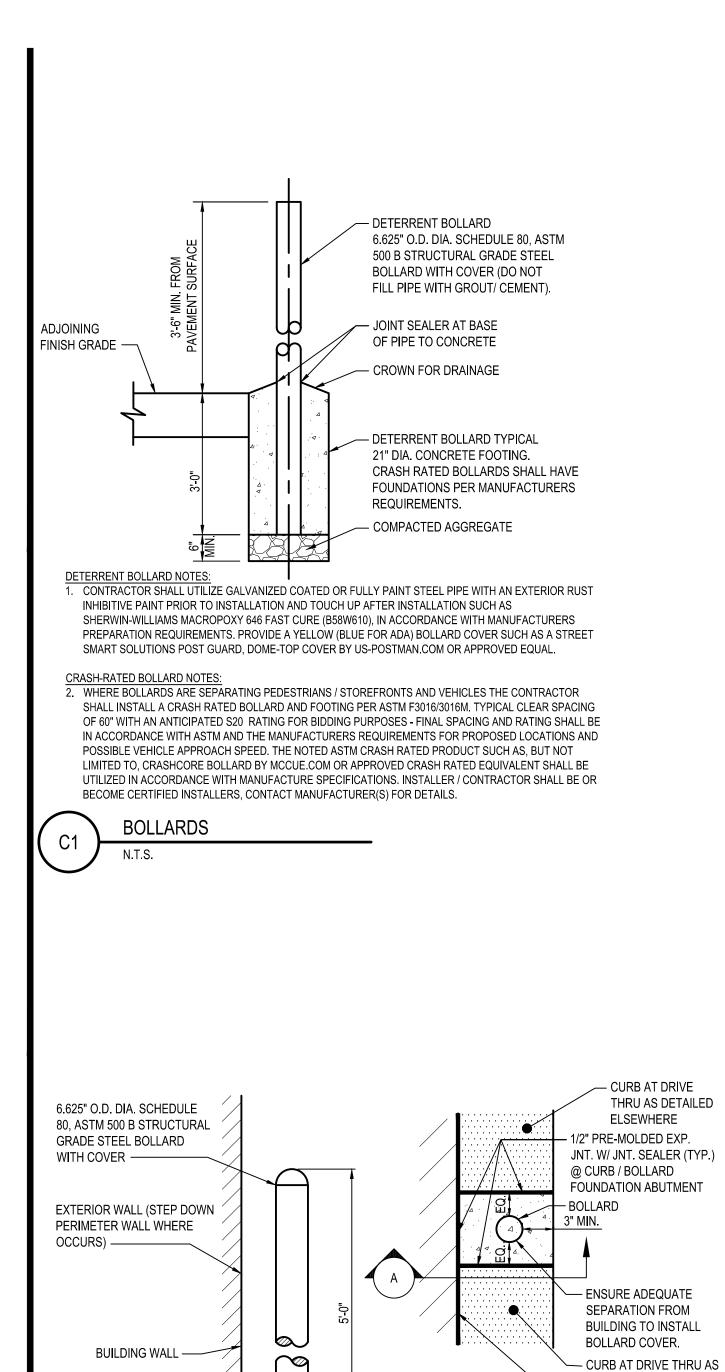
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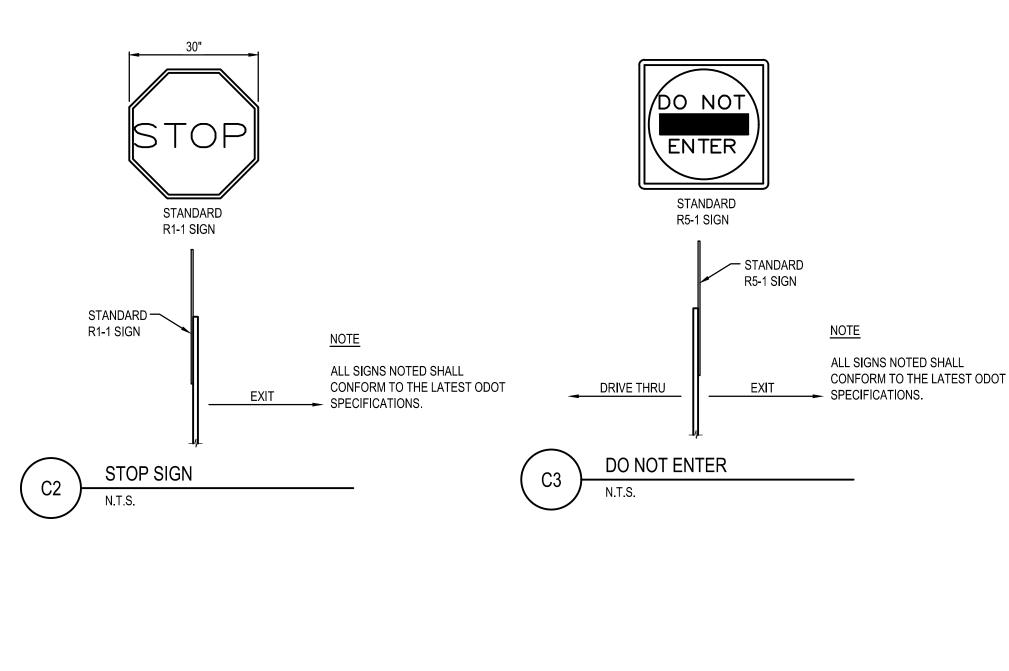
STORE NUMBER:
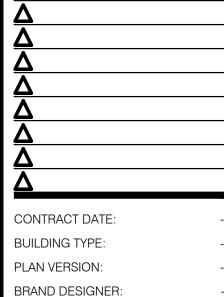
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UTILITY PLAN







— 12" YELLOW

STRIPE

STRIPE

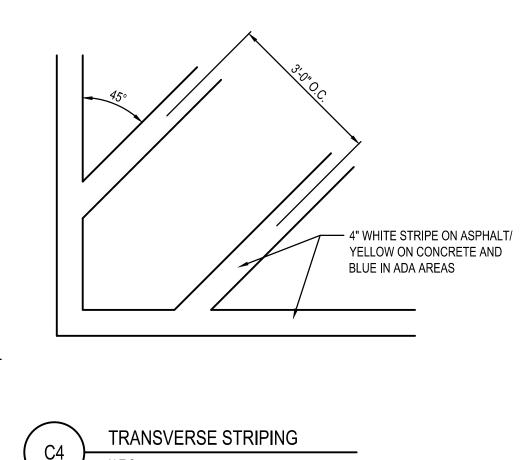

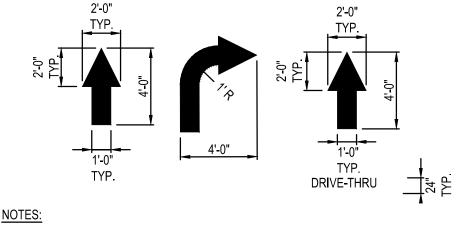


ALL PAVEMENT MARKINGS TO BE WHITE PAVEMENT PAINT, UNLESS STATED OTHERWISE. ALL PAVEMENT MARKINGS WITHIN ADA AREAS SHALL BE PAINTED BLUE EXCEPT FOR COLORS DEFINED ON THE ADA PAVEMENT SYMBOL.


MARKING (STRIPING) PAINT FOR PARKING SPACES, TRAFFIC ARROWS, ADA PARKING AND SYMBOLS, ETC., PER LOCAL REQUIREMENTS AND AS FOLLOWS:


PAVEMENT MARKINGS SHALL BE PER ODOT ITEM 642 TYPE 1.


PROVIDE A NON-SLIP AGGREGATE ADDITIVE TO MARKING PAINT USED AT ADA ACCESS

APPLY 2 COATS WITH STRAIGHT EDGES, YELLOW ON CONCRETE/WHITE ON ASPHALT EXCEPT WHEN MATCHING ADJACENT OR EXISTING COLOR WHEN THE PAVING IS AN EXPANSION OR SEGMENT OF A LARGER LOT. CONTRACTOR SHALL APPLY THE SECOND COAT NO SOONER THAN 30 DAYS OF APPLYING THE FIRST COAT.

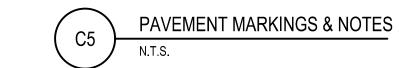

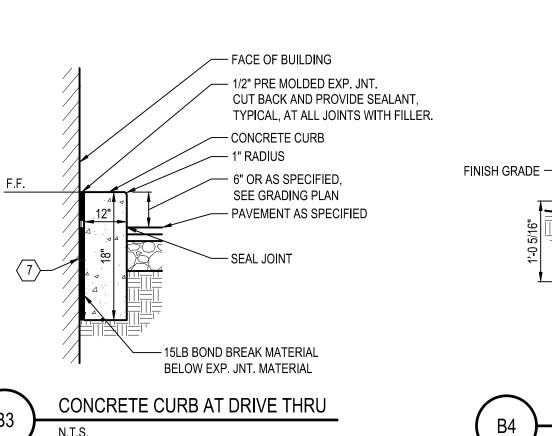

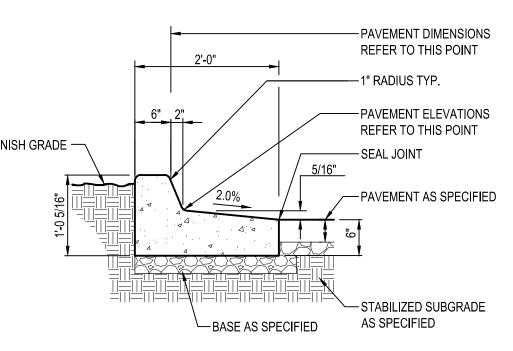


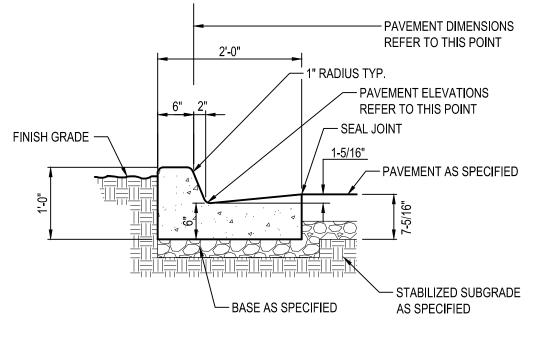



— 4" CONC. CURBED WALK



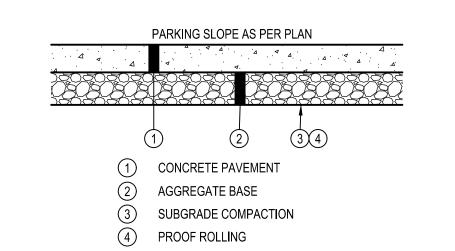

NOTES:

DETAILED ELSEWHERE

- BUILDING WALL

PROP. PAVEMENT AND

AGGREGATE BASE AS INDICATED ELSEWHERE

- 1/2" PRE-MOLDED EXP. JOINT

WITH JOINT SEALER CONT.

- CONCRETE

FOOTER

BUILDING FÖOTER

CONTRACTOR SHALL UTILIZE GALVANIZED COATED OR FULLY PAINT STEEL PIPE

AFTER INSTALLATION SUCH AS SHERWIN-WILLIAMS MACROPOXY 646 FAST CURE

(B58W610), IN ACCORDANCE WITH MANUFACTURERS PREPARATION

WITH AN EXTERIOR RUST INHIBITIVE PAINT PRIOR TO INSTALLATION AND TOUCH UP

REQUIREMENTS. PROVIDE A YELLOW (BLUE FOR ADA) BOLLARD COVER SUCH AS A

STREET SMART SOLUTIONS POST GUARD, DOME-TOP COVER BY US-POSTMAN.COM

DETERRENT BOLLARD IN CURB

SECTION A

FOUNDATION WALL-


OR APPROVED EQUAL.

1. APPLY LIQUID ASPHALT AT ALL JOINTS BETWEEN CONCRETE AND ASPHALT. APPLY CONCRETE SEALANT CONFORMING TO ASTM D6690 WHERE PROPOSED CONCRETE MEETS EXISTING CONCRETE.

TYPICAL CONCRETE PAVEMENT SECTION

2. SEE SITE PLAN FOR PAVEMENT THICKNESSES AND REINFORCEMENT. 3. CONCRETE PAVEMENT SHALL HAVE CONTROL JOINTS PER CONCRETE NOTES SHEET C-001.

CROSSWALK STRIPING

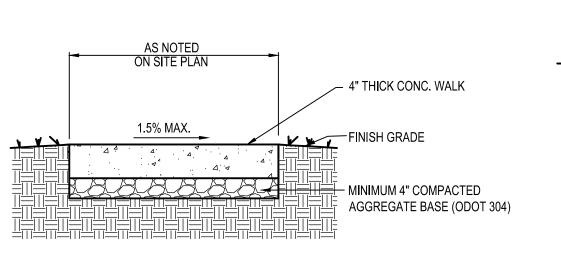

1. CONTRACTOR SHALL INSTALL 1/2" PRE-FORMED EXPANSION JOINT MATERIAL AND JOINT SEALER WHERE PAVEMENT ABUTS BUILDING.

CONCRETE WALK


2. SEE SHEET C-001 FOR FIBER REINFORCEMENT NOTES. 2. SEE SHEET C-001 FOR FIBER REINFORCEMENT NOTES.


CONCRETE CURBED WALK


- FACE OF BUILDING

WIDTH AS NOTED ON SITE PLAN

1.5% MAX.

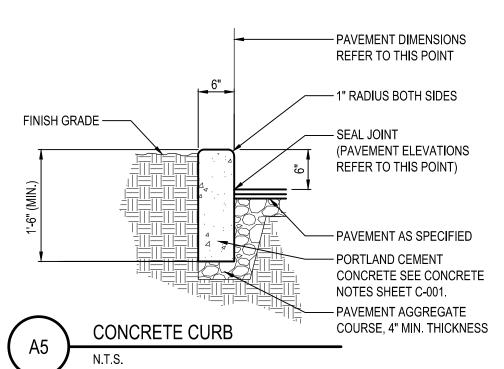

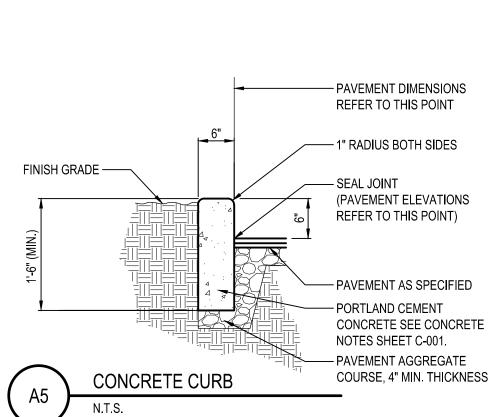


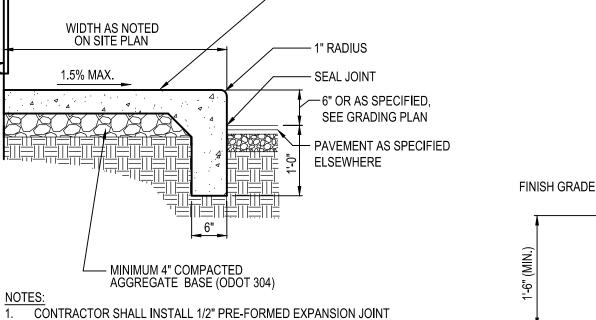

MATERIAL AND JOINT SEALER WHERE PAVEMENT ABUTS BUILDING.

AGGREGATE BASE (ODOT 304)

- MINIMUM 4" COMPACTED

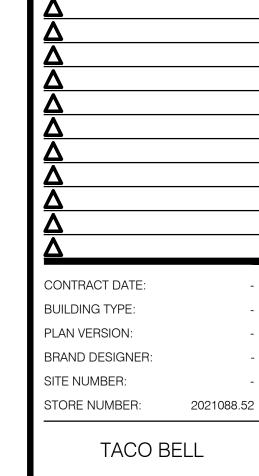

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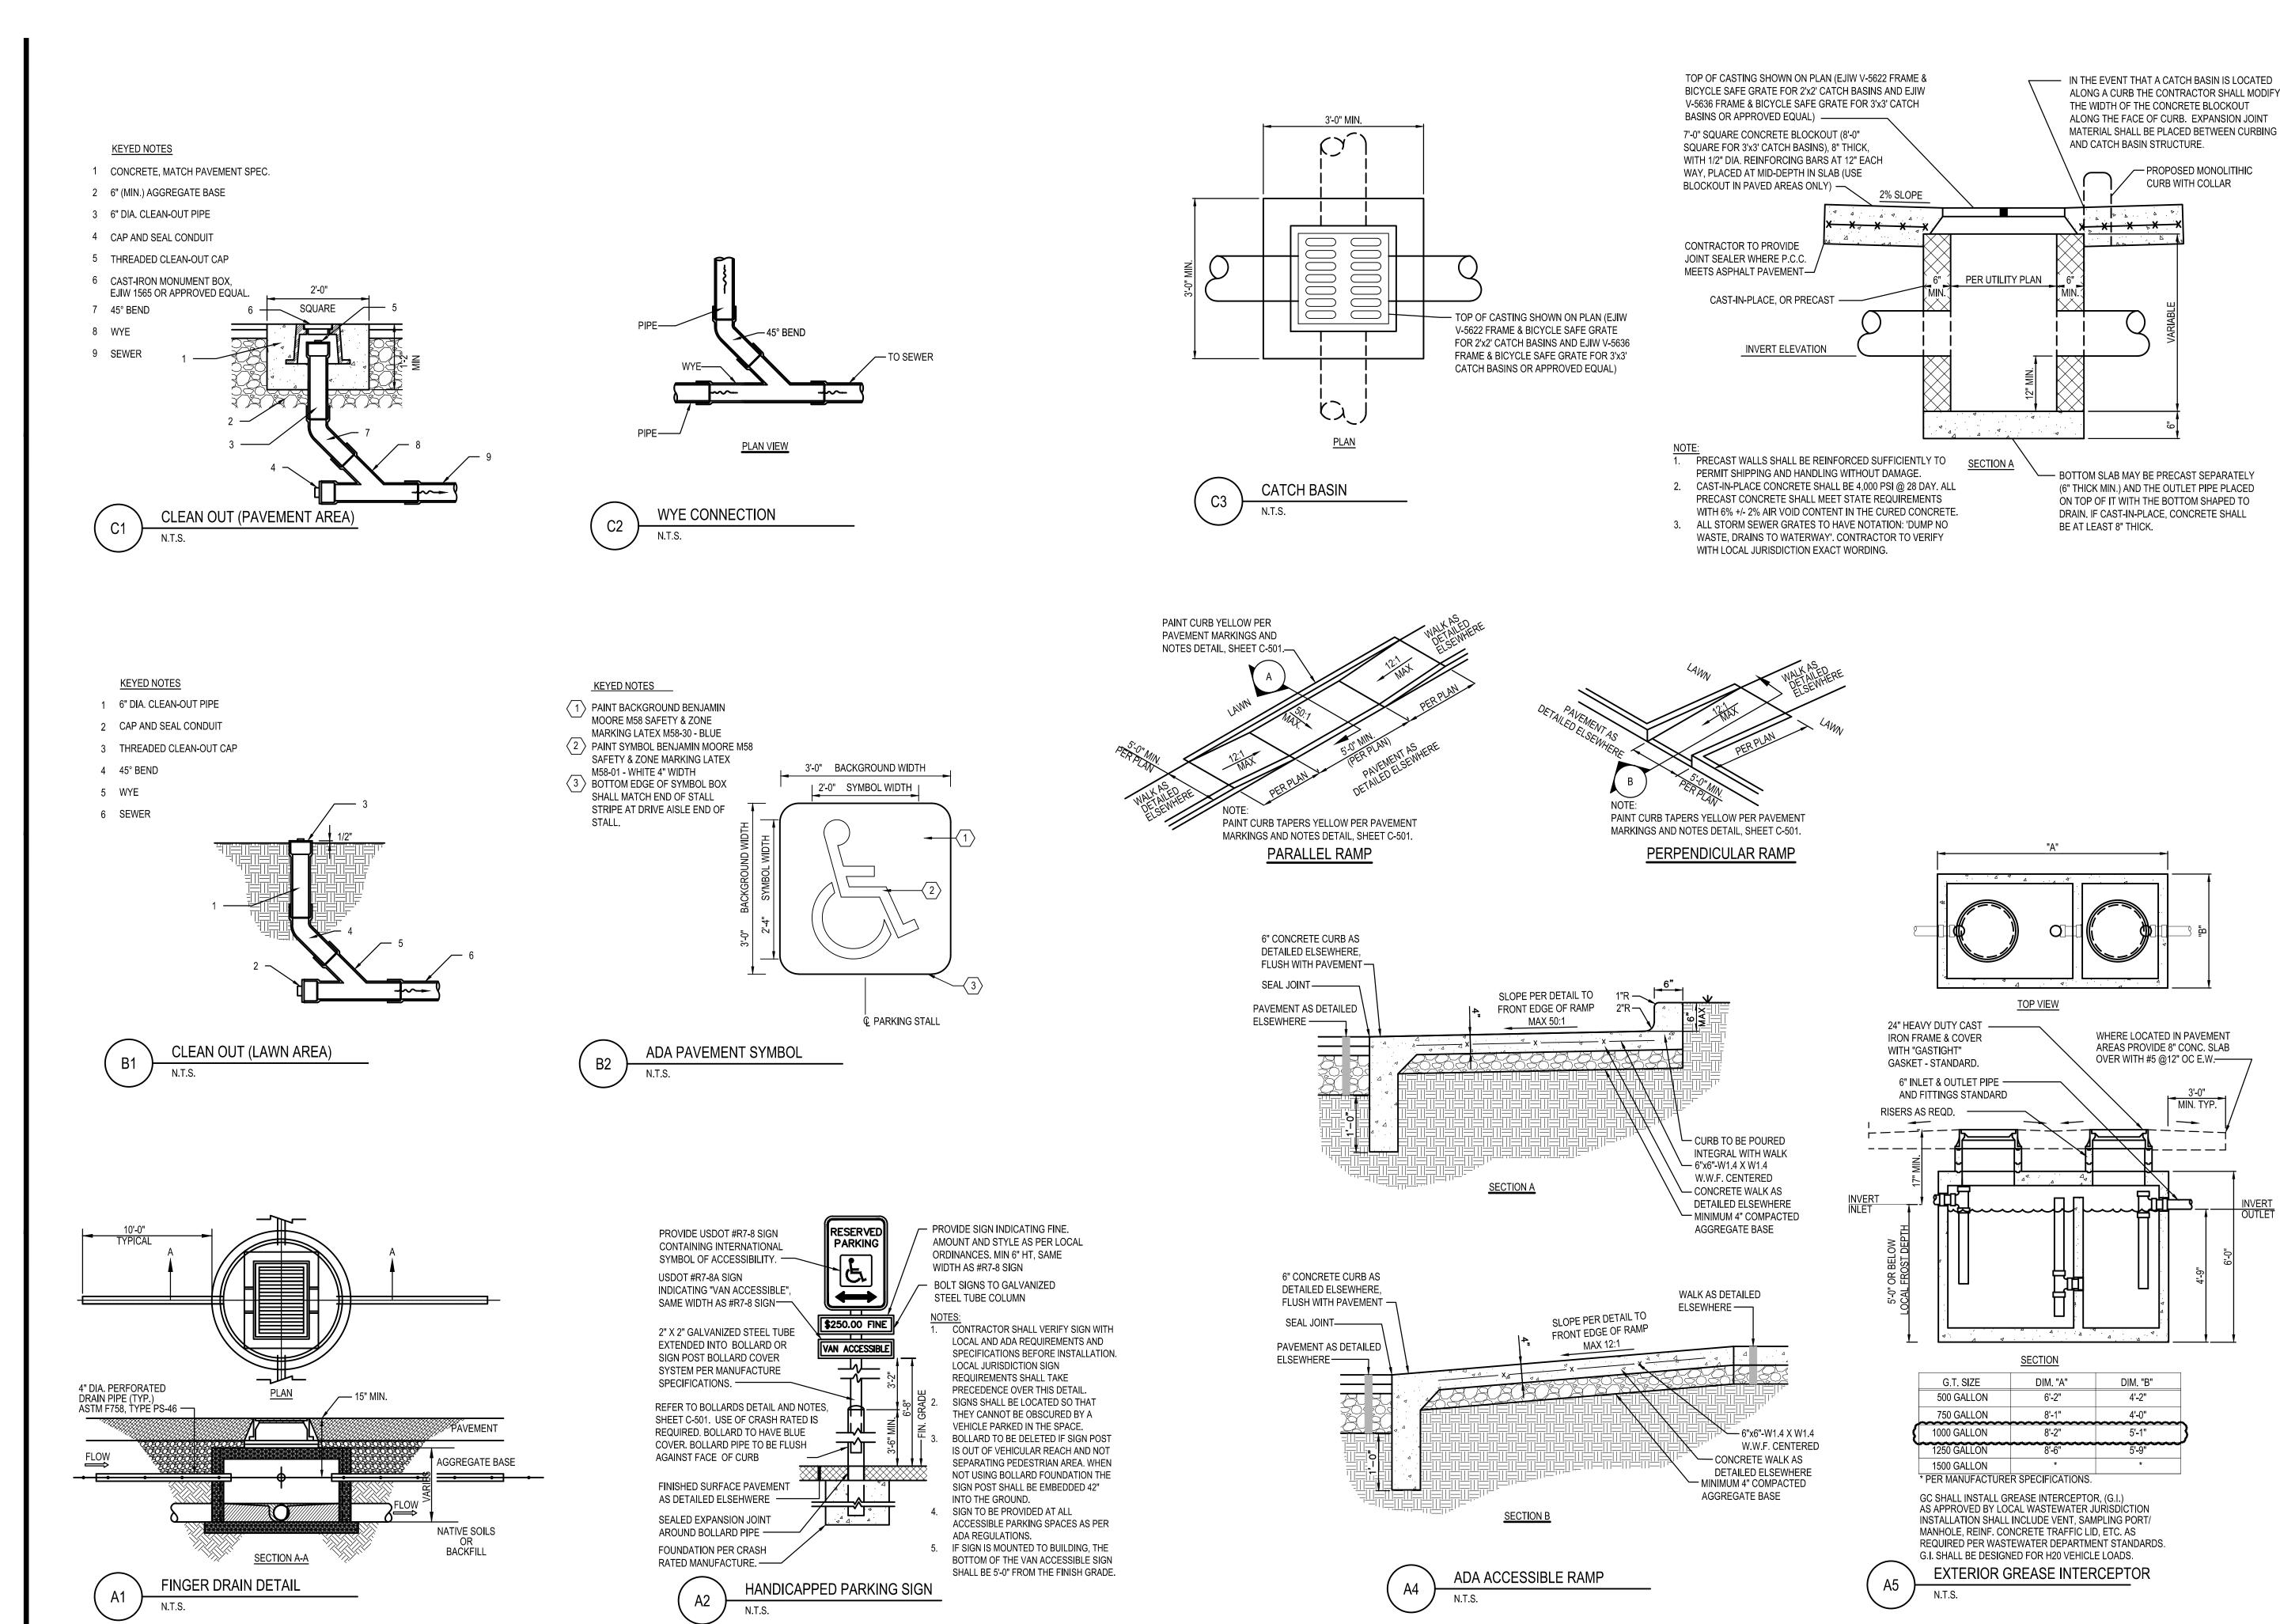
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ELYRIA, OHIO 44035





DETAILS





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TACO BELL

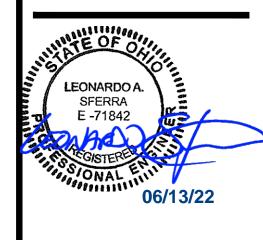
1551 WEST RIVER ROAD ELYRIA, OHIO 44035
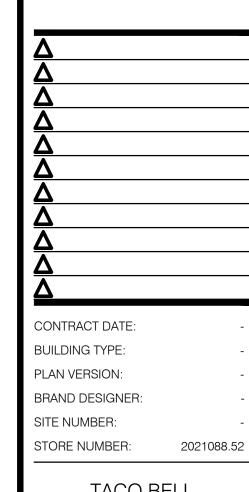
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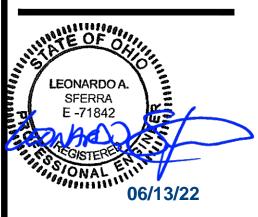
ENDEAVOR 2.0


DETAILS

C-502



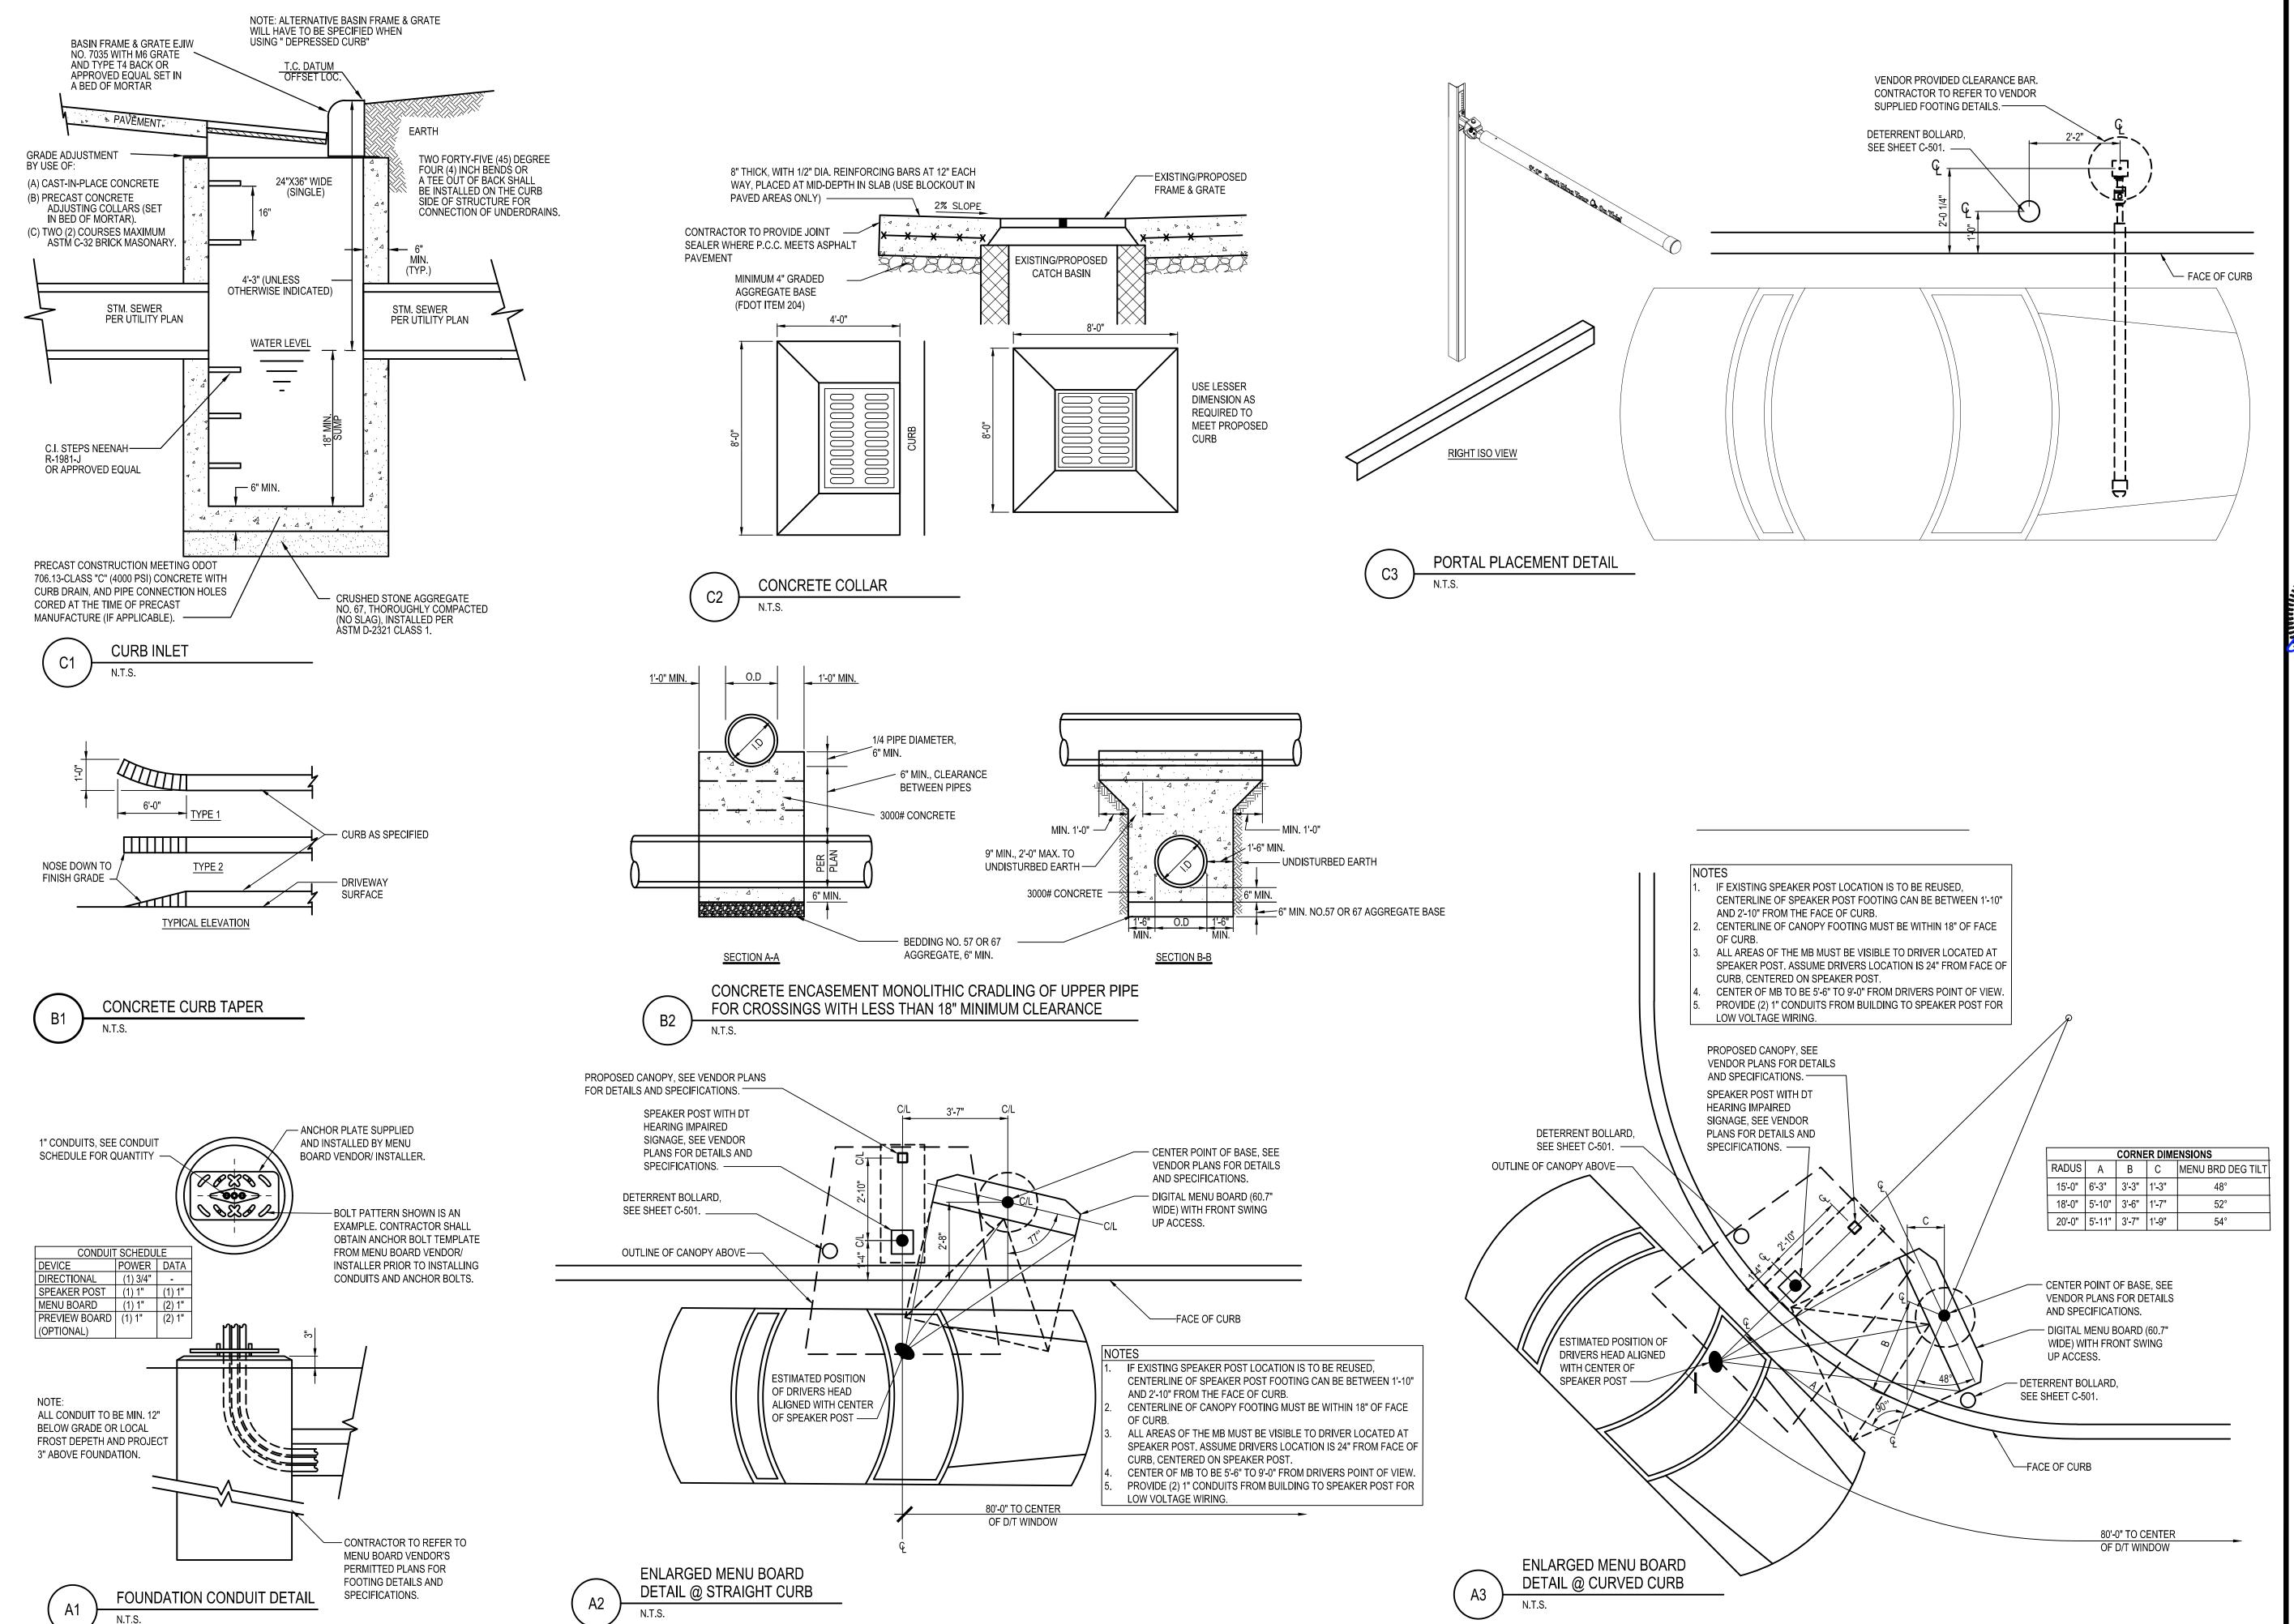



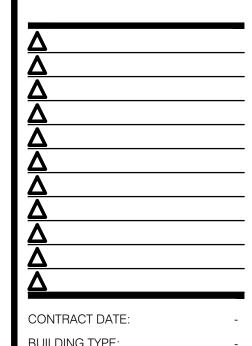

CONTRACT DATE:
BUILDING TYPE:
PLAN VERSION:
BRAND DESIGNER:

SITE NUMBER:
STORE NUMBER:

TACO BELL

2021088.52

1551 WEST RIVER ROAD ELYRIA, OHIO 44035



DETAILS

C-503

SCOPE OF WORK

- 1. THIS WORK SHALL CONSIST OF PERFORMING CLEARING AND GRUBBING, SOIL PREPARATION, FINISH GRADING, PLANTING AND DRAINAGE, INCLUDING ALL LABOR, MATERIALS, TOOLS, EQUIPMENT, AND ANY OTHER APPURTENANCES NECESSARY FOR THE COMPLETION OF THIS PROJECT.
- 2. QUANTITY TAKEOFF IS SUPPLIED FOR CONTRACTOR'S ASSISTANCE ONLY. CONTRACTOR IS RESPONSIBLE FOR SUPPLYING ALL PLANT MATERIALS AS PER PLAN.
- 3. NO ADDITIONAL COMPENSATION SHALL BE PAID TO THE CONTRACTOR FOR DAMAGE AND REPAIR WITHIN EASEMENT OR RIGHT-OF-WAY LIMITS.

PRESERVATION/PROTECTION (IF APPLICABLE)

- CONTRACTOR SHALL MAINTAIN AND PRESERVE TREES AND SHRUBS NOT BEING REMOVED, INCLUDING THEIR ROOTS. TREE PROTECTION FENCING SHALL BE USED AT THE DRIP LINE OF ALL TREES AND SHRUBS WITHIN 50 FEET OF CONSTRUCTION EXCEPT AS SHOWN ON PLAN. FENCING SHALL REMAIN IN PLACE UNTIL FINAL PLANT INSPECTION FOLLOWING CONSTRUCTION. MATERIALS SHALL NOT BE STOCKPILED WITHIN THIS DEFINED AREA AND VEHICLES AND OTHER EQUIPMENT SHALL BE OPERATED TO AVOID SOIL COMPACTION.
- 2. FEEDER ROOTS SHOULD NOT BE CUT IN AN AREA EQUAL TO TWICE THE TREE CIRCUMFERENCE (MEASURED 6" ABOVE THE GROUND LINE IN INCHES) EXPRESSED IN FEET. (EXAMPLE: A CIRCUMFERENCE OF 10" WOULD HAVE A 'NO CUT' ZONE OF 20 FEET IN ALL DIRECTIONS FROM THE TREE). THIS SHOULD APPLY TO UTILITY SERVICES, IF FEASIBLE. THE ONLY EXCEPTION TO THIS REQUIREMENT WILL BE THOSE SPECIFICALLY ALLOWED BY THE LANDSCAPE ARCHITECT, SPECIFICATIONS OR AS INDICATION ON THE PLANS.
- 3. TREE TRUNKS AND EXPOSED ROOTS DAMAGED DURING EQUIPMENT OPERATIONS SHALL BE TREATED IN ACCORDANCE WITH THE ARBOR CULTURAL STANDARDS OF THE CITY.

PLANT MATERIALS

- GENERAL ALL MATERIALS SHALL BE OF ITS KIND AVAILABLE AND SHALL HAVE BEEN GROWN IN A CLIMATE SIMILAR TO THAT ON SITE.
- 2. PLANTS ALL PLANTS SHALL BE HEALTHY, OF NORMAL GROWTH, WELL ROOTED, FREE FROM DISEASE AND INSECTS. QUALITY AND SIZE OF PLANT MATERIAL SHALL CONFORM TO ANSI Z60.1 "AMERICAN STANDARDS FOR NURSERY STOCK".
- 3. VARIETIES AND SIZES OF PLANTS SHALL BE AS SHOWN ON DRAWINGS.
- . PLANTS SHALL BE IN A HEALTHY, VIGOROUS CONDITION, FREE OF DEAD OR BROKEN BRANCHES, SCARS THAT ARE NOT COMPLETELY HEALED, FROST CRACKS, DISFIGURING KNOTS, BROKEN OR ABRADED BARK, REDUNDANT LEADERS OR BRANCHES, OR ABERRATIONS OF ANY KIND. PLANTS SHALL NOT HAVE MULTIPLE LEADERS, UNLESS THIS IS THE NATURAL FORM.
- 5. BALLED AND BURLAPPED (B&B) PLANTS SHALL BE DUG WITH A FIRM ROOT BALL OF NATURAL EARTH, OF A SIZE IN PROPORTION TO THE PLANT'S SIZE, AS MEASURED BY CALIPER, HEIGHT, OR SPREAD. BALLED AND BURLAPPED PLANTS SHALL BE HANDLED ONLY BY THE ROOT BALL, NOT BY THE TRUNK OR BRANCHES, AS THIS MAY BREAK OR LOOSEN THE ROOT BALL AND DAMAGE THE ROOT SYSTEM. CONTAINER PLANTS SHALL HAVE BEEN ESTABLISHED FOR A MINIMUM OF ONE FULL GROWING SEASON IN THEIR CONTAINERS BEFORE INSTALLATION. CONTAINER PLANTS SHALL BE HANDLED ONLY BY THE CONTAINER, NOT BY THE STEMS OR BRANCHES, AS THIS MAY PULL THE PLANT OUT OF THE CONTAINER AND BREAK OR LOOSEN THE ROOT BALL AND DAMAGE THE ROOT SYSTEM.
- 6. PLANTS SHALL BE PROTECTED FROM DRYING OUT DURING SHIPPING WITH TARPAULINS OR OTHER COVERINGS. PLANTS SHALL BE PROTECTED FROM DRYING OUT AFTER DELIVERY BY PLANTING IMMEDIATELY; IF THIS IS NOT POSSIBLE, THE ROOT BALL SHALL BE COVERED WITH PEAT MOSS OR EARTH, AND WATERED FREQUENTLY TO KEEP IT MOIST UNTIL PLANTING.
- 7. DO NOT HANDLE, MOVE, BIND, TIE OR OTHERWISE TREAT PLANTS SO AS TO DAMAGE THE ROOT BALL, ROOTS, TRUNK, OR BRANCHES IN ANY WAY.

TOPSO

- TOPSOIL HAS BEEN (OR WILL BE) STOCKPILED FOR REUSE IN LANDSCAPE WORK. IF QUANTITY OF STOCKPILED TOPSOIL IS INSUFFICIENT, PROVIDE ADDITIONAL TOPSOIL AS REQUIRED TO COMPLETE LANDSCAPE WORK. IMPORTED TOPSOIL SHALL CONSIST OF LOOSE, FRIABLE, LOAMY TOPSOIL WITHOUT ADMIXTURE OF SUBSOIL OR REFUSE. ACCEPTABLE TOPSOIL SHALL CONTAIN NOT LESS THAN 3 PERCENT NOR MORE THAN 20 PERCENT ORGANIC MATTER.
- 2. PLANTING BACKFILL FOR PARKING LOT ISLANDS SHALL CONSIST OF A HOMOGENEOUS MIXTURE OF 3 PARTS TOPSOIL TO ONE PART SPHAGNUM PEAT INSTALLED OVER A 6" THICKNESS OF NO. 57 AGGREGATE.

SOIL CONDITIONING

- OBTAIN LABORATORY ANALYSIS OF STOCKPILED AND IMPORTED TOPSOIL COMPLETE WITH RECOMMENDATIONS FOR SOIL AMENDMENT.
- BEFORE MIXING, CLEAN TOPSOIL OF ROOTS, PLANTS, SOD, STONES, CLAY LUMPS, AND OTHER EXTRANEOUS MATERIALS HARMFUL OR TOXIC TO PLANT GROWTH.
- MIX SPECIFIED SOIL AMENDMENTS AND FERTILIZERS WITH TOPSOIL AT RATES SPECIFIED BY THE LAB REPORT. DELAY MIXING OF FERTILIZER IF PLANTING WILL NOT FOLLOW PLACING OF PLANTING SOIL WITHIN A FEW DAYS.
- 4. FOR PLANTING BEDS AND LAWNS, MIX PLANTING SOIL EITHER PRIOR TO PLANTING OR APPLY ON SURFACE OF TOPSOIL AND MIX THOROUGHLY BEFORE PLANTING. MIX LIME WITH DRY SOIL PRIOR TO MIXING OF FERTILIZER.
- 5. PREVENT LIME FROM CONTACTING ROOTS OF ACID-LOVING PLANTS.
- 6. APPLY PHOSPHORIC ACID FERTILIZER (OTHER THAN THAT CONSTITUTING A PORTION OF COMPLETE FERTILIZERS) DIRECTLY TO SUBGRADE BEFORE APPLYING PLANTING SOIL AND TILLING.

PLANTING SOIL

1. PLANTING SOIL MIX SHALL BE CLEAR OF ALL STONES AND DEBRIS 1" OR LARGER, AND CONSIST OF THE FOLLOWING: 25% ORGANIC COMPOST, 75% ACCEPTABLE TOPSOIL.

OTHER MATERIALS

- 1. BED EDGING EDGING SHALL BE 4" STEEL EDGING WITH THREE (3) METAL ANCHOR STAKES PER 20 FOOT SECTION. ALL MASS PLANTING BEDS SHALL HAVE EDGING PLACED BETWEEN MULCH AREA AND ANY ADJACENT TURF AREA.
- 2. MULCH: ORGANIC MULCH FREE FROM DELETERIOUS MATERIALS AND SUITABLE FOR TOP DRESSING OF TREES, SHRUBS, OR PLANTS AND CONSISTING OF THE FOLLOWING:
 - RIVER ROCK MULCH AREA: AGGREGATE MULCH, 3/4"-2" IN SIZE, WASHED AND ROUNDED, SHALL BE INSTALLED WITHIN THE RIVER ROCK MULCH AREA PER THE PLAN. RIVER ROCK MULCH SHALL BE INSTALLED AT 3" INCHES DEPTH.
 - b. NON-DRYED, DOUBLE SHREDDED HARDWOOD SHALL BE INSTALLED IN ALL OTHER LANDSCAPE BEDS OUTSIDE OF THE RIVER ROCK MULCH AREA AT A DEPTH OF 3 INCHES.

GENERAL WORK PROCEDURES

- 1. LANDSCAPE WORK SHALL BE ACCORDING TO THE WORKMANLIKE STANDARDS ESTABLISHED FOR LANDSCAPE CONSTRUCTION AND PLANTING IN THE OHIO STANDARDIZED LANDSCAPE SPECIFICATIONS (ASLA) AND ANY LOCAL LANDSCAPE ORDINANCES.
- 2. CONTRACTOR SHALL OBTAIN A COPY OF LOCAL ORDINANCES REGARDING ACCEPTABLE PLANT AND PLANTING DETAILS AND ABIDE BY THOSE ORDINANCES AND DETAILS.
- 3. ENGINEER RESERVES THE RIGHT TO REJECT ALL PLANT MATERIAL DEEMED NOT ACCEPTABLE.
- 4. ANY PROPOSED PLANT SUBSTITUTIONS SHALL BE EQUIVALENT IN FORM, HABIT, STRUCTURE, BRANCHING AND LEAF TYPE AND MUST BE ISSUED TO THE LANDSCAPE ARCHITECT FOR APPROVAL, IN WRITING, PRIOR TO INSTALLATION.

WEEDING

1. BEFORE AND DURING PRELIMINARY GRADING AND FINISH GRADING, ALL WEEDS AND GRASSES SHALL BE DUG OUT BY THE ROOTS AND DISPOSED OF AT THE CONTRACTOR'S EXPENSE.

<u>PLANTING</u>

- 1. POSITION TREES AND SHRUBS AT THEIR INTENDED LOCATIONS AS PER THE PLANS AND SECURE THE APPROVAL OF THE OWNER BEFORE EXCAVATING PITS, MAKING NECESSARY ADJUSTMENTS AS DIRECTED.
- 2. PLANTING PITS SHALL BE AS PER DETAILS.
- 3. PREPARED SOIL SHALL BE TAMPED FIRMLY AT BOTTOM OF PIT. FILL WITH PLANTING SOIL AROUND BALL OF PLANT. COMPLETE BACKFILLING AND WATER THOROUGHLY.
- 4. EACH TREE AND SHRUB SHALL RECEIVE THE LANDSCAPER'S BIONUTRITION (3-0-3) GRANULAR WITH MYCORRHIZAL TECHNOLOGY FERTILIZER OR APPROVED OTHER. APPLY FERTILIZER PER MANUFACTURER'S SPECIFICATIONS.
- 5. WATER IMMEDIATELY AFTER PLANTING. WATER SHALL BE APPLIED TO EACH TREE AND SHRUB IN SUCH MANNER AS NOT TO DISTURB BACKFILL AND TO THE EXTENT THAT ALL MATERIALS IN THE PLANTING HOLE ARE THOROUGHLY SATURATED.
- 6. INSTALL BED EDGING AND MULCH PER MATERIALS SPECIFICATION AND DETAILS.
- 7. REMOVE ALL SALES TAGS, STRINGS, STRAPS, WIRE, ROPE OR OTHER MATERIALS THAT MAY INHIBIT PLANT GROWTH BOTH ABOVE AND BELOW THE SURFACE OF THE SOIL.
- 8. REMOVE ANY BROKEN, SUCKERING, DISEASED, CRISSCROSSED OR AESTHETICALLY DISPLEASING BRANCHES BACK TO LIVE LEADER OR SIDE LATERAL WITH A FLUSH CUT.

FINISH GRADING

- 1. ALL AREAS WILL BE GRADED BY THE CONTRACTOR TO SUBSTANTIALLY PLUS/MINUS 0.1 FOOT OF FINISH GRADE.
- 2. ALL LAWN AND PLANTING AREAS SHALL BE GRADED TO A SMOOTH, EVEN, UNIFORM PLANE WITH NO ABRUPT CHANGE OF SURFACE. SOIL AREAS ADJACENT TO THE BUILDINGS SHALL SLOPE AWAY FROM THE BUILDINGS.
- 3. ALL PLANTING AREAS SHALL BE GRADED AND MAINTAINED TO ALLOW FREE FLOW OF SURFACE WATER.
- 4. PARKING LOT ISLAND SHALL BE BACKFILLED AS PART OF THIS CONTRACT.

GROUND COVER

- 1. SPACING AND VARIETY OF GROUND COVER SHALL BE AS SHOWN ON DRAWINGS.
- 2. MULCH GROUND COVER WITH 2" THICKNESS OF SPHAGNUM PEAT.
- 3. IMMEDIATELY AFTER PLANTING GROUND COVER, CONTRACTOR SHALL THOROUGHLY WATER GROUND COVER.
- 4. ALL GROUND COVER AREAS SHALL BE TREATED WITH A PRE-EMERGENT BEFORE FINAL LANDSCAPE INSPECTION. GROUND COVER AREAS SHALL BE WEEDED PRIOR TO APPLYING PRE-EMERGENT. PRE-EMERGENT TO BE APPLIED AS PER MANUFACTURER'S RECOMMENDATION.

<u>GUARANTEE</u>

1. CONTRACTOR SHALL GUARANTEE ALL PLANTS FOR A PERIOD OF ONE (1) YEAR FROM DATE OF PROJECT ACCEPTANCE BY THE OWNER.

CLEANUP

1. UPON THE COMPLETION OF ALL PLANTING WORK AND BEFORE FINAL ACCEPTANCE, THE CONTRACTOR SHALL REMOVE ALL MATERIAL, EQUIPMENT, AND DEBRIS RESULTING FROM HIS WORK. AN 'ACCEPTABLE CONDITION' SHALL BE AS DEFINED AND APPROVED BY THE OWNER'S AUTHORIZED REPRESENTATIVE.

IRRIGATION

1. CONTRACTOR SHALL PROVIDE & INSTALL AN IRRIGATION SYSTEM TO PROVIDE 100% COVERAGE OF THE SITE.

LANDSCAPE NOTES & PLANTING SPECIFICATIONS

- 2. IRRIGATED AREAS WITHIN 5 FEET OF BUILDING WALLS SHALL BE IRRIGATED BY DRIP IRRIGATION OR SIMILAR. CONTRACTOR SHALL ENSURE BUILDING WALLS AND WINDOWS WILL NOT BE DAMAGED OR STAINED BY IMPROPER IRRIGATION INSTALLATION OR POOR SELECTION OF FIXTURES.
- SYSTEM SHALL INCLUDE ALL SPRINKLER FIXTURES, DRIP TUBING, PIPING, VALVES, WIRING AND CONTROLS TO PROVIDE A COMPLETE FUNCTIONAL SYSTEM THAT SHALL COMPLY WITH CITY CODE.
- 5. IRRIGATION CONTRACTOR SHALL PROVIDE A METHOD FOR WINTERIZATION. WINTERIZATION SHALL BE PERFORMED BY CONTRACTOR UPON COMPLETION IF SYSTEM IS INSTALLED BETWEEN NOVEMBER 1 AND MARCH 31.
- 6. PRIOR TO UPDATING THE IRRIGATION SYSTEM, A CERTIFIED IRRIGATION DESIGNER SHALL PROVIDE SHOP DRAWINGS TO ENGINEER FOR APPROVAL.
- 5. UPON APPROVAL OF SHOP DRAWINGS, THE UPDATED IRRIGATION SYSTEM SHALL BE APPROVED BY OWNER FOR FINAL ACCEPTANCE.

MAINTENANCE

- (MAINTENANCE PERIOD TO COMMENCE AFTER FINAL INSPECTION.)
- 1. MAINTENANCE PERIOD FOR THIS CONTRACT SHALL BE 90 CALENDAR DAYS COMMENCING AFTER FINAL INSPECTION OF CONSTRUCTION.
- 2. MAINTAIN TREES, SHRUBS AND OTHER PLANTS BY PRUNING, CULTIVATING AND WEEDING AS REQUIRED FOR HEALTHY GROWTH. RESTORE PLANTING SAUCERS. RESET TREES AND SHRUBS TO PROPER GRADES OR VERTICAL POSITION AS REQUIRED.
- 3. MAINTAIN LAWNS BY WATERING, MOWING, TRIMMING, AND OTHER OPERATIONS SUCH AS ROLLING, REGRADING AND REPLANTING AS REQUIRED TO ESTABLISH A SMOOTH, ACCEPTABLE LAWN, FREE OF ERODED OR BARE AREAS.
- 4. MAINTAIN THE LANDSCAPING BY KEEPING ALL PLANTS DISEASE-FREE AND PLANTING BEDS GROOMED, EXCEPT IN NATURALLY OCCURRING VEGETATION AREAS.
- 5. REPLACE ANY REQUIRED PLANTING(S), WHICH SEVERELY DECLINE OR DIE AFTER THE DATE OF PLANTING. SUCH REPLACEMENT SHALL OCCUR DURING THE NEXT APPROPRIATE PLANTING SEASON.

SODDING

1. SOD SHALL BE FIRST GRADE CERTIFIED BLENDS OF THE FOLLOWING SPECIES PER HARDINESS ZONE CONTAINING NOT MORE THAN 30 PERCENT OF OTHER GRASSES AND CLOVERS, AND FREE FROM ALL NOXIOUS WEEDS.

ZONES 3, 4 & 5: APPROVED BLUE GRASS BLEND
ZONE 6: APPROVED FESCUE BLEND
ZONES 7 & 8: APPROVED BERMUDA BLEND
ZONES 9 & 10: APPROVED ST AUGUSTINE FLORATAM BLEND

- 2. SOD SHALL BE RECENTLY MOWED TO A HEIGHT OF NOT LESS THAN 3 INCHES. IT SHALL BE CUT INTO STRIPS OF NOT LESS THAN 3 FEET AND NOT OVER 6 FT. WITH A UNIFORM WIDTH OF NOT OVER 24 INCHES.
- 3. SOD SHALL BE CUT TO A DEPTH EQUAL TO THE GROWTH OF THE FIBROUS ROOTS BUT IN NO CASE LESS THAN 1 INCH.
- 4. SOD SHALL BE DELIVERED TO THE JOB WITHIN 24 HOURS AFTER BEING CUT AND SHALL BE INSTALLED WITHIN 48 HOURS AFTER BEING CUT.
- 5. BEFORE SOD IS PLACED, THE SOD BED WILL HAVE BEEN EXCAVATED TO SUCH A DEPTH THAT WHEN THE SOD IS IN PLACE THE TOP OF THE SOD WILL BE FLUSH WITH THE SURROUNDING GRADE.
- SOD SHALL BE PLACED NOR SHALL ANY SOD BE PLACED ON FROZEN SOIL. WHEN SOD IS PLACED BETWEEN THE DATES OF JUNE 1ST AND OCTOBER 15TH, IT SHALL BE COVERED IMMEDIATELY WITH A STRAW MULCH 1 INCH THICK (LOOSE MEASUREMENT).

6. NO SOD SHALL BE PLACED WHEN THE TEMPERATURE IS BELOW 32 DEGREES F. NO FROZEN

- 7. AFTER LAYING, THE SOD SHALL BE WATERED THOROUGHLY AND TAMPED WITH APPROVED SOD TAMPERS SUFFICIENTLY TO BRING THE SOD INTO CLOSE CONTACT WITH THE SOD BED AND INSURE TIGHT JOINTS BETWEEN THE SECTIONS OR STRIPS.
- 8. THE CONTRACTOR SHALL KEEP ALL SODDED AREAS INCLUDING SUBGRADE, THOROUGHLY MOIST FOR 30 DAYS AFTER SODDING.
- 9. THE CONTRACTOR SHALL REPAIR ANY AREAS DAMAGED FOLLOWING INSTALLATION AS DIRECTED BY THE ENGINEER. SOD SHALL BE IN PLACE AT LEAST 30 DAYS BEFORE FINAL ACCEPTANCE.

SEEDING

1. GRASS SEED SHALL BE FRESH, CLEAN, DRY, NEW-CROP SEED COMPLYING WITH THE ASSOCIATION OF OFFICIAL SEED ANALYSTS' "RULES FOR TESTING SEEDS" FOR PURITY AND GERMINATION TOLERANCES.

MIN.% MAX.%

2. ALL AREAS TO BE SEEDED SHALL RECEIVE NO LESS THAN FIVE POUNDS OF SEED PER ONE THOUSAND SQUARE FEET. APPLY SEED AND PROTECT WITH STRAW MULCH AS REQUIRED FOR NEW LAWNS. GRASS SEED MIX SHALL CONSIST OF THE FOLLOWING:

PROPORTION	NAME	MIN.% GERM.	PURE SEED	WEED SEED	
30%	KENTUCKY BLUEGRASS (POA PRATENSIS)	80	85	0.50	
30%	CREEPING RED FESCUE (FESTUCA RUBRA)	85	98	0.50	
20%	PERENNIAL RYE GRASS (LOLIUM PERENNE)	90	98	0.50	
20%	ANNUAL RYEGRASS (LOLIUM MULTIFLORUM)	85	92	1.00	


PLANTING SCHEDULE


1. ALL PLANTING IS RECOMMENDED TO BE DONE WITHIN THE FOLLOWING DATES. WHEN PLANTING OUTSIDE THESE DATES, WRITTEN DOCUMENTATION SHALL BE PROVIDED THAT SURVIVAL OR REPLACEMENT WILL BE ENSURED. NO PLANTING SHALL BE DONE IN FROZEN SOIL.

NORMAL PLANTING SEASONS	SPRING	<u>FALL</u>
ALL TREES AND SHRUBS	MARCH 15-MAY 15	OCTOBER 1-DECEMBER 1
EVERGREENS	APRIL 1-MAY 15	OCTOBER 1-NOVEMBER 15
GROUNDCOVERS	APRIL 1-JUNE1	WHEN SOD IS WORKABLE
SEED AND MULCH	APRIL 1-MAY 15	OCTOBER 1-NOVEMBER 15



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TACO BELL
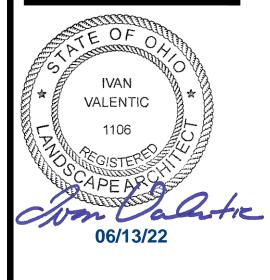
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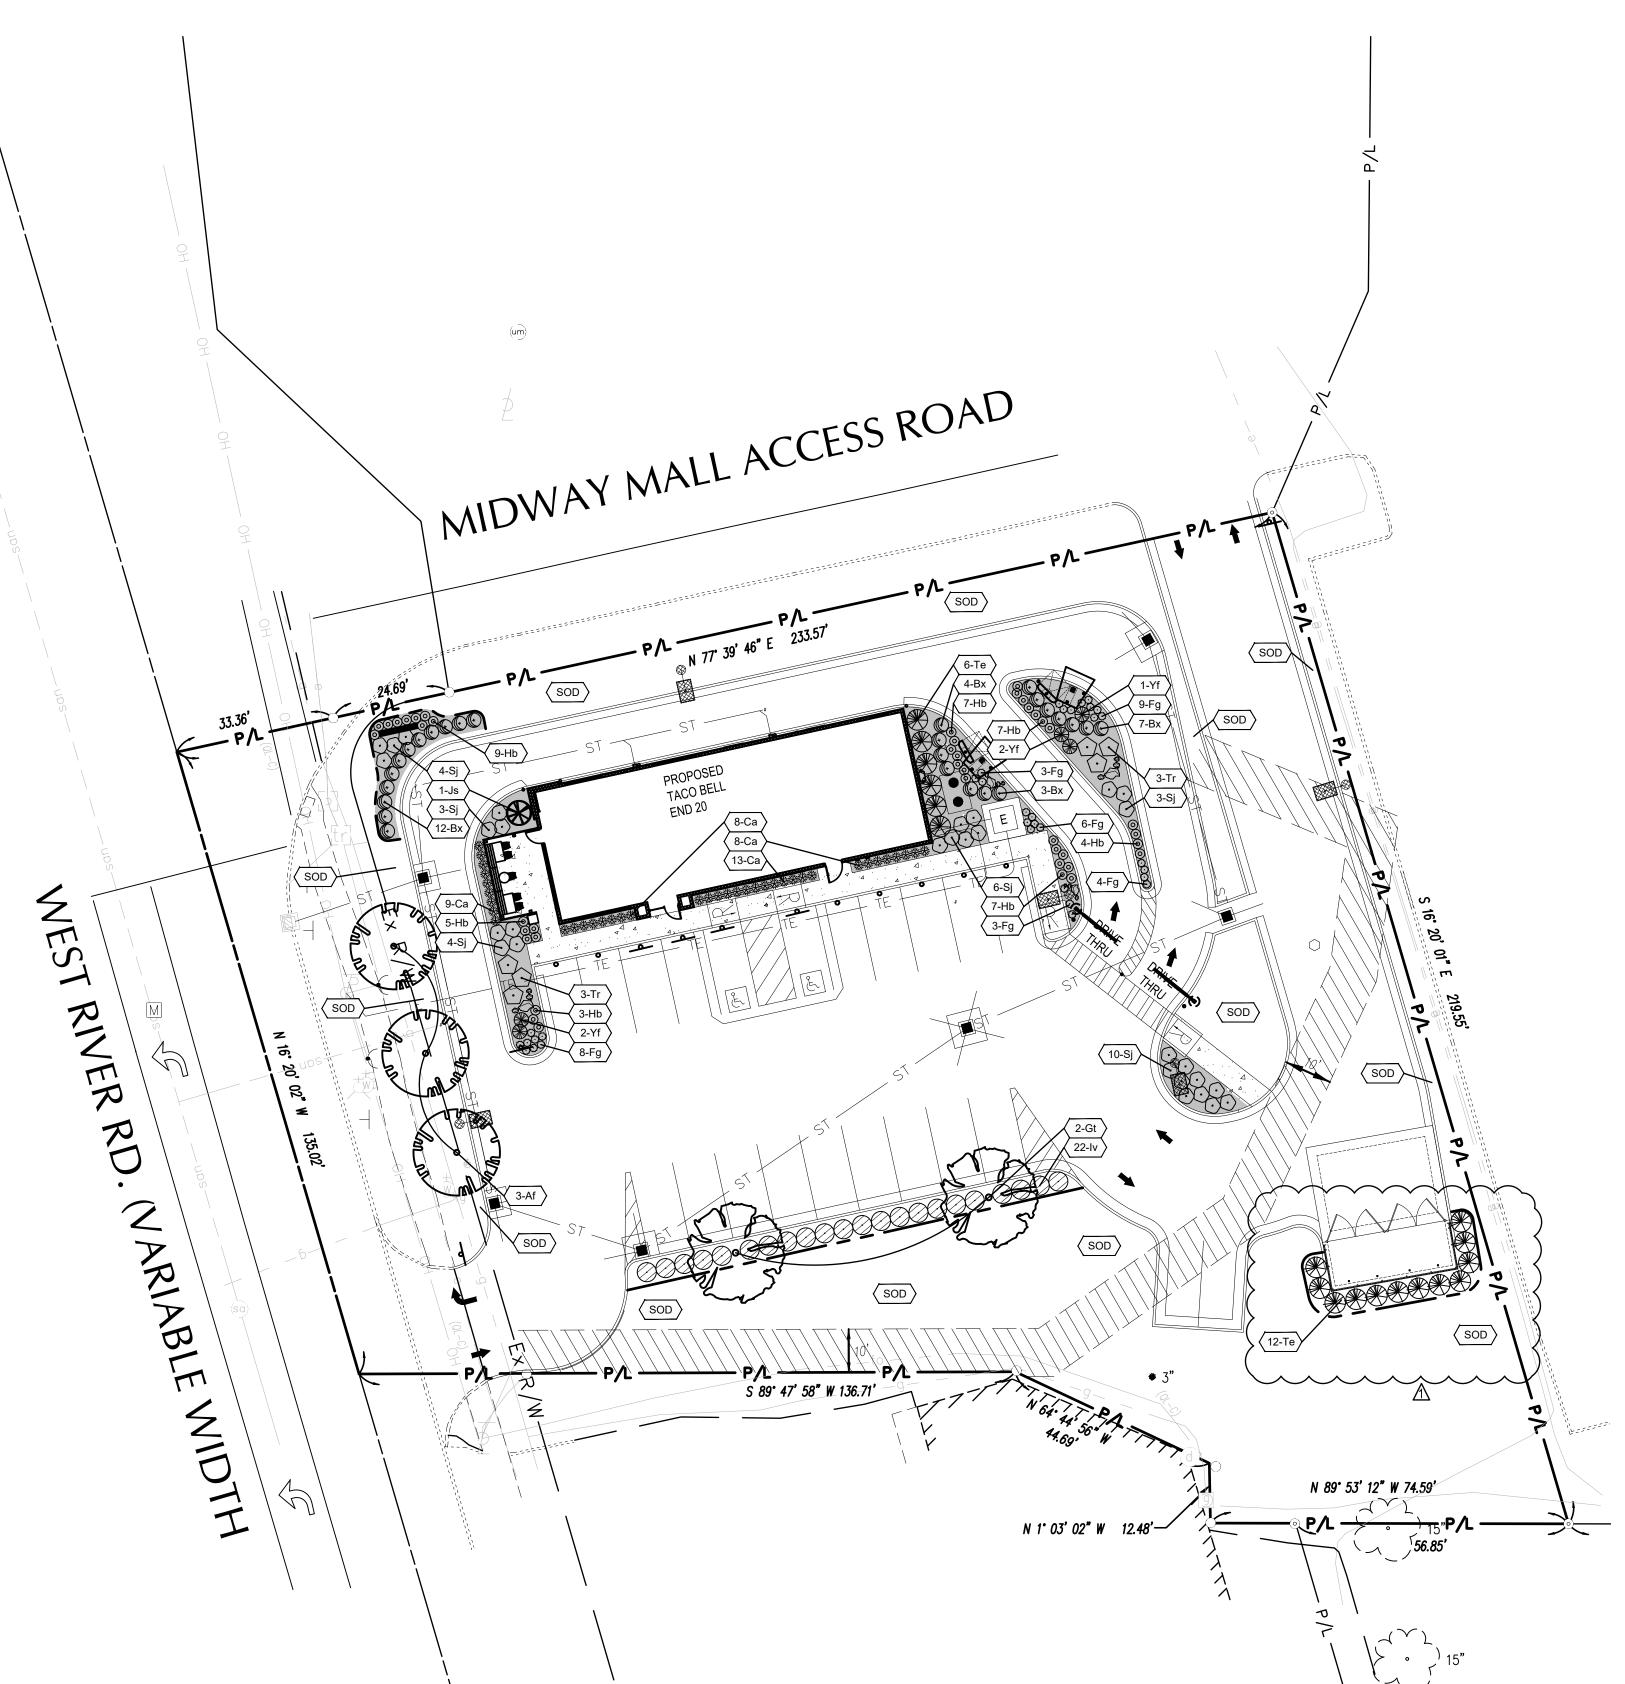
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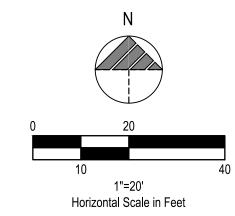
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LANDSCAPE

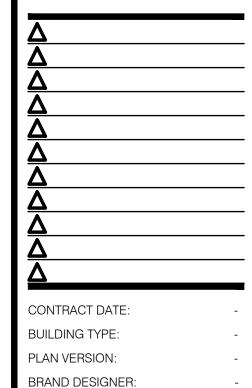L-001








LANDSCAPE NOTES

- 1. ALL AREAS NOT DELINEATED TO BE RIVER ROCK MULCH SHALL BE ORGANIC MULCH PER LANDSCAPE SPECIFICATIONS.
- 2. ALL DISTURBED AREAS NOT TO BE PAVED OR MULCHED SHALL BE SODDED PER SPECIFICATIONS.
- 3. ALL DISTURBED AREAS WITHIN THE R.O.W. NOT TO BE PAVED, SHALL BE SEEDED PER THE SPECIFICATIONS.

LANDSCAPE LEGEND

PROPOSED LANDSCAPE BED EDGE

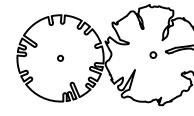

PROPOSED TREE



PROPOSED SHRUB / PERENNIAL




PROPOSED LIMESTONE BOULDER, DESERT SAND, 12"-36"

PROPOSED RIVER ROCK MULCH AREA

PROPOSED PLANT QUANTITY AND SYMBOL



PROPOSED LAWN AREA

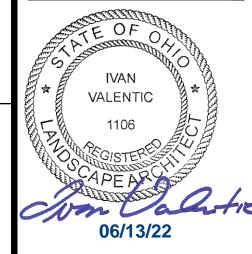

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A 05.19.22 PLANNING COMMENTS

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CONTRACT DATE:

CONTRACT DATE:
BUILDING TYPE:
PLAN VERSION:
BRAND DESIGNER:
SITE NUMBER:

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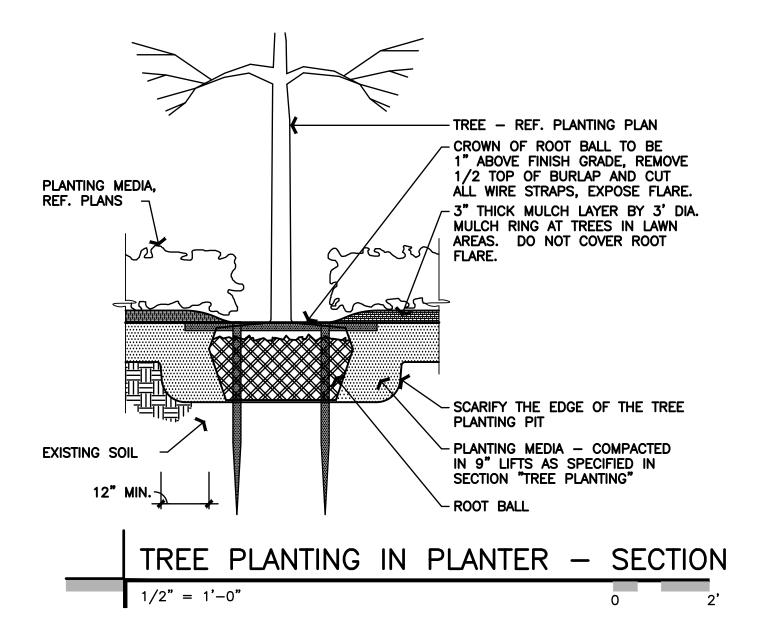



LANDSCAPE PLAN


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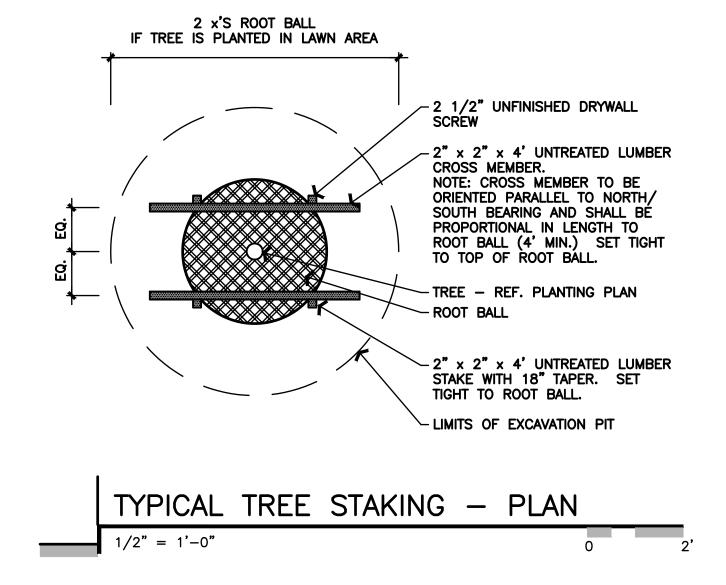



Symbol	Botanical Name	Common Name	Qty.	Min. Size	Condition	Remarks
Af	Acer x Freemanii 'Celzam'	Celebration Maple	3	2" Cal.	B&B	Matching
Вх	Buxus 'Green Velvet'	Green Velvet Boxwood	26	24" H Min.	B&B	3' o/c
Ca	Calamagrostis x acutifolia 'Karl Foerster'	Feather Reedgrass	29	No. 2	Cont.	2' o/c
Gt	Gleditsia triacanthos f. inermis 'Skycole'	Skyline Thornless Honeylocust	2	2" Cal.	B&B	Matching
Fg	Festuca gluaca	Blue Fescue	33	No. 1	Cont.	Per Plan
Hb	Hemerocallis 'Going Bananas'	Going Bananas Daylily	42	No. 2	Cont.	2' o/c
lv	Itea Virginica 'Henry's Garnet'	Henry's Garnet Sweetspire	22	24" H, No. 5	Cont.	4' o/c
Js	Juniperus scopulorum 'Wichita Blue'	Wichita Blue Juniper	1	5' H	B&B	Specimen
Sj	Spiraea japonica 'Goldmound'	Goldmound Spirea	30	24" H Min.	Cont.	3' o/c
Те	Thuja occidentalis 'Smaragd'	Emerald Arborvitae	18	5' H	B&B	4' o/c
Tr	Thuja occidentalis 'Rheingold'	Rheingold Arborvitae	6	24" H Min.	B&B	4' o/c
Yf	Yucca filamentosa 'Color Guard'	Color Guard Yucca	5	No. 5	Cont.	Per Plan






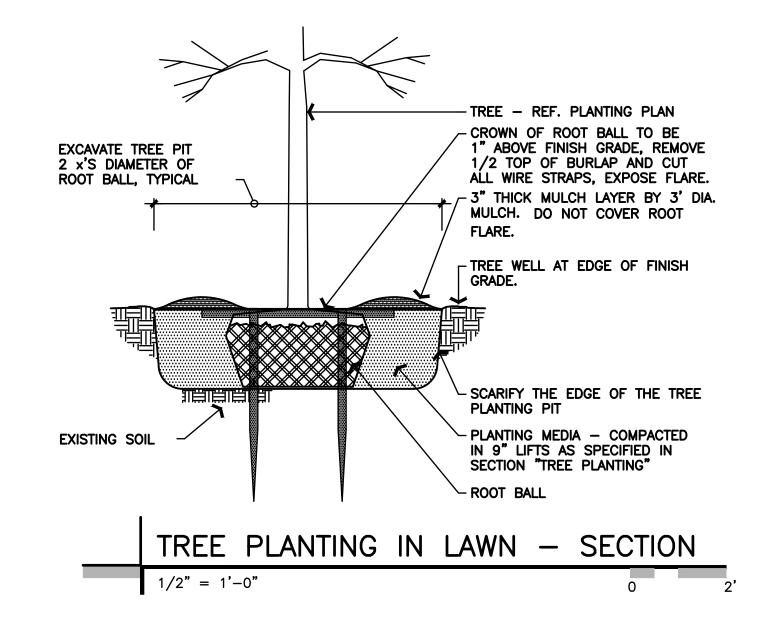

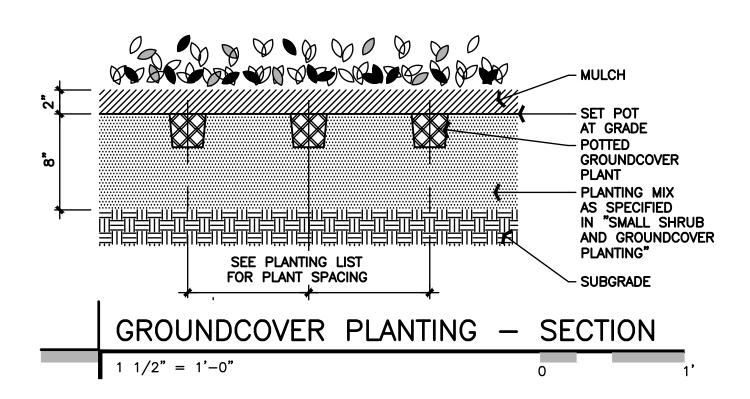


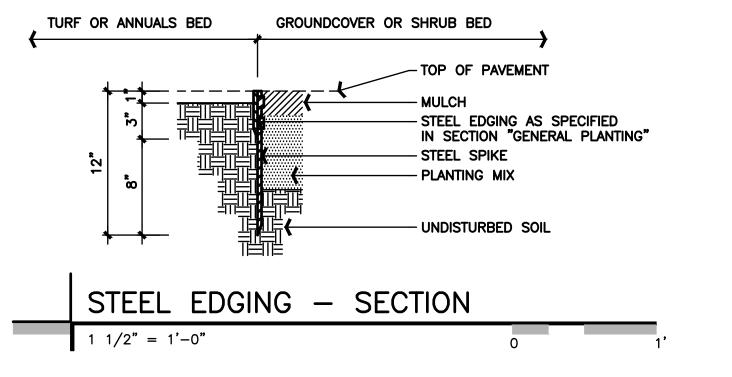

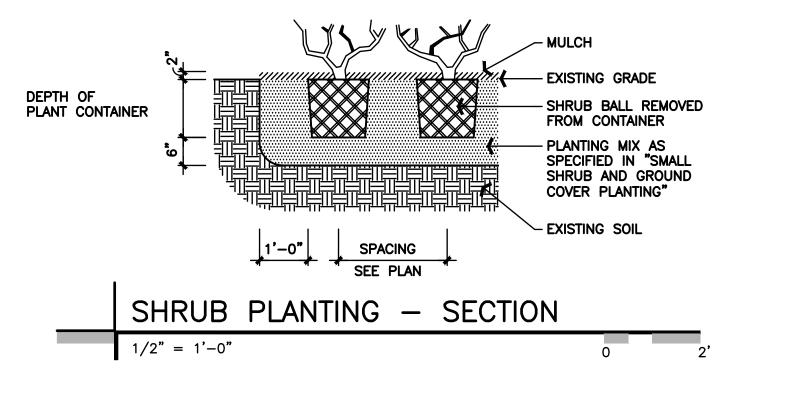



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LANDSCAPE DETAILS
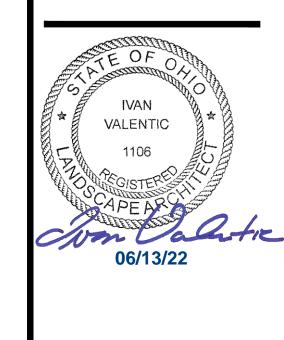
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