

NOT TO SCALE

OWNER/APPLICANT:
LINEAR REALTY PROPERTIES
5 BURLINGTON WOODS DRIVE, SUITE 107
BURLINGTON, MA 01803

ARCHITECT(S):

TACO BELL:
KATHLEEN DAY
8535 FERRY ROAD
WAYNESVILLE, OH 45068
PHONE: (617) 331-2545

AROMA JOE'S:
ROLLOUT CONNECTION
7221 W. PARKLAND COURT
MILWAUKEE, WI 53223
PHONE: (262) 361-4857

CIVIL ENGINEER / LANDSCAPE ARCHITECT / SURVEYOR:
ALLEN & MAJOR ASSOCIATES, INC.
400 HARVEY ROAD
MANCHESTER, NH 03103
PHONE: (603) 627-5500

TRAFFIC ENGINEER:
VANASSE & ASSOCIATES, INC.
35 NEW ENGLAND BUSINESS CENTER DRIVE, SUITE 140
ANDOVER, MA 01810
PHONE: (978) 474-8800


IT IS HEREBY AGREED THAT, AS THE OWNER/DEVELOPER OF THE PROPERTY, I WILL CONSTRUCT THE PROJECT AS APPROVED AND AS SHOWN ON THE ENCLOSED SET OF PLANS. FURTHER, I AGREE TO MAINTAIN THE SITE IMPROVEMENTS FOR THE DURATION OF THE USE IN ACCORDANCE WITH THE LONG-TERM MAINTENANCE AGREEMENT.

LINEAR RETAIL PROPERTIES REPRESENTATIVE


DATE

SITE DEVELOPMENT PLANS FOR 525 HOOKSETT ROAD

MAP 916, LOT 41A MANCHESTER, NH 03103

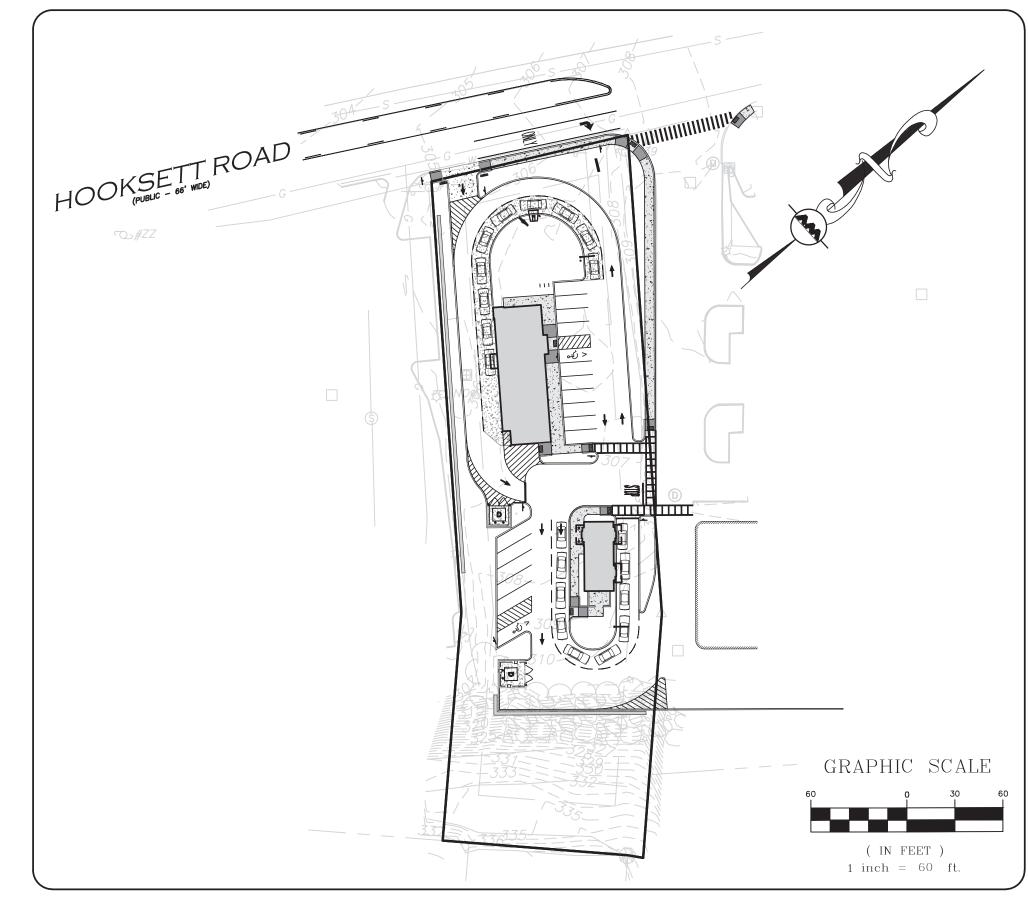

LIST OF DRAWINGS						
DRAWING TITLE	SHEET NO.	ISSUED	REVISION 1	REVISION 2	REVISION 3	
EXISTING CONDITIONS	V-101	03-15-22	05-04-22	05-26-22	-	
EROSION CONTROL PLAN	C-101	03-15-22	04-06-22	05-26-22	-	
LAYOUT & MATERIALS PLAN	C-102	03-15-22	04-06-22	04-12-22	05-26-22	
GRADING & DRAINAGE PLAN	C-103	03-15-22	04-06-22	05-26-22	-	
UTILITIES PLAN	C-104	03-15-22	04-06-22	05-26-22	-	
LIGHTING PLAN	C-105	03-15-22	04-06-22	-	-	
TRUCK TURNING PLAN	C-106	03-15-22	04-06-22	-	-	
DETAILS	C-501	03-15-22	-	-	-	
DETAILS	C-502	03-15-22	05-26-22	-	-	
DETAILS	C-503	03-15-22	05-26-22	-	-	
DETAILS	C-504	03-15-22	05-26-22	-	-	
DETAILS	C-505	03-15-22	05-26-22	-	-	
LANDSCAPING PLAN	L-101	03-15-22	04-06-22	-	-	
LANDSCAPING DETAILS	L-501	03-15-22	-	-	-	
TACO BELL ELEVATIONS	ELEV	02-25-22	04-11-22	-	-	
TACO BELL FLOOR PLAN	A1.0	02-25-22	-	-	-	
AROMA JOE'S ELEVATIONS	ELEV	03-15-22	-	-	-	
AROMA JOE'S FLOOR PLAN	A101	03-15-22	04-06-22	-	- ,	

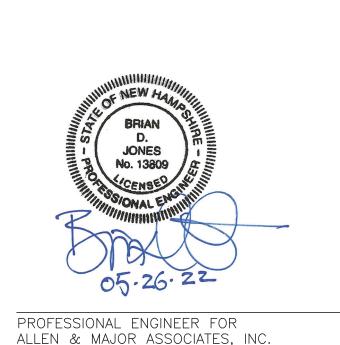



WOBURN, MA ◆ LAKEVILLE, MA ◆ MANCHESTER, NH

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FAX: (603) 627-5501



- 1. PLANNING BOARD APPROVAL OF THIS PLANNED DEVELOPMENT IS LIMITED TO THE REPRESENTATIONS SHOWN WITHIN THIS SET OF DRAWINGS AND DOES NOT ENDORSE ANY SUBSEQUENT PLANS THAT MAY BE PREPARED FOR CONDOMINIUM APPROVAL BY THE STATE. MODIFICATIONS TO THESE PLANS, INCLUDING, BUT NOT LIMITED TO, BUILDING ADDITIONS, ACCESSORY STRUCTURES, AND LIMITED COMMON AREAS ARE SUBJECT TO PLANNING BOARD REVIEW AND APPROVAL. ANY PROPOSED DIVISION OF THIS PARCEL OF LAND THAT MAY BE HELD IN COMMON OWNERSHIP AND SUBSEQUENTLY DIVIDED INTO PARTS AMONG THE SEVERAL OWNERS MAY BE DEEMED A SUBDIVISION AND SUBJECT TO PLANNING BOARD APPROVAL.
- 2. ALL CONDITIONS SUBSEQUENT TO APPROVAL SHALL BE COMPLETED WITHIN TWO YEARS OF THE DATE OF FINAL APPROVAL.
- 3. NO CERTIFICATE OF OCCUPANCY SHALL BE AUTHORIZED UNTIL ALL REQUIRED IMPROVEMENTS HAVE BEEN COMPLETED, UNLESS ADDRESSED BY THE PROVISION OF A FINANCIAL GUARANTEE, PURSUANT TO THE REQUIREMENTS OF SECTION 4.14 OF THE MANCHESTER SUBDIVISION AND SITE PLAN REVIEW REGULATIONS.
- 4. ALL STORMWATER STRUCTURES SHALL BE INSPECTED AND CLEANED FOLLOWING SITE STABILIZATION AND PRIOR TO ISSUANCE OF A CERTIFICATE OF OCCUPANCY, WHERE APPLICABLE. A REPORT INCLUDING THE INSPECTION FINDINGS AND CLEANING ACTIVITIES SHALL BE SUBMITTED TO DPW




CITY OF MANCHESTER APPROVAL STAMP

ISSUED FOR PLANNED DEVELOPMENT REVIEW: MARCH 15, 2022

REVISION 1: APRIL 6, 2002 REVISION 2: APRIL 12, 2022

REVISION 3: MAY 26, 2022

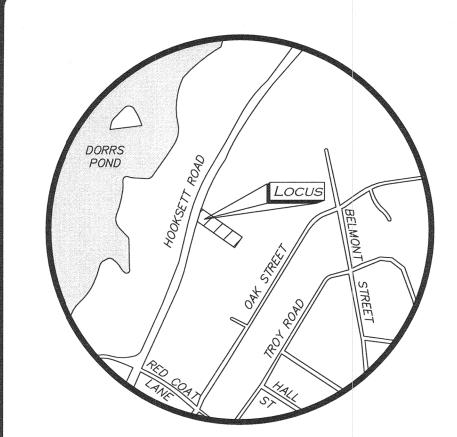

LOCUS MAP (NOT TO SCALE)

<u> </u>	BENCHMARK SUMMAR	RY
TBM #	DESCRIPTION	ELEV.
\wedge	HYDRANT FLANGE	300 30

ZONING TABLE - GENERAL BUSINESS

BOLT HYDRANT

309.30

IR FND.

IR FND.

TM 916 LOT 45

KRISTAL L. LINNANNE

506 OAK STREET

MANCHESTER, NH 03104

BK.8997/PG.1892

/HELD


ENCROACHMENT

PLANTER -

ITEM	REQUIRED
LOT AREA (MIN)	12,500 S.F.
LOT FRONTAGE (MIN)	100'
LOT COVERAGE (MAX)	75%
FRONT YARD SETBACK (MIN)	20'
SIDE YARD SETBACK (MIN)	20'
REAR YARD SETBACK (MIN)	30'
MAXIMUM BUILDING HEIGHT	50'-4 STORIES

UTILITY STATEMENT

THE UTILITIES SHOWN HAVE BEEN LOCATED FROM FIELD SURVEY INFORMATION AND EXISTING DRAWINGS. ALLEN & MAJOR ASSOCIATES, INC. (A&M) MAKES NO GUARANTEE THAT THE UTILITIES SHOWN HEREON COMPRISE ALL SUCH UTILITIES IN THE AREA, EITHER IN SERVICE OR ABANDONED. A&M FURTHER DOES NOT WARRANT THAT THE UTILITIES SHOWN ARE IN THE EXACT LOCATION INDICATED. A&M HAS NOT PHYSICALLY LOCATED THE UNDERGROUND UTILITIES.

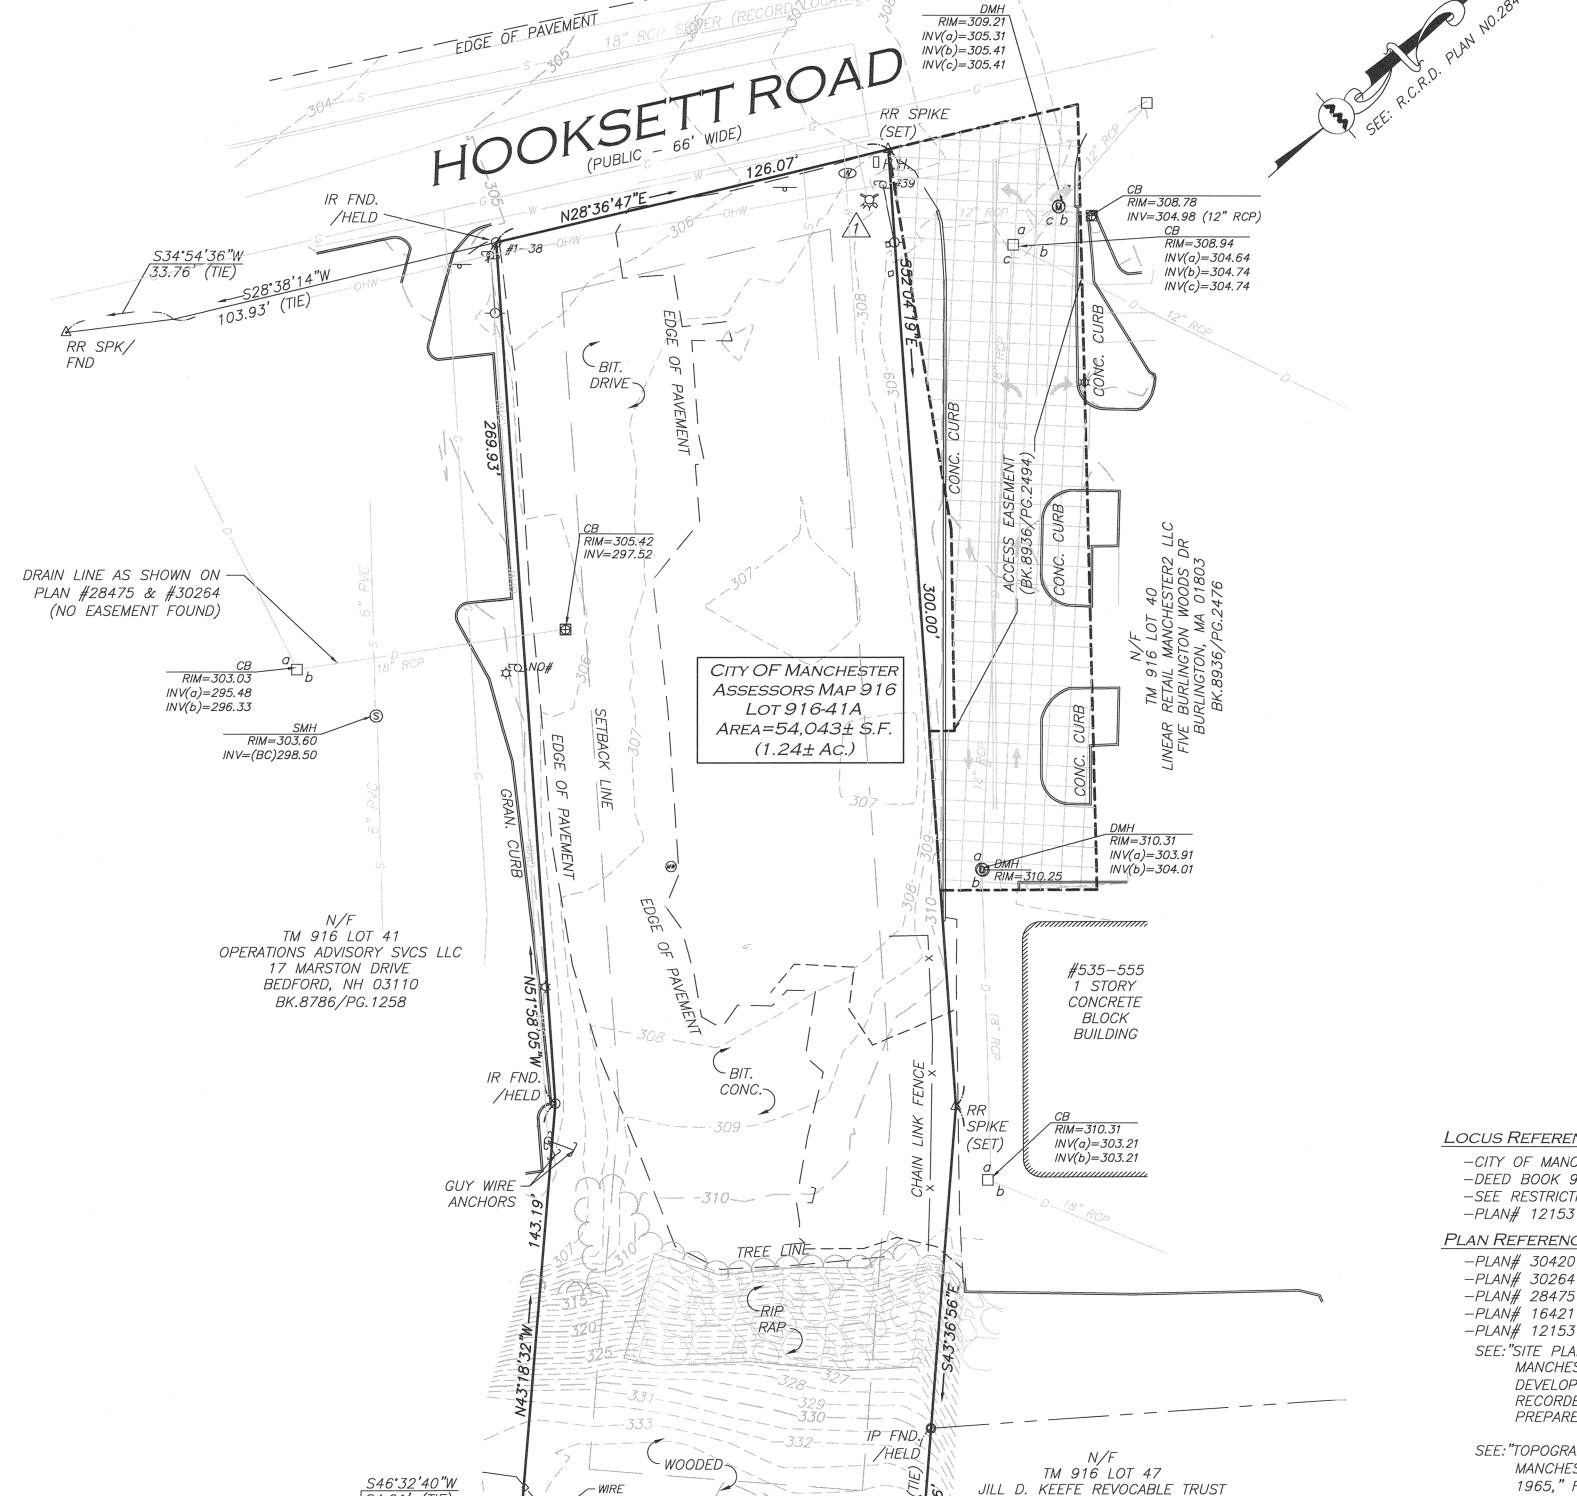

POST & RAIL

15" RED OAK

IRON ROD

S51°25'54"W 9.57'

(SET UP 0.2')

FENCE

S46°32'40"W

TM 916 LOT 46

ROBERT G. DUBE

518 OAK STREET

MANCHESTER, NH 03104

BK.8683/PG.2556

116.19

LEGEND

IRON ROD (IR)	0
IRON PIPE (IP)	0
RAILROAD SPIKE	\triangle
CATCH BASIN (CB)	
UTILITY POLE	⊕
DRAIN MANHOLE (DMH)	(D)
GUY POLE	- -
MONITOR WELL	MW
WATER SERVICE	W
FIRE HYDRANT	
LIGHT	\$
TREE	
SIGN	-0
HAND HOLE	□ <i>H.H</i> .
ELECTRIC METER	(E)
GUY WIRE	
BUILDING	<u> </u>
EASEMENT LINE	
PROPERTY LINE	
ABUTTERS LINE	
TREE LINE	
WATER LINE	essa esta anticonomica en la mante esta en esta de la francia esta anticonomica en esta esta esta en esta esta
SEWER LINE	<u></u>
DRAIN LINE	ne announcement of government of the second
GAS LINE	<i>G</i>
OVERHEAD WIRES	aanaanaanaa NAW oo aanaanaanaanaa
EDGE OF PAVEMENT	
CURB	
CHAIN LINK FENCE	x
WOOD FENCE	
1' CONTOUR	
5' CONTOUR	
BITUMINOUS	BIT.
CONCRETE	CONC.
GRANITE	GRAN.
FOUND	FND
NOW OR FORMERLY	N/F
BOOK	BK.
PAGE	PG.

LOCUS REFERENCES

- -CITY OF MANCHESTER ASSESSORS MAP 916, LOT 41A
- -DEED BOOK 9035, PAGE 1188 -SEE RESTRICTION AGREEMENT IN BOOK 9035, PAGE 1193
- -PLAN# 12153
- PLAN REFERENCES
- -PLAN# 30420
- -PLAN# 28475
- -PLAN# 16421
- -PLAN# 12153 SEE: "SITE PLAN MAPLE TREE MALL 545 DANIEL WEBSTER HIGHWAY MANCHESTER, NEW HAMPSHIRE OWNER & APPLICANT: KOPKA DEVELOPMENT, SCALE: 1"=30', DATED: JUNE, 1985," PLAN RECORDED AT MANCHESTER, NH DEPT. OF PUBLIC WORKS, PLAN

SEE: "TOPOGRAPHIC SURVEY WEBSTER HEIGHTS, INC. BELMONT ST. MANCHESTER, NH, SCALE: 1"=50', DATED: REV. SEPT. 13, 1965," RECORDED AT MANCHESTER, NH DEPT. OF PUBLIC WORKS, PREPARED BY: HILLS & HESSLEIN.

PREPARED BY: DIPRETE-MARCHIONDA & ASSOC.

NOTES

522 OAK ST.

MANCHESTER, NH 03104

BK.9314/PG.2344


- 1. NORTH ARROW TAKEN FROM PLAN# 28415.
- BOOK/PAGE AND PLAN REFERENCES ARE TAKEN FROM THE HILLSBOROUGH
- COUNTY REGISTRY OF DEEDS. OWNERS OF ADJOINING PROPERTIES ARE SHOWN ACCORDING TO CURRENT
- CITY OF MANCHESTER ASSESSORS INFORMATION. 4. VERTICAL DATUM IS NAVD 88 ESTABLISHED USING RTK GPS OBSERVATION.

GRAPHIC SCALE (IN FEET) 1 inch = 30 ft.

> $N:\PROJECTS\1583-54\SURVEY\DRAWINGS\S-1583-54-ALTA.DWG$ FB# NH-2 PG. 63

THIS PLAN IS THE RESULT OF AN ACTUAL ON THE GROUND SURVEY PERFORMED ON OR BETWEEN JULY 18, 2017 AND SEPTEMBER 8, 2021 AND HAD AN ERROR OF CLOSURE OF NO GREATER THAN 1/10,000.

ALLEN & MAJOR ASSOCIATES, INC.

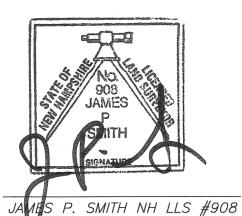

5-31-22

5/31/22 UPDATE DRAIN INVERT ELEVATION 05/04/22 MOVE WATER LINE DATE DESCRIPTION REV APPLICANT\OWNER:

LINEAR RETAIL PROPERTIES, LLC 5 BURLINGTON WOODS DR., S. 107 BURLINGTON, MA. 01803

PROJECT:

525 HOOKSETT ROAD AKA DANIEL WEBSTER HWY. MANCHESTER, NH

1583-55 DATE: 3/15/22 PROJECT NO.

1" = 30' DWG. NAME: S-1583-55B-EC

AJR | CHECKED BY: **DRAFTED BY:**

ALLEN & MAJOR ASSOCIATES, INC.

civil & structural engineering • land surveying environmental consulting • landscape architecture www.allenmajor.com

100 COMMERCE WAY P.O. BOX 2118 WOBURN MA 01888-0118

TEL: (781) 935-6889


FAX: (781) 935-2896 WOBURN, MA ♦ LAKEVILLE, MA ♦ MANCHESTER, NI

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DRAWING TITLE:

EXISTING CONDITIONS

SHEET No.

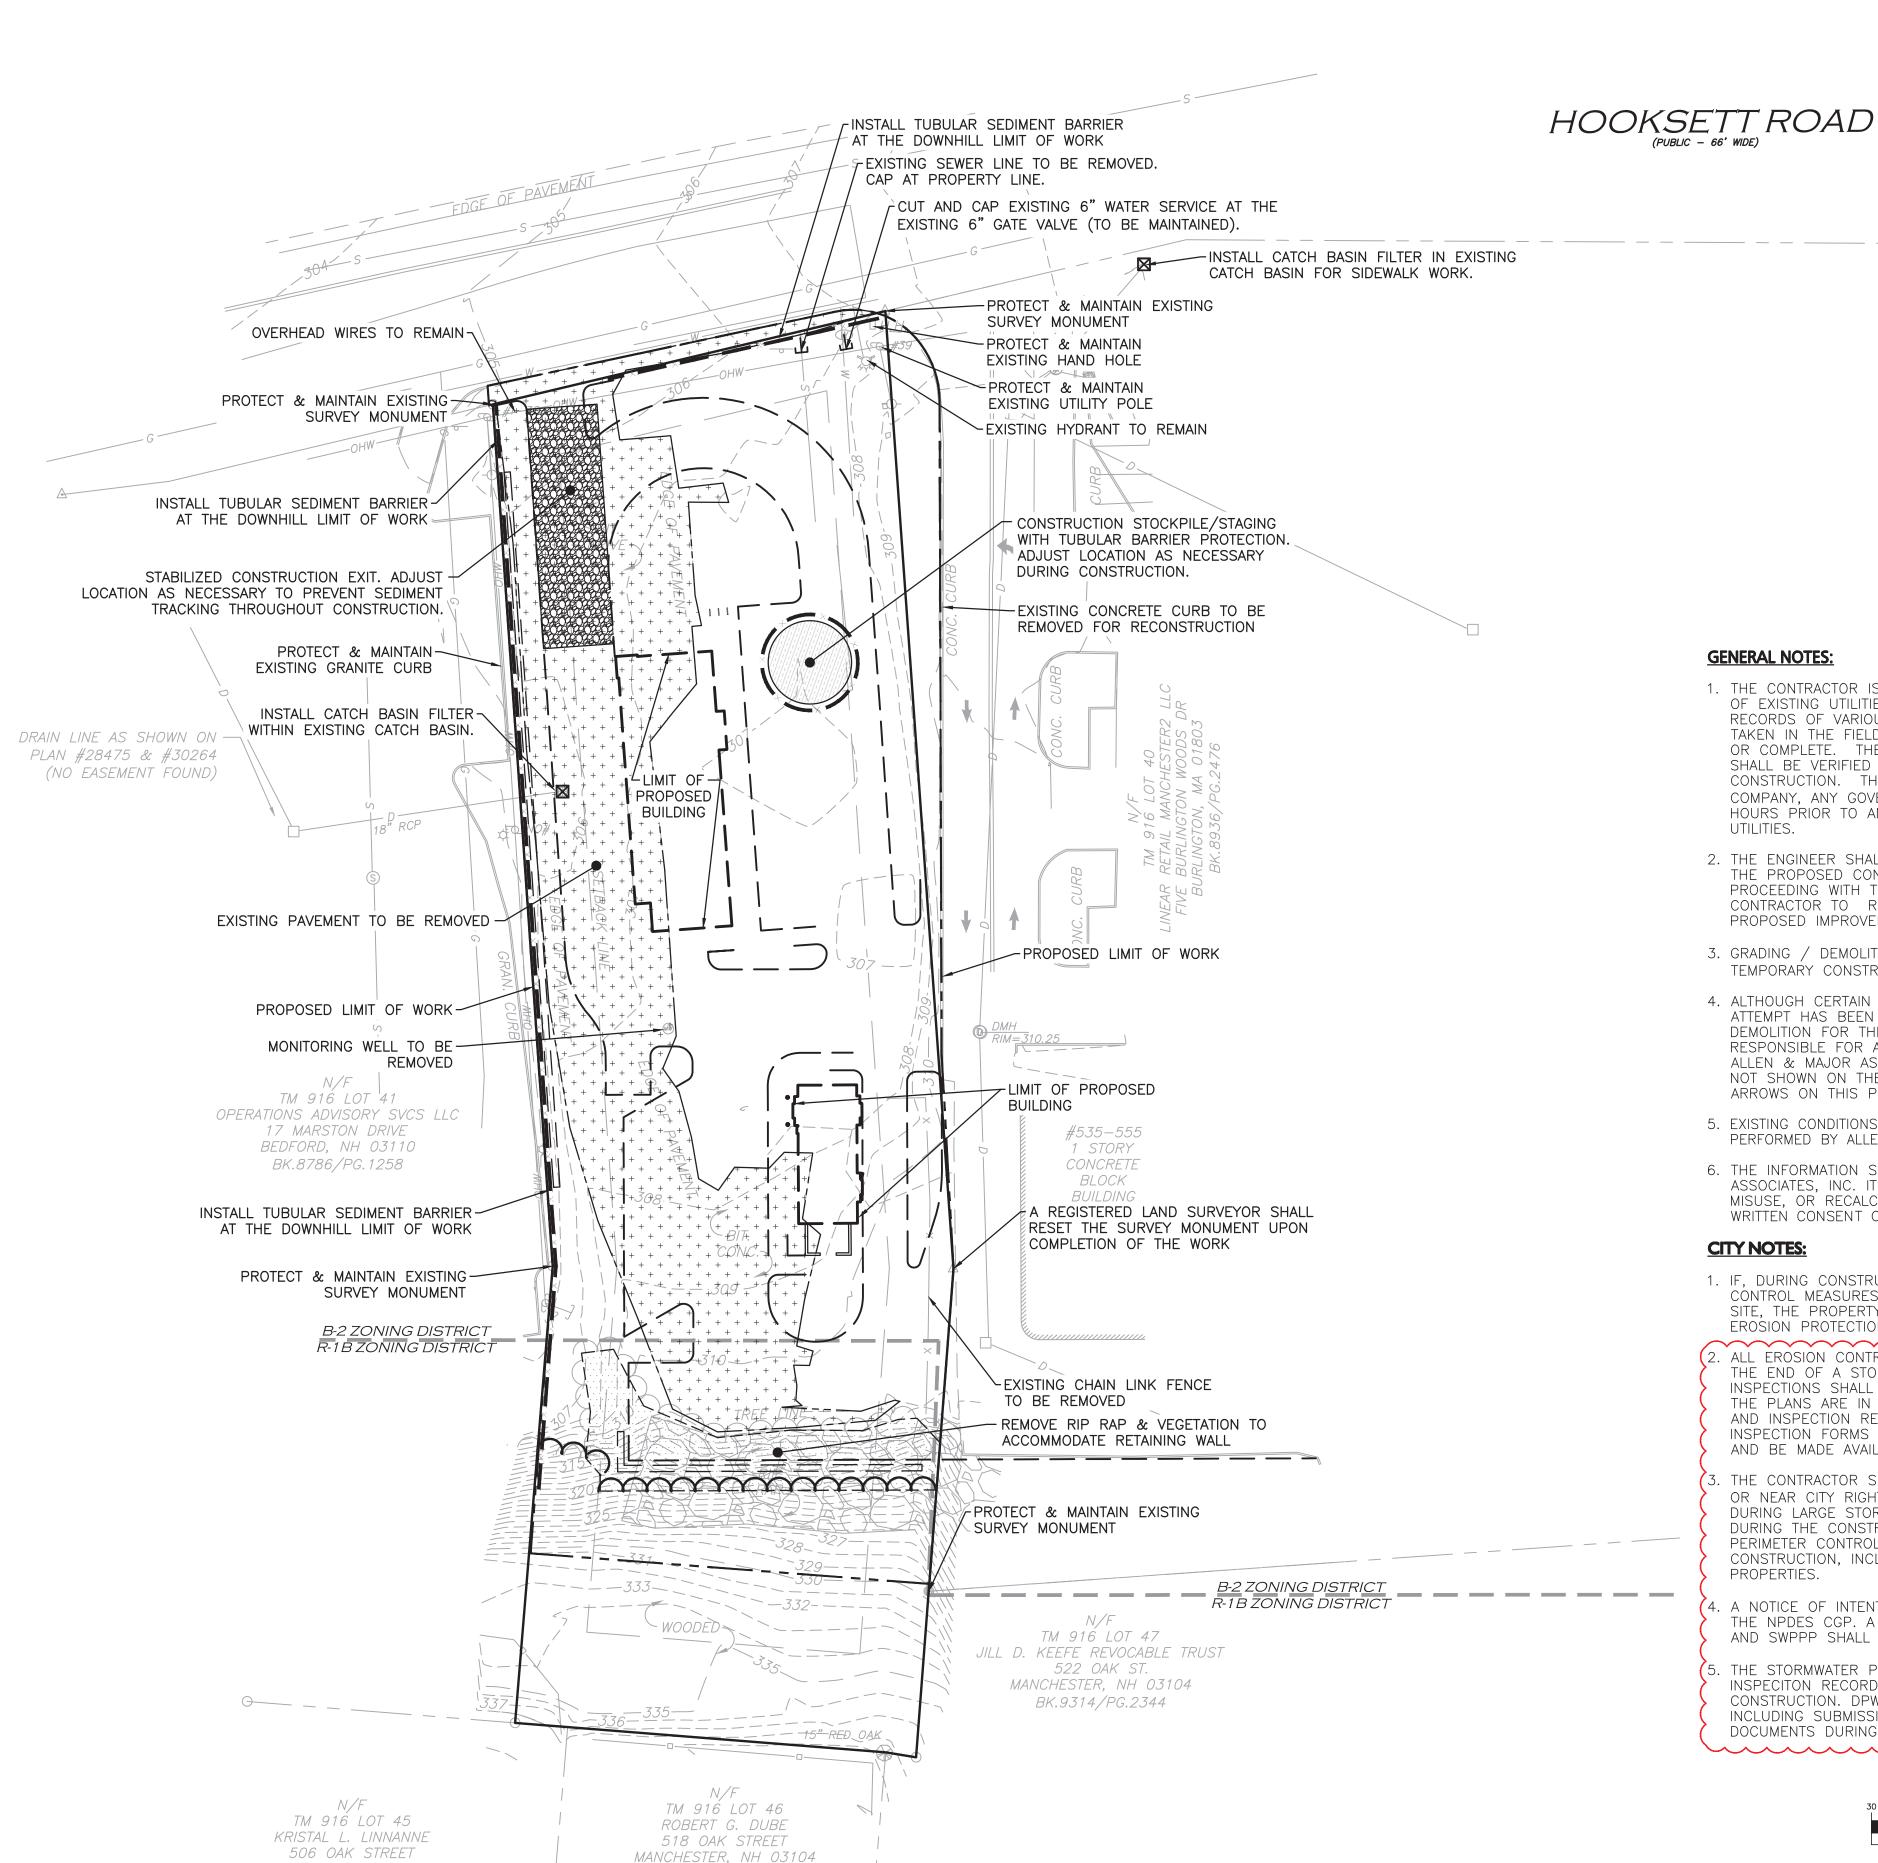

BK.8683/PG.2556

DIG SAFE

BEFORE YOU DIG


CALL 811 OR

1-888-DIG-SAFE

1-888-344-7233

MANCHESTER, NH 03104

BK.8997/PG.1892

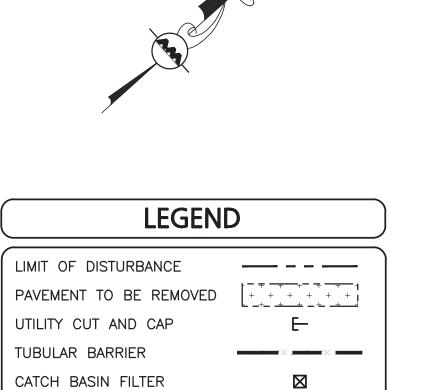

GENERAL NOTES:

1. THE CONTRACTOR IS SPECIFICALLY CAUTIONED THAT THE LOCATION AND/OR ELEVATION OF EXISTING UTILITIES AND STRUCTURES AS SHOWN ON THESE PLANS IS BASED ON RECORDS OF VARIOUS UTILITY COMPANIES AND WHERE POSSIBLE, MEASUREMENTS TAKEN IN THE FIELD. THIS INFORMATION IS NOT TO BE RELIED ON AS BEING EXACT OR COMPLETE. THE LOCATION OF ALL UNDERGROUND UTILITIES AND STRUCTURES SHALL BE VERIFIED IN THE FIELD BY THE CONTRACTOR PRIOR TO THE START OF CONSTRUCTION. THE CONTRACTOR MUST CONTACT THE APPROPRIATE UTILITY COMPANY, ANY GOVERNING PERMITTING AUTHORITY, AND "DIGSAFE" AT LEAST 72 HOURS PRIOR TO ANY EXCAVATION WORK TO REQUEST EXACT FIELD LOCATION OF UTILITIES.

STABILIZED ENTRANCE

STOCKPILE/STAGING AREA

LIMIT OF 'CLEAR AND GRUB'


- 2. THE ENGINEER SHALL BE NOTIFIED IN WRITING OF ANY UTILITIES INTERFERING WITH THE PROPOSED CONSTRUCTION AND APPROPRIATE REMEDIAL ACTION TAKEN BEFORE PROCEEDING WITH THE WORK. IT SHALL BE THE RESPONSIBILITY OF THE CONTRACTOR TO RELOCATE ALL EXISTING UTILITIES WHICH CONFLICT WITH THE PROPOSED IMPROVEMENTS SHOWN ON THE PLANS.
- 3. GRADING / DEMOLITION OUTSIDE OF THE PROJECT BOUNDARIES (IF ANY) REQUIRES A TEMPORARY CONSTRUCTION/GRADING EASEMENT FROM THE LANDOWNER (BY OTHERS).
- 4. ALTHOUGH CERTAIN ITEMS HAVE BEEN NOTED ON THIS DRAWING FOR DEMOLITION, NO ATTEMPT HAS BEEN MADE TO DELINEATE EACH AND EVERY ITEM THAT REQUIRES DEMOLITION FOR THE COMPLETION OF THE PROJECT. THE CONTRACTOR WILL BE RESPONSIBLE FOR ALL NECESSARY DEMOLITION WORK TO COMPLETE THE PROJECT ALLEN & MAJOR ASSOCIATES, INC. IS NOT RESPONSIBLE FOR SITE DEMOLITION ITEMS NOT SHOWN ON THE SURVEY, OR SPECIFICALLY NOTED. THE DEMOLITION NOTES AND ARROWS ON THIS PLAN ARE TYPICAL AND DO NOT REFLECT QUANTITY.
- 5. EXISTING CONDITIONS INFORMATION WAS COMPILED FROM AN ON THE GROUND SURVEY PERFORMED BY ALLEN & MAJOR ASSOCIATES, INC. IN SEPTEMBER OF 2021.
- 6. THE INFORMATION SHOWN ON THIS PLAN IS THE SOLE PROPERTY OF ALLEN & MAJOR ASSOCIATES, INC. ITS INTENDED USE IS TO PROVIDE INFORMATION. ANY ALTERATION, MISUSE, OR RECALCULATION OF INFORMATION OR DATA WITHOUT THE EXPRESSED, WRITTEN CONSENT OF ALLEN & MAJOR ASSOCIATES, INC. IS STRICTLY PROHIBITED.

CITY NOTES:

- 1. IF, DURING CONSTRUCTION, IT BECOMES APPARENT THAT ADDITIONAL EROSION CONTROL MEASURES ARE REQUIRED TO STOP ANY EROSION ON THE CONSTRUCTION SITE, THE PROPERTY OWNER SHALL BE REQUIRED TO INSTALL THE NECESSARY EROSION PROTECTION AT NO EXPENSE TO THE CITY.
- ALL EROSION CONTROLS SHALL BE INSPECTED WEEKLY AND WITHIN 24 HOURS OF THE END OF A STORM WITH RAINFALL AMOUNT GREATER THAN 0.25 INCHES. THE INSPECTIONS SHALL VERIFY THAT THE STRUCTURAL BMPS SHOWN AND DESCRIBED ON THE PLANS ARE IN GOOD CONDITION AND ARE MINIMIZING EROSION. A MAINTENANCE AND INSPECTION REPORT SHALL BE MADE WITH EACH INSPECTION. COMPLETED INSPECTION FORMS SHALL BE KEPT ON SITE FOR THE DURATION OF THE PROJECT AND BE MADE AVAILABLE FOR REVIEW BY THE CITY OF MANCHESTER UPON REQUEST
- THE CONTRACTOR SHALL VERIFY EROSION CONTROL MEASURES, WHICH ARE PLACED IN , OR NEAR CITY RIGHTS-OF-WAY, ARE PROPERLY MAINTAINED JUST PRIOR TO AND/OR DURING LARGE STORM EVENTS IN ORDER TO PREVENT POTENTIAL STREET FLOODING DURING THE CONSTRUCTION DURATION. THE CONTRACTOR SHALL ENSURE THAT PERIMETER CONTROLS MANAGE ALL STORMWATER LEAVING THE SITE DURING CONSTRUCTION, INCLUDING SHEET FLOW ONTO ADJACENT PROPERTIES AND ANY CITY PROPERTIES.

A NOTICE OF INTENT (NOI) SHALL BE PREPARED AND SUBMITTED TO THE EPA UNDER THE NPDES CGP. A SWPPP SHALL BE PREPARED AND MAINTAINED ON SITE. THE NOI AND SWPPP SHALL ALSO BE SUBMITTED TO DPW.

THE STORMWATER POLLUTION PREVENTION PLAN (SWPPP) AND EROSION CONTROL INSPECITON RECORDS SHALL BE MAINTAINED ON SITE AT ALL TIMES DURING CONSTRUCTION. DPW STAFF SHOULD ALSO BE COPIED ON PERMIT COMPLIANCE INCLUDING SUBMISSION OF THE SWPPP AND HAVE ACCESS TO EROSION INSPECTION DOCUMENTS DURING CONSTRUCTION.

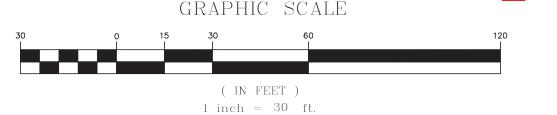

R:\PROJECTS\1583-55B\CIVIL\DRAWINGS\CURRENT\C-1583-55B_EROSION CONTROL.DWG



PROFESSIONAL ENGINEER FOR ALLEN & MAJOR ASSOCIATES, INC.

<u>^</u>	05-26-22	REVS PER CITY DEPT. COMMENTS
1	04-06-22	REVISED COFFEE SHOP BUILDING
REV	DATE	DESCRIPTION

APPLICANT\OWNER:

LINEAR RETAIL PROPERTIES, LLC 5 BURLINGTON WOODS DR. S. 107 BURLINGTON, MA 01803

525 HOOKSETT ROAD AKA DANIEL WEBSTER HWY. MAP-LOT: 916-41A MANCHESTER, NH 03104

PROJECT NO. 1583-55B DATE: 03-15-2022 1" = 30' DWG. NAME: C-1583-55E **DRAFTED BY:** BDJ | CHECKED BY:



ASSOCIATES, INC. civil engineering ♦ land surveying environmental consulting • landscape architecture www.allenmajor.com

400 HARVEY ROAD MANCHESTER, NH 03101 TEL: (603) 627-5500 FAX: (603) 627-5501


WOBURN, MA ♦ LAKEVILLE, MA ♦ MANCHESTER, NE

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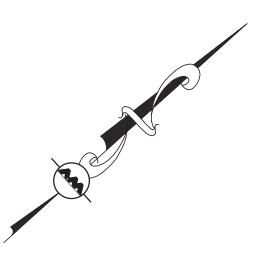
DRAWING TITLE:

SHEET No.

C-101 EROSION CONTROL PLAN

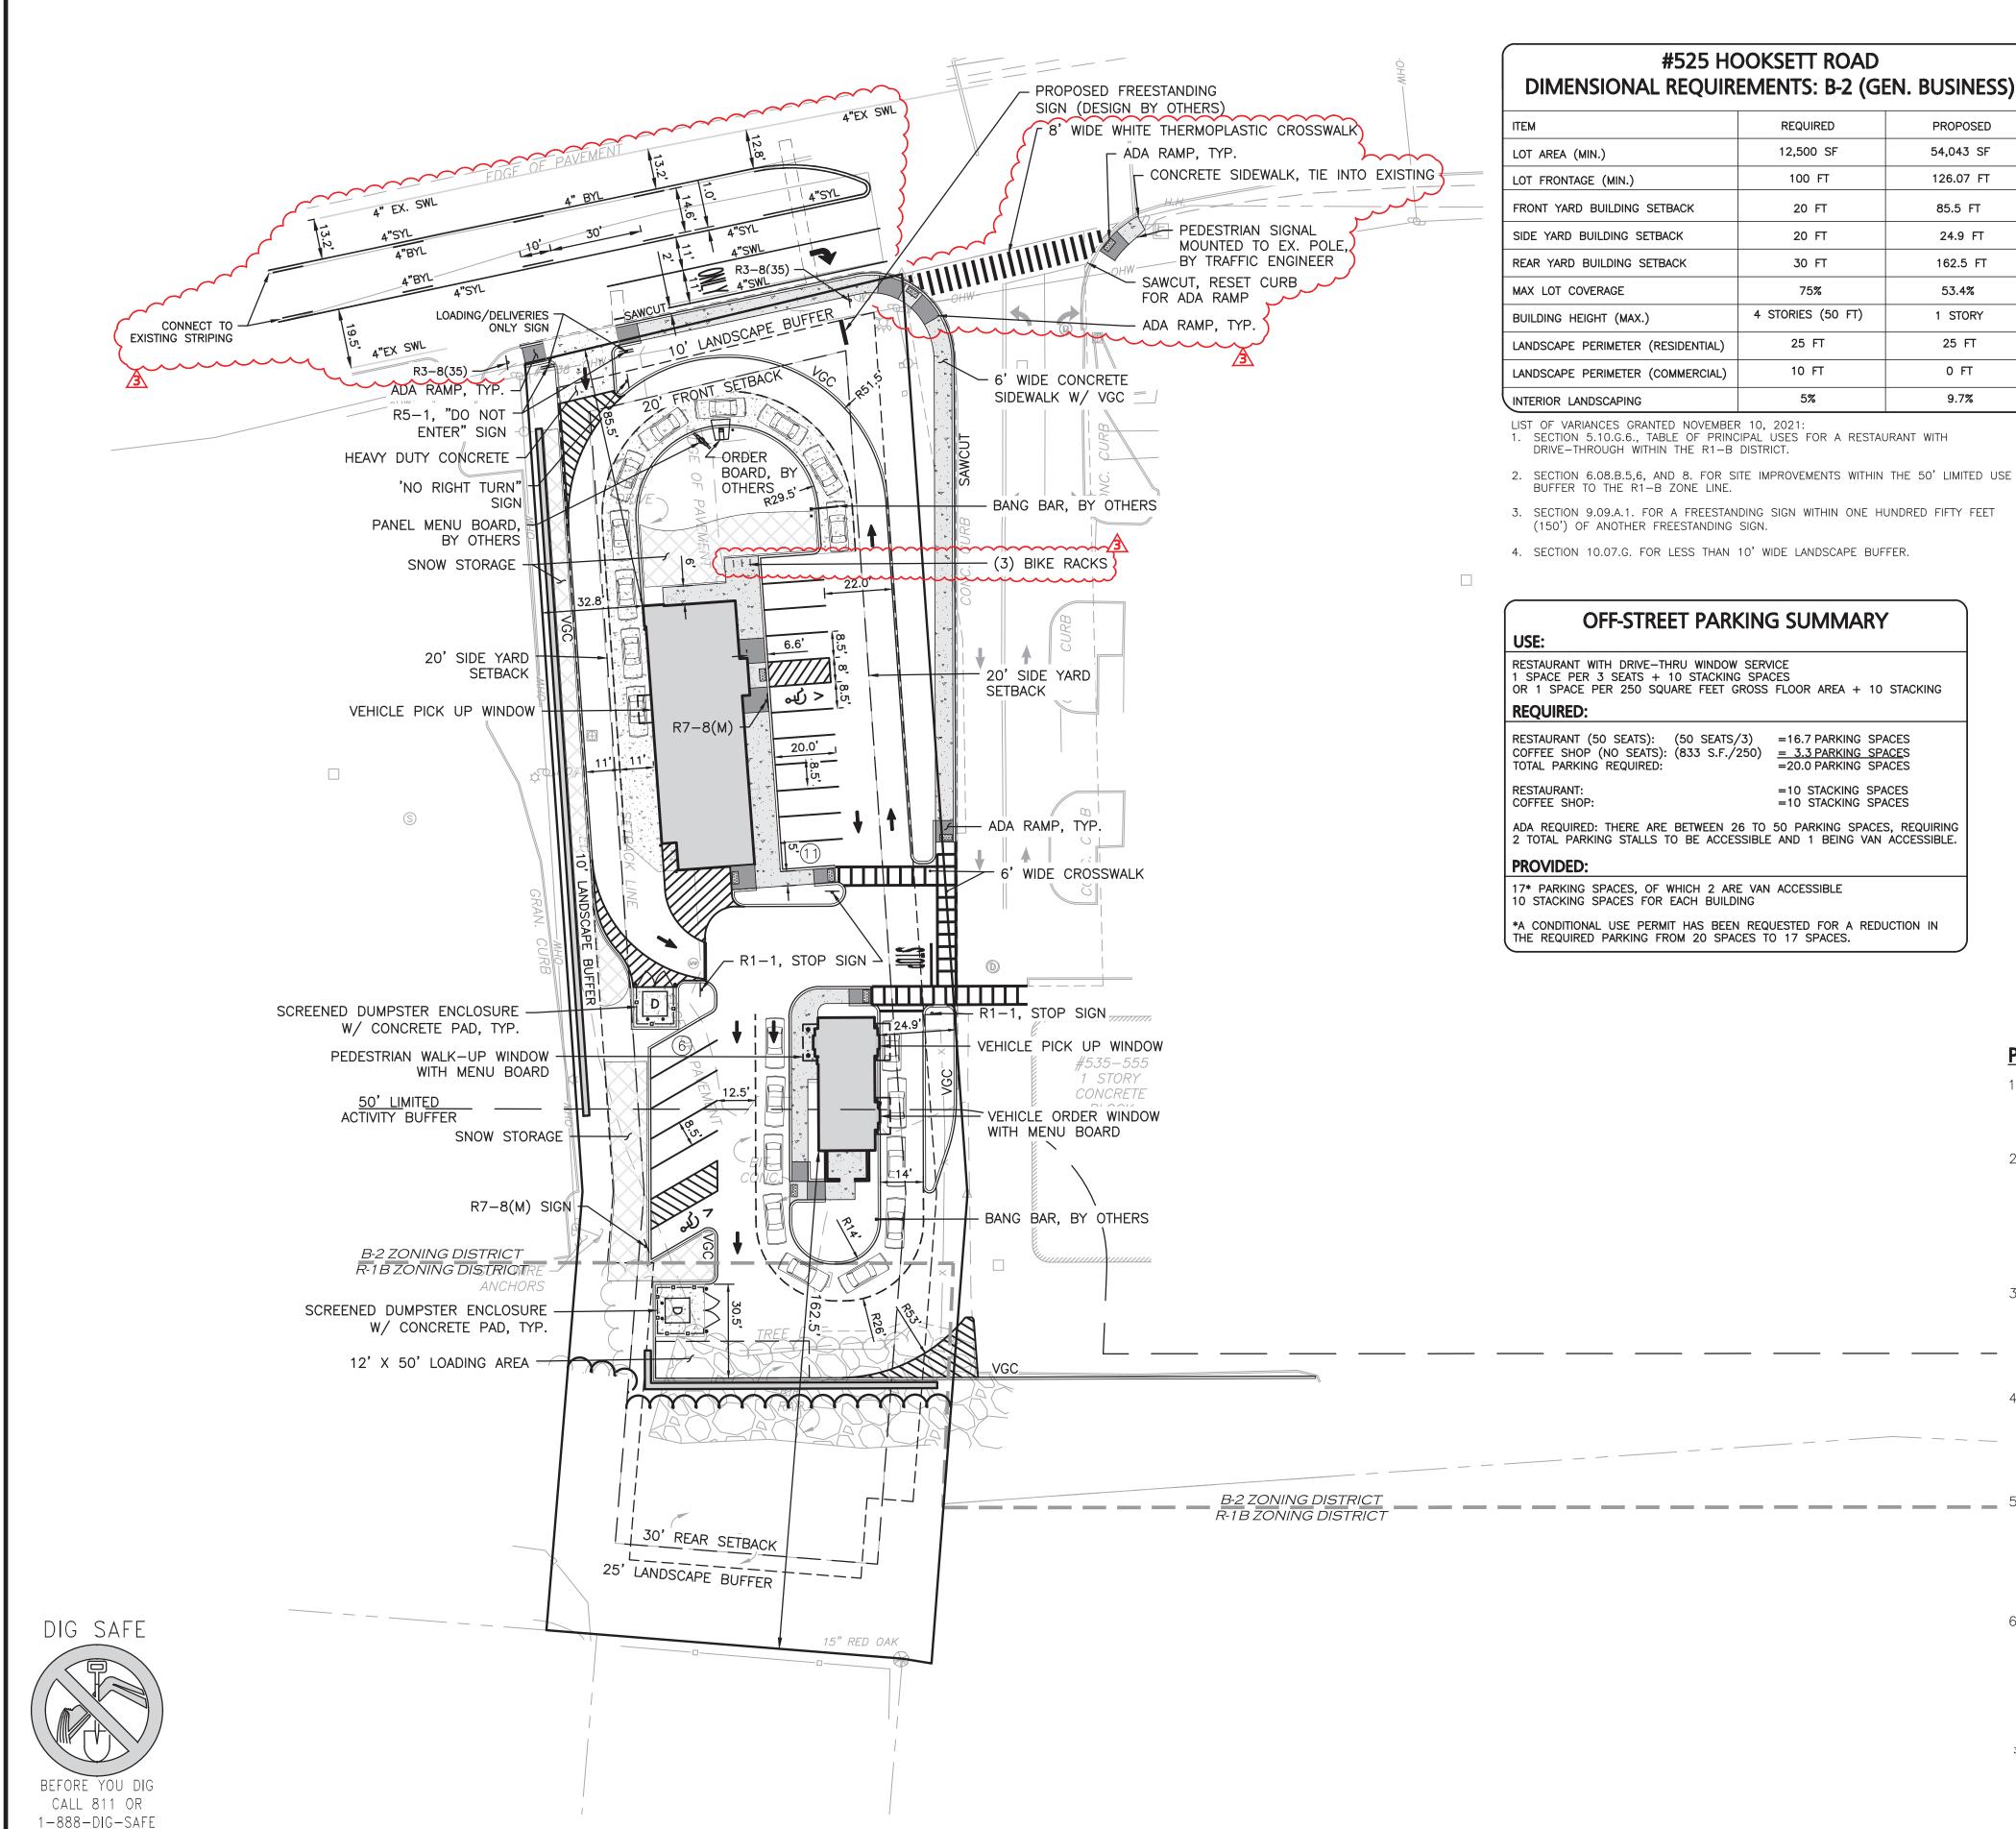

1-888-344-7233




LEGEND


PROPERTY LINE SIGN BOLLARD BUILDING BUILDING ARCHITECTURE BUILDING INTERIOR WALLS VERTICAL GRANITE CURB RETAINING WALL PARKING STRIPING ROADWAY STRIPING TRAFFIC ARROWS HEAVY DUTY CONCRETE SIDEWALK ADA ACCESSIBLE RAMP ADA DET. WARNING SURFACE SNOW STORAGE SETBACK LINE SAW-CUT LINE _____ PARKING COUNT BYL BROKEN YELLOW LINE SOLID YELLOW LINE SOLID WHITE LINE SWL

PLAN NOTES:

- 1. EXISTING CONDITIONS WERE COMPILED FROM AN ON THE GROUND SURVEY PERFORMED BY ALLEN & MAJOR ASSOCIATES AS WELL AS AVAILABLE RECORD PLANS OBTAINED FROM THE CITY OF MANCHESTER AND OTHER SOURCES.
- 2. THE CONTRACTOR IS SPECIFICALLY CAUTIONED THAT THE LOCATION AND/OR ELEVATION OF EXISTING UTILITIES AND STRUCTURES AS SHOWN ON THESE PLANS IS BASED ON RECORDS OF VARIOUS UTILITY COMPANIES AND WHERE POSSIBLE. MEASUREMENTS TAKEN IN THE FIELD. THIS INFORMATION IS NOT TO BE RELIED ON AS BEING EXACT OR COMPLETE. THE LOCATION OF ALL UNDERGROUND UTILITIES AND STRUCTURES SHALL BE VERIFIED IN THE FIELD BY THE CONTRACTOR PRIOR TO THE START OF CONSTRUCTION.
- 3. THE CONTRACTOR MUST CONTACT THE APPROPRIATE UTILITY COMPANY, ANY GOVERNING PERMITTING AUTHORITY, AND "DIGSAFE" AT LEAST 72 HOURS PRIOR TO ANY EXCAVATION WORK. THE CONTRACTOR SHALL ALSO CONTACT THE CITY DEPARTMENT OF PUBLIC WORKS AT LEAST 72 HOURS PRIOR TO ANY EXCAVATION WORK TO REQUEST EXACT FIELD LOCATION OF LOCAL UTILITIES.
- 4. THE ENGINEER SHALL BE NOTIFIED IN WRITING OF ANY UTILITIES INTERFERING WITH THE PROPOSED CONSTRUCTION AND APPROPRIATE REMEDIAL ACTION TAKEN BEFORE PROCEEDING WITH THE WORK. I SHALL BE THE RESPONSIBILITY OF THE CONTRACTOR TO RELOCATE ALL EXISTING UTILITIES WHICH CONFLICT WITH THE PROPOSED IMPROVEMENTS SHOWN ON THE PLANS.
- 5. WRITTEN DIMENSIONS ON THIS PLAN TAKE PRECEDENCE OVER SCALED DIMENSIONS. THE CONTRACTOR SHALL USE CAUTION WHEN SCALING REPRODUCED PLANS. IN THE EVENT OF A CONFLICT BETWEEN THIS PLAN SET AND ANY OTHER DRAWINGS AND/OR SPECIFICATIONS OR CONDITIONS, THE ENGINEER SHALL BE NOTIFIED BY THE CONTRACTOR. ALL SITE ITEMS SHALL BE LAID OUT AND AS BUILT BY A LICENSED LAND SURVEYOR.
- 6. THE INFORMATION SHOWN ON THIS PLAN IS THE SOLE PROPERTY OF ALLEN & MAJOR ASSOCIATES, INC. ITS INTENDED USE IS TO PROVIDE INFORMATION. ANY ALTERATION, MISUSE, OR RECALCULATION OF INFORMATION OR DATA WITHOUT THE EXPRESSED, WRITTEN CONSENT OF ALLEN & MAJOR ASSOCIATES, INC. IS STRICTLY PROHIBITED.

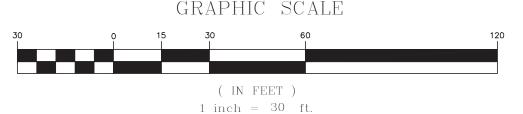

R:\PROJECTS\1583-55B\CIVIL\DRAWINGS\CURRENT\C-1583-55B_LAYOUT & MATERIALS.DWG

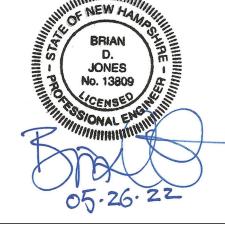

PROFESSIONAL ENGINEER FOR ALLEN & MAJOR ASSOCIATES, INC.

3	05-26-22	REVS PER CITY DEPT. COMMENTS
2	04-12-22	REVISED PARKING SUMMARY
1	04-06-22	REVISED COFFEE SHOP BUILDING
REV	DATE	DESCRIPTION
	_	

APPLICANT\OWNER:

LINEAR RETAIL PROPERTIES, LLC 5 BURLINGTON WOODS DR. S. 107 BURLINGTON, MA 01803

525 HOOKSETT ROAD AKA DANIEL WEBSTER HWY. MAP-LOT: 916-41A MANCHESTER, NH 03104

PROJECT NO. 1583-55B DATE: 03-15-2022 1" = 30' DWG. NAME: C-1583-55B DRAFTED BY: BDJ CHECKED BY:



ASSOCIATES, INC. civil engineering • land surveying

nvironmental consulting • landscape architecture www.allenmajor.com 400 HARVEY ROAD MANCHESTER, NH 03101 TEL: (603) 627-5500

FAX: (603) 627-5501

SHEET No.

VOBURN, MA ♦ LAKEVILLE, MA ♦ MANCHESTER, NH

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DRAWING TITLE:

LAYOUT & MATERIALS PLAN | C-102

TEST PIT #1 (TP1) EXISTING GROUND ELEVATION: 306.25 PERFORMED BY: BRIAN D. JONES, PE DATE: 05-12-2022					
HORIZON	DEPTH	TEXTURE	COLOR	STRUCTURE	NOTES
PAVEMENT	0-3"	_	_	_	_
GRAVEL BASE	3-18"	_	_	_	BANK RUN GRAVEL
FILL	18-36"	_	_	_	SIMILAR TO "C" HORIZ.
Ab (BURIED)	36-48"	SANDY LOAM	10YR 2/1	MASSIVE, FRIABLE	BURIED TOPSOIL
Bw	48-54"	SANDY LOAM	2.5Y 4/3	MASSIVE, FRIABLE	_
С	54-113"	FINE SANDY	2.5Y 4/4	MASSIVE	_

ESHWT: 84" (ELEVATION=299.25) WEEP: 96"

BEDROCK/REFUSAL: NONE

LOAM

TEST PIT #2 (TP2) EXISTING GROUND ELEVATION: 306.00 PERFORMED BY: BRIAN D. JONES, PE DATE: 05-12-2022						
HORIZON	DEPTH	TEXTURE	COLOR	STRUCTURE	NOTES	
PAVEMENT	0-3"	_	_	_	_	
GRAVEL BASE	3-18"	_	_	_	BANK RUN GRAVEL	
FILL	18-60"	_	-	_	SAND MIXED WITH TOPSOIL	
С	60-114"	MEDIUM SAND	10YR 5/8	SINGLE GRAIN LOOSE	_	

ESHWT: 92" (ELEVATION=298.33) WEEP: 110" BEDROCK/REFUSAL: NONE

INV.OUT=303.30 (CB-06)

29LF, 12"HDPE, S=3.8%

RIM=305.47

INV.IN=302.20 (CB-07)

INV.OUT=302.10 (IS-2) 2LF, 12"HDPE, S=5.0%

TOP OF WALL=307.0 BOT. OF WALL=306.0

(32) STORMTECH SC-310 CHAMBERS

DRAIN LINE AS SHOWN ON

PLAN #28475 & #30264

(NO EASEMENT FOUND)

INFILTRATION SYSTEM-2

TOP OF STONE=303.75 TOP OF CHAMBER=303.25

CHAMBER INVERT=301.92

BOTTOM OF STONE=301.42

INV.IN = 302.25 (RD)

TOP OF WALL=308.5

CONVERT CB TO DMH

INV.IN=302.65 (IS-2)

INV.IN=305.60 (IS-1)

IS-1 INV.OUT=305.50

INV.IN = 303.58 (RD)

3LF, 10"HDPE, S=-3.3%

INFILTRATION SYSTEM-1

TOP OF STONE=307.83

TOP OF CHAMBER=306.83

CHAMBER INVERT=303.08

INV.IN=304.12 (CB-03)

INV.OUT = 303.40 (IS - 1)

(2) 3LF, 24"HDPE, S=5.0%

BOTTOM OF STONE=302.33

INV.OUT=297.52 (EX 18"RCP)

(12) STORMTECH MC-3500 CHAMBERS

FINISHED GRADE=309.00(MIN)

BOT. OF WALL=305.5

INV.IN=302.00

INSERTA TEE +

RIM = 310.50

INSERTA TEE

INV.IN=303.25

RIM = 308.86

INV.IN=303.25

INV.IN=303.58 (CB2)

TOP OF WALL=307.0

INV.IN=307.15 (RD)

7LF, 12"HDPE, S=3.0%

R-1 B ZONING DISTRIOTRE

B-2 ZONING DISTRICT

TOP OF WALL=312.0

BOT. OF WALL=311.5

TOP OF WALL=317.0

BOT. OF WALL=311.5

INV.OUT=303.79

BOT. OF WALL=305.5

INSERTA TEE -

CB-02

ANCHORS

RIM=309.85

CB-01

RIM=306.50

FFE=

311.00

· WOODED >

TEST PIT #3 (TP3) EXISTING GROUND ELEVATION: 306.20 PERFORMED BY: BRIAN D. JONES, PE DATE: 05-12-2022					
HORIZON	DEPTH	TEXTURE	COLOR	STRUCTURE	NOTES
PAVEMENT	0-3"	_	_	_	_
GRAVEL BASE	3-18"	_	_	_	BANK RUN GRAVEL
FILL	18-60"	_	_	_	SAND MIXED WITH TOPSOIL
С	60-115"	MEDIUM SAND	10YR 5/8	SINGLE GRAIN LOOSE	_

INV.=302.89

- RD-01

CB-04

CB-03

0.32(EX)

INV.=303.90

RIM = 309.70

RIM = 310.40

INV.OUT=305.17

RD-03

S=1.0%

RIM=310.25

- TOP OF WALL=312.00

BOT. OF WALL=311.5

TOP OF WALL=319.5

BOT. OF WALL=311.5

CB-05

INV.=307.97

82LF, 6"HDPE,

INV.IN=307.55 (UD)

89LF, 12"HDPE, S=2.0%

INV.OUT=307.05

INV.OUT=306.50

16LF, 6"HDPE, S=4.0%

IS-2 INV.OUT=302.4

4LF, 6"HDPE, S=-6.3%

16LF, 6"HDPE, S=2.0%

41LF, 12"HDPE, S=3.0%


INV.IN=305.27 (CB-04)

INV.IN=305.27 (CB-05)


105LF, 12"HDPE, S=1.0%

ESHWT: 94" (ELEVATION=298.37) WEEP: 112"

BEDROCK/REFUSAL: NONE

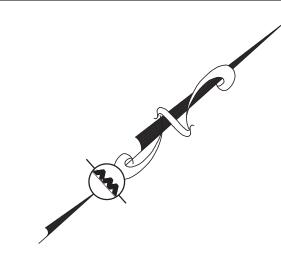

HOOKSETT ROAD

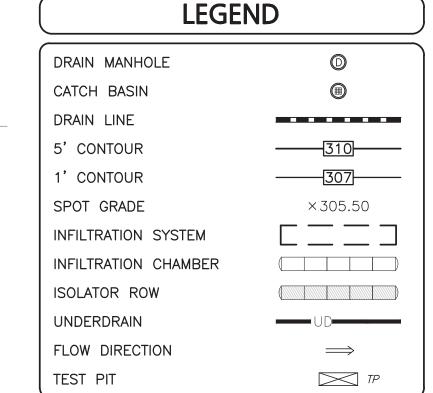

PLAN NOTES:

- 1. TOP AND BOTTOM OF WALL ELEVATIONS INDICATE APPROXIMATE SPOT FINISHED GRADE ELEVATIONS. EXACT ELEVATIONS OF THE WALL BLOCKS WILL VARY AND BE PER THE WALL MANUFACTURER. CONTRACTOR SHALL SUBMIT SHOP DRAWINGS TO THE ENGINEER-OF-RECORD FOR REVIEW AND
- 2. THE LOCATIONS OF EXISTING UNDERGROUND UTILITIES ARE SHOWN IN AN APPROXIMATE WAY ONLY AND HAVE NOT BEEN INDEPENDENTLY VERIFIED BY THE OWNER OR ITS REPRESENTATIVE. THE CONTRACTOR SHALL DETERMINE THE EXACT LOCATION OF ALL EXISTING UTILITIES BEFORE COMMENCING WORK, AND AGREES TO BE FULLY RESPONSIBLE FOR ANY AND ALL DAMAGES WHICH MIGHT BE OCCASIONED BY THE CONTRACTOR'S FAILURE TO EXACTLY LOCATE AND PRESERVE ANY AND ALL UNDERGROUND UTILITIES.
- 3. VERTICAL DATUM IS NAVD88. EXISTING GRADE CONTOUR INTERVALS SHOWN AT 1 FOOT. PROPOSED GRADE CONTOUR INTERVALS SHOWN AT 1 FOOT.
- 4. ALL CUT OR FILL SLOPES SHALL BE 3:1 OR FLATTER UNLESS OTHERWISE NOTED.
- 5. PIPE DIMENSIONS ARE MEASURED FROM THE OUTSIDE WALL OF THE STRUCTURE.
- 6. ROOF DRAIN LOCATIONS TO BE BASED ON FINAL BUILDING PLANS. CONNECTION POINTS SHALL BE AS SHOWN HEREON.
- 7. IF ANY EXISTING STRUCTURES TO REMAIN ARE DAMAGED DURING CONSTRUCTION IT SHALL BE THE CONTRACTOR'S RESPONSIBILITY TO REPAIR AND/OR REPLACE THE EXISTING STRUCTURE AS NECESSARY TO RETURN IT TO EXISTING CONDITIONS OR BETTER.
- 8. ALL STORM DRAIN MANHOLES IN PAVED AREAS SHALL BE FLUSH WITH PAVEMENT AND SHALL HAVE TRAFFIC BEARING RING & COVERS, H-20 MINIMUM.
- 9. CONTRACTOR SHALL ADJUST AND/OR CUT EXISTING PAVEMENT AS NECESSARY TO ENSURE A SMOOTH FIT AND CONTINUOUS GRADE.
- 10. CONTRACTOR SHALL ENSURE POSITIVE DRAINAGE AWAY FROM BUILDINGS FOR ALL NATURAL AND PAVED AREAS.
- 11. ALL DRAINAGE SHALL CONFORM TO LOCAL REQUIREMENTS.
- 12. THE INFORMATION SHOWN ON THIS PLAN IS THE SOLE PROPERTY OF ALLEN & MAJOR ASSOCIATES, INC. ANY ALTERATION, MISUSE, OR RECALCULATION OF INFORMATION OR DATA WITHOUT THE EXPRESSED, WRITTEN CONSENT OF ALLEN & MAJOR ASSOCIATES, INC. IS STRICTLY PROHIBITED.

CITY NOTES


ALL IMPROVEMENTS AND STRUCTURES SPECIFIED ON THESE SITE PLANS SHALL BE CONSTRUCTED, COMPLETED, INSPECTED, AND APPROVED BY THE CITY PRIOR TO ISSUANCE OF A CERTIFICATE OF OCCUPANCY, WHERE APPLICABLE. ALL STORMWATER STRUCTURES SHALL BE INSPECTED AND CLEANED FOLLOWING SITE STABILIZATION AND PRIOR TO ISSUANCE OF A CERTIFICATE OF OCCUPANCY, WHERE APPLICABLE. A REPORT INCLUDING FINDINGS AND CLEANING ACTIVITIES SHALL BE SUBMITTED TO DPW.

·

2. THE CONTRACTOR SHALL STAKE OUT AND PROTECT THE PROPOSED INFILTRATION SYSTEMS DURING ALL CONSTRUCTION ACTIVITIES. SEE NOTES BELOW.

INFILTRATION SYSTEM PROTECTION NOTES

- DO NOT TRAFFIC EXPOSED SOIL SURFACE WITH CONSTRUCTION EQUIPMENT. IF FEASIBLE, PERFORM EXCAVATIONS WITH EQUIPMENT POSITIONED OUTSIDE THE LIMITS OF THE INFILTRATION SYSTEM.
- AFTER THE INFILTRATION SYSTEM AREA IS EXCAVATED TO THE FINAL DESIGN ELEVATION, THE FLOOR SHOULD BE DEEPLY TILLED WITH A ROTARY TILLER OR DISC HARROW TO RESTORE INFILTRATION RATES, FOLLOWED BY A PASS WITH A LEVELING DRAG.
- 5. DO NOT PLACE INFILTRATION SYSTEMS INTO SERVICE UNTIL THE CONTRIBUTING AREAS HAVE BEEN FULLY STABILIZED.

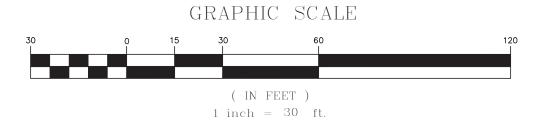

R: \PROJECTS\1583-55B\CIVIL\DRAWINGS\CURRENT\C-1583-55B_GRADING & DRAINAGE.DWG



PROFESSIONAL ENGINEER FOR ALLEN & MAJOR ASSOCIATES, INC.

2	05-26-22	REVISION 1
1	04-06-22	REVISED COFFEE SHOP BUILDING
REV	DATE	DESCRIPTION

APPLICANT\OWNER:

LINEAR RETAIL PROPERTIES, LLC 5 BURLINGTON WOODS DR. S. 107 BURLINGTON, MA 01803

525 HOOKSETT ROAD AKA DANIEL WEBSTER HWY. MAP-LOT: 916-41A MANCHESTER, NH 03104

1583-55B DATE: PROJECT NO. 03-15-2022 1" = 30' DWG. NAME: C-1583-55B SCALE: DRAFTED BY: BDJ | CHECKED BY:



ASSOCIATES, INC. civil engineering • land surveying environmental consulting • landscape architecture www.allenmajor.com

400 HARVEY ROAD MANCHESTER, NH 03101 TEL: (603) 627-5500 FAX: (603) 627-5501

WOBURN, MA ♦ LAKEVILLE, MA ♦ MANCHESTER, NE

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DRAWING TITLE:

GRADING & DRAINAGE PLAN | C-103


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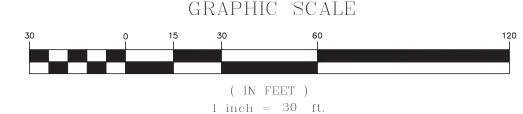
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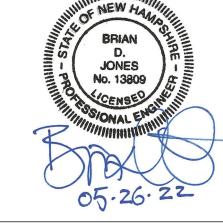
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UTILTITY NOES:

- 1. A MINIMUM OF 10 FEET CLEAR HORIZONTALLY SHALL BE MAINTAINED BETWEEN WATER MAINS AND SANITARY SEWER MAINS AND/OR STORM DRAINS. WHENEVER CONDITIONS PREVENT A LATERAL SEPARATION OF 10 FEET TO A WATER MAIN, THE WATER MAIN SHALL BE LAID IN A SEPARATE TRENCH AND THE DIFFERENCE IN ELEVATION BETWEEN THE WATER MAIN AND THE SEWER MAIN SHALL BE AT LEAST 18 INCHES.
- 2. IN THE CASE THAT WATER MAINS CROSS SANITARY SEWER MAINS AND ARE SEPARATED BY LESS THAT 18" OF VERTICAL CLEARANCE, THE SEWER MAIN SHALL BE ENCASED IN CONCRETE FOR THE ENTIRE WIDTH OF THE TRENCH AND FOR A DISTANCE OF 8 LINEAR FEET CENTERED ON THE CROSSING.
- THE CONTRACTOR SHALL REFER TO ARCHITECTS PLANS AND SPECIFICATIONS FOR ACTUAL LOCATION AND SIZE OF ALL ROOF DRAIN LATERALS AND UTILITY ENTRANCES TO INCLUDE SANITARY SEWER LATERALS, DOMESTIC AND FIRE PROTECTION WATER SERVICE, ELECTRIC, TELEPHONE, AND GAS SERVICE. THE CONTRACTOR SHALL COORDINATE INSTALLATION OF UTILITIES IN SUCH A MANNER AS TO AVOID CONFLICTS AND COORDINATE WITH THE PROPER AGENCY THE LOCATION AND SCHEDULING OF CONNECTIONS WITH THEIR FACILITIES.
- 4. ALL CONSTRUCTION SHALL CONFORM TO THE APPLICABLE REGULATIONS AND STANDARDS INCLUDING THE MUNICIPALITY, NHDOT, NHDES, MUTCD, AND AASHTO.
- 5. THE CONTRACTOR IS RESPONSIBLE FOR THE MEANS AND METHODS OF CONSTRUCTION AND FOR CONDITIONS OF THE SITE. THESE PLANS PREPARED BY ALLEN & MAJOR ASSOCIATES, INC., DO NOT EXTEND TO, NOR INCLUDE SYSTEMS PERTAINING TO THE SAFETY OF THE CONSTRUCTION CONTRACTOR OR THE EMPLOYEES, AGENTS OF REPRESENTATIVES IN PERFORMANCE OF THE WORK. THE SEAL OF THE ARCHITECT OR ENGINEER HEREON DOES NOT EXTEND TO ANY SUCH SAFETY SYSTEMS THAT MAY NOW OR HEREAFTER BE INCORPORATED INTO THESE PLANS. THE CONSTRUCTION CONTRACTOR SHALL PREPARE OF OBTAIN THE APPROPRIATE SAFETY SYSTEMS THAT MAY BE REQUIRED BY THE US OCCUPATIONAL SAFETY AND HEATH ADMINISTRATION (OSHA) AND/OR LOCAL REGULATIONS.
- 6. PIPE DIMENSIONS ARE MEASURED FROM THE INSIDE EDGE OF THE STRUCTURE.
- 7. LOCATION OF PROPOSED ELECTRICAL/COMMUNICATION SERVICE IS SCHEMATIC IN NATURE AND FOR COORDINATION PURPOSES ONLY. SPECIFIC ALIGNMENTS ARE TO BE DESIGNED BY OTHERS AND REVIEWED BY THE UTILITY PROVIDING SERVICE.
- LOCATION OF PROPOSED GAS/PROPANE LINE IS SCHEMATIC IN NATURE AND FOR COORDINATION PURPOSES ONLY. SPECIFIC ALIGNMENTS ARE TO BE DESIGNED BY OTHERS AND REVIEWED BY THE UTILITY PROVIDING SERVICE.
- 9. IT IS THE RESPONSIBILITY OF THE CONTRACTOR TO REVIEW ALL DRAWINGS AND SPECIFICATIONS ASSOCIATED WITH THE PROJECT WORK SCOPE PRIOR TO THE START OF CONSTRUCTION. SHOULD THE CONTRACTOR FIND A CONFLICT WITH THE DRAWINGS, SPECIFICATIONS, OR RELATIVE CODES, IT IS THE RESPONSIBILITY OF THE CONTRACTOR TO NOTIFY THE ENGINEER AND/OR ARCHITECT PRIOR TO START OF CONSTRUCTION. FAILURE BY THE CONTRACTOR TO NOTIFY THE ENGINEER AND/OR ARCHITECT SHALL CONSTITUTE ACCEPTANCE OF FULL RESPONSIBILITY BY THE CONTRACTOR TO COMPLETE THE SCOPE OF WORK AND/OR DESIGN INTENT OF THE DRAWINGS AND IN FULL COMPLIANCE WITH LOCAL REGULATIONS AND CODES.
- 10. THE DESIGN ENGINEER WAIVES ANY AND ALL RESPONSIBILITY AND LIABILITY FOR PROBLEMS WHICH ARISE FROM FAILURE TO FOLLOW THESE PLANS, SPECIFICATIONS, AND/OR THE DESIGN INTENT THEY CONVEY, OR FOR PROBLEMS WHICH ARISE FROM OTHERS' FAILURE TO OBTAIN AND/OR FOLLOW THE GUIDANCE OF THE DESIGN ENGINEER WITH RESPECT TO ANY ERRORS, OMISSIONS, INCONSISTENCIES, AMBIGUITIES, OR CONFLICTS WHICH ARE DISCOVERED OR ALLEGED.
- 11. POWER FEEDS AND INTERCONNECTIONS FOR SITE LIGHTING TO BE COORDINATED WITH THE ELECTRICAL ENGINEER.
- 12. ALL ELEVATIONS REFER TO NAVD 88.
- 13. ALL WORK MUST CONFORM TO THE CITY OF MANCHESTER DEPARTMENT OF PUBLIC WORKS STANDARDS SPECIFICATIONS AND ANY WORK WITHIN THE CITY RIGHT-OF-WAY REQUIRES AN EXCAVATION PERMIT.





PROFESSIONAL ENGINEER FOR ALLEN & MAJOR ASSOCIATES, INC.
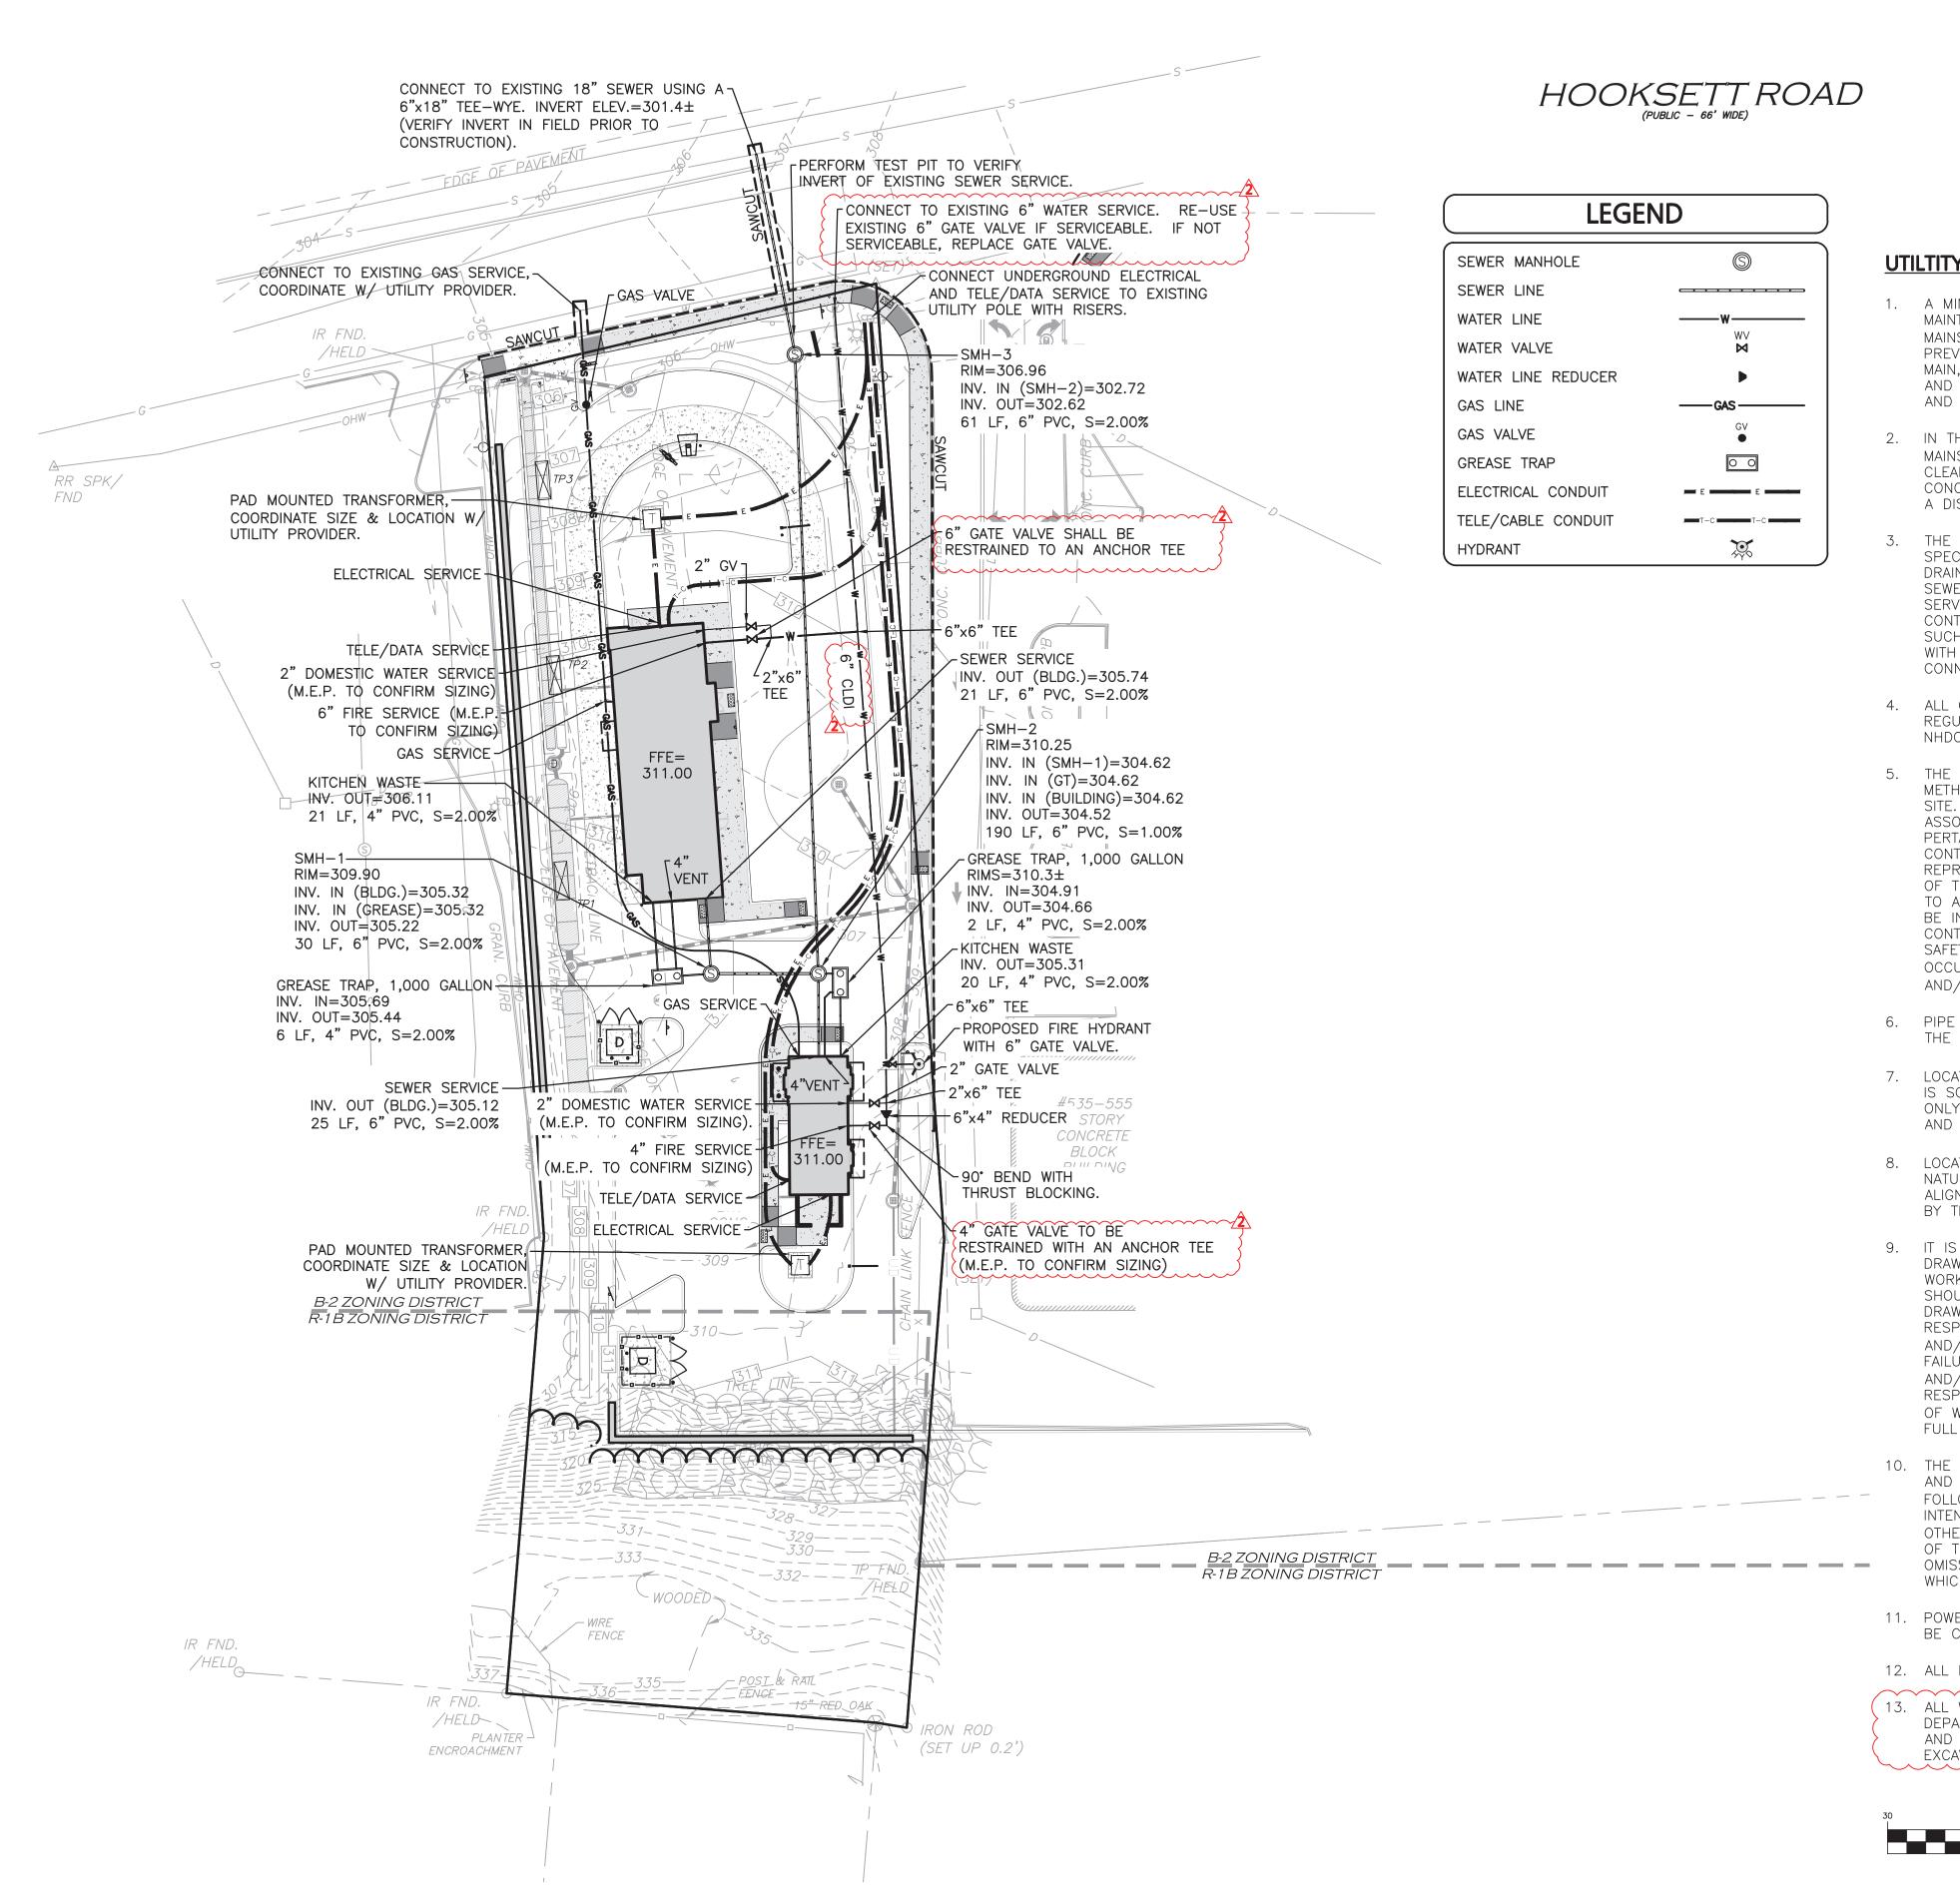
<u>^</u>	05-26-22	REVISED PER MWW COMMENTS
1	04-06-22	REVISED COFFEE SHOP BUILDING
REV	DATE	DESCRIPTION

APPLICANT\OWNER:

LINEAR RETAIL PROPERTIES, LLC 5 BURLINGTON WOODS DR. S. 107 **BURLINGTON, MA 01803**

525 HOOKSETT ROAD AKA DANIEL WEBSTER HWY. MAP-LOT: 916-41A MANCHESTER, NH 03104

PROJECT NO. 1583-55B DATE: 03-15-2022 1" = 30' DWG. NAME: C-1583-55E DRAFTED BY: BDJ | CHECKED BY:



civil engineering ♦ land surveying environmental consulting • landscape architecture www.allenmajor.com 400 HARVEY ROAD

MANCHESTER, NH 03101 TEL: (603) 627-5500 FAX: (603) 627-5501

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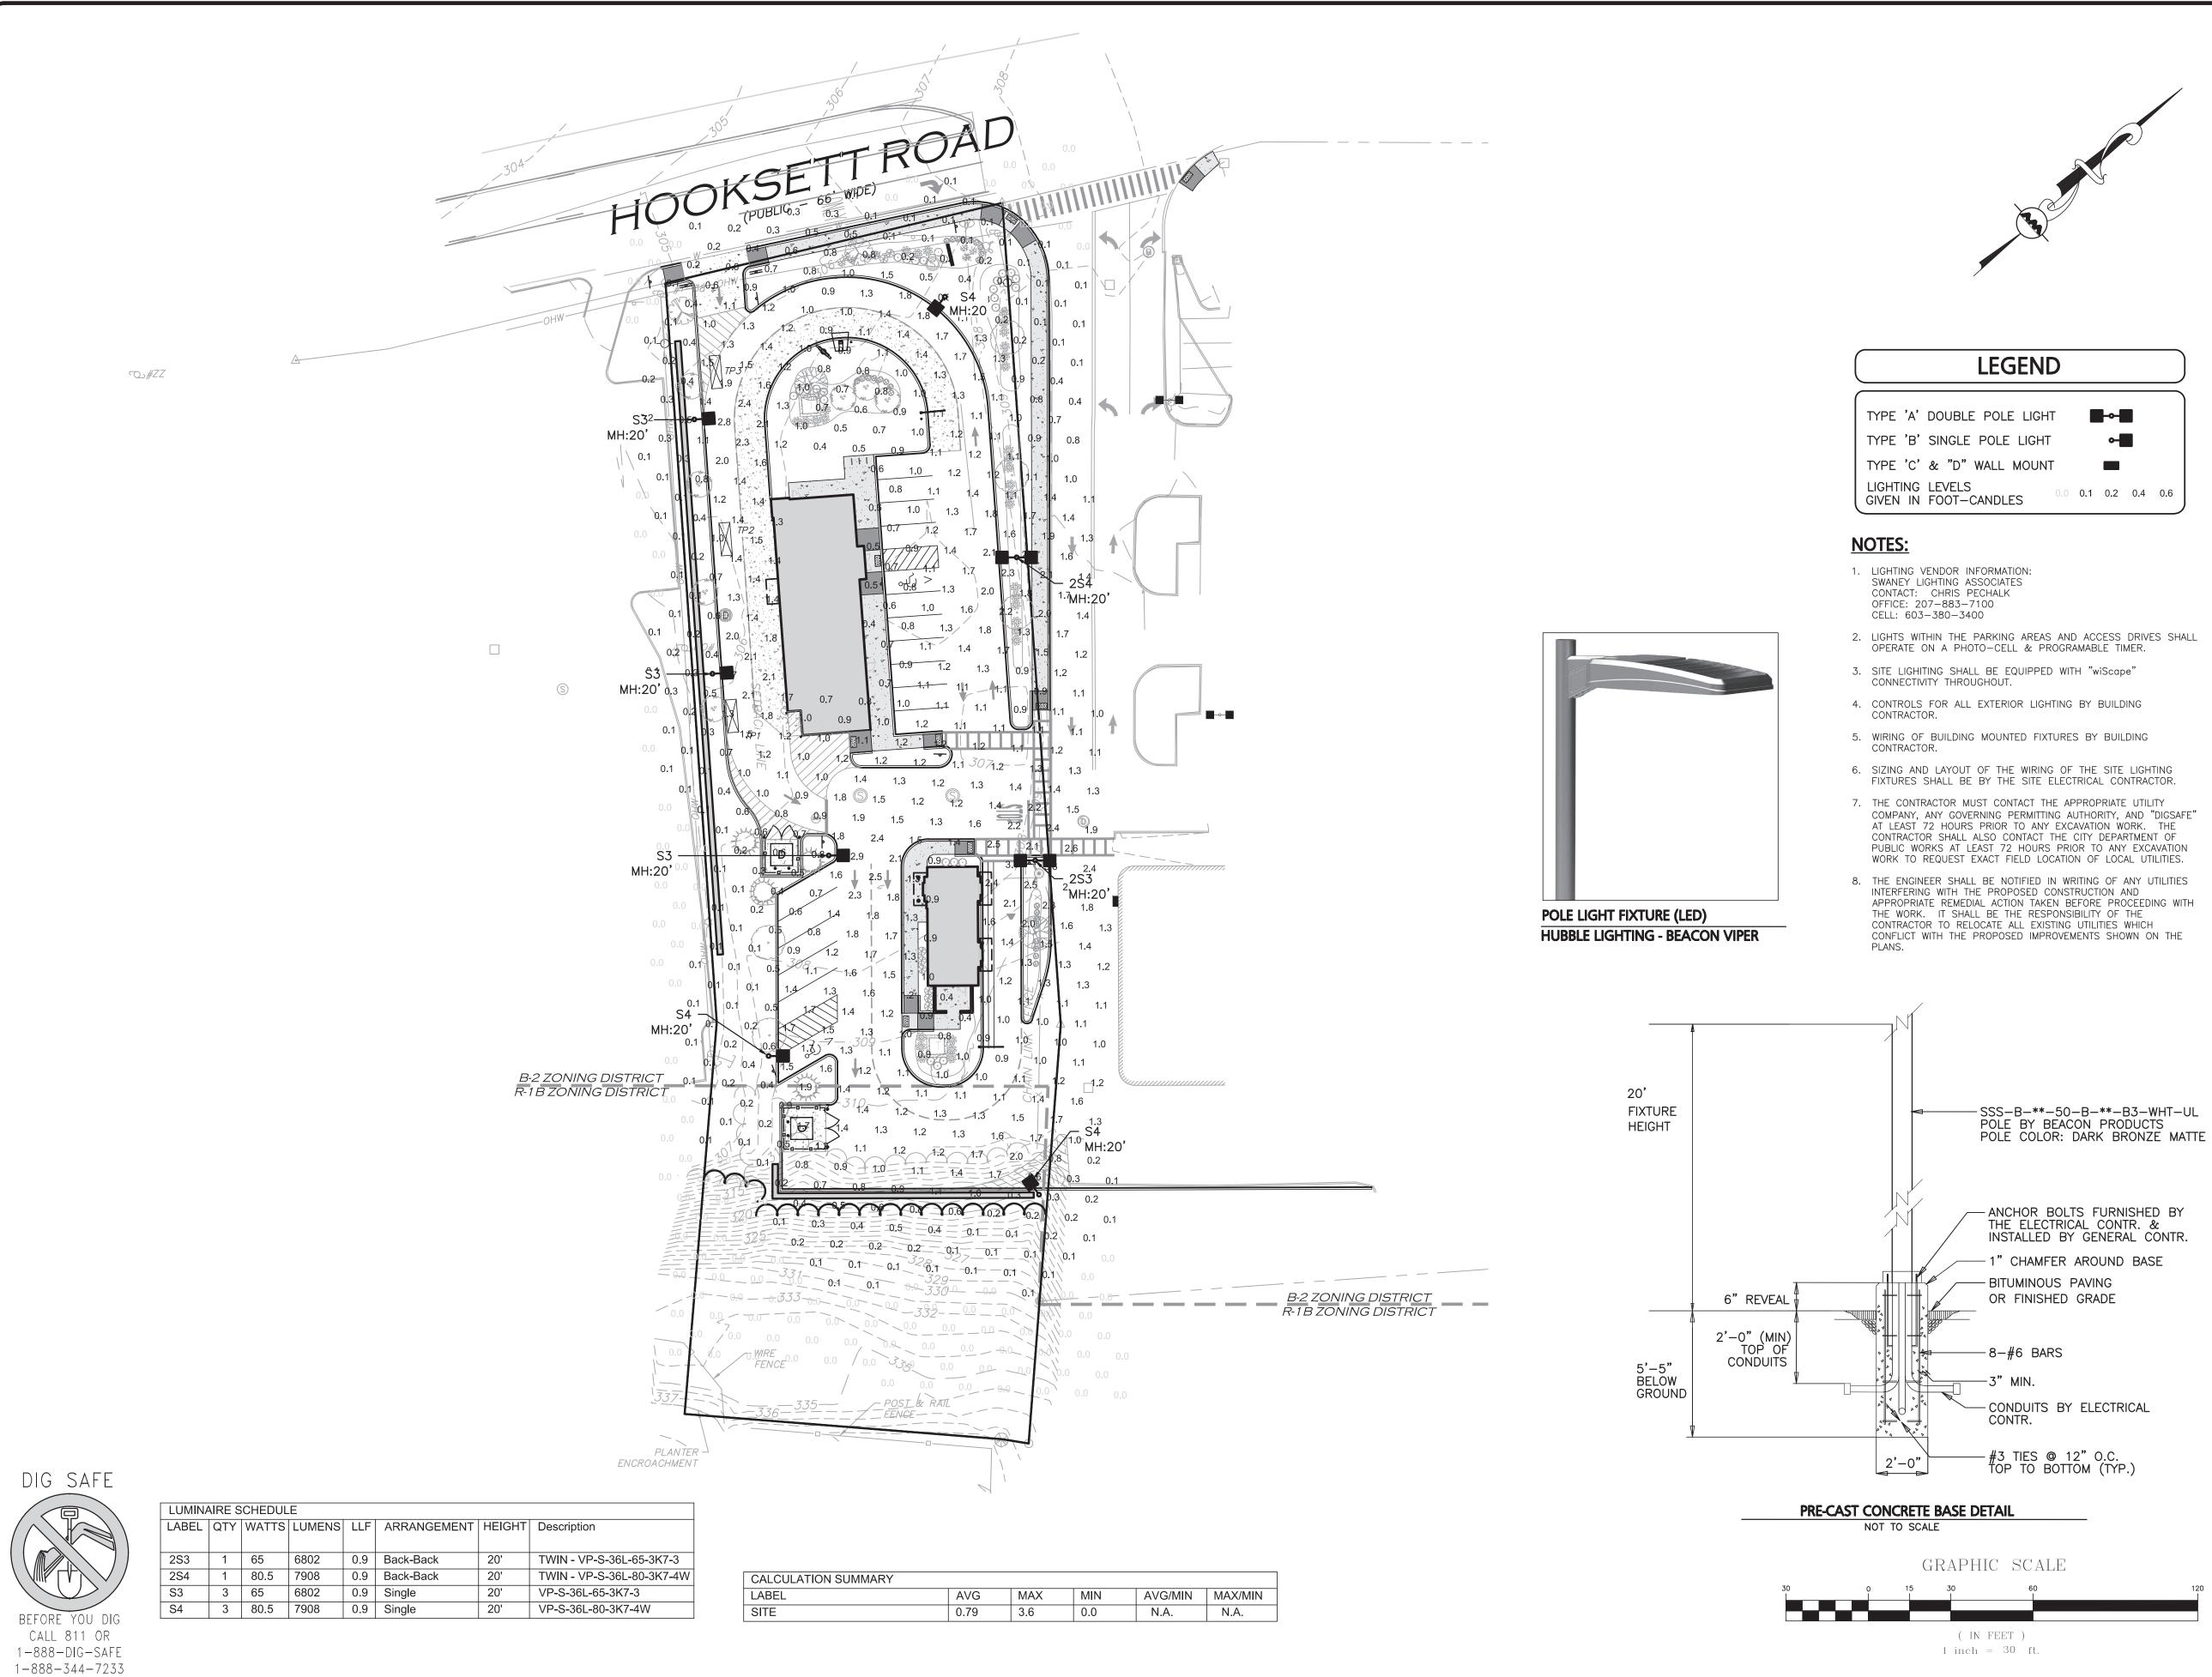
DRAWING TITLE:

C-104 **UTILITIES PLAN**

SHEET No.

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PROFESSIONAL ENGINEER FOR ALLEN & MAJOR ASSOCIATES, INC.

04-06-22 REVISED COFFEE SHOP BUILDING REV DATE DESCRIPTION

APPLICANT\OWNER:

LINEAR RETAIL PROPERTIES, LLC 5 BURLINGTON WOODS DR. S. 107 **BURLINGTON, MA 01803**

PROJECT:

525 HOOKSETT ROAD AKA DANIEL WEBSTER HWY. MAP-LOT: 916-41A MANCHESTER, NH 03104

PROJECT NO. 1583-55B DATE: 03-15-2022 SCALE: 1" = 30' DWG. NAME: C-1583-55B DRAFTED BY: BDJ | CHECKED BY:



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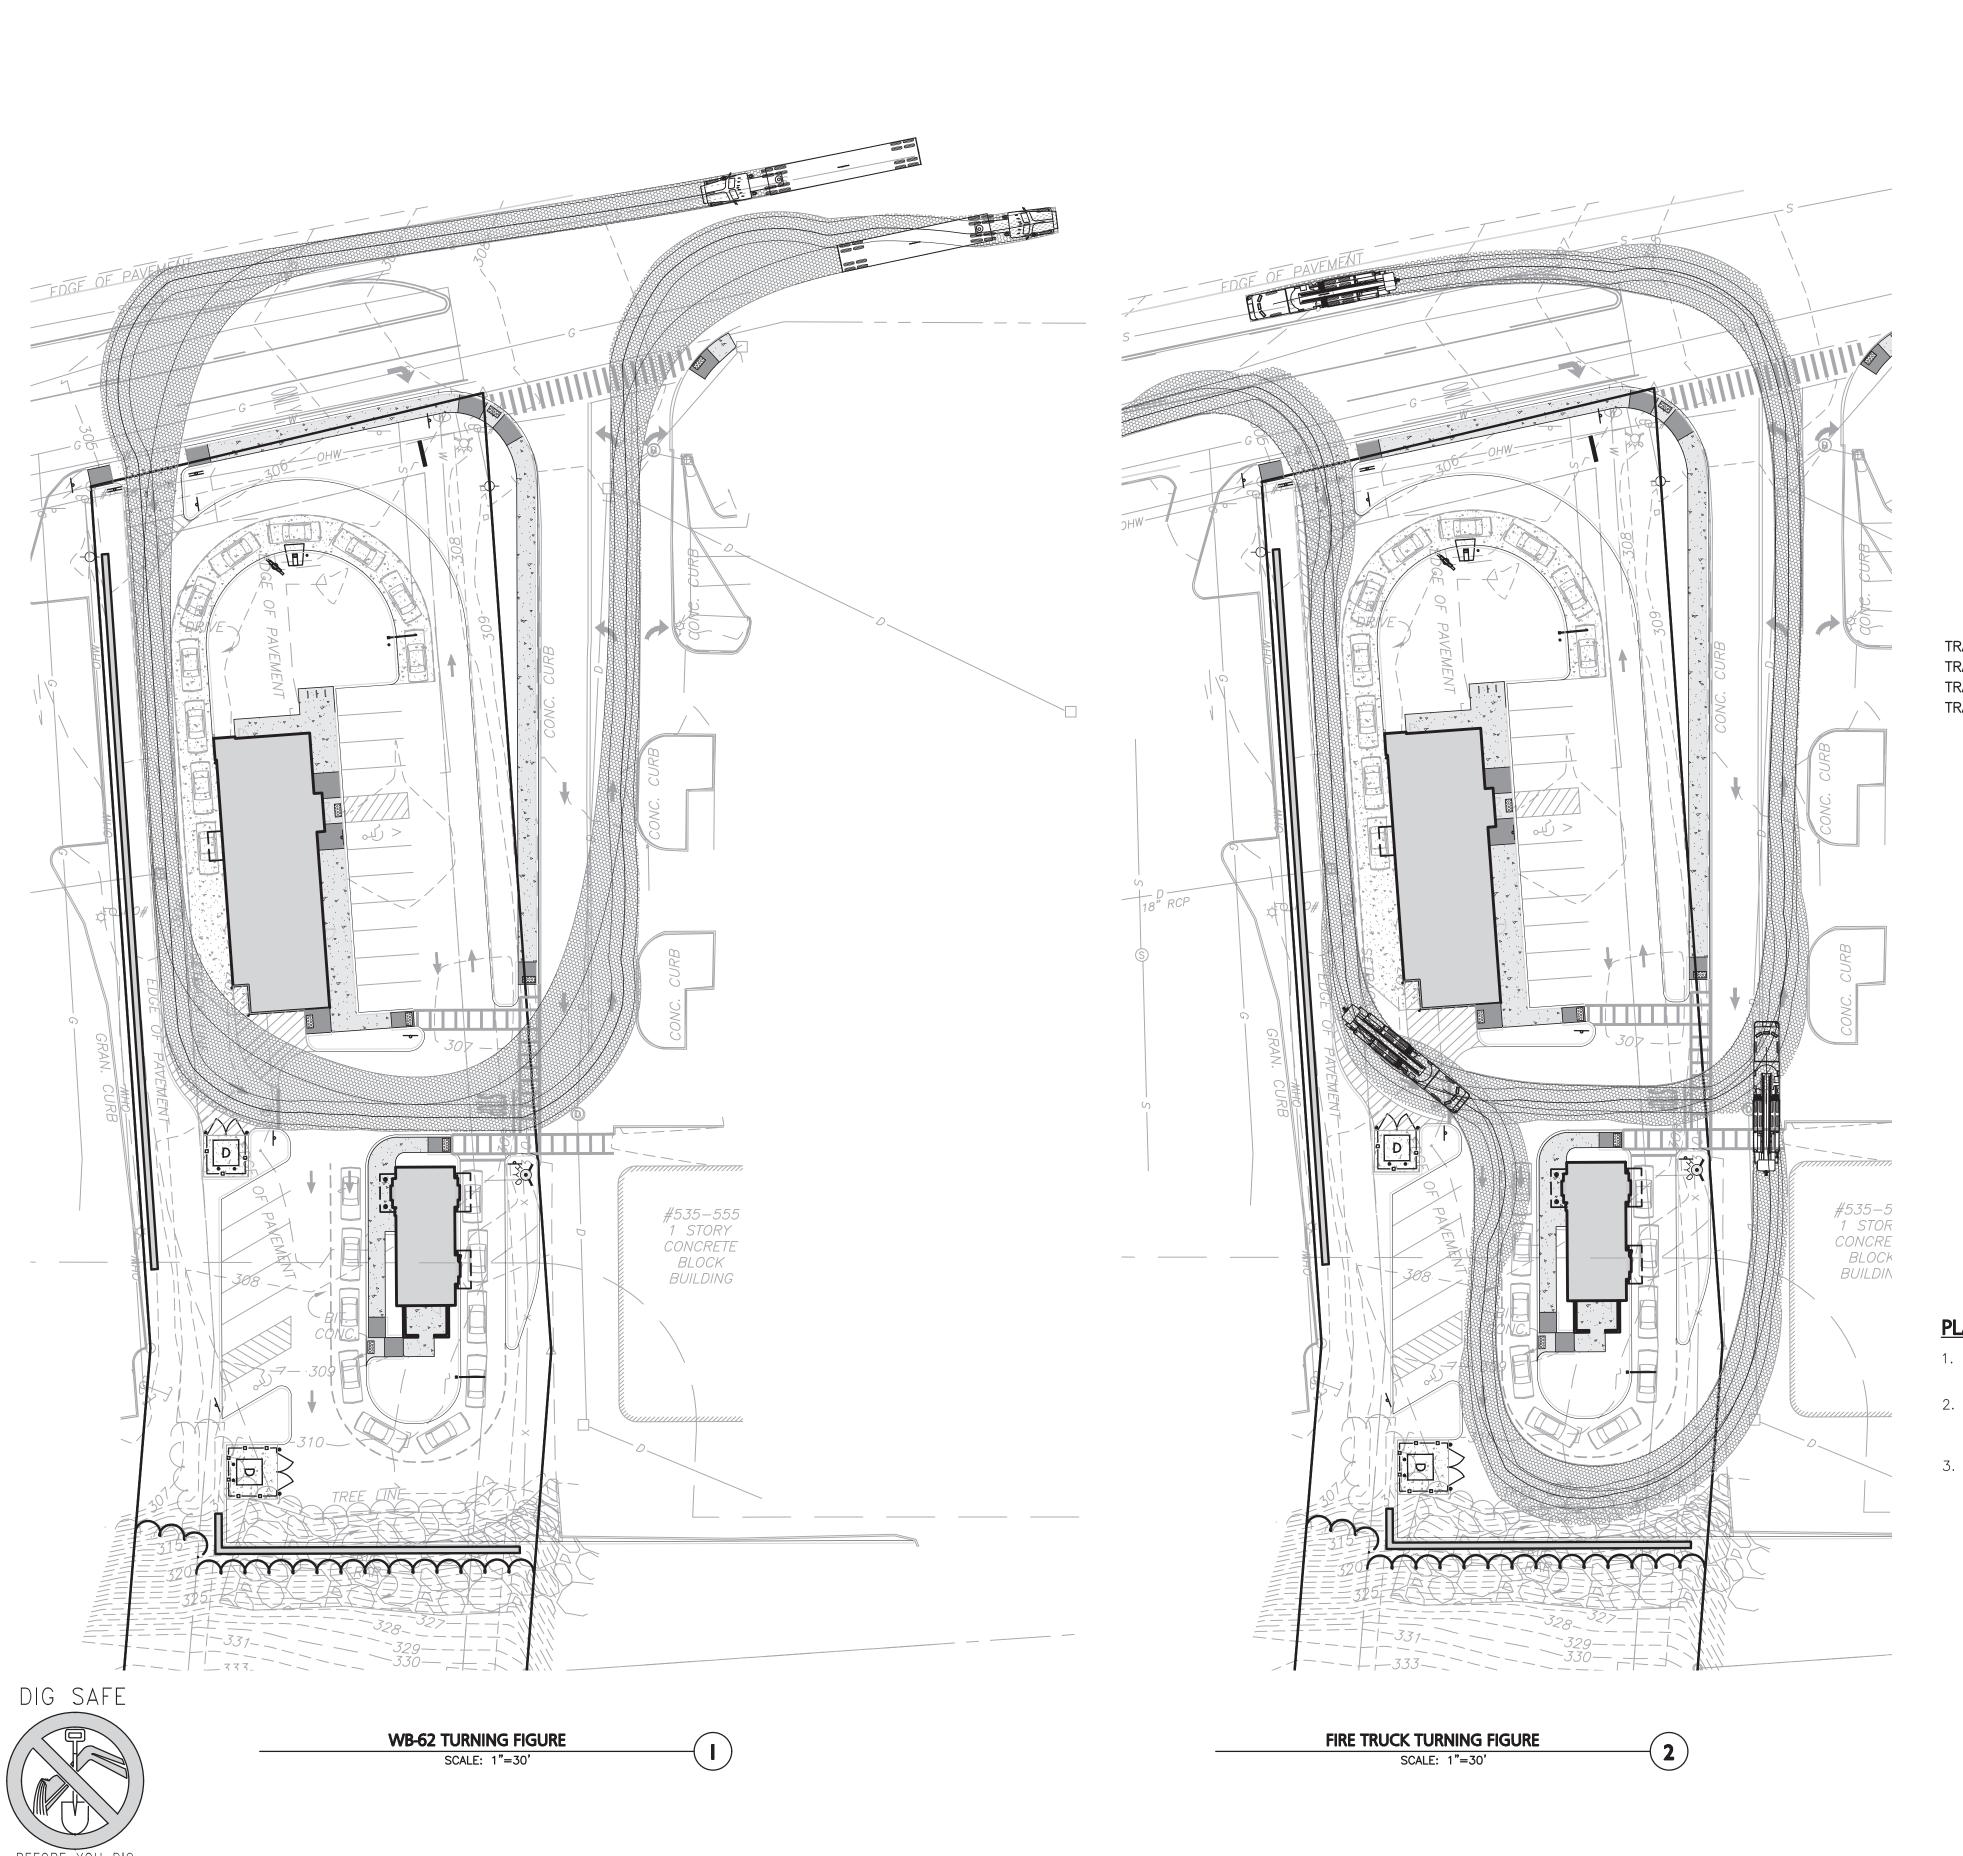
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SHEET No. C-105 LIGHTING PLAN


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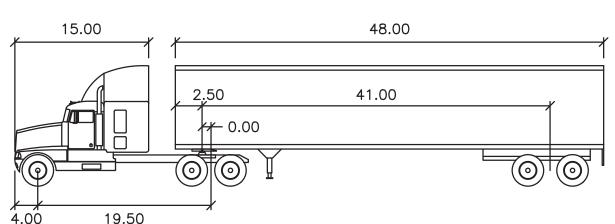
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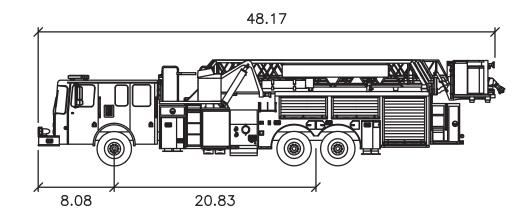




WB - 62

FEET

TRACTOR WIDTH	: 8.00	LOCK TO LOCK TIME	: 6.0
TRAILER WIDTH	: 8.50	STEERING ANGLE	: 28.4
TRACTOR TRACK	: 8.00	ARTICULATING ANGLE	: 70.0
TRAILER TRACK	: 8.50		

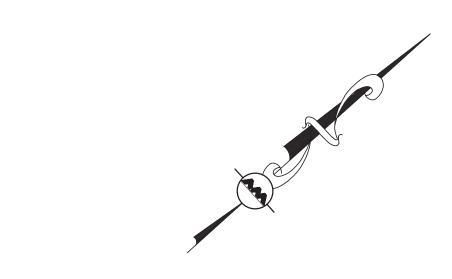


SMEAL PLATFORM MM 100FT


	:	8.33
	:	7.92
LOCK TIME	:	6.0
ANGLE	:	45.0
	LOCK TIME ANGLE	LOCK TIME :

PLAN NOTES:

- THE FIRE TRUCK MOVEMENT SHOWN IS THE ROUTE FROM THE MANCHESTER FIRE DEPARTMENT WEBSTER STREET STATION 5.
- 2. EXISTING CONDITIONS WERE COMPILED FROM AN ON THE GROUND SURVEY PERFORMED BY ALLEN & MAJOR ASSOCIATES AS WELL AS AVAILABLE RECORD PLANS OBTAINED FROM THE CITY OF DOVER AND OTHER SOURCES.
- 3. THE INFORMATION SHOWN ON THIS PLAN IS THE SOLE PROPERTY OF ALLEN & MAJOR ASSOCIATES, INC. ITS INTENDED USE IS TO PROVIDE INFORMATION. ANY ALTERATION, MISUSE, OR RECALCULATION OF INFORMATION OR DATA WITHOUT THE EXPRESSED, WRITTEN CONSENT OF ALLEN & MAJOR ASSOCIATES, INC. IS STRICTLY PROHIBITED.

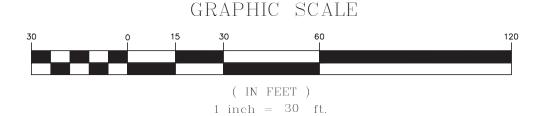

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PROFESSIONAL ENGINEER FOR ALLEN & MAJOR ASSOCIATES, INC.

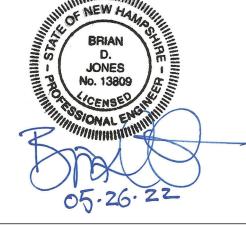REV DATE DESCRIPTION

APPLICANT\OWNER:

LINEAR RETAIL PROPERTIES, LLC 5 BURLINGTON WOODS DR. S. 107 BURLINGTON, MA 01803

525 HOOKSETT ROAD AKA DANIEL WEBSTER HWY. MAP-LOT: 916-41A MANCHESTER, NH 03104

1583-55B DATE: 03-15-2022 PROJECT NO. 1" = 30' DWG. NAME: C-1583-55B

BDJ CHECKED BY: DRAFTED BY:



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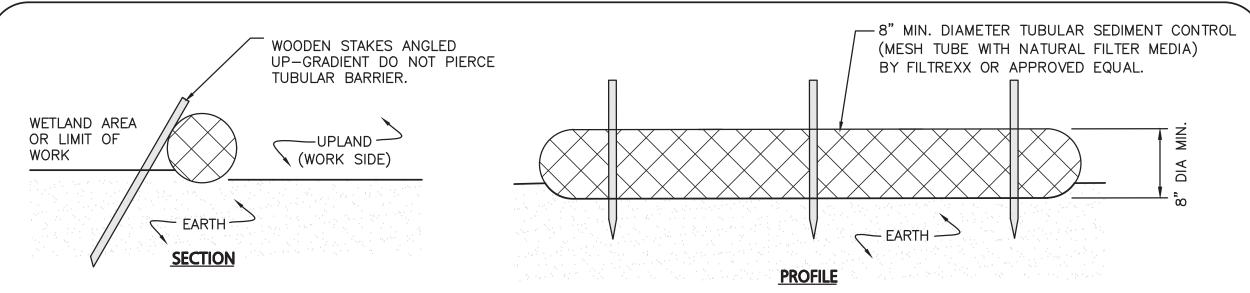
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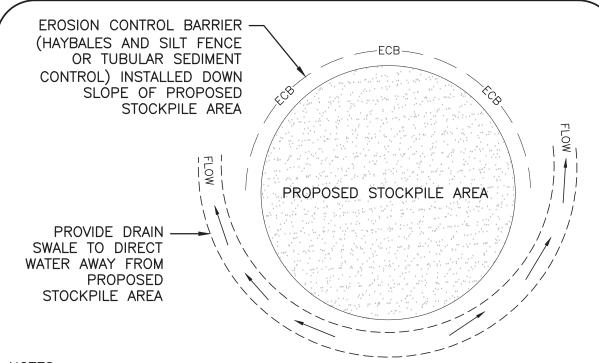
SHEET No.

C-106 TRUCK TURNING PLAN



- 1. TUBULAR SEDIMENT CONTROL SHALL BE 8" MIN. DIAMETER MESH TUBE WITH NATURAL FILTER MEDIA BY FILTREXX OR APPROVED EQUAL.
- 2. ALL MATERIALS TO MEET MANUFACTURERS SPECIFICATIONS.
- 3. INSTALL WOODEN STAKES ANGLED UP-GRADIENT EVERY 8' ON CENTER
- 4. OVERLAP TUBULAR BARRIER SEGMENTS A MINIMUM OF 12".
- 5. THE CONTRACTOR SHALL MAINTAIN THE TUBULAR BARRIERS IN A FUNCTIONAL CONDITION AT ALL TIMES. THE CONTROLS SHALL BE ROUTINELY INSPECTED BY THE CONTRACTOR.
- 6. WHERE THE TUBULAR BARRIERS REQUIRE REPAIR OR SEDIMENT REMOVAL, IT WILL BE COMPLETED BY THE CONTRACTOR AT NO ADDITIONAL COST.
- 7. AT A MINIMUM, THE CONTRACTOR SHALL REMOVE SEDIMENTS COLLECTED AT THE BASE WHEN THEY REACH 1/3 THE EXPOSED HEIGHT OF THE BARRIER.






1. SOIL AND FILL STOCKPILES EXPECTED TO REMAIN IN PLACE FOR LESS THAN 90 DAYS SHALL BE COVERED WITH HAY AND MULCH (AT 100LBS/1,000 SF), OR WITH AN ANCHORED TARP WITHIN 7 DAYS OR PRIOR TO ANY RAÍNFALL.

2. SOIL AND FILL STOCKPILES EXPECTED TO REMAIN IN PLACE FOR 90 DAYS OR MORE SHALL BE SEEDED WITH WINTER RYE (FOR FALL SEEDING AT 3LB/1,000 SF) OR OATS (FOR SUMMER SEEDING AT 2LB/1,000 SF) AND THEN COVERED WITH HAY MULCH (AT 100LB/1,000 SF) OR AN ANCHORED TARP WITHIN 7 DAYS OR PRIOR TO ANY RAINFALL.

MATERIAL.




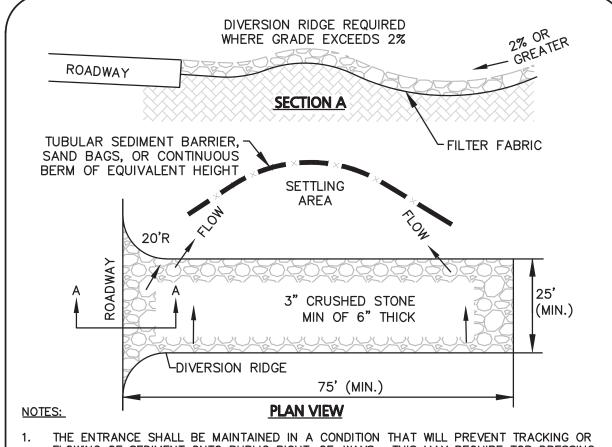


- FLOWING OF SEDIMENT ONTO PUBLIC RIGHT-OF-WAYS. THIS MAY REQUIRE TOP DRESSING, REPAIR AND/OR CLEANOUT OF ANY MEASURES USED TO TRAP SEDIMENT.
- WHEN NECESSARY, WHEELS SHALL BE CLEANED PRIOR TO ENTERING THE PUBLIC RIGHT-OF-WAY.
- WHEN WASHING IS REQUIRED, IT SHALL BE DONE ON AN AREA STABILIZED WITH CRUSHED STONE THAT DRAINS INTO AN APPROVED SEDIMENT TRAP OR SEDIMENT BASIN.

NOT TO SCALE

STABILIZED CONSTRUCTION EXIT

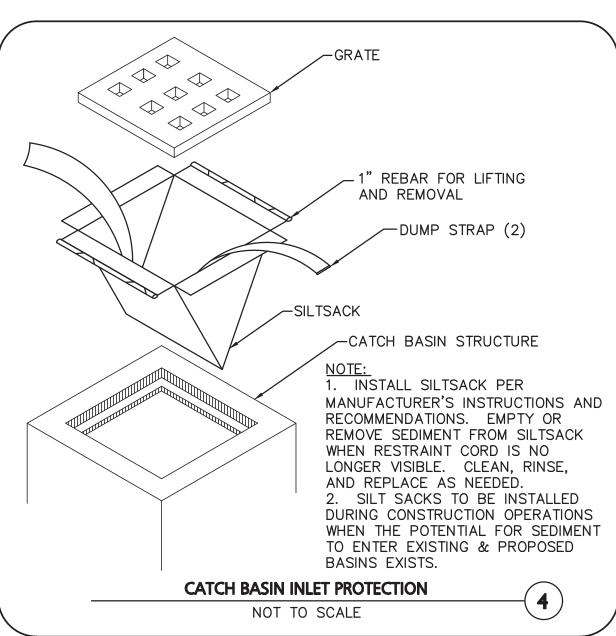

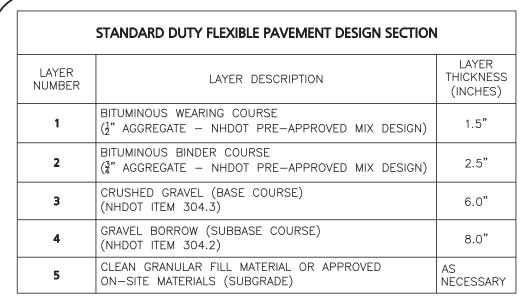

PAVEMENT SECTIONS

NOT TO SCALE

BIT. WEARING COURS
BIT. BINDER COURSE
CRUSHED GRAVEL (BASE COURSE)
BANK RUN GRAVEL (SUBBASE COURSE)
CLEAN GRANULAR FILL OR APPROVED ON-SITE MATERIALS (SUBGRADE)

	GRADATION	SPECIFICAT	ION
	PERCENT	PASSING B	Y WEIGHT
SIEVE SIZE	CLEAN GRANULAR FILL	BASE COURSE	SELECT GRANULAR FILL
8"	100	100	100
3"	70-100	100	70-100
<u>1</u> "	40-100	40-80	40-90
No. 4	25-100	30-70	25-80
No. 10	15-95	20-60	15-70
No. 40	10-70	10-30	5-40
No. 200	0-15	3-10	0-12

BIT. WEARING COURSE BINDER COURSE PAVEMENT DESIGN SHALL BE REVIEWED BY THE HED GRAVEL PROJECT GEOTECHNICAL ENGINEER. THE GEOTECHNICAL COURSE) REPORT IS CONSIDERED PART OF THE CONSTRUCTION RUN GRAVEL BASE COURSE) TOPSOIL SHALL BE REMOVED BENEATH ALL PAVEMENT AREAS TO EXPOSE THE NATURALLY-OCCURRING SOILS OR ACCEPTABLE ON-SITE FILL MATERIALS.

GRADATION SPECIFICATION					
	PERCENT	PASSING B	Y WEIGHT		
SIEVE SIZE	CLEAN GRANULAR FILL	BASE COURSE	SELECT GRANULAR FILL		
8"	100	100	100		
3"	3" 70-100		70-100		
<u>1</u> "	40-100	40-80	40-90		
No. 4	25-100	30-70	25-80		
No. 10	15-95	20-60	15-70		
No. 40	10-70	10-30	5-40		
No. 200	0-15	3-10	0-12		

THE PAVEMENT SUBGRADE CONSISTING OF THE SPECIFIED CLEAN GRANULAR FILL SHALL BE PLACED IN 12" MAXIMUM LIFTS AND COMPACTED TO A DRY DENSITY OF AT LEAST 95 PERCENT OF THE MATERIALS MAXIMUM DRY DENSITY AS DETERMINED BY ASTM DESIGNATION D-1557.


THE SUBGRADE SHOULD BE PROOFROLLED UNDER THE


SUPERVISION OF A GEOTECHNICAL ENGINEER USING AT

LEAST 4 PASSES OF A 10-TON VIBRATORY ROLLER.

AREAS OF THE SUBGRADE THAT "WEAVE" OR "ROLL" EXCESSIVELY SHOULD BE OVER EXCAVATED AND

REPLACED WITH DRIER CLEAN GRANULAR FILL

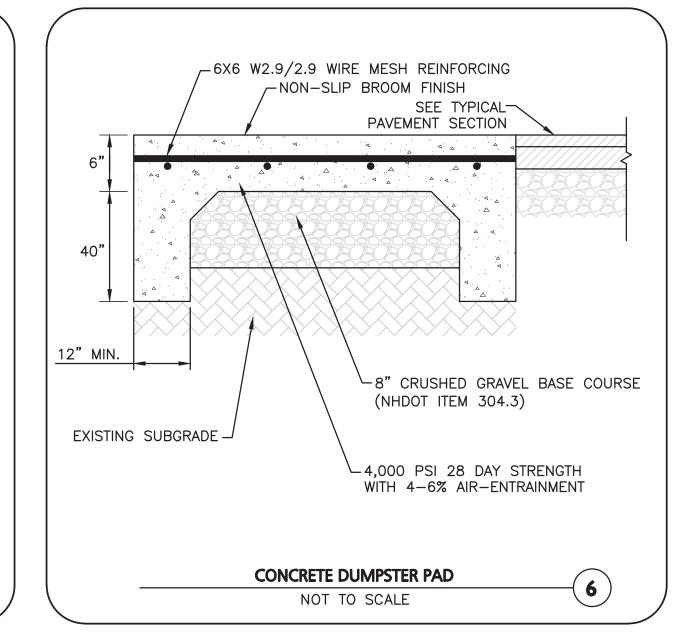

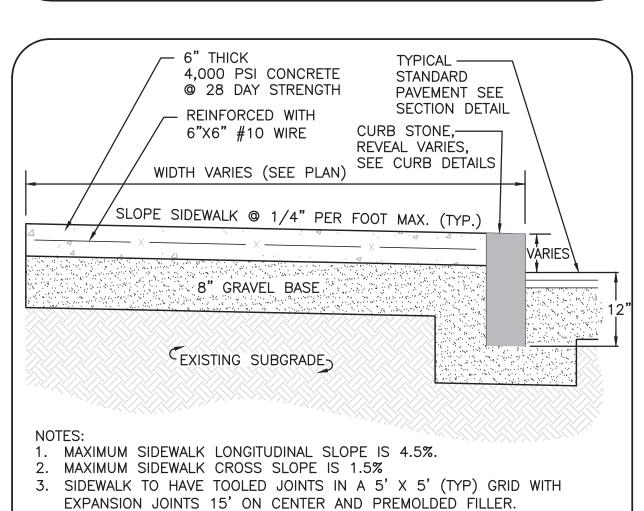

6. LIFT WWF TO CENTER OF SLAB WITH HOOKS AFTER CONCRETE PLACEMENT.


CONCRETE SIDEWALK WITH VERTICAL GRANITE CURB

NOT TO SCALE

4. TOOLED JOINT 6" FROM FACE OF CURB.

7. DOWEL SIDEWALK INTO FOUNDATION AT DOORS.

5. SEE PLAN FOR ELEVATIONS AT CURB.

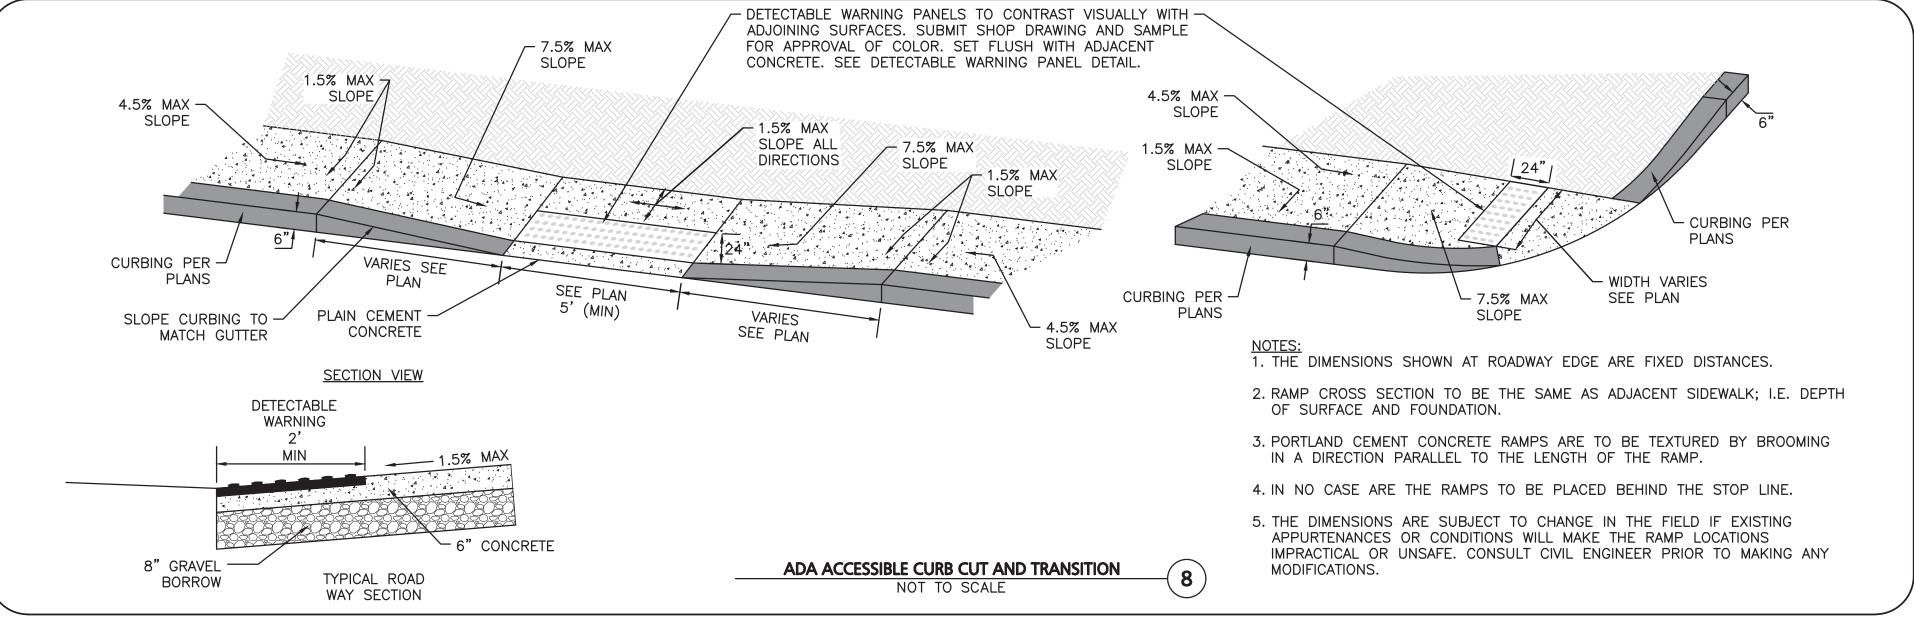



REV DATE DESCRIPTION APPLICANT\OWNER:

LINEAR RETAIL PROPERTIES, LLC 5 BURLINGTON WOODS DR. S. 107 **BURLINGTON**. MA 01803

PROJECT:

525 HOOKSETT ROAD AKA DANIEL WEBSTER HWY. MAP-LOT: 916-41A MANCHESTER, NH 03104

PROJECT NO. 1583-55B DATE: 03-15-2022 AS SHOWN DWG. NAME: C-1583-55E

DRAFTED BY: BDJ CHECKED BY:



ASSOCIATES, INC. civil engineering • land surveying nvironmental consulting • landscape architecture www.allenmajor.com

> 400 HARVEY ROAD MANCHESTER, NH 03101 TEL: (603) 627-5500 FAX: (603) 627-5501

WOBURN, MA ♦ LAKEVILLE, MA ♦ MANCHESTER, NE

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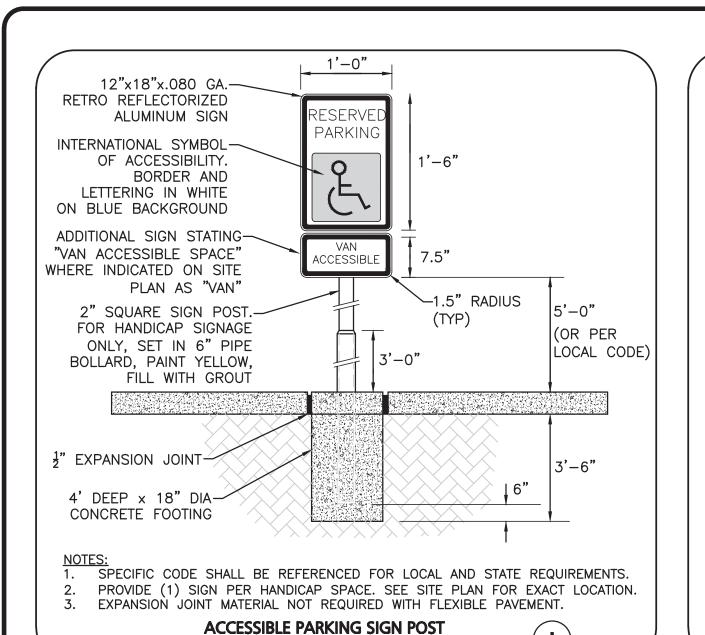
DETAILS

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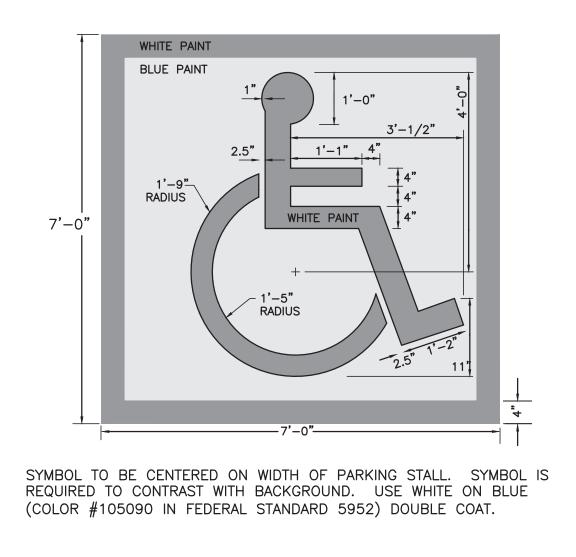
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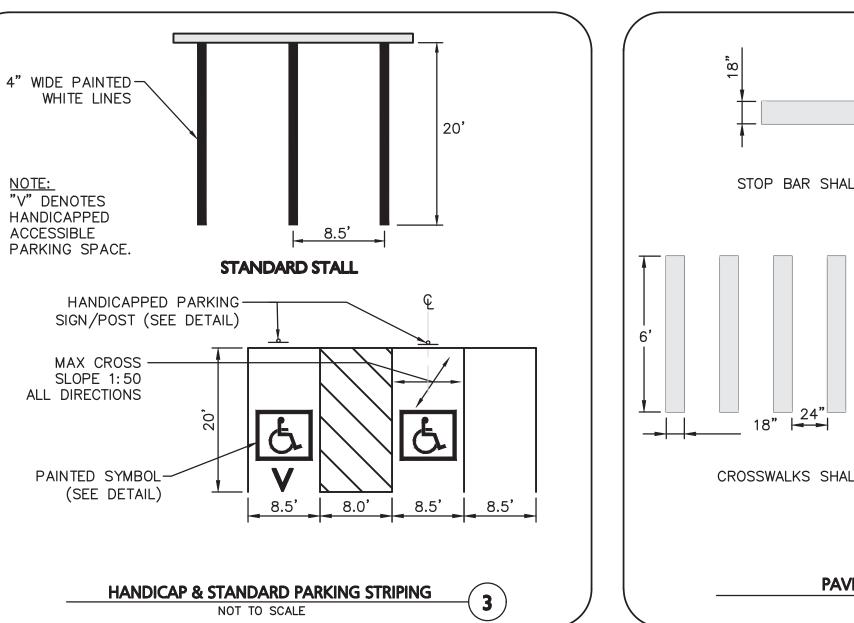



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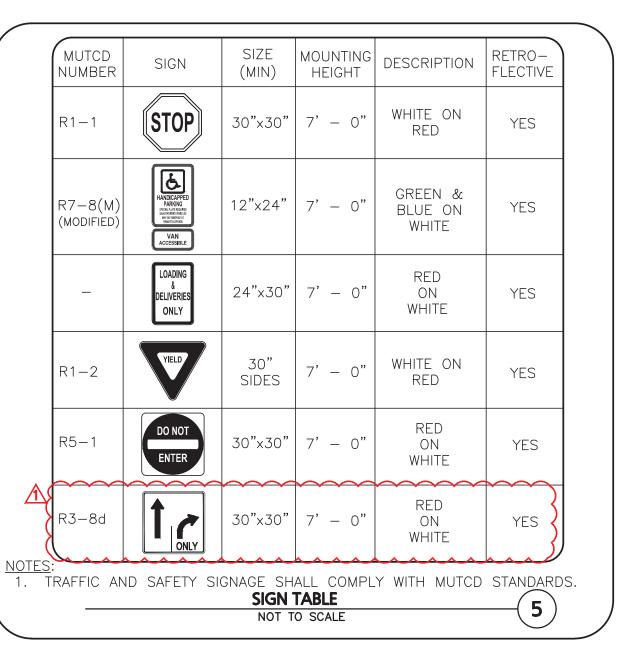



ACCESSIBLE PARKING STALL PAVEMENT MARKING


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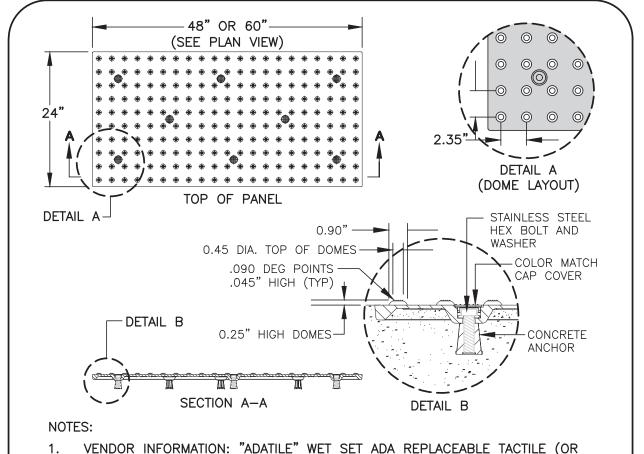






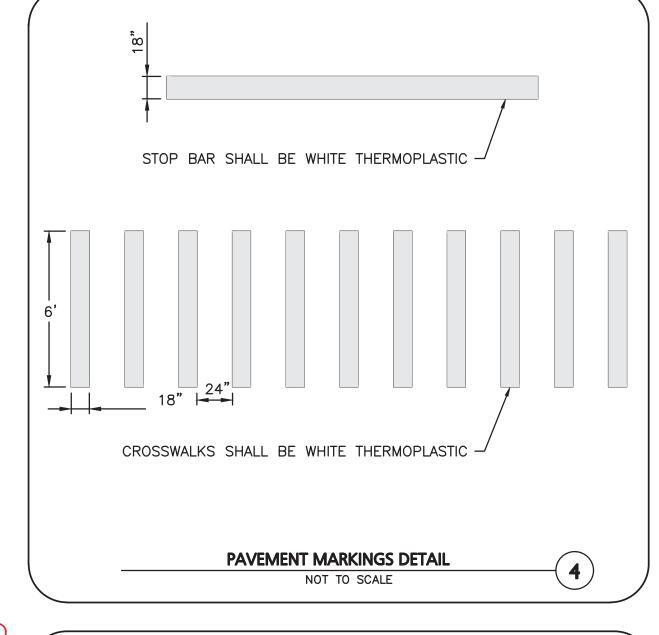
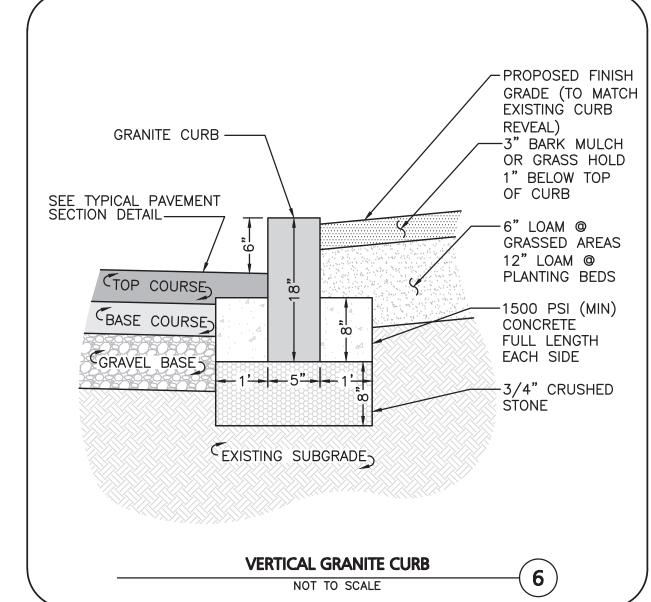
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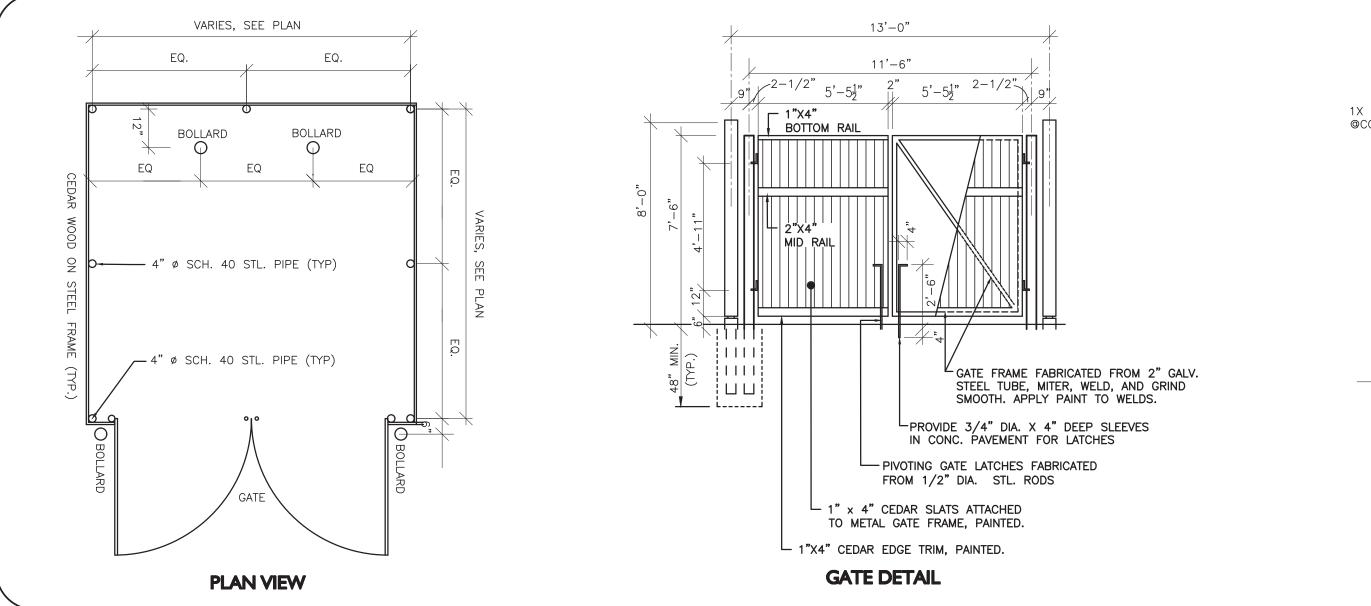


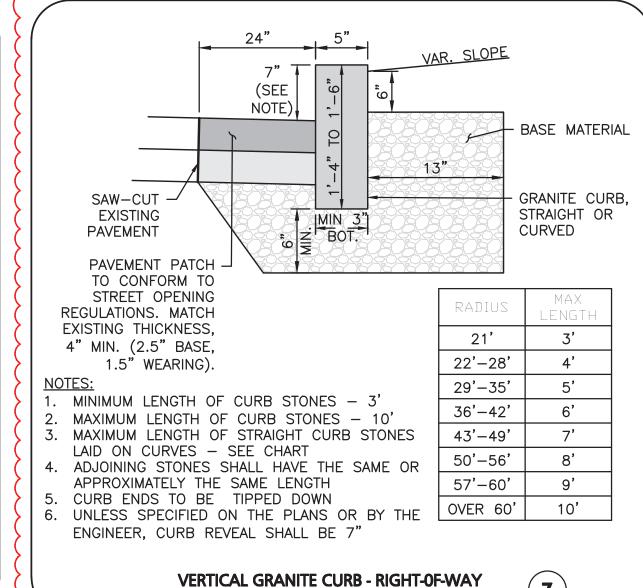
VENDOR INFORMATION: "ADATILE" WET SET ADA REPLACEABLE TACTILE (OR APPROVED EQUAL) AS MANUFACTURED BY ADATILE, PHONE: 1-800-372-0519, WWW.ADATILE.COM, EMAIL: INFO@ADATILE.COM

2. COLOR SHALL BE BLACK.

3. INSTALL PER MANUFACTURER'S INSTALLATION GUIDELINES.


WET SET ADA REPLACEABLE TACTILE PANEL




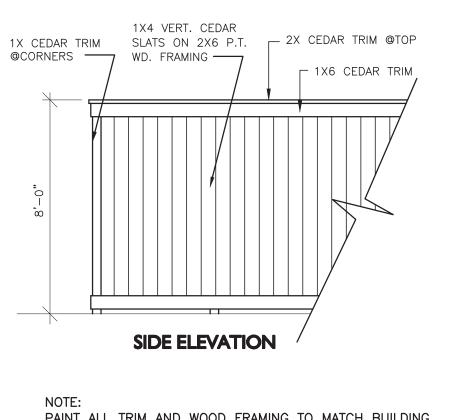


PAINT ALL TRIM AND WOOD FRAMING TO MATCH BUILDING

SCREENED DUMPSTER ENCLOSURE **(9**) NOT TO SCALE

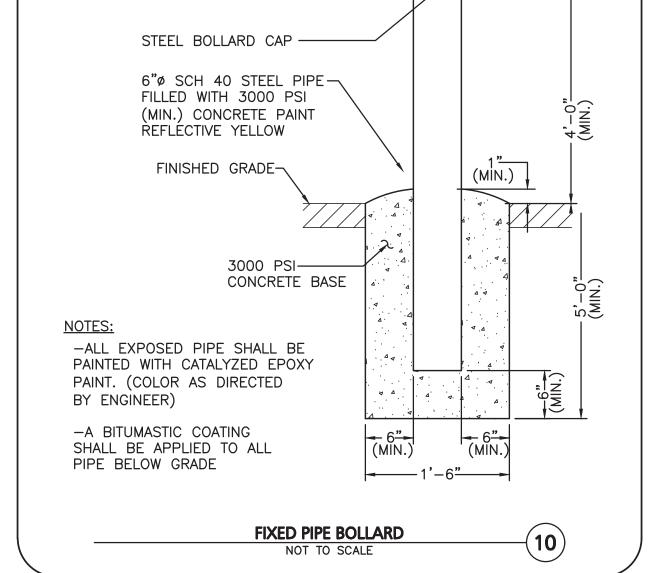

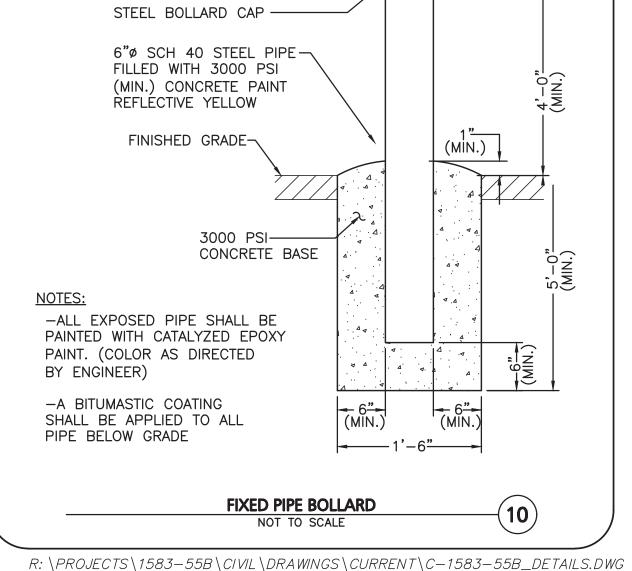

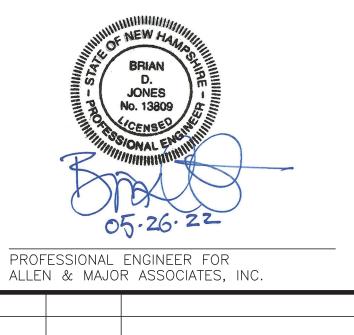

05-26-22 REVS PER CITY DEPT. COMMENTS DATE DESCRIPTION REV

APPLICANT\OWNER:

LINEAR RETAIL PROPERTIES, LLC 5 BURLINGTON WOODS DR. S. 107 **BURLINGTON, MA 01803**

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525 HOOKSETT ROAD AKA DANIEL WEBSTER HWY. MAP-LOT: 916-41A MANCHESTER, NH 03104

PROJECT NO. 1583-55B DATE: 03-15-2022 AS SHOWN DWG. NAME: C-1583-55E DRAFTED BY: BDJ CHECKED BY:



ALLEN & MAJOR ASSOCIATES, INC.

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FAX: (603) 627-5501 WOBURN, MA ♦ LAKEVILLE, MA ♦ MANCHESTER, NE


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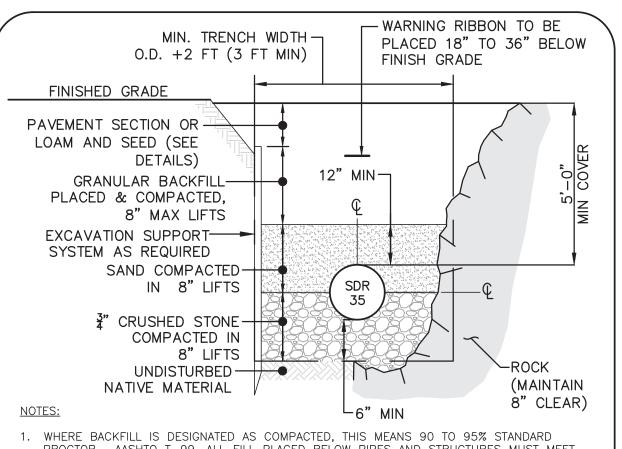
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DETAILS

C-502


SHEET No.




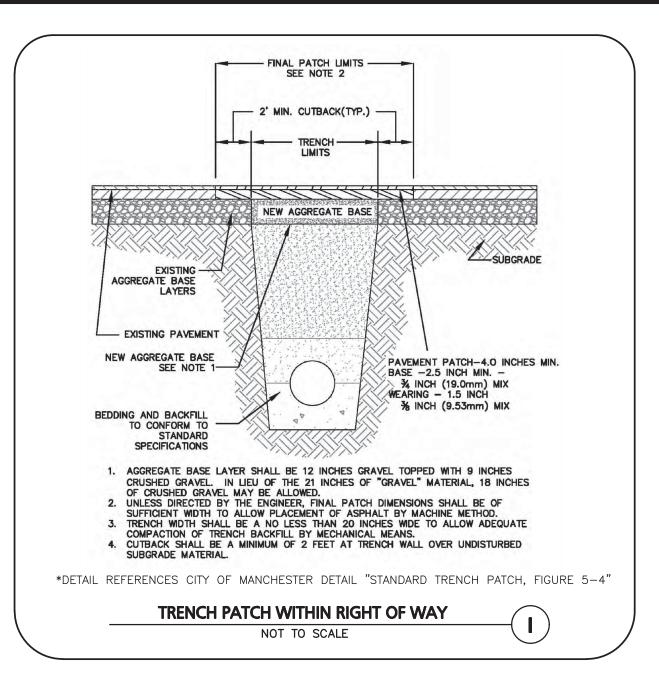

- PROCTOR. AASHTO T-99. ALL FILL PLACED BELOW PIPES AND STRUCTURES MUST MEET THIS REQUIREMENT.
- 2. FOR ALL TRENCHES WITH A GRADE GREATER THAN 4% AND/OR WHERE GROUNDWATER IS APPARENT, INSTALL CLAY DAMS AROUND THE PIPE AT 100' INTERVALS.
- 3. CRUSHED STONE SHALL BE CLEAN, HARD, FREE FROM COATINGS AND THOROUGHLY WASHED WITH A GRADATION BY WEIGHT OF 100% PASSING A 1" SQUARE OPENING, AND 0 TO 5% PASSING A 1 SQUARE OPENING.

SEWER TRENCH DETAIL NOT TO SCALE

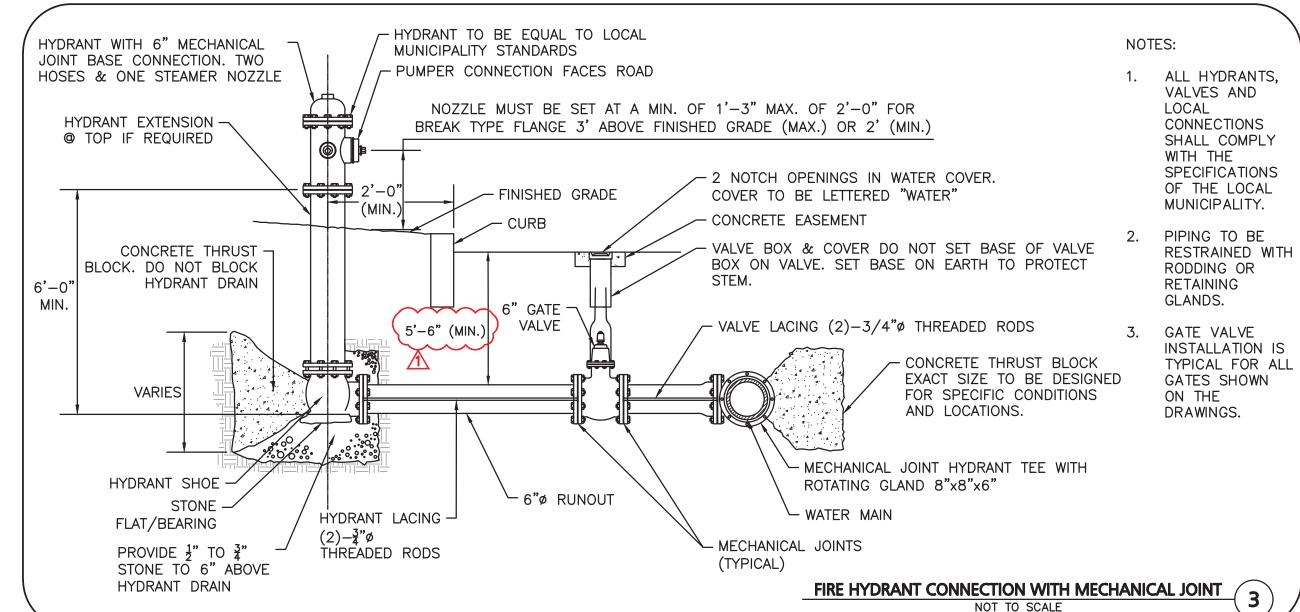


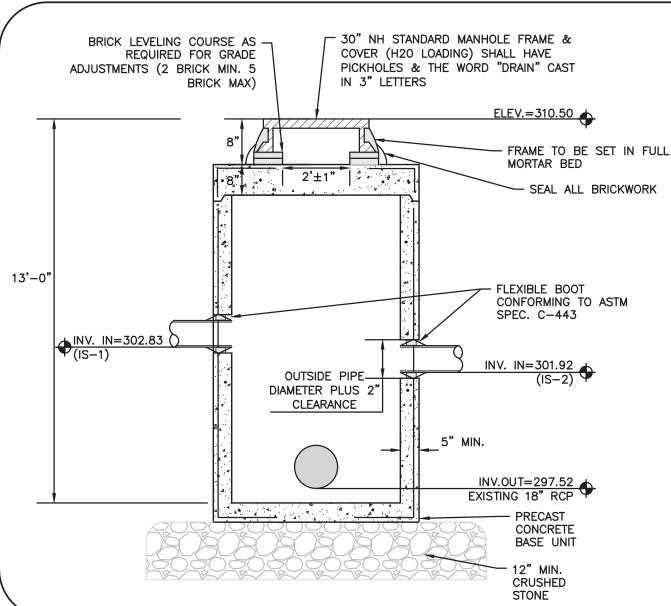



MANHOLE TO BE CAPABLE OF AASHTO H-20 LOADING WITHOUT FAILURE.

- STEEL REINFORCEMENT FOR BASE SECTION BOTTOM SHALL BE A MIN. 10 SQ. IN. STEEL PER VERTICAL FOOT, PLACED ACCORDING TO AASHTO DESIGNATION M-199
- BASE SECTION SHALL BE MONOLITHIC
- ANY ADJUSTMENTS DURING CONSTRUCTION WILL BE DONE BY SAW CUTTING AND/OR CORING, THE USE OF JACKHAMMERS, HAMMERS, AND CHISELS WILL NOT BE ALLOWED.

EXISTING CB CONVERTED TO DMH NOT TO SCALE

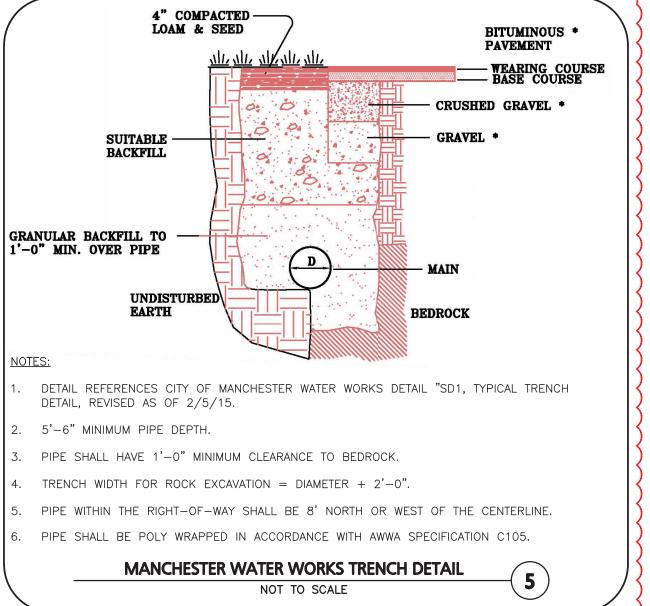

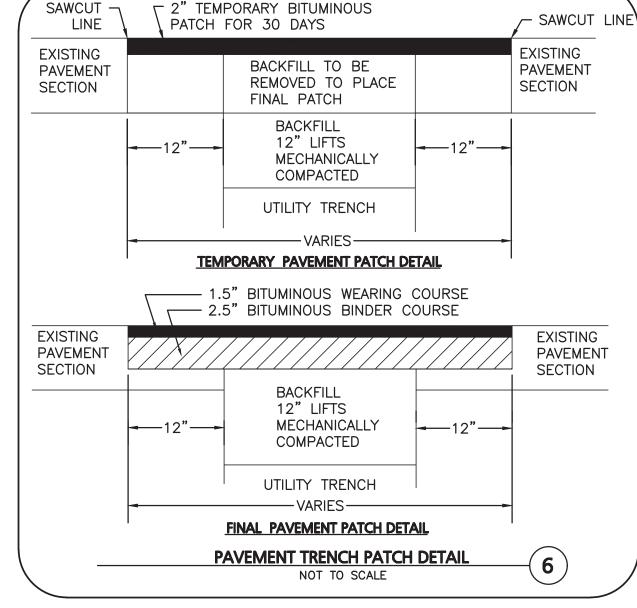

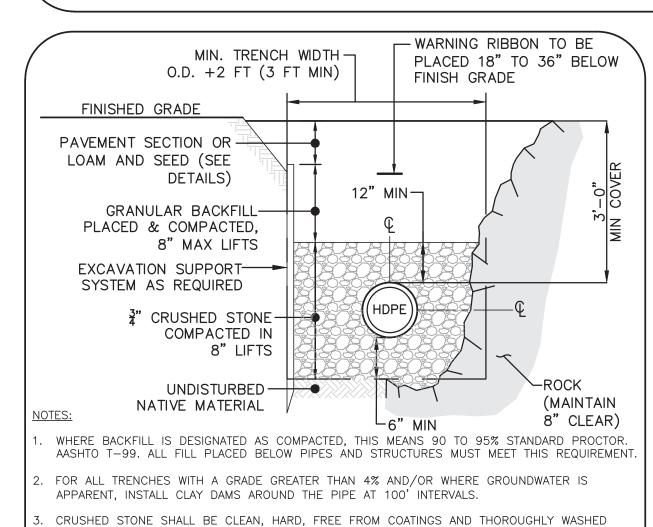

WITH A GRADATION BY WEIGHT OF 100% PASSING A 1" SQUARE OPENING, AND 0 TO 5%


ALL DRAIN PIPE SHALL BE DUAL WALLED HDPE PIPE WITH SMOOTH INTERIOR, SUCH AS ADS


N-12 OR APPROVED EQUAL, UNLESS OTHERWISE NOTED.


DRAIN TRENCH DETAIL


NOT TO SCALE

PASSING A 1" SQUARE OPENING

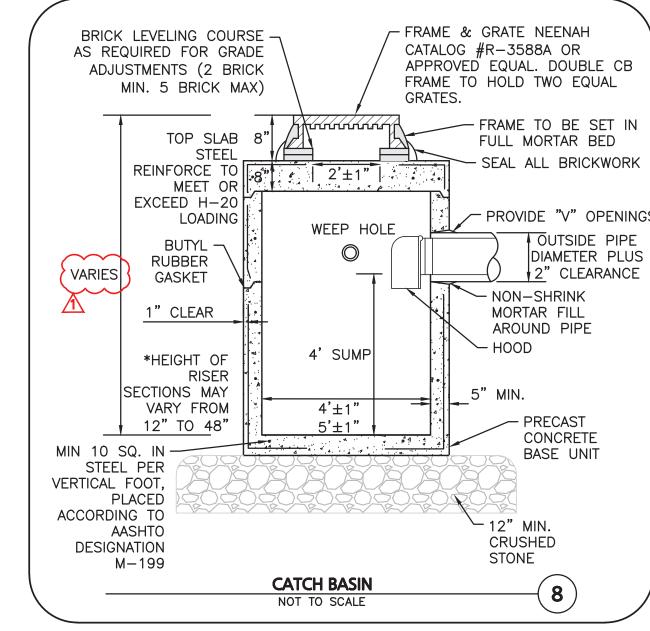

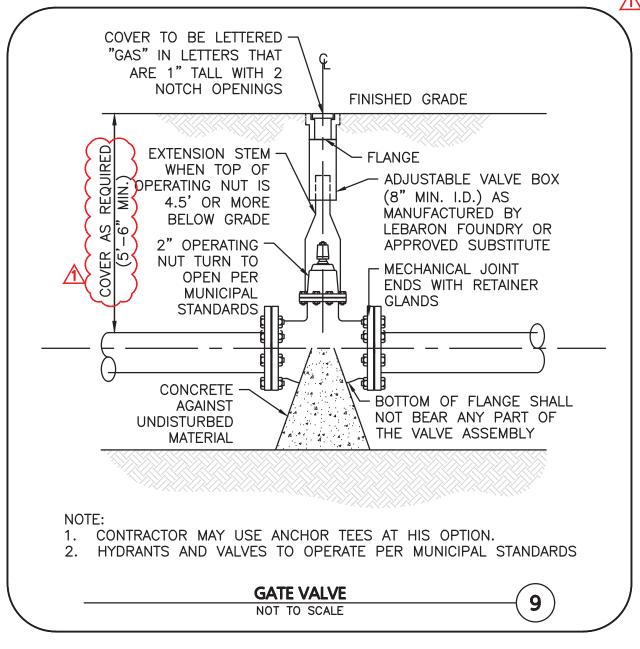

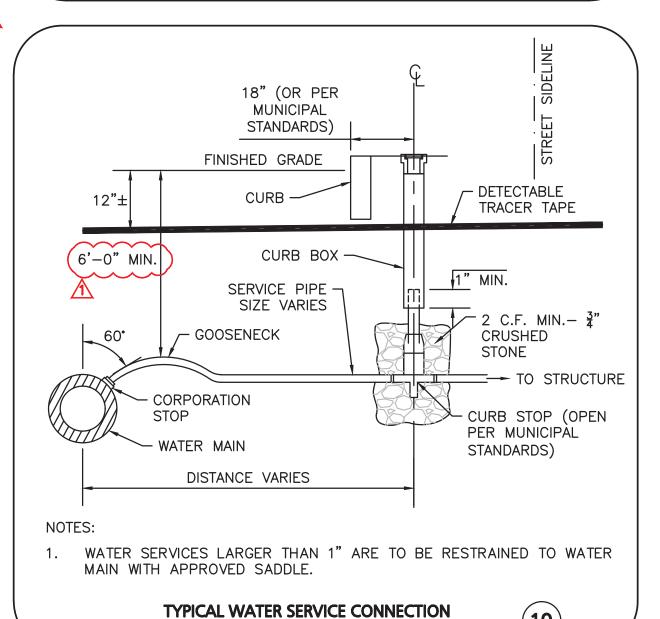

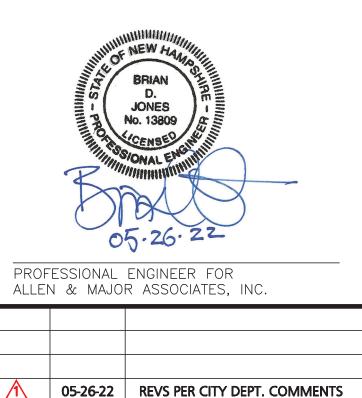

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5 BURLINGTON WOODS DR. S. 107 **BURLINGTON, MA 01803**

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nvironmental consulting • landscape architecture www.allenmajor.com 400 HARVEY ROAD MANCHESTER, NH 03101

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DRAWING TITLE:

DETAILS

C-503

SHEET No.

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(10) $R: \PROJECTS \setminus 1583 - 55B \setminus CIVIL \setminus DRAWINGS \setminus CURRENT \setminus C - 1583 - 55B _DETAILS.DWG$


ACCEPTABLE FILL MATERIALS: STORMTECH SC-310 CHAMBER SYSTEMS

	MATERIAL LOCATION	DESCRIPTION	AASHTO MATERIAL CLASSIFICATIONS	COMPACTION / DENSITY REQUIREMENT
D	FINAL FILL: FILL MATERIAL FOR LAYER 'D' STARTS FROM THE TOP OF THE 'C' LAYER TO THE BOTTOM OF FLEXIBLE PAVEMENT OR UNPAVED FINISHED GRADE ABOVE. NOTE THAT PAVEMENT SUBBASE MAY BE PART OF THE 'D' LAYER.	ANY SOIL/ROCK MATERIALS, NATIVE SOILS, OR PER ENGINEER'S PLANS. CHECK PLANS FOR PAVEMENT SUBGRADE REQUIREMENTS.	N/A	PREPARE PER SITE DESIGN ENGINEER'S PLANS. PAVED INSTALLATIONS MAY HAVE STRINGENT MATERIAL AND PREPARATION REQUIREMENTS.
С	INITIAL FILL: FILL MATERIAL FOR LAYER 'C' STARTS FROM THE TOP OF THE EMBEDMENT STONE ('B' LAYER) TO 18" (450 mm) ABOVE THE TOP OF THE CHAMBER. NOTE THAT PAVEMENT SUBBASE MAY BE A PART OF THE 'C' LAYER.	GRANULAR WELL-GRADED SOIL/AGGREGATE MIXTURES, <35% FINES OR PROCESSED AGGREGATE. MOST PAVEMENT SUBBASE MATERIALS CAN BE USED IN LIEU OF THIS LAYER.	AASHTO M145 ¹ A-1, A-2-4, A-3 OR AASHTO M43 ¹ 3, 357, 4, 467, 5, 56, 57, 6, 67, 68, 7, 78, 8, 89, 9, 10	BEGIN COMPACTIONS AFTER 12" (300 mm) OF MATERIAL OVER THE CHAMBERS IS REACHED. COMPACT ADDITIONAL LAYERS IN 6" (150 mm) MAX LIFTS TO A MIN. 95% PROCTOR DENSITY FOR WELL GRADED MATERIAL AND 95% RELATIVE DENSITY FOR PROCESSED AGGREGATE MATERIALS. ROLLER GROSS VEHICLE WEIGHT NOT TO EXCEED 12,000 lbs (53 kN). DYNAMIC FORCE NOT TO EXCEED 20,000 lbs (89 kN).
В	EMBEDMENT STONE: FILL SURROUNDING THE CHAMBERS FROM THE FOUNDATION STONE ('A' LAYER) TO THE 'C' LAYER ABOVE.	CLEAN, CRUSHED, ANGULAR STONE	AASHTO M43¹ 3, 357, 4, 467, 5, 56, 57	NO COMPACTION REQUIRED.
А	FOUNDATION STONE: FILL BELOW CHAMBERS FROM THE SUBGRADE UP TO THE FOOT (BOTTOM) OF THE CHAMBER.	CLEAN, CRUSHED, ANGULAR STONE	AASHTO M43¹ 3, 357, 4, 467, 5, 56, 57	PLATE COMPACT OR ROLL TO ACHIEVE A FLAT SURFACE. ^{2,3}

1. THE LISTED AASHTO DESIGNATIONS ARE FOR GRADATIONS ONLY. THE STONE MUST ALSO BE CLEAN, CRUSHED, ANGULAR. FOR EXAMPLE, A SPECIFICATION FOR #4 STONE WOULD STATE: "CLEAN, CRUSHED, ANGULAR NO. 4 (AASHTO

2. STORMTECH COMPACTION REQUIREMENTS ARE MET FOR 'A' LOCATION MATERIALS WHEN PLACED AND COMPACTED IN 6" (MAX) LIFTS USING TWO FULL COVERAGES WITH A VIBRATORY COMPACTOR.
3. WHERE INFILTRATION SURFACES MAY BE COMPROMISED BY COMPACTION, FOR STANDARD DESIGN LOAD CONDITIONS, A FLAT SURFACE MAY BE ACHIEVED BY RAKING OR DRAGGING WITHOUT COMPACTION EQUIPMENT. FOR SPECIAL LOAD DESIGNS, CONTACT STORMTECH FOR COMPACTION REQUIREMENTS.

4. ONCE LAYER 'C' IS PLACED, ANY SOIL/MATERIAL CAN BE PLACED IN LAYER 'D' UP TO THE FINISHED GRADE. MOST PAVEMENT SUBBASE SOILS CAN BE USED TO REPLACE THE MATERIAL REQUIREMENTS OF LAYER 'C' OR 'D' AT THE SITE DESIGN ENGINEER'S DISCRETION.

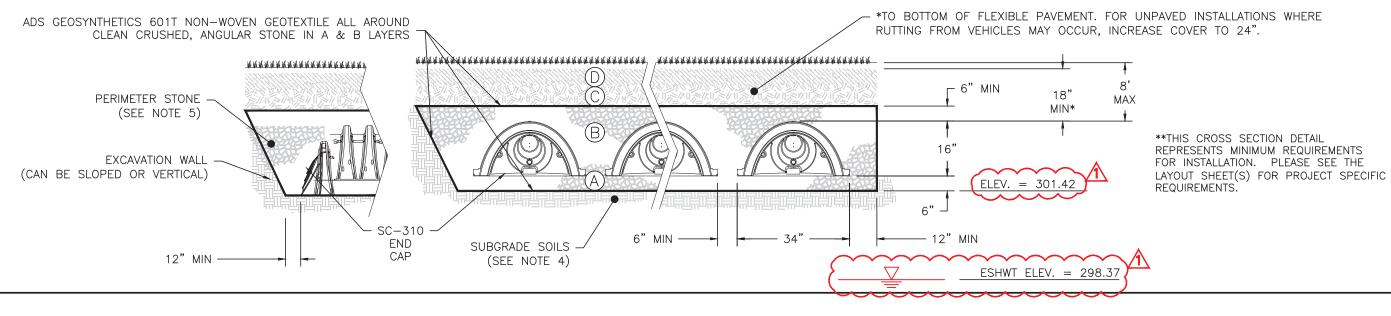



- 1. CHAMBERS SHALL MEET THE REQUIREMENTS OF ASTM F2922 (POLETHYLENE) OR ASTM F2418-16a (POLYPROPYLENE), "STANDARD SPECIFICATION FOR CORRUGATED WALL STORMWATER COLLECTION CHAMBERS".
- 2. SC-310 CHAMBERS SHALL BE DESIGNED IN ACCORDANCE WITH ASTM F2787 "STANDARD PRACTICE FOR STRUCTURAL DESIGN OF THERMOPLASTIC

CORRUGATED WALL STORMWATER COLLECTION CHAMBERS".

- 3. THE GEOTECHNICAL ENGINEER IS RESPONSIBLE FOR ASSESSING THE BEARING RESISTANCE (ALLOWABLE BEARING CAPACITY) OF THE SUBGRADE SOILS AND THE DEPTH OF FOUNDATION STONE WITH CONSIDERATION FOR THE RANGE OF EXPECTED SOIL MOISTURE CONDITIONS.
- 4. PERIMETER STONE MUST BE EXTENDED HORIZONTALLY TO THE EXCAVATION WALL FOR BOTH VERTICAL AND SLOPED EXCAVATION WALLS.
- 5. REQUIREMENTS FOR HANDLING AND INSTALLATION:
- TO MAINTAIN THE WIDTH OF CHAMBERS DURING SHIPPING AND HANDLING, CHAMBERS SHALL HAVE INTEGRAL, INTERLOCKING STACKING
- TO ENSURE A SECURE JOINT DURING INSTALLATION AND BACKFILL, THE HEIGHT OF THE CHAMBER JOINT SHALL NOT BE LESS THAN 2 .
- . TO ENSURE THE INTEGRITY OF THE ARCH SHAPE DURING INSTALLATION, a) THE ARCH STIFFNESS CONSTANT AS DEFINED IN SECTION 6.2.8 OF ASTM F2922 SHALL BE GREATER THAN OR EQUAL TO 400 LBS/IN/IN. AND b) TO RESIST CHAMBER DEFORMATION DURING INSTALLATION AT ELEVATED TEMPERATURES (ABOVE 73° F / 23° C), CHAMBERS SHALL BE PRODUCED FROM REFLECTIVE GOLD OR YELLOW COLORS.

<u> TYPICAL STORMTECH SC-310 DETAIL & NOTES</u>

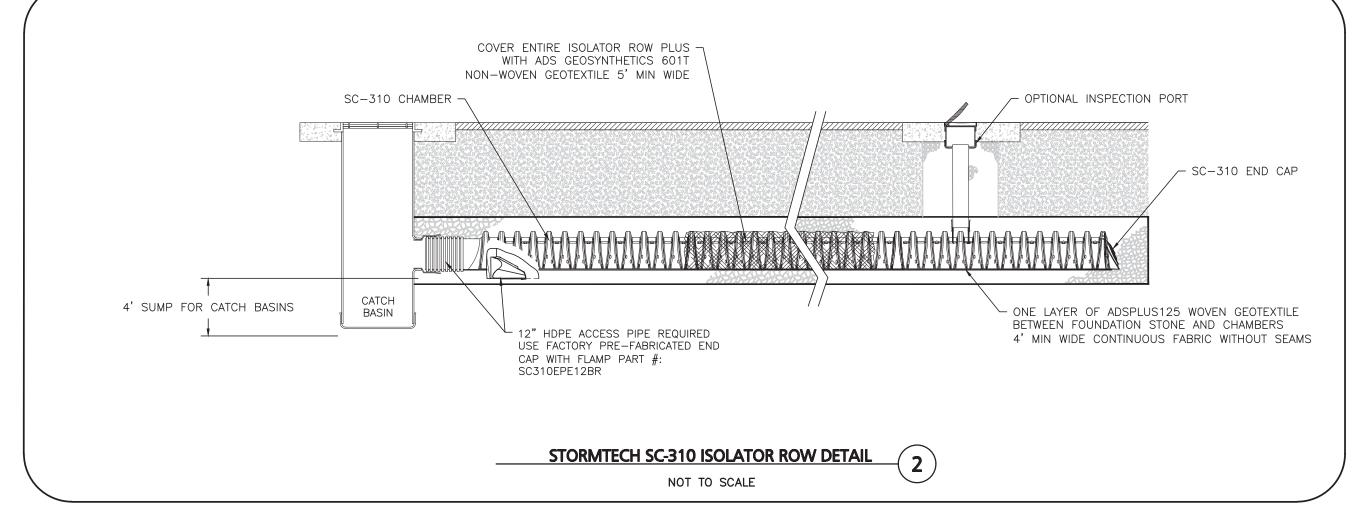

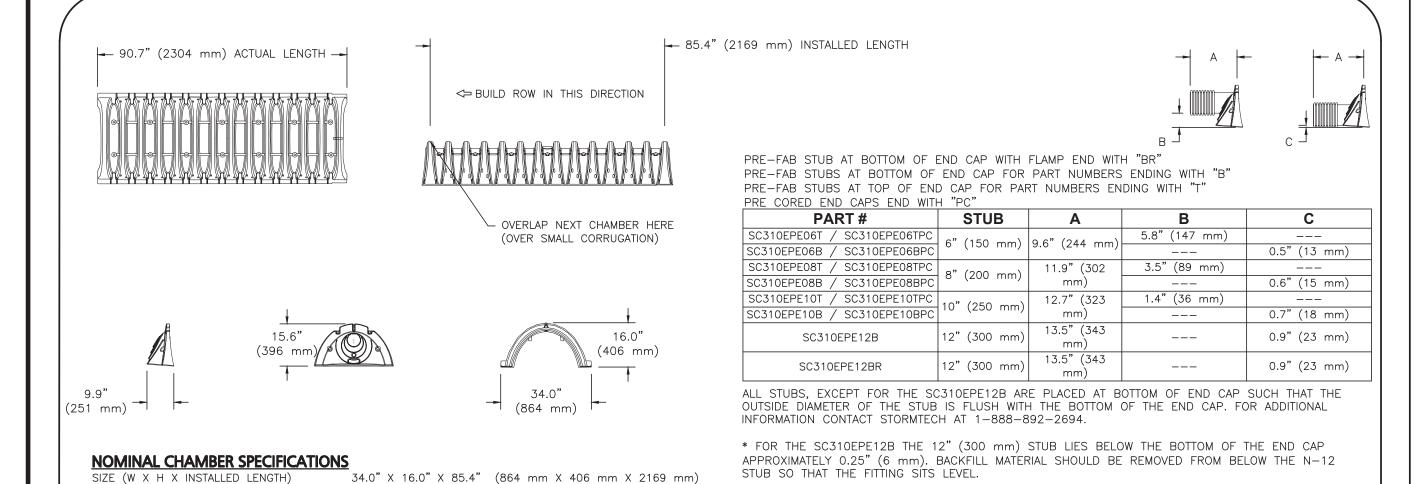

STORMTECH SC-310 TECHNICAL SPECIFICATIONS (3)

NOT TO SCALE

NOTE: ALL DIMENSIONS ARE NOMINAL

CHAMBER STORAGE

MINIMUM INSTALLED STORAGE*

14.7 CUBIC FEET

31.0 CUBIC FEET

35.0 lbs.

*ASSUMES 6" (152 mm) ABOVE, BELOW, AND BETWEEN CHAMBERS

 (0.42 m^3)

 (0.88 m^3)

(16.8 kg)

INSPECTION & MAINTENANCE


- STEP 1) INSPECT ISOLATOR ROW PLUS FOR SEDIMENT A. INSPECTION PORTS (IF PRESENT)
 - A.1. REMOVE/OPEN LID ON NYLOPLAST INLINE DRAIN A.2. REMOVE AND CLEAN FLEXSTORM FILTER IF INSTALLED
 - A.3. USING A FLASHLIGHT AND STADIA ROD, MEASURE DEPTH OF SEDIMENT AND RECORD ON MAINTENANCE LOG
 - A.4. LOWER A CAMERA INTO ISOLATOR ROW PLUS FOR VISUAL INSPECTION OF SEDIMENT LEVELS
 - A.5. IF SEDIMENT IS AT, OR ABOVE, 3" (80 mm) PROCEED TO STEP 2. IF NOT, PROCEED TO STEP
 - B. ALL ISOLATOR PLUS ROWS B.1. REMOVE COVER FROM STRUCTURE AT UPSTREAM FND OF ISOLATOR ROW PLUS
 - B.2. USING A FLASHLIGHT, INSPECT DOWN THE ISOLATOR ROW PLUS THROUGH OUTLET PIPE i) MIRRORS ON POLES OR CAMERAS MAY BE USED TO AVOID A CONFINED SPACE ENTRY ii)FOLLOW OSHA REGULATIONS FOR CONFINED SPACE ENTRY IF ENTERING MANHOLE
 - B.3. IF SEDIMENT IS AT, OR ABOVE, 3" (80 mm) PROCEED TO STEP 2. IF NOT, PROCEED TO STEP
- STEP 2) CLEAN OUT ISOLATOR ROW PLUS USING THE
- A. A FIXED CULVERT CLEANING NOZZLE WITH REAR FACING SPREAD OF 45" (1.1 m) OR MORE IS PREFERRED
- B. APPLY MULTIPLE PASSES OF JETVAC UNTIL BACKFLUSH WATER IS CLEAN C. VACUUM STRUCTURE SUMP AS REQUIRED
- STEP 3) REPLACE ALL COVERS, GRATES, FILTERS, AND LIDS; RECORD OBSERVATIONS AND ACTIONS.

STEP 4) INSPECT AND CLEAN BASINS AND MANHOLES UPSTREAM OF THE STORMTECH SYSTEM.

NOTES

- 1. INSPECT EVERY 6 MONTHS DURING THE FIRST YEAR OF OPERATION. ADJUST THE INSPECTION INTERVAL BASED ON PREVIOUS OBSERVATIONS OF SEDIMENT ACCUMULATION AND HIGH WATER ELEVATIONS.
- 2. CONDUCT JETTING AND VACTORING ANNUALLY OR WHEN INSPECTION SHOWS THAT MAINTENANCE IS NECESSARY.

STORMTECH CHAMBERS INSPECTION AND MAINTENANCE / NOT TO SCALE

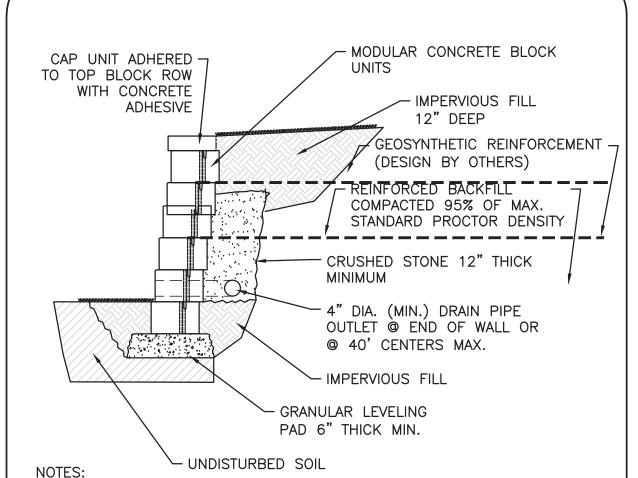

1. THE SITE CONTRACTOR SHALL BE RESPONSIBLE FOR PROVIDING THE STRUCTURAL DESIGN OF THE MODULAR BLOCK RETAINING

- 2. WALLS THREE FEET OR GREATER IN HEIGHT SHALL BE DESIGNED BY A NEW HAMPSHIRE REGISTERED PROFESSIONAL STRUCTURAL ENGINEER.
- 3. STAMPED WALLS DESIGNS SHALL BE PROVIDED FOR REVIEW AND APPROVAL BY THE CITY OF MANCHESTER BUILDING DEPARTMENT.
- 4. WALL DESIGNS AND CALCULATIONS SHALL BE PROVIDED TO THE PROJECT GEOTECHNICAL ENGINEER TO CONFIRM THAT GEOTECHNICAL RECOMENDATIONS HAVE BEEN PROPERLY INCLUDED.
- 5. WALL DESIGNS AND CALCULATIONS SHALL BE PROVIDED TO THE PROJECT CIVIL ENGINEER TO CONFIRM ELEVATIONS AND ALIGNMENT HAVE BEEN PROPERLY INCLUDED.
- 6. SMALL BLOCK UNITS SHALL BE THE SQUARE FOOT PRODUCT BY VERSA-LOK OR APPROVED EQUAL.
- 7. WALL HEIGHT WITHOUT REINFORCEMENT SHALL BE LIMITED TO 3' EXPOSED FACE.
- 8. INSTALLATION SHALL BE IN ACCORDANCE WITH MANUFACTURER'S RECOMMENDATIONS.

TYPICAL "SMALL BLOCK" RETAINING WALL

NOT TO SCALE

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PROFESSIONAL ENGINEER FOR ALLEN & MAJOR ASSOCIATES, INC.

05-26-22 | REVS PER CITY DEPT. COMMENTS REV DATE DESCRIPTION

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PROJECT NO. 1583-55B DATE: 03-15-2022 AS SHOWN DWG. NAME: C-1583-55E

DRAFTED BY: BDJ CHECKED BY:



ASSOCIATES, INC. civil engineering ♦ land surveying nvironmental consulting • landscape architecture

www.allenmajor.com 400 HARVEY ROAD MANCHESTER, NH 03101 TEL: (603) 627-5500

WOBURN. MA ♦ LAKEVILLE. MA ♦ MANCHESTER. NE

FAX: (603) 627-5501

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DRAWING TITLE:

SHEET No. C-504

DETAILS

CONTRACTOR TO SUBMIT SHOP DRAWINGS TO SITE ENGINEER FOR REVIEW AND APPROVAL STORMTECH MC-3500 CHAMBERS SHALL BE INSTALLED IN ACCORDANCE

STORMTECH RECOMMENDS 3 BACKFILL METHODS:

HOE OR EXCAVATOR.

INTO CHAMBER END CAPS.


- WITH THE "STORMTECH MC-3500/MC-4500 CONSTRUCTION GUIDE". CHAMBERS ARE NOT TO BE BACKFILLED WITH A DOZER OR AN EXCAVATOR SITUATED OVER THE CHAMBERS
 - STONESHOOTER LOCATED OFF THE CHAMBER BED. BACKFILL AS ROWS ARE BUILT USING AN EXCAVATOR ON THE FOUNDATION STONE OR SUBGRADE BACKFILL FROM OUTSIDE THE EXCAVATION USING A LONG BOOM
- 4. THE FOUNDATION STONE SHALL BE LEVELED AND COMPACTED PRIOR TO PLACING CHAMBERS.
- JOINTS BETWEEN CHAMBERS SHALL BE PROPERLY SEATED PRIOR TO PLACING STONE.
- INLET AND OUTLET MANIFOLDS MUST BE INSERTED A MINIMUM OF 12"
- EMBEDMENT STONE SURROUNDING CHAMBERS MUST BE A CLEAN, CRUSHED, ANGULAR STONE MEETING THE AASHTO M43 DESIGNATION OF
- STONE MUST BE PLACED ON THE TOP CENTER OF THE CHAMBER TO ANCHOR THE CHAMBERS IN PLACE AND PRESERVE ROW SPACING.
- THE CONTRACTOR MUST REPORT ANY DISCREPANCIES WITH CHAMBER FOUNDATION MATERIALS BEARING CAPACITIES TO THE SITE DESIGN

NOTES FOR CONSTRUCTION EQUIPMENT

- STORMTECH MC-3500 CHAMBERS SHALL BE INSTALLED IN ACCORDANCE WITH THE "STORMTECH MC-3500/MC-4500 CONSTRUCTION GUIDE".
- THE USE OF EQUIPMENT OVER MC-3500 CHAMBERS IS LIMITED: NO EQUIPMENT IS ALLOWED ON BARE CHAMBERS. NO RUBBER TIRED LOADER, DUMP TRUCK, OR EXCAVATORS ARE ALLOWED UNTIL PROPER FILL DEPTHS ARE REACHED IN ACCORDANCE WITH THE "STORMTECH MC-3500/MC-4500
- CONSTRUCTION GUIDE" WEIGHT LIMITS FOR CONSTRUCTION EQUIPMENT CAN BE FOUND IN THE "STORMTECH MC-3500/MC-4500 CONSTRUCTION GUIDE".
- 3. FULL 36" OF STABILIZED COVER MATERIALS OVER THE CHAMBERS IS REQUIRED FOR DUMP TRUCK TRAVEL OR DUMPING.

USE OF A DOZER TO PUSH EMBEDMENT STONE BETWEEN THE ROWS OF CHAMBERS MAY CAUSE DAMAGE TO CHAMBERS AND IS NOT AN ACCEPTABLE BACKFILL METHOD. ANY CHAMBERS DAMAGED BY USING THE "DUMP AND PUSH" METHOD ARE NOT COVERED UNDER THE STORMTECH STANDARD WARRANTY.

CONTACT STORMTECH AT 1-888-892-2694 WITH ANY QUESTIONS ON INSTALLATION REQUIREMENTS OR WEIGHT LIMITS FOR CONSTRUCTION EQUIPMENT.

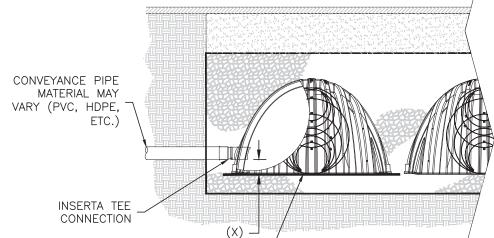

PART NUMBERS WILL VARY BASED ON INLET PIPE MATERIALS.

ANY PIPE, CONDUIT AND GROUND WIRE LOCATIONS

TYPICAL UTILITY PAD

NOT TO SCALE

CONTACT STORMTECH FOR MORE INFORMATION.

PLACE ADSPLUS WOVEN GEOTEXTILE (CENTERED ON INSERTA-TEE INLET) OVER BEDDING STONE FOR SCOL PROTECTION AT SIDE INLET

CONNECTIONS. GEOTEXTILE MUST MAX DIAMETER OF EXTEND 6" PAST CHAMBER FOOT CHAMBER **INSERTA TEE** SC-310 MC - 3500

INSERTA-TEE SIDE INLET DETAIL

HEIGHT FROM BASE OF CHAMBER (X)

INSERTA TEE TO BE INSTALLED, CENTERED OVER CORRUGATION SIDE VIEW

ACCEPTABLE FILL MATERIALS: STORMTECH MC-3500 CHAMBER SYSTEMS


	MATERIAL LOCATION	DESCRIPTION	AASHTO MATERIAL CLASSIFICATIONS	COMPACTION / DENSITY REQUIREMENT
1	FINAL FILL: FILL MATERIAL FOR LAYER 'D' STARTS FROM THE TOP OF THE 'C' LAYER TO THE BOTTOM OF FLEXIBLE PAVEMENT OR UNPAVED FINISHED GRADE ABOVE. NOTE THAT PAVEMENT SUBBASE MAY BE PART OF THE 'D' LAYER	ANY SOIL/ROCK MATERIALS, NATIVE SOILS, OR PER ENGINEER'S PLANS. CHECK PLANS FOR PAVEMENT SUBGRADE REQUIREMENTS.	N/A	PREPARE PER SITE DESIGN ENGINEER'S PLANS. PAVED INSTALLATIONS MAY HAVE STRINGENT MATERIAL AND PREPARATION REQUIREMENTS.
	INITIAL FILL: FILL MATERIAL FOR LAYER 'C' STARTS FROM THE TOP OF THE EMBEDMENT STONE ('B' LAYER) TO 24" ABOVE THE TOP OF THE CHAMBER. NOTE THAT PAVEMENT SUBBASE MAY BE A PART OF THE 'C' LAYER.	GRANULAR WELL-GRADED SOIL/AGGREGATE MIXTURES, <35% FINES OR PROCESSED AGGREGATE. MOST PAVEMENT SUBBASE MATERIALS CAN BE USED IN LIEU OF THIS LAYER.	A-1, A-2-4, A-3 OR AASHTO M431	BEGIN COMPACTIONS AFTER 24" OF MATERIAL OVER THE CHAMBERS IS REACHED. COMPACT ADDITIONAL LAYERS IN 12" MAX LIFTS TO A MIN. 95% PROCTOR DENSITY FOR WELL GRADED MATERIAL AND 95% RELATIVE DENSITY FOR PROCESSED AGGREGATE MATERIALS.
	EMBEDMENT STONE: FILL SURROUNDING THE CHAMBERS FROM THE FOUNDATION STONE ('A' LAYER) TO THE 'C' LAYER ABOVE.	CLEAN, CRUSHED, ANGULAR STONE	AASHTO M43¹ 3, 4	NO COMPACTION REQUIRED
	FOUNDATION STONE: FILL BELOW CHAMBERS FROM THE SUBGRADE UP TO THE FOOT (BOTTOM) OF THE CHAMBER.	CLEAN, CRUSHED, ANGULAR STONE	AASHTO M43¹ 3, 4	PLATE COMPACT OR ROLL TO ACHIEVE A FLAT SURFACE. ^{2,3}

PLEASE NOTE: 1. THE LISTED AASHTO DESIGNATIONS ARE FOR GRADATIONS ONLY. THE STONE MUST ALSO BE CLEAN, CRUSHED, ANGULAR. FOR EXAMPLE, A SPECIFICATION FOR #4 STONE WOULD STATE: "CLEAN, CRUSHED, ANGULAR NO. 4 (AASHTO M43) STONE".

. STORMTECH COMPACTION REQUIREMENTS ARE MET FOR 'A' LOCATION MATERIALS WHEN PLACED AND COMPACTED IN 9" (MAX) LIFTS USING TWO FULL COVERAGES WITH A VIBRATORY COMPACTOR. WHERE INFILTRATION SURFACES MAY BE COMPROMISED BY COMPACTION, FOR STANDARD DESIGN LOAD CONDITIONS, A FLAT SURFACE MAY BE ACHIEVED BY RAKING OR DRAGGING WITHOUT COMPACTION EQUIPMENT. FOR SPECIAL LOAD DESIGNS, CONTACT STORMTECH FOR COMPACTION REQUIREMENTS.

4. ONCE LAYER 'C' IS PLACED, ANY SOIL/MATERIAL CAN BE PLACED IN LAYER 'D' UP TO THE FINISHED GRADE. MOST PAVEMENT SUBBASE SOILS CAN BE USED TO REPLACE THE MATERIAL REQUIREMENTS OF LAYER 'C' OR 'D' AT THE SITE DESIGN ENGINEER'S DISCRETION.

ADS GEOSYNTHETICS 601T NON-WOVEN GEOTEXTILE ALL - SEE PAVEMENT SECTION DETAIL AROUND CLEAN, CRUSHED, ANGULAR STONE IN A & B LAYERS -*TO BOTTOM OF FLEXIBLE PAVEMENT. FOR UNPAVED INSTALLATIONS WHERE PERIMETER STONE RUTTING FROM VEHICLES MAY OCCUR, MIN* INCREASE COVER TO 30". **THIS CROSS SECTION DETAIL EXCAVATION WALL REPRESENTS MINIMUM REQUIREMENTS (CAN BE SLOPED OR VERTICAL) FOR INSTALLATION. PLEASE SEE THE LAYOUT SHEET(S) FOR PROJECT SPECIFIC REQUIREMENTS.

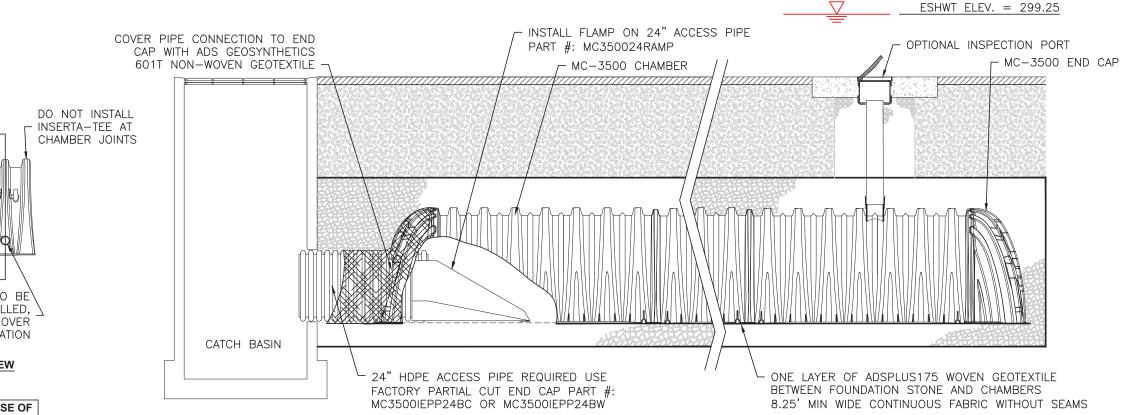

SUBGRADE SOILS


MC-3500 ISOLATOR ROW PLUS DETAIL

STORMTECH MC-3500 CHAMBER DETAIL & NOTES

NOT TO SCALE

- 1. CHAMBERS SHALL MEET THE REQUIREMENTS OF ASTM F2418-16a, "STANDARD SPECIFICATION FOR POLYPROPYLENE (PP) CORRUGATED WALL STORMWATER COLLECTION CHAMBERS" CHAMBER CLASSIFICATION 45x76 DESIGNATION SS.
- 2. MC-3500 CHAMBERS SHALL BE DESIGNED IN ACCORDANCE WITH ASTM F2787 "STANDARD PRACTICE FOR STRUCTURAL DESIGN OF THERMOPLASTIC CORRUGATED WALL STORMWATER COLLECTION CHAMBERS".
- 3. PERIMETER STONE MUST BE EXTENDED HORIZONTALLY TO THE EXCAVATION WALL FOR BOTH VERTICAL AND SLOPED EXCAVATION WALLS.
- 4. REQUIREMENTS FOR HANDLING AND INSTALLATION:
- TO MAINTAIN THE WIDTH OF CHAMBERS DURING SHIPPING AND HANDLING, CHAMBERS SHALL HAVE INTEGRAL, INTERLOCKING STACKING LUGS.
- TO ENSURE A SECURE JOINT DURING INSTALLATION AND BACKFILL, THE HEIGHT OF THE CHAMBER JOINT SHALL NOT BE LESS THAN 3".
- TO ENSURE THE INTEGRITY OF THE ARCH SHAPE DURING INSTALLATION, a) THE ARCH STIFFNESS CONSTANT AS DEFINED IN SECTION 6.2.8 OF ASTM F2418 SHALL BE GREATER THAN OR EQUAL TO 500 LBS/IN/IN. AND b) TO RESIST CHAMBER


DEFORMATION DURING INSTALLATION AT ELEVATED TEMPERATURES (ABOVE 73° F / 23° C), CHAMBERS SHALL BE PRODUCED FROM REFLECTIVE GOLD OR YELLOW COLORS.

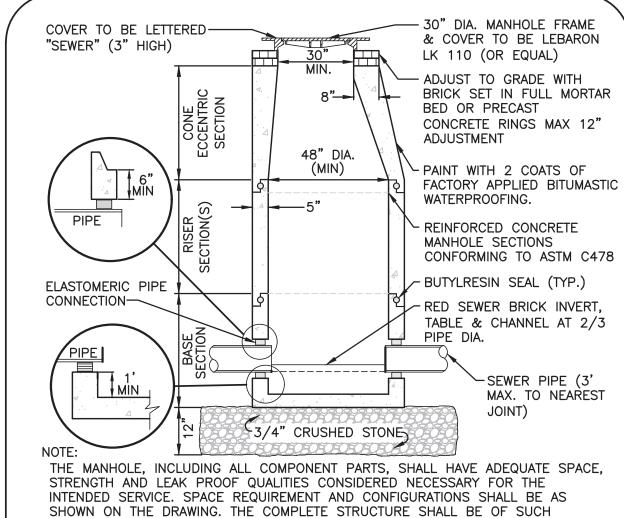

MATERIAL AND QUALITY AS TO WITHSTAND (H-20 LOADING) OR WITHOUT FAILURE AND PREVENT LEAKAGE IN EXCESS OF ONE GALLON PER DAY PER VERTICAL FOOT

SEWER MANHOLE NOT TO SCALE



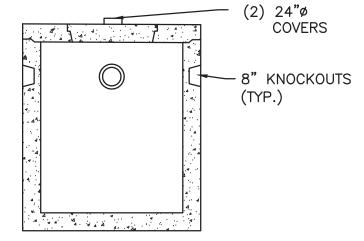

SECTION B-B

MANUFACTURER'S NOTES:
1. CONCRETE: 5,000 PSI MINIMUM STRENGTH @ 28 DAYS.

- 2. STEEL REINFORCING-ASTM A-615, GRADE 60.
- 3. COVER TO STEEL-1" MINIMUM. 4. TANKS ARE DESIGNED TO MEET ASTM C858 AND ACI 318 WITH ASHHTO HS-20 LOADING. 5. EARTH COVER: 1 TO 5 FEET MAX.
- 6. CONSTRUCTION JOINT SEALED WITH 1" DIA. BUTYL RUBBER OR EQUIVILENT. 7. APPROX. WEIGHTS: TOP SLAB = 2.3 TONS; BOTTOM SECTION = 8.5 TONS.
- 1. ALL PIPE GOING TO, WITHIN, AND TO 10 FEET BEYOND THE CONCRETE STRUCTURE, INCLUDING THE 4" VENT PIPE, SHALL BE THE RESPONSIBILITY OF THE PLUMBING
- PROFESSIONAL 2. ALL PIPE, INCLUDING THE 4" VENT PIPE TO THE ROOF, SHALL BE CAST IRON. 3. THE PLUMBING PROFESSIONAL SHOULD COORDINATE INSTALLATION OF THE TANK, ACCESS MANHOLES, AND DETAILS OF EXCAVATION, BACKFILLING, AND WATERPROOFING WITH THE CIVIL ENGINEER
- 4. ADJUST TO GRADE WITH MINIMUM 12" OF CONCRETE BRICK AND MORTAR (RED BRICK SHALL NOT BE USED).
- 5. BUTYL RUBBER JOINT SEALANT SHALL BE USED AT ALL JOINTS.

GREASE TRAP (1,000 GALLON) NOT TO SCALE



ALLEN & MAJOR ASSOCIATES, INC.

Â	05-26-22	REVS PER CITY DEPT. COMMEN
REV	DATE	DESCRIPTION

APPLICANT\OWNER:

LINEAR RETAIL PROPERTIES, LLC 5 BURLINGTON WOODS DR. S. 107 **BURLINGTON, MA 01803**

PROJECT:

525 HOOKSETT ROAD AKA DANIEL WEBSTER HWY. MAP-LOT: 916-41A MANCHESTER, NH 03104

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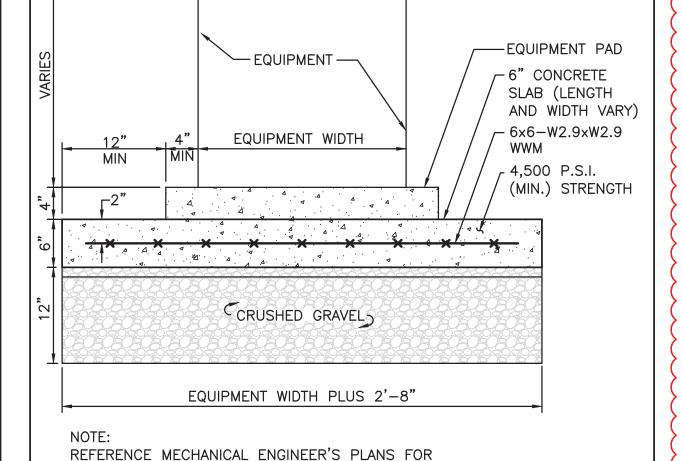
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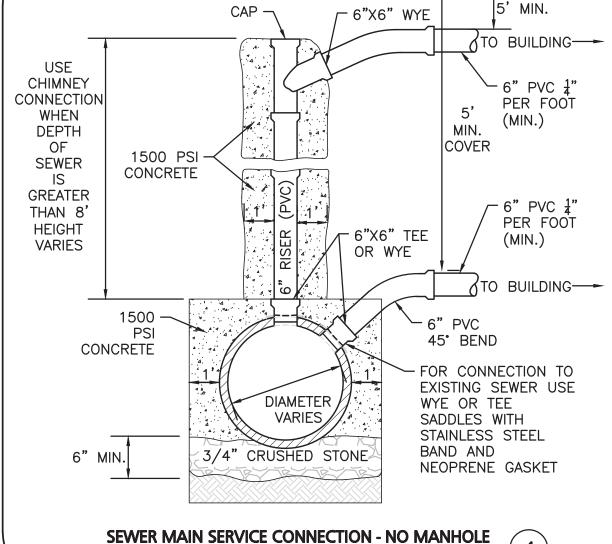
DETAILS

C-505

SHEET No.

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NOT TO SCALE

FINISHED GRADE

(2) 24"ø COVERS — 8" KNOCKOUTS -**PLAN VIEW** The state of the s 4'-0" INLET LIQUID LEVEL INVER1 12" MAX **SECTION A-A**

6" WALLS

OF MANHOLE.

R: \PROJECTS\1583-55B\CIVIL\DRAWINGS\CURRENT\C-1583-55B_DETAILS.DWG

TOWN OF MANCHESTER, NH SITE PLAN REGULATIONS SUMMARY:

LOAM &

LOAM &

27-PD -

2-AR

LOAM &

LOAM &

1-AF

SEED EROSION

SEED ALL DIST.

B-2 ZONING DISTRICT

R-1BZONING DISTRICT

AREAS TYP.

CONTROL MIX -

AREAS TYP.

SEED ALL DIST.

AREAS TYP.

SEED ALL DIST.

VIII. DESIGN CRITERIA FOR SITE PLANS AND PLANNED DEVELOPMENTS 8.3 LANDSCAPING, SCREENING AND BUFFER AREA REQUIREMENTS.

REQUIRED: (E) MINIMUM SIZES FOR PLANT MATERIAL, UNLESS INDICATED

ELSEWHERE IN THESE REGULATIONS: (I) DECIDUOUS SHADE TREES 3-INCH CALIPER

(II) DECIDUOUS ORNAMENTAL 2-INCH CALIPER

(III) EVERGREEN TREES 6 FEET IN HEIGHT (IV) STREET TREES, 3-3½-INCH CALIPER

PROPOSED: TREES PROPOSED ARE AT A MINIMUM SIZE OF: (I) DECIDUOUS SHADE TREES 3-INCH CALIPER

(II) DECIDUOUS ORNAMENTAL 2-INCH CALIPER (III) EVERGREEN TREES 6 FEET IN HEIGHT

(IV) STREET TREES, 3-3½-INCH CALIPER

SEED MIX:

NEW ENGLAND WETLAND PLANTS 820 WEST STREET, AMHERST, MA 01002 PHONE: 413-548-8000 FAX 413-549-4000 EMAIL: INFO@NEWP.COM WEB ADDRESS: WWW.NEWP.COM

NEW ENGLAND EROSION CONTROL/RESTORATION MIX FOR DRY SITES

BOTANICAL NAME COMMON NAME WETLAND INDICATOR **ELYMUS CANADENSIS** CANADA WILD RYE FACU+ FESTUCA RUBRA RED FESCUE FACU

LOLIUM MULTIFLORUM ANNUAL RYEGRASS LOLIUM PERENNE PERRENIAL RYEGRASS PANICUM VIRGATUM SWITCH GRASS SORGHASTRUM NUTANS INDIAN GRASS UPL LITTLE BLUESTEM SCHIZACHYRIUM SCOPARIUM FACU AGROSTIS PERENNANS UPLAND BENTGRASS FACU

THE NEW ENGLAND EROSION CONTROL/RESTORATION MIX FOR DRY SITES PROVIDES AN APPROPRIATE SELECTION OF NATIVE AND NATURALIZED GRASSES TO ENSURE THAT DRY AND RECENTLY DISTURBED SITES WILL BE QUICKLY REVEGETATED AND THE SOIL SURFACE STABILIZED. IT IS AN APPROPRIATE SEED MIX FOR ROAD CUTS, PIPELINES, STEEPER SLOPES, AND AREAS REQUIRING QUICK COVER DURING THE ECOLOGICAL RESTORATION PROCESS. THE MIX MAY BE APPLIED BY HYDRO-SEEDING, BY MECHANICAL SPREADER, OR ON SMALL SITES IT CAN BE SPREAD BY HAND. LIGHTLY RAKE, OR ROLL TO ENSURE PROPER SOIL-SEED CONTACT. BEST RESULTS ARE OBTAINED WITH A SPRING OR LATE SUMMER SEEDING. LATE SPRING THROUGH MID-SUMMER SEEDING WILL BENEFIT FROM A LIGHT MULCHING OF WEED-FREE STRAW TO CONSERVE MOISTURE. IF CONDITIONS ARE DRIER THAN USUAL, WATERING WILL BE REQUIRED. FERTILIZATION IS

REQUIRED UNLESS THE SOILS ARE PARTICULARLY INFERTILE. PREPARATION OF A CLEAN WEED FREE SEED BED IS NECESSARY FOR OPTIMAL RESULTS.

APPLY: 35 LBS/ACRE :1250 SQ FT/LB

EROSION CONTROL BLANKET FOR SLOPES SEE LANDSCAPE NOTES


GENERAL NOTES:

- THE LOCATIONS OF EXISTING UNDERGROUND UTILITIES ARE SHOWN IN AN APPROXIMATE WAY ONLY AND HAVE NOT BEEN INDEPENDENTLY VERIFIED BY THE OWNER OR IT'S REPRESENTATIVE. THE CONTRACTOR SHALL DETERMINE THE EXACT LOCATION OF ALL EXISTING UTILITIES BEFORE COMMENCING WORK, AND AGREES TO BE FULLY RESPONSIBLE FOR ANY AND ALL DAMAGES WHICH MIGHT BE OCCASIONED BY THE CONTRACTOR'S FAILURE TO EXACTLY LOCATE AND PRESERVE ANY AND ALL UNDERGROUND UTILITIES.
- 2. ALL LANDSCAPED AREAS WITH SHRUBS, TREES, AND PERENNIALS TO HAVE 12" MINIMUM DEPTH OF TOPSOIL. THE 12" OF TOPSOIL AROUND TREES AND SHRUBS DOES NOT INCLUDE AMENDED PLANTING SOIL WITHIN TREE / SHRUB PIT FOR FULL DEPTH OF ROOTBALLS. SEE PLANTING DETAILS FOR PLANTING DEPTH AT SHRUBS AND TREES. ALL AREAS OF LOAM AND SEED TO HAVE 6" MINIMUM DEPTH OF TOPSOIL. TOPSOIL TO BE TESTED BY CONTRACTOR, AND APPROVED BY A&M PRIOR TO PURCHASE AND OR PLACEMENT. GENERAL CONTRACTOR. DEMOLITION CONTRACTOR, AND LANDSCAPE CONTRACTOR TO COORDINATE PROPER DEPTH OF EXISTING MATERIAL REMOVAL ACROSS SITE SO THAT 12 INIMUM AND 6" MINIMUM DEPTHS OF PROPOSED TOPSOIL NOTED ABOVE ARE MET AT NO ADDITIONAL COST TO OWNER. SEE TOPSOIL DETAIL.
- 3. THE INFORMATION SHOWN ON THIS PLAN IS THE SOLE PROPERTY OF ALLEN & MAJOR ASSOCIATES, INC. IT'S INTENDED USE IS TO PROVIDE INFORMATION. ANY ALTERATION, MISUSE, OR RECALCULATION OF INFORMATION OR DATA WITHOUT THE EXPRESSED, WRITTEN CONSENT OF ALLEN & MAJOR ASSOCIATES, INC. IS STRICTLY PROHIBITED.



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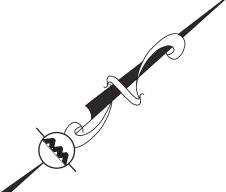
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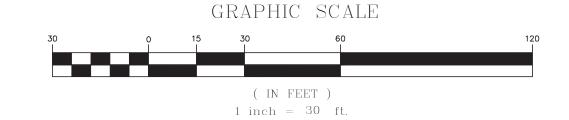
DECIDUOUS TREE EVERGREEN TREE FLOWERING TREE SHRUBS MULCH BED PERENNIALS/GROUNDCOVER WILDFLOWER SEED MIX

EROSION CONTROL SEED MIX

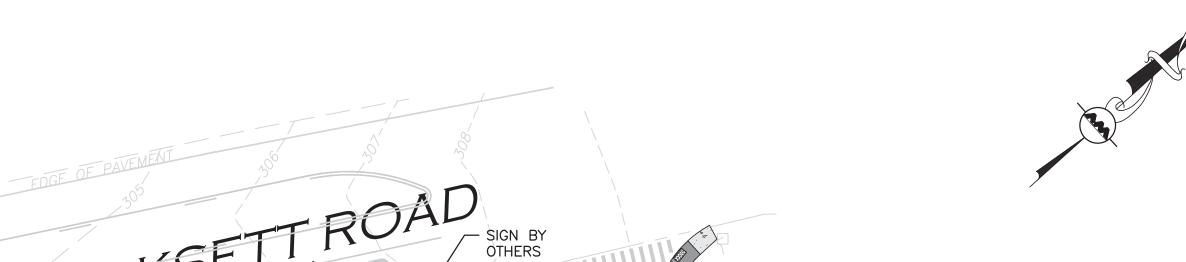LEGEND


PLANTING SCHEDULE - TREES, SHRUBS, GROUNDCOVERS & PERENNIALS

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KEY	QUANTITY	BOTANICAL NAME	COMMON NAME	MIN. SIZE	SPACING	COMMEN
AR	6	ACER RUBRUM 'RED SUNSET'	RED SUNSET RED MAPLE	3-3.5" CAL.	AS SHOWN	B&B
BP	8	BETULA NIGRA 'DURAHEAT'	DURAHEAT RIVER BIRCH	12-14' HT.	AS SHOWN	B&B — MULTISTE
MR	2	MALUS TRANSITORIA 'ROYAL RAINDROPS'	ROYAL RAINDROPS CRABAPPLE	2.5-3" CAL.	AS SHOWN	В&В
PK	2	PRUNUS SERRULATA 'KWANZAN	'KWANZAN CHERRY	3-3.5" CAL.	AS SHOWN	В&В
AF	4	ABIES FRASERI	FRASER FIR	7-8' HT.	AS SHOWN	B&B
SHRU	JBS / GRA	ASSES				
AD	25	AZALEA 'DELAWARE WHITE'	DELAWARE WHITE AZALEA	#5	AS SHOWN	POT
CA	15	CORNUS SERICEA 'KELSEYI'	KELSEYI DWARF RED TWIGGED DOGWOOD	#6	AS SHOWN	POT
CR	9	CORNUS ALBA 'IVORY HALO'	IVORY HALO DOGWOOD	#5	AS SHOWN	POT
FG	6	FOTHERGILLA GARDENII 'BLUE SHADOW'	DWARF BLUE SHADOW FOTHEREGILLA	#5	AS SHOWN	POT
IG	24	ILEX GLABRA 'SHAMROCK'	SHAMROCK INKBERRY	#5	AS SHOWN	POT
РЈМ	32	RHODODENDRON 'PJM'	PJM RHODODENDRON	#5	AS SHOWN	POT
RA	20	RHUS AROMATICA 'GROW LOW'	GROW LOW SUMAC	#3	AS SHOWN	POT
RK	6	ROSA KNOCKOUT YELLOW	KNOCKOUT YELLOW ROSE	#3	AS SHOWN	POT
SP	9	SYRINGA P. 'MISS KIM'	MISS KIM LILAC	#5	AS SHOWN	POT
PERE	INNIALS /	GRASSES				
AN	9	ASTER NOVAE ANGLIAE 'OCTOBER SKIES'	NEW ENGLAND ASTER	#2	24" O.C.	STAGGERE
AT	7	ASCLEPIAS TUBEROSA	BUTTERFLYWEED	#2	24" O.C.	STAGGERE
BA	21	BAPTISIA AUSTRALIS	BLUE FALSE INDIGO	#2	24" O.C.	STAGGER
EP	26	ECHINACEA PURPUREA 'POWPOW WILDBERRY'	POW WOW WILDBERRY CONEFLOWER	#2	24" O.C	STAGGERE
EU	13	EUPATORIUM 'LITTLE JOE'	'LITTLE JOE' JOE PYE WEED	#2	24" O.C.	STAGGER
НН	11	HELIOPSIS HELIANTHOIDES 'TUSCAN SUN'	TUSCAN SUN OXEYE SUNFLOWER	#2	24" O.C.	STAGGER
НО	13	HOSTA 'GUACAMOLE'	GUACAMOLE HOSTA	#2	24" O.C.	STAGGERE
LS	11	LIATRIS SPICATA 'KOBOLD'	KOBOLD GAYFEATHER	#2	24" O.C.	STAGGERE
PD	27	PENSTEMON DIGITALIS 'HUSKER RED'	FOXGLOVE BEARDTONGUE 'HUSKER RED'	#2	24" O.C.	STAGGERE
RF	33	RUDBECKIA FULGIDA	ORANGE CONEFLOWER	#2	24" O.C.	STAGGERE
SB	20	SALVIA 'BLUE HILL'	BLUE HILL SAGE	#2	24" O.C.	STAGGERE



R:\PROJECTS\1583-55B\CIVIL\DRAWINGS\CURRENT\L-1583-55B_LANDSCAPE.DWG

BETHANY DERMODY, HEREBY CERTIFY THAT AM THE DESIGNER OF THIS LANDSCAPE PLAN AND THAT I AM A PROFESSIONAL LANDSCAPE ARCHITECT LICENSED BY THE STATE OF NEW HAMPSHIRE."

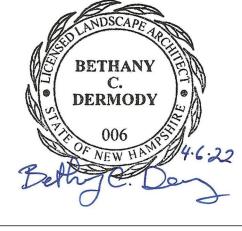

PROFESSIONAL LANDSCAPE ARCHITECT FOR ALLEN & MAJOR ASSOCIATES, INC.

1	04-06-22	REVISED COFFEE SHOP BUILDING
REV	DATE	DESCRIPTION

APPLICANT\OWNER:

LINEAR RETAIL PROPERTIES, LLC 5 BURLINGTON WOODS DR. S. 107 BURLINGTON, MA 01803

PROJECT:

525 HOOKSETT ROAD AKA DANIEL WEBSTER HWY. MAP-LOT: 916-41A MANCHESTER, NH 03104

PROJECT NO. 1583-55B DATE: 03-15-2022 1" = 30' DWG. NAME: C-1583-55E **DRAFTED BY:** BDJ | CHECKED BY:



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MANCHESTER, NH 03101 TEL: (603) 627-5500 FAX: (603) 627-5501


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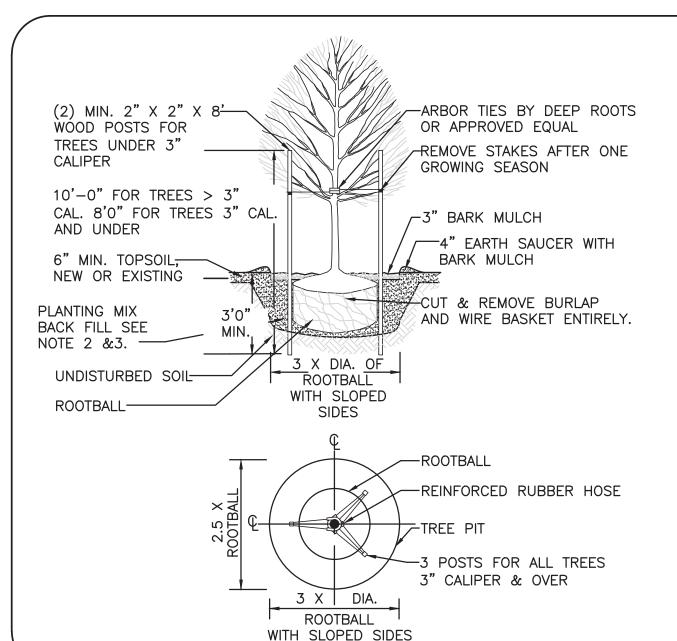
L-101 LANDSCAPING PLAN



<u>NOTES</u>

- 1. TREES SHALL BEAR SAME RELATIONSHIP TO FINISH GRADE AS IT BORE TO NURSERY OR FIELD GRADE. ROOT FLARE SHALL BE 2" ABOVE FINISH GRADE. REMOVE SOIL FROM TRUNK FLARE OF TREE TO DETERMINE ACTUAL TOP OF ROOTBALL AREA.
- 2. INSTALL THREE GUYS PER TREE; EQUALLY SPACED AROUND BALL.
- 3. ATTACH GUYS AT 2/3 HEIGHT OF TREE.
- 4. BACKFILL WITH PLANTING MIX. PLANT MIX TO BE: 50% NATIVE TOPSOIL. 20% COMPOST (LEAVES & ORGANIC MATERIAL, NO ASH) 20% PEAT MOSS, 10% SAND.
- 5. ADD MYCORRHIZA SOIL ADDITIVES AND SLOW RELEASE FERTILIZER WHEN PLANT HOLES ARE 50% FILLED AND WATER THOROUGHLY AT COMPLETION.

EVERGREEN TREE DETAIL

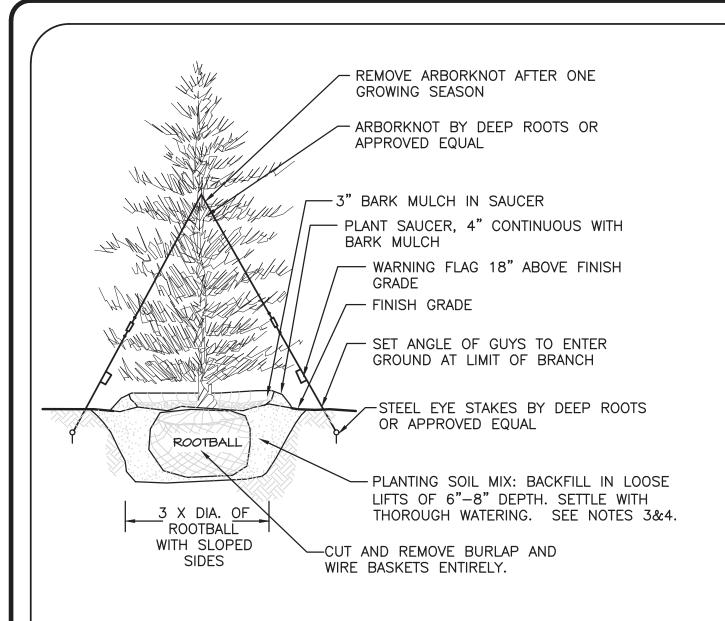

1. ALL TREES SHALL HAVE THE SAME RELATIONSHIP TO FINISH GRADE AFTER PLANTING AS THEY HAD AT THE ORIGINAL NURSERY SETTING. ROOT FLARE SHALL BE 2" ABOVE FINISH GRADE. REMOVE SOIL FROM TRUNK FLARE OF TREE TO DETERMINE ACTUAL ROOTBALL AREA.

NOT TO SCALE

- 2. BACKFILL WITH PLANTING MIX. PLANT MIX TO BE: 50% NATIVE TOPSOIL, 20% COMPOST (LEAVES & ORGANIC MATERIAL, NO ASH) 20% PEAT MOSS, 10% SAND.
- 3. ADD MYCORRHIZA SOIL ADDITIVES AND SLOW RELEASE FERTILIZER WHEN PLANT HOLES ARE 50% FILLED AND WATER THOROUGHLY AT COMPLETION.

DECIDUOUS TREE PLANTING DETAIL NOT TO SCALE

LOAM AND STANDARD SEEDING NOTES:

CONTRACTOR SHALL SEED ALL DISTURBED AREAS NOT NOTED TO RECEIVE OTHER MATERIALS, AND AT AREAS SHOWN ON THE PLAN PER SPECIFICATIONS BELOW

SCIENTIFIC NAME	COMMON NAME	PROPORTION <u>BY WEIGH</u>	PERCENT T <u>PURITY</u>	PERCENT GERMINATION
FESTUCA RUBRA "RUBRA"	CREEPING RED FESCUE	37%	95%	90%
PAO PRAENTENSIS "BARON"	BARON KENTUCKY BLUEGRASS	40%	85%	90%
LOLIUM PERENNE "PALMER"	PALMER PERENNIAL RYEGRASS	15%	95%	90%
FESTUCA RUBRA COMMUTATA WILMA	WILMA CHEWINGS	8%	95%	80%

- 1. SEED TO BE SPREAD AT MINIMUM RATE OF 5 LBS. PER 1000 SQ. FT.
- 2. SEEDING TO BE COMPLETED "IN SEASON" BETWEEN APRIL 1 TO JUNE 15 OR AUGUST 15 TO OCTOBER 1, EXCEPT FOR RESEEDING OF BARE SPOTS. IF UNABLE TO SEED WITHIN THESE TIMEFRAMES, CONTRACTOR TO INSTALL EROSION CONTROL MATS ON ALL SLOPES 3:1 AND OVER, HYDROSEED ALL EXPOSED AREAS, ADD SOIL STABILIZER "FLUX TERRA HP-FGM SOIL STABILIZER" AS MANUFACTURED BY "PROFILE" TO HYDROSEED (AT RATE OF 3,000 LBS PER ACRE), AT NO ADDITIONAL COST TO THE OWNER. CONTRACTOR TO COMPLETE ALL ABOVE "OUT OF SEASON" REQUIREMENTS AND THEN ALSO BE RESPONSIBLE FOR RE-GRADING AND RE-SEEDING ALL DISTURBED, ERODED, OR BARE SPOTS WITHIN NEXT CLOSEST PLANTING SEASON IN FALL OR SPRING AT NO ADDITIONAL COST TO OWNER. CONTRACTOR RESPONSIBLE FOR ALL MAINTENANCE UNTIL FINAL ACCEPTANCE OF LAWN AREAS INCLUDING: WATERING, ADDING FERTILIZERS AND LIME AND MOWING AT NO ADDITIONAL COST TO OWNER.
- 3. COMMERCIAL FERTILIZER SHALL BE APPLIED AT THE RATE OF 25 POUNDS PER 1000 SQ. FT. OR AS RECOMMENDED BY THE TESTING AGENCY. LIME TO BE SPREAD AT THE RATE OF 100 POUNDS PER 1000 SQ. FT OR AS RECOMMENDED BY THE TESTING AGENCY. COMMERCIAL FERTILIZER SHALL BE A COMPLETE FERTILIZER CONTAINING AT LEAST 50% OF THE NITROGEN OF WHICH IS DERIVED FROM NATURAL ORGANIZE SOURCES OF UREAFORM. IT SHALL CONTAIN THE FOLLOWING PERCENTAGES BY WEIGHT NITROGEN (N) 10%, PHOSPHORUS (P) 6%, POTASH (K) 4%. LIME SHALL BE AN APPROVED AGRICULTURAL LIMESTONE CONTAINING NOT LESS THAN 85% OF TOTAL CARBONATES. LIMESTONE SHALL BE GROUND TO SUCH FINENESS THAT 50% WILL PASS A 100 MESH SIEVE AND 90% WILL PASS THROUGH A 20 MESH SIEVE.
- 4.LAWN AREAS TO BE SEEDED BY SOWING EVENLY WITH AN APPROVED MECHANICAL SEEDER AT THE RATE OF TEN POUNDS PER 1000 SQUARE FEET.

5.CONTRACTOR RESPONSIBLE FOR WATERING, MOWING, AND RESEEDING OF LAWN BARE SPOTS UNTIL A UNIFORM, HEALTHY STAND OF GRASS IS ESTABLISHED AND ACCEPTED.

-SEED. SEE LANDSCAPE PLAN FOR TYPE

SCREENED


(NO STONES

THAN 3/8")

- COMPACTED

SUBGRADE SOILS.

LARGER

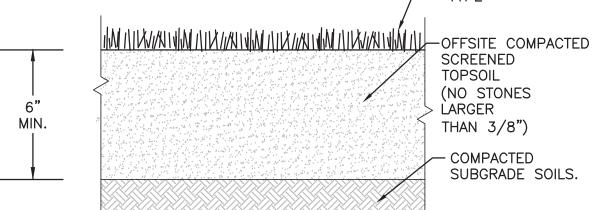

TEXTURE CLASS % OF TOTAL WEIGHT 45% - 65% SILT 15% - 35% 5% - 20% CLAY

% PASSING
100
85-100
60-85
38-60
10-35
LESS THAN

1. TOP OF LOAM (TOPSOIL) IS FINISH GRADE.


ALL TOPSOIL (BOTH ONSITE AND OFFSITE SOURCES) SHALL BE COMPOSED OF A NATURAL, FERTILE, FRIABLE SOIL TYPICAL OF CULTIVATED TOPSOILS OF THE LOCALITY. OFFSITE SOIL SHALL BE SUITABLE FOR THE GERMINATION OF SEEDS AND SUPPORT OF VEGETATIVE GROWTH, WITH ADDITIVES, IF REQUIRED, TO ACHIEVE PARTICLE DISTRIBUTION AND ORGANIC CONTENT BELOW. TOPSOIL SHALL BE TAKEN FROM A WELL-DRAINED, ARIABLE SITE, FREE OF SUBSOIL, LARGE STONES, EARTH CLODS, STICKS, STUMPS, CLAY LUMPS, ROOTS, OTHER OBJECTIONABLE, EXTRANEOUS MATTER OR DEBRIS NOR CONTAIN TOXIC SUBSTANCES.

5%

- THE CONTRACTOR SHALL PROVIDE THE OWNER / LANDSCAPE ARCHITECT WITH TOPSOIL TEST RESULTS (RECOMMEND UMASS AMHERST SOIL TESTING LAB) FOR APPROVAL PRIOR TO OBTAINING AND PLACING THE SOIL. IF ANY TOPSOIL IS PURCHASED OR PLACED PRIOR TO APPROVAL BY OWNER / LANDSCAPE ARCHITECT, IT IS AT CONTRACTORS RISK, AND IT CAN BE REMOVED AT NO ADDITIONAL COST TO THE OWNER. IF THE PLANTING SOIL (BOTH ONSITE AND OFFSITE SOURCES) DOES NOT FALL WITHIN THE REQUIRED SIEVE ANALYSIS, TEXTURAL CLASS, ORGANIC CONTENT, OR PH RANGE, IT SHALL BE ADJUSTED TO MEET THE SPECIFICATIONS THROUGH THE ADDITION OF SAND, COMPOST, LIMESTONE, OR ALUMINUM SULFATE TO BRING IT WITHIN THE SPECIFIED LIMITS AT NO ADDITIONAL COST TO THE OWNER.
- 4. TOPSOIL SHALL HAVE A PH VALUE BETWEEN 5.5 AND 6.5. TOPSOIL SHALL CONTAIN BETWEEN 4% AND 8% ORGANIC MATTER OF TOTAL DRY WEIGHT AND SHALL CONFORM TO THE FOLLOWING GRADATION AND TEXTURE CLASS ABOVE.

TOPSOIL FOR LAWN, TREES, SHRUBS, & PERENNIALS NOT TO SCALE

- 1. ALL SHRUBS SHALL HAVE THE SAME RELATIONSHIP TO FINISH GRADE AFTER PLANTING AS THEY HAD AT THE ORIGINAL NURSERY SETTING. SET SHRUB 1"-2" ABOVE FINISH GRADE.
- 2. BACKFILL WITH PLANTING MIX. PLANT MIX TO BE: 50% NATIVE TOPSOIL. 20% COMPOST (LEAVES & ORGANIC MATERIAL, NO ASH) 20% PEAT MOSS, 10% SAND.
- 3. ADD MYCORRHIZA SOIL ADDITIVES AND SLOW RELEASE FERTILIZER WHEN PLANT HOLES ARE 50% FILLED AND WATER THOROUGHLY AT COMPLETION. 4. SHRUB BEDS TO HAVE 24" MIN. OF CONTINUOUS PLANTING SOIL.

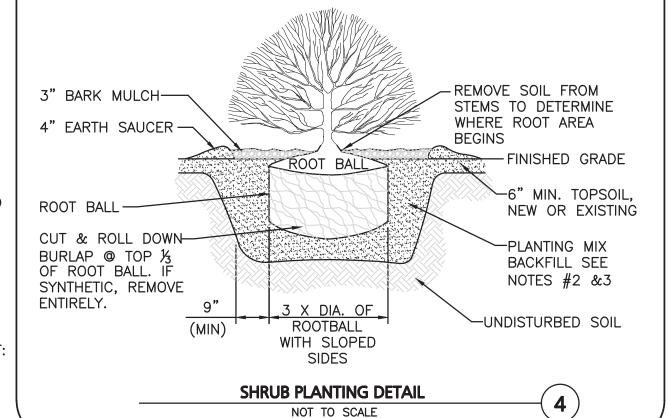

LANDSCAPE NOTES

- 1. ALL WORK SHALL BE IN ACCORDANCE WITH THE REQUIREMENTS OF THE CITY OF MANCHESTER, NH, SPECIFICATIONS.
- 2. PLANTING PLAN IS DIAGRAMMATIC IN NATURE. FINAL PLACEMENT OF PLANTS TO BE APPROVED BY THE LANDSCAPE ARCHITECT IN THE FIELD.
- THE CONTRACTOR SHALL BE RESPONSIBLE FOR CONTACTING ALL UTILITY COMPANIES, ANY PERMITTING AGENCIES, AND "DIG-SAFE"(1-888-DIG-SAFE)AT LEAST 72 HOURS IN ADVANCE OF ANY WORK THAT WILL REQUIRE EXCAVATION. CONTRACTOR SHALL NOTIFY THE OWNERS REPRESENTATIVE OF ANY CONFLICTS IN WRITING.
- 4. NO PLANT MATERIAL SHALL BE INSTALLED UNTIL ALL GRADING AND CONSTRUCTION HAS BEEN COMPLETED IN THE IMMEDIATE AREA, ANY TREES NOTED AS "SEAL OR SELECTED SPECIMEN" SHALL BE TAGGED AND SEALED BY THE LANDSCAPE ARCHITECT.
- 5. ALL TREES SHALL BE BALLED AND BURLAPPED (B&B) UNLESS OTHERWISE NOTED OR APPROVED BY THE OWNER'S REPRESENTATIVE AND LANDSCAPE ARCHITECT.
- 6. CONTRACTOR SHALL VERIFY QUANTITIES SHOWN ON PLANT LIST. QUANTITIES SHOWN ON PLANS SHALL GOVERN OVER PLANT LIST.
- 7. ANY PROPOSED PLANT SUBSTITUTIONS MUST BE APPROVED IN WRITING BY OWNER'S REPRESENTATIVE AND LANDSCAPE ARCHITECT.
- 8. ALL PLANT MATERIALS INSTALLED SHALL MEET THE GUIDELINES ESTABLISHED BY THE STANDARDS FOR NURSERY STOCK PUBLISHED BY THE AMERICAN ASSOCIATION OF
- 9. ALL PLANT MATERIALS SHALL BE GUARANTEED FOR ONE YEAR FOLLOWING DATE OF ACCEPTANCE.
- 10. ALL DISTURBED AREAS NOT OTHERWISE NOTED SHALL RECEIVE 4" OF LOAM AND SEED. LAWNS WITH OVER 3:1 SLOPES SHALL BE PROTECTED WITH AN EROSION CONTROL BLANKET.
- 11. ANY FALL TRANSPLANTING HAZARD PLANTS SHALL BE DUG IN THE SPRING AND STORED FOR FALL PLANTING.
- 12. TREES SHALL HAVE A MINIMUM CALIPER OF 2 1/2" ONE FOOT ABOVE THE ROOT CROWN
- 13. ALL PLANT BEDS AND TREE SAUCERS TO RECEIVE 3" OF PINE BARK MULCH, AND GROUND COVER AREAS SHALL RECEIVE 1" OF PINE BARK MULCH.
- 14. ALL DECIDUOUS TREES ADJACENT TO WALKWAYS AND ROADWAYS SHALL HAVE A BRANCHING PATTERN TO ALLOW FOR A MINIMUM OF 7' OF CLEARANCE BETWEEN THE GROUND AND THE
- 15. CONTRACTOR RESPONSIBLE FOR WATERING, AND RESEEDING OF BARE SPOTS UNTIL A UNIFORM STAND OF VEGETATION IS ESTABLISHED AND ACCEPTED.
- 16. ALL PARKING ISLANDS PLANTED WITH SHRUBS SHALL HAVE 24" OF TOP SOIL. FINISH GRADE SHALL BE EQUAL TO THE TOP OF CURB.
- 17. SOIL SAMPLES AND TESTS SHALL BE PROVIDED TO THE LANDSCAPE ARCHITECT OR THE
- 18. REFER TO NEW ENGLAND WETLAND PLANS, INC (WWW.NEWP.COM) FOR CURRENT SEED MIXES & APPLICATION RATES.
- 19. ALL PROPOSED LANDSCAPE AREAS INCLUDING MOWED LAWNS, TREES, SHRUB BEDS, AND PERENNIALS SHALL BE PROVIDED WITH WATER EFFICIENT UNDERGROUND IRRIGATION. DESIGN AND INSTALLATION OF IRRIGATION SYSTEM TO BE PERFORMED BY AN APPROVED IRRIGATION DESIGN BUILD CONTRACTOR OR BY AN APPROVED EQUAL, TO BE DETERMINED BY THE OWNERS REPRESENTATIVE AND LANDSCAPE ARCHITECT. IRRIGATION SYSTEM IS TO BE DESIGNED FOR EFFICIENT WATER USAGE INCLUDING: USE OF DRIP IRRIGATION FOR SHRUBS AND PERENNIALS, IRRIGATION SYSTEM WITH HEAD-TO-HEAD COVERAGE, A CENTRAL SHUT-OFF VALVE. SEPARATE ZONES FOR EACH TYPE OF BEDDING AREA BASED ON WATERING NEEDS, AND A RAIN SENSOR TO SHUT OFF IRRIGATION DURING RAIN EVENTS.

LOAM AND SOD NOTES:

- 1. CONTRACTOR SHALL SOD AREAS NOTED ON THE PLANS.
- 2. SOD IS TO BE A BLEND OF FOUR TO FIVE CURRENT AND IMPROVED HYBRID BLUEGRASS AND FESCUE MIXES APPROPRIATE FOR BOTH SEMI-SHADED AND AREAS OF SUN. HYBRIDS MAY INCLUDE: BLACKSTONE KENTUCKY BLUEGRASS, AWARD KENTUCKY BLUEGRASS, CHALLENGER KENTUCKY BLUEGRASS, BLACKBURG II KENTUCKY BLUEGRASS OR COMPARABLE AND EQUAL BLUEGRASS HYBRIDS.
- SOD SHALL BE HIGH QUALITY, NURSERY GROWN ON CULTIVATED MINERAL AGRICULTURAL SOILS. SOD SHALL BE MOIST AND MACHINE CUT AT A UNIFORM SOIL THICKNESS OF AT LEAST 5/8" AT TIME OF CUTTING. MEASUREMENT FOR THICKNESS SHALL INCLUDE TOP GROWTH AND THATCH. SOD SHALL BE FREE OF DISEASES, WEEDS, BARE SPOTS, OR INSECTS.
- SODDING TO BE COMPLETED "IN SEASON" BETWEEN APRIL 1 TO JUNE 15 OR AUGUST 15 TO OCTOBER 1, EXCEPT FOR RE-SODDING OF BARE SPOTS. IF UNABLE TO SOD WITHIN THESE TIMEFRAMES, CONTRACTOR TO INSTALL EROSION CONTROL MATS ON ALL SLOPES 3:1 AND OVER, HYDROSEED ALL EXPOSED AREAS, ADD SOIL STABILIZER "FLUX TERRA HP-FGM SOIL STABILIZER" AS MANUFACTURED BY "PROFILE" TO HYDROSEED (AT RATE OF 3,000 LBS PER ACRE). CONTRACTOR TO COMPLETE ALL ABOVE "OUT OF SEASON" REQUIREMENTS AND THEN ALSO BE RESPONSIBLE FOR RE-GRADING AND RE-SODDING ALL DISTURBED. ERODED, OR BARE SPOTS WITHIN NEXT CLOSEST PLANTING SEASON IN FALL OR SPRING.
- COMMERCIAL FERTILIZER SHALL BE APPLIED AT THE RATE OF 25 POUNDS PER 1000 SQ. FT. OR AS RECOMMENDED BY THE TESTING AGENCY. LIME TO BE SPREAD AT THE RATE OF 100 POUNDS PER 1000 SQ. FT OR AS RECOMMENDED BY THE TESTING AGENCY. COMMERCIAL FERTILIZER SHALL BE A COMPLETE FERTILIZER CONTAINING AT LEAST 50% OF THE NITROGEN OF WHICH IS DERIVED FROM NATURAL ORGANIZE SOURCES OF UREAFORM. IT SHALL CONTAIN THE FOLLOWING PERCENTAGES BY WEIGHT: NITROGEN (N) 10%, PHOSPHORUS (P) 6%, POTASH (K) 4%. LIME SHALL BE AN APPROVED AGRICULTURAL LIMESTONE CONTAINING NOT LESS THAN 85% OF TOTAL CARBONATES. LIMESTONE SHALL BE GROUND TO SUCH FINENESS THAT 50% WILL PASS A 100 MESH SIEVE AND 90% WILL PASS THROUGH A 20 MESH SIEVE.
- CONTRACTOR RESPONSIBLE FOR WATERING, MOWING, AND RE-SODDING OF LAWN BARE SPOTS UNTIL A UNIFORM, HEALTHY STAND OF GRASS IS ESTABLISHED AND ACCEPTED.



DRAWING TITLE:

LANDSCAPE DETAILS

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PROFESSIONAL LANDSCAPE ARCHITECT FOR

LINEAR RETAIL PROPERTIES, LLC

5 BURLINGTON WOODS DR. S. 107

525 HOOKSETT ROAD

AKA DANIEL WEBSTER HWY.

MAP-LOT: 916-41A

MANCHESTER, NH 03104

1583-55B DATE:

ALLEN & MAJOR

ASSOCIATES, INC.

civil engineering ♦ land surveying

nvironmental consulting • landscape architecture

www.allenmajor.com

400 HARVEY ROAD

MANCHESTER, NH 03101

TEL: (603) 627-5500

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BURLINGTON, MA 01803


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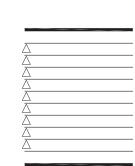
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1-888-344-7233 R:\PROJECTS\1583-55B\CIVIL\DRAWINGS\CURRENT\L-1583-55B_LANDSCAPE.DWG





CONTRACT DATE: xx.xx.xx ENDEAVOR 50 BUILDING TYPE: PLAN VERSION: SITE NUMBER: STORE NUMBER:

TACO BELL

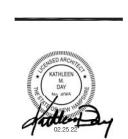525 Hookset Road Manchester, New Hampshire




ELEVATION RENDERINGS

ELEV PERMIT PLOT DATE:





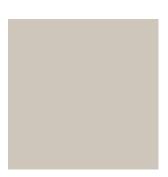


SHERWIN WILLIAMS







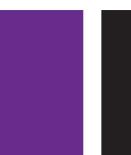

DARK BRONZE

ALUMINUM STOREFRONT




SHERWIN WILLIAMS

SHERWIN WILLIAMS

PURPLE (SW/TB2603C)



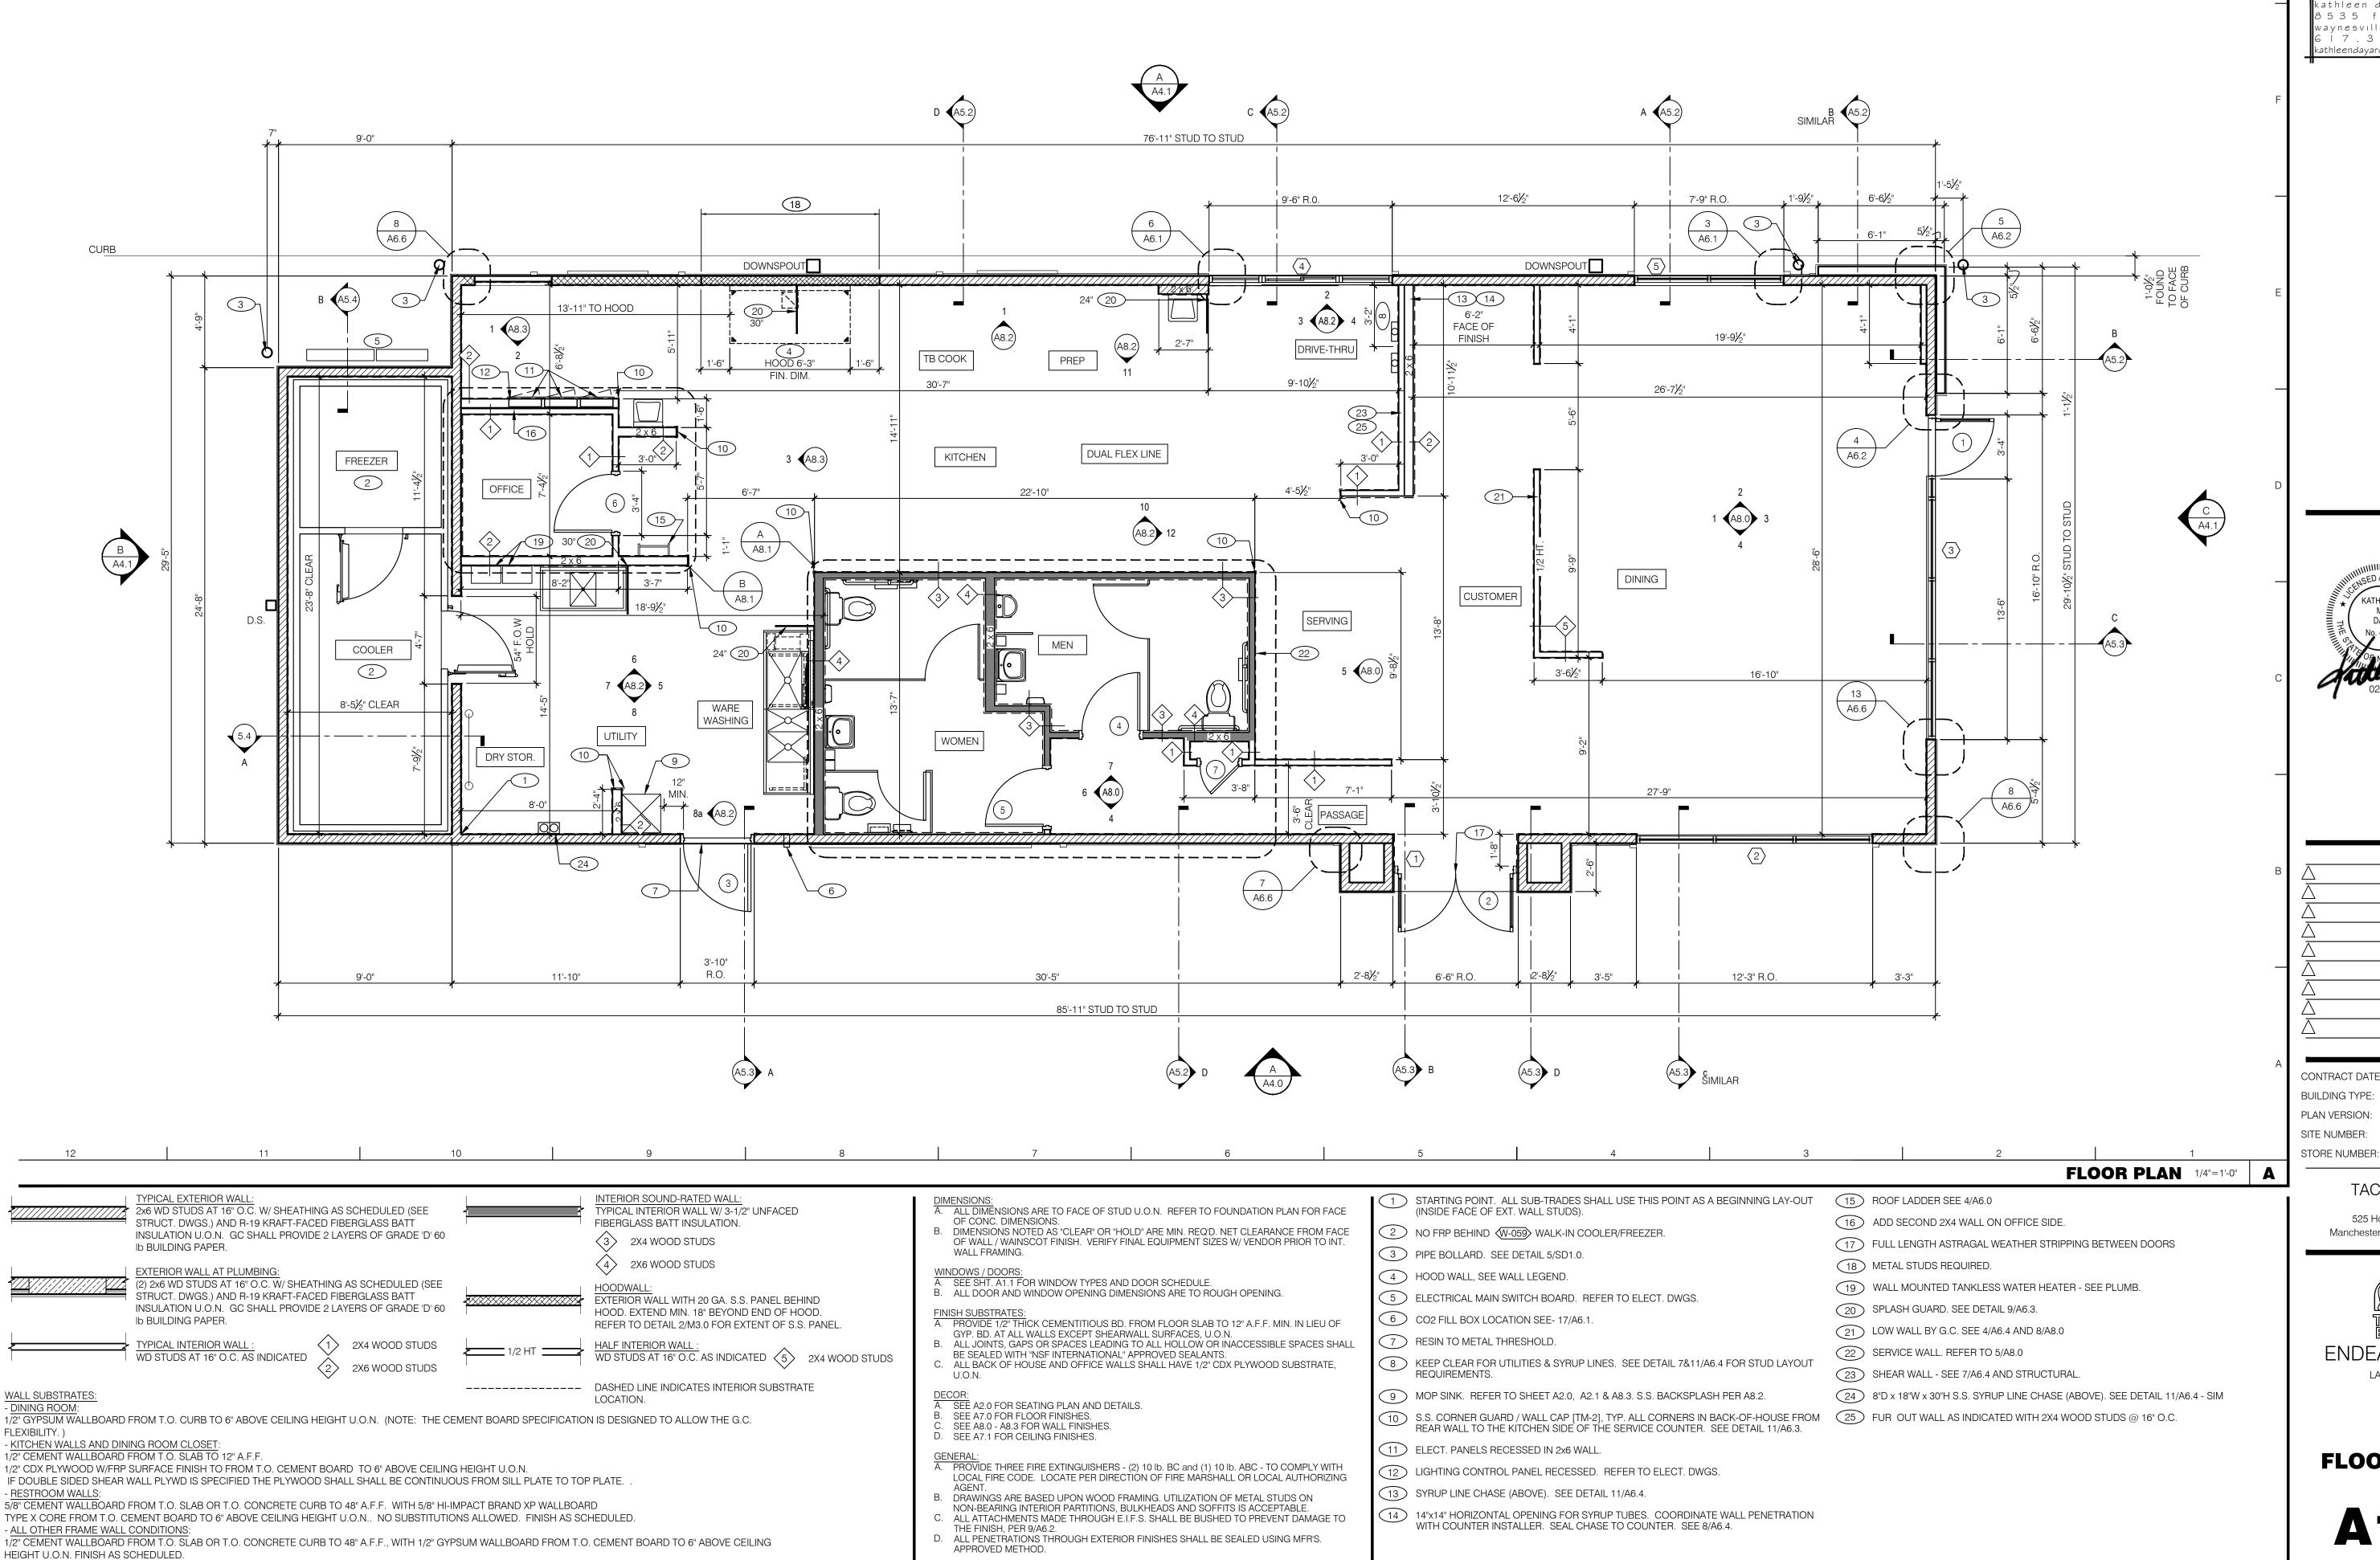


FLOOR PLAN NOTES

WALL LEGEND

D

3535 ferry roa waynesville, oh 45068 3 i 7 . 3 3 I . 2 5 4

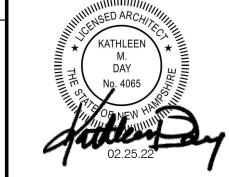

CONTRACT DATE **ENDEAVOR 50** BUILDING TYPE: PLAN VERSION: SITE NUMBER:

TACO BELL

525 Hookset Road Manchester, New Hampshire



ENDEAVOR 2.0

LARGE 50

FLOOR PLAN

KEY NOTES

