IMPROVEMENT PLANS

TACO BELL


17669 23 MILE ROAD MACOMB, MICHIGAN MAY, 2022



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OWNER AND DEVELOPER
PETE ZINGAS
645 GRISWOLD, SUITE 3466
DETROIT, MI 48226



5 7/29/22 Macomb Township Comments

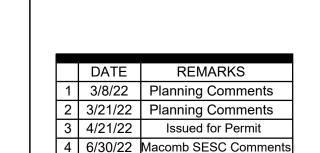520 South Main Street, Suite 2531 Akron, OH 44311 330.572.2100 Fax: 330.572.2102

CONTRACT DATE: 11.15.21
BUILDING TYPE: END. MED20
PLAN VERSION: MARCH 2021
BRAND DESIGNER: DICKSON
SITE NUMBER: 315390
STORE NUMBER: 457226
PA/PM: SM
DRAWN BY.: FA

TACO BELL

2021088.48

17669 23 Mile Road Macomb, MI 48042

JOB NO.:



ENDEAVOR 2.0

TITLE SHEET

TS-001

PROJECT DESCRIPTION

THE SUBJECT PROJECT AREA IS 2.17 ACRE SITE WHICH IS A VACANT LOT. THE IMPROVEMENTS TO THIS SITE WILL INCLUDE BUT NOT LIMITED TO A NEW TACO BELL RESTAURANT, NEW PARKING LOT, CONCRETE SIDEWALKS, ALL APPURTENANT UTILITY CONNECTIONS, DETENTION POND, GRADING AND LANDSCAPING.

MICHIGAN SPECIFICATION

THE STANDARD SPECIFICATIONS OF THE STATE OF MICHIGAN, DEPARTMENT OF TRANSPORTATION, INCLUDING CHANGES AND SUPPLEMENTAL SPECIFICATIONS LISTED IN THE PROPOSAL SHALL GOVERN THIS IMPROVEMENT.


PLAN REPRODUCTION WARNING
THE PLANS HAVE BEEN PREPARED
FOR PRINTING ON ANSI D (24"x36")
SHEETS. PRINTING ON OTHER SIZE
SHEETS MAY DISTORT SCALES.
REFER TO GRAPHIC SCALES.


Engineer's Certification


"I hereby certify that I have read the Township's Land Development Ordinance (and its related Engineering and Construction Standards), and I have prepared these plans in complete conformity with the requirements of said Ordinance."


Leonardo Sferra* P.E.

*My signature on this certification represents only items to the extent within GPD's scope of work and the sheets bearing my stamp/signature. As such, Contractor, Owner, and any Third-Party(ies) remain responsible for their respective roles.

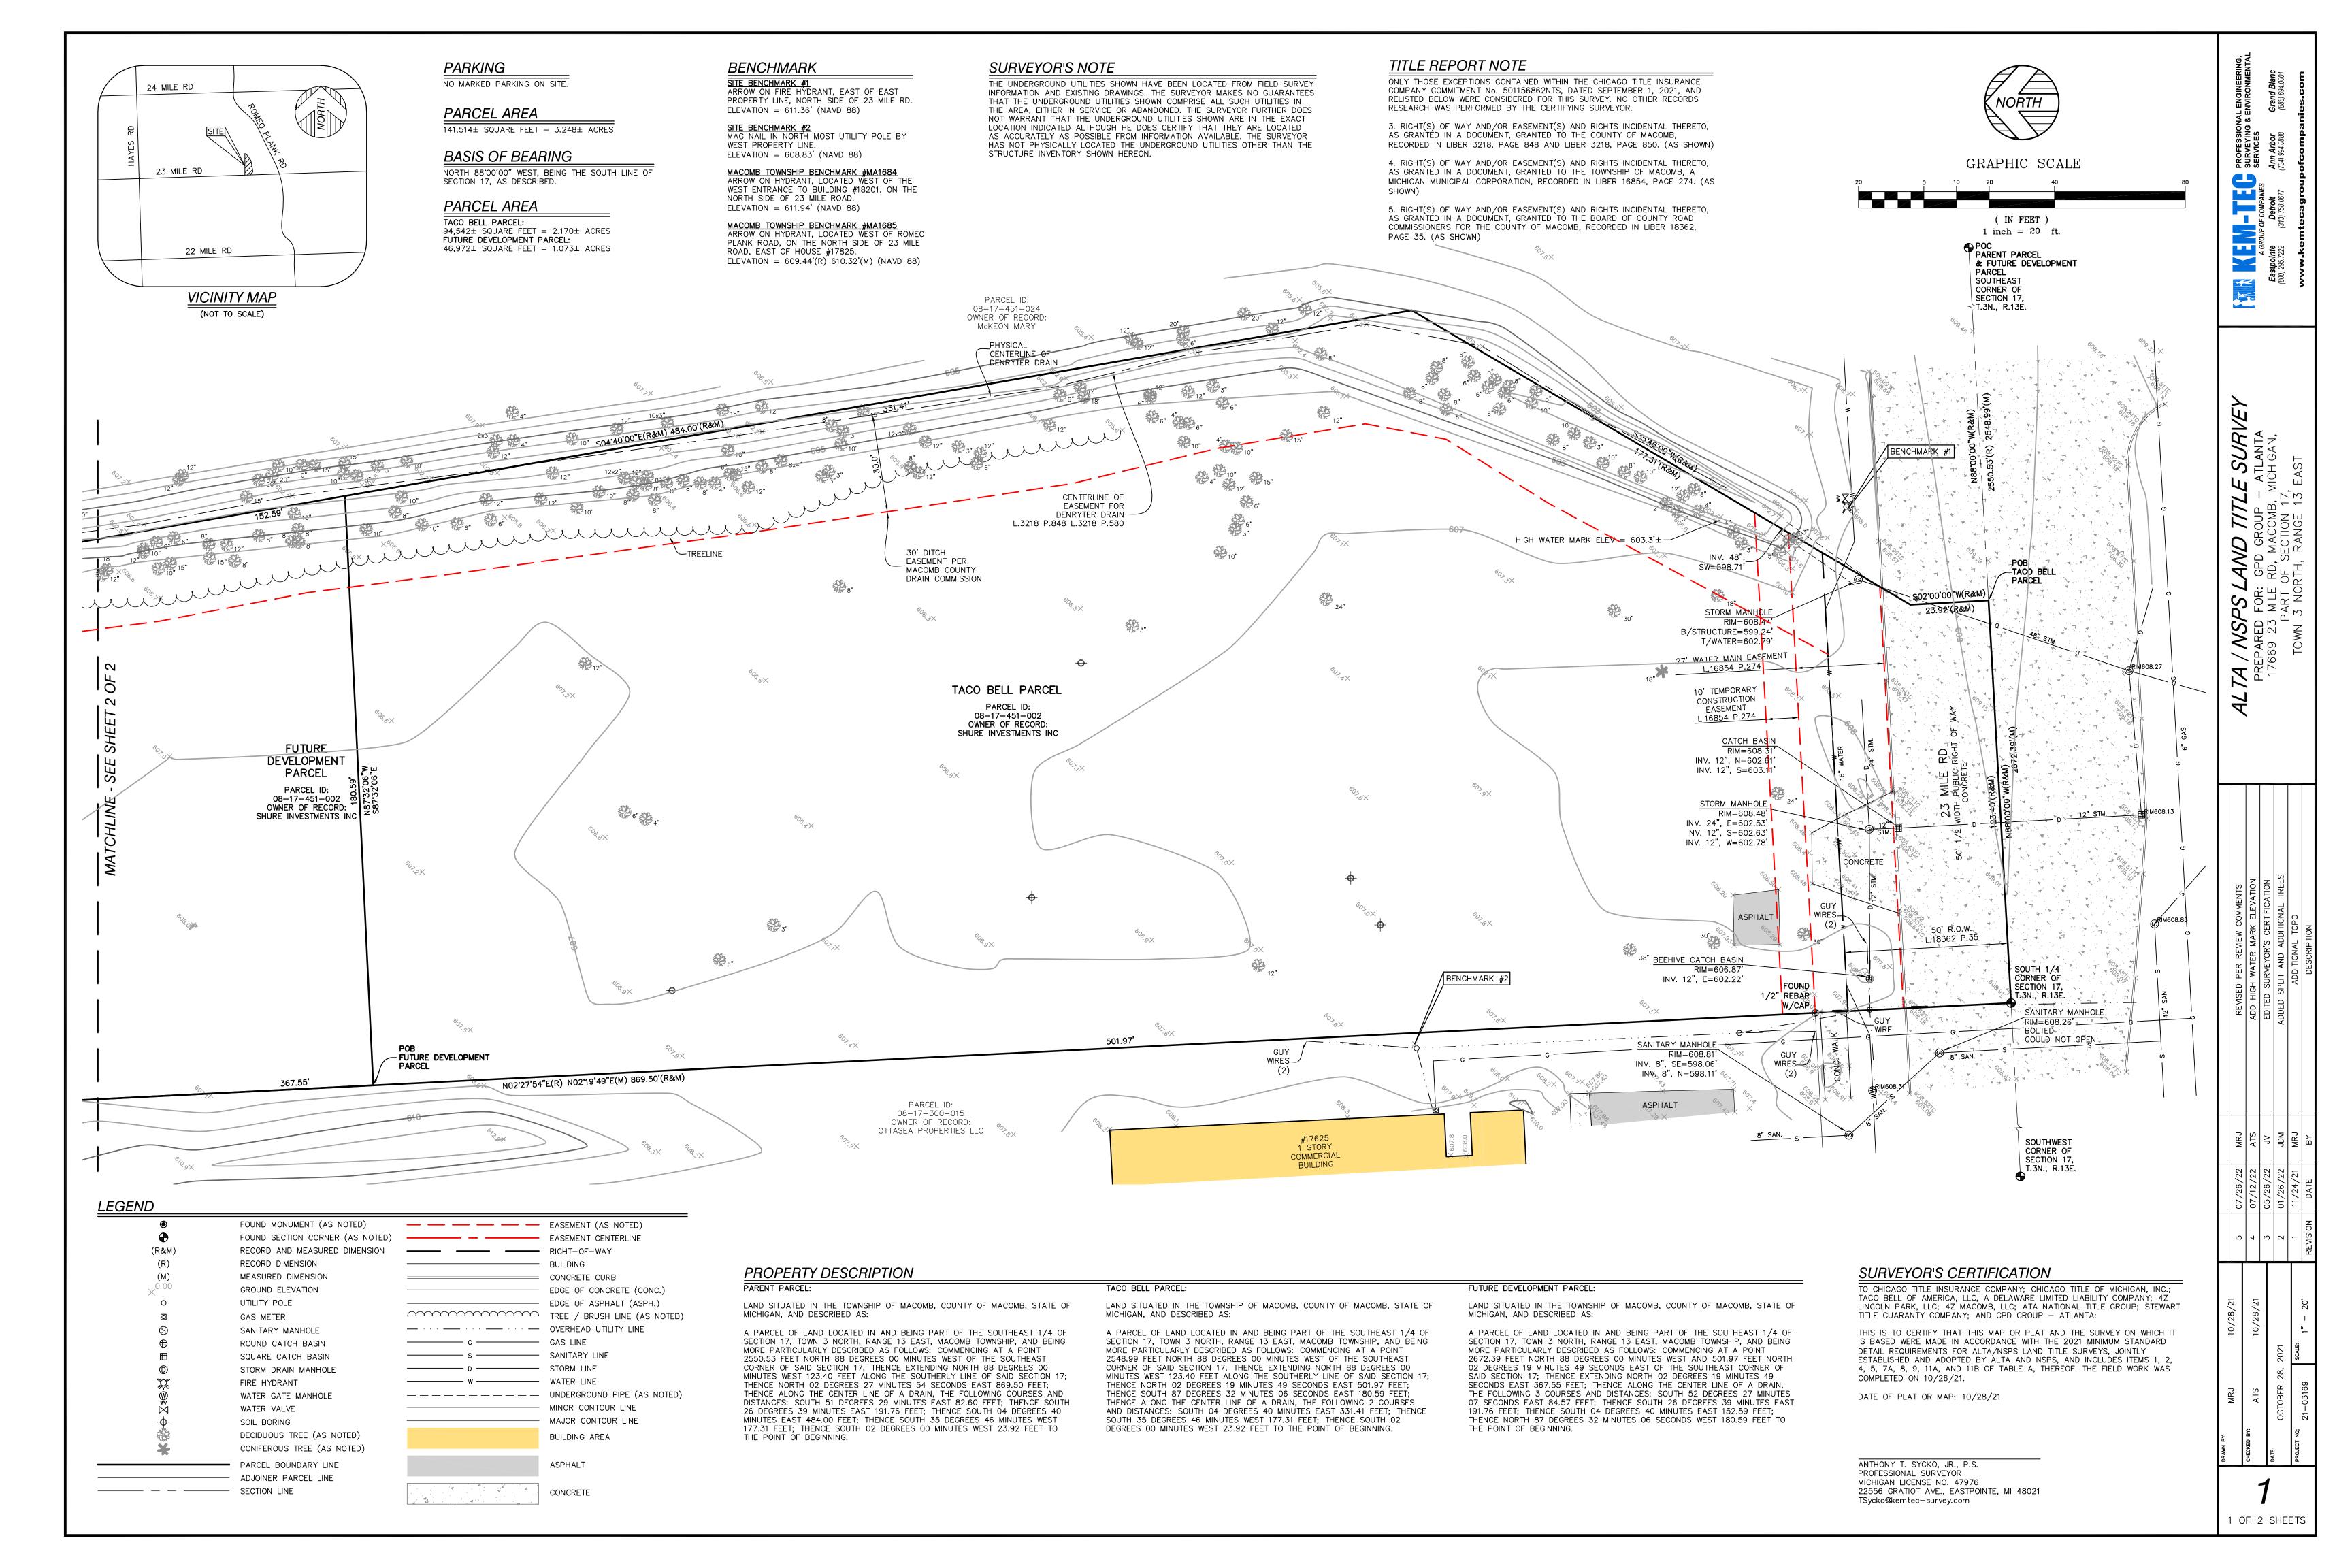

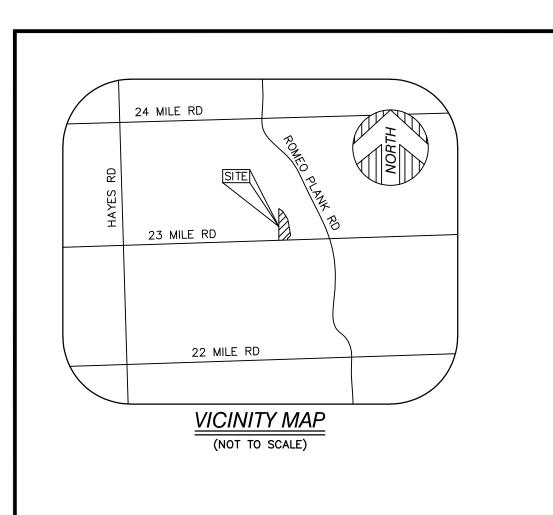

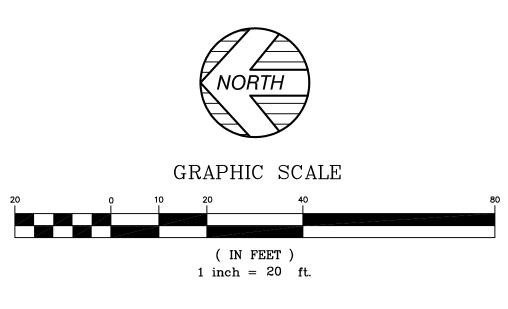

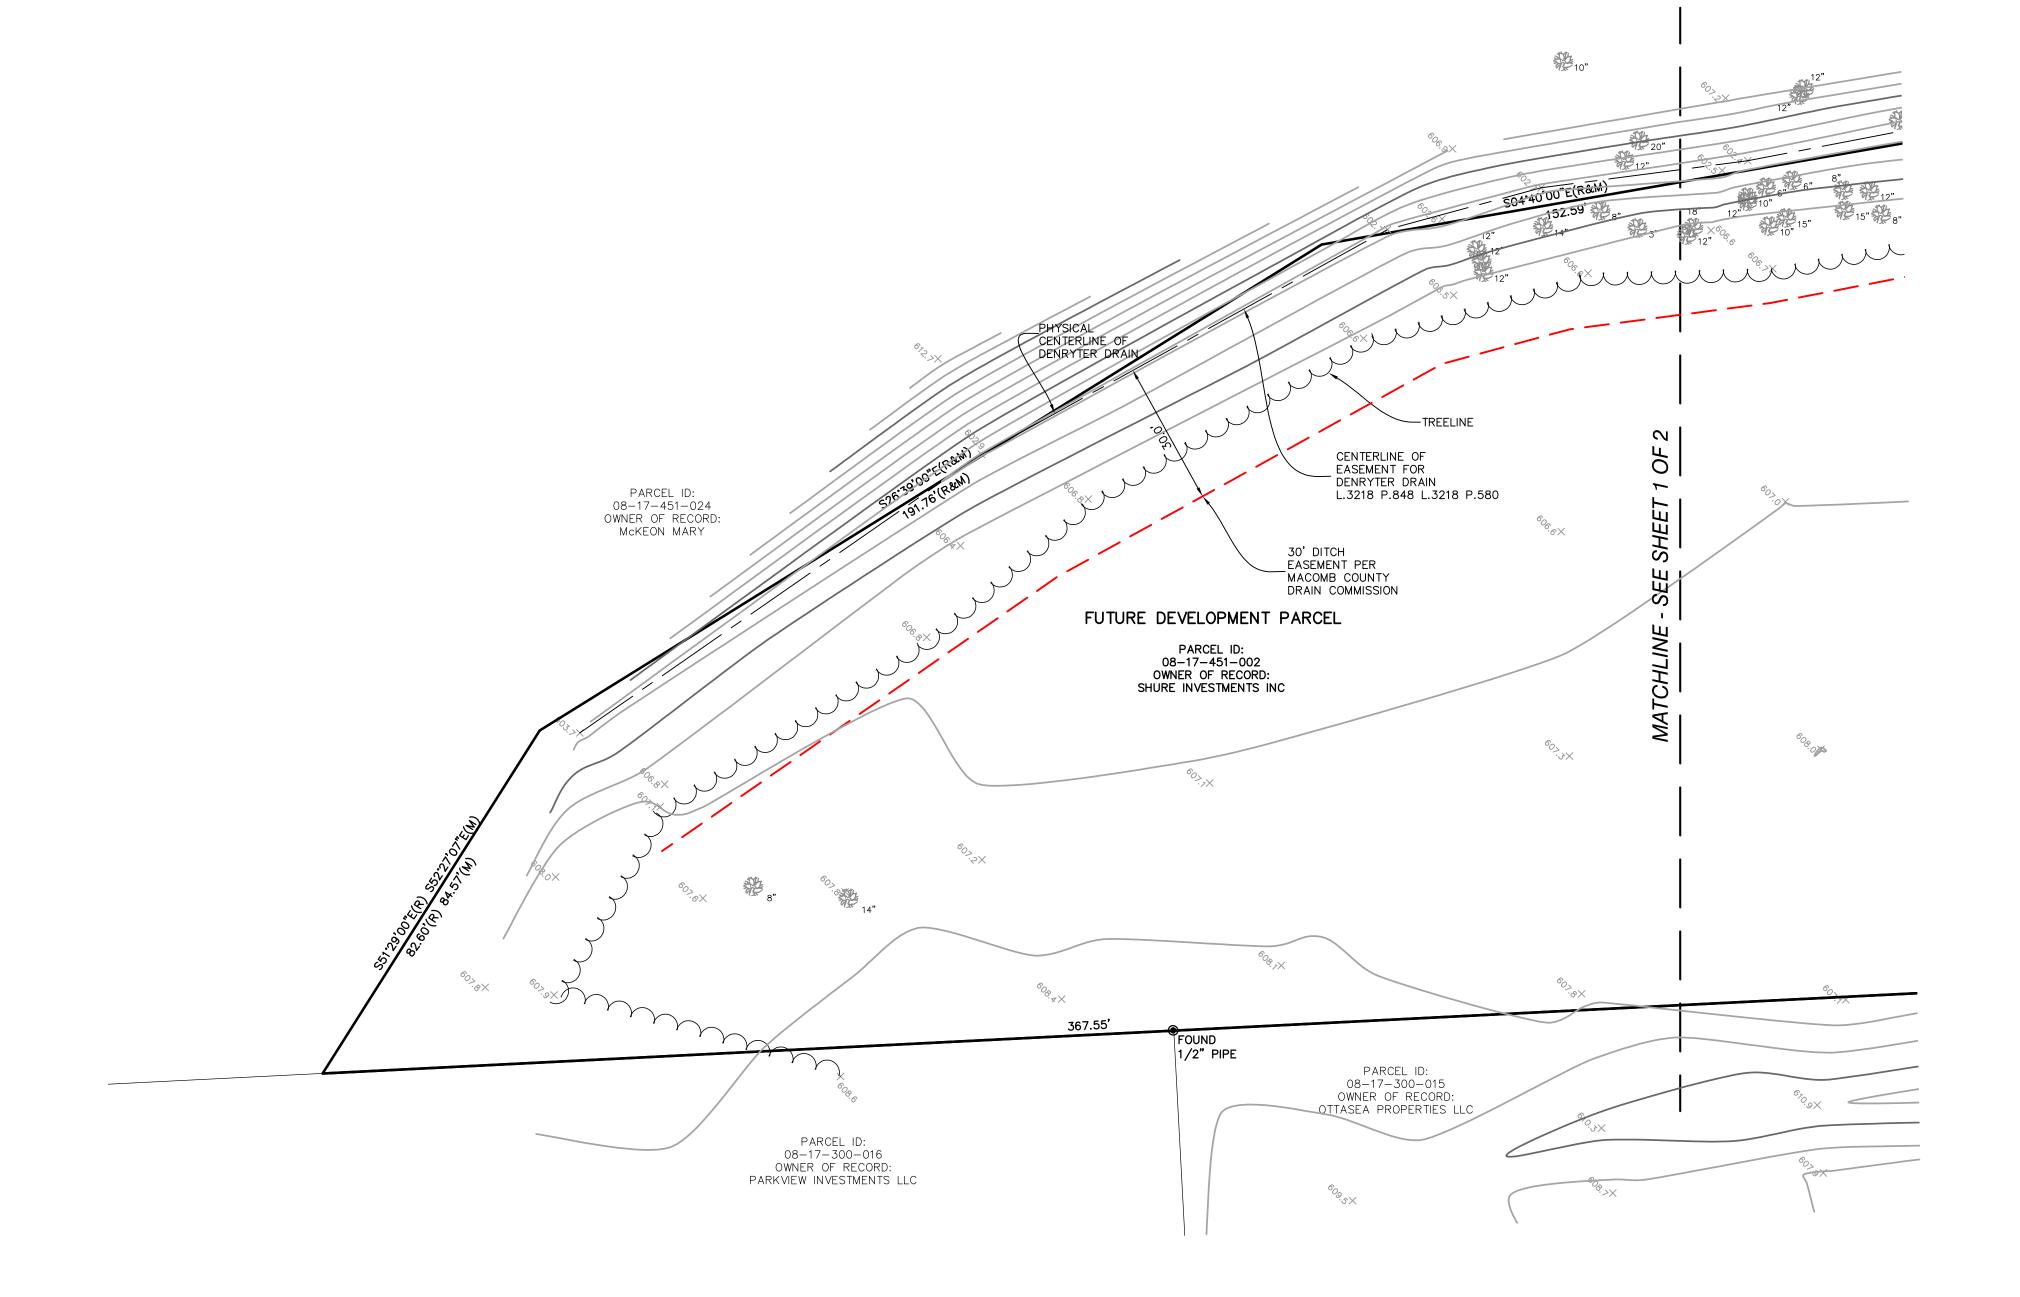

LE	GEI	ND

<u>LEGEND</u>			
•	FOUND MONUMENT (AS NOTED)		EASEMENT (AS NOTED)
①	FOUND SECTION CORNER (AS NOTED)		EASEMENT CENTERLINE
(R&M)	RECORD AND MEASURED DIMENSION		RIGHT-OF-WAY
(R)	RECORD DIMENSION		BUILDING
(M)	MEASURED DIMENSION		CONCRETE CURB
× ^{0.00}	GROUND ELEVATION		EDGE OF CONCRETE (CONC.)
0	UTILITY POLE		EDGE OF ASPHALT (ASPH.)
	GAS METER	~~~~~~~~~~~~~~~~~~~~~~~~~~~~~~~~~~~~~~	TREE / BRUSH LINE (AS NOTED)
S	SANITARY MANHOLE		OVERHEAD UTILITY LINE
\oplus	ROUND CATCH BASIN	G	GAS LINE
Ħ	SQUARE CATCH BASIN	s	SANITARY LINE
0	STORM DRAIN MANHOLE	D	STORM LINE
$\ddot{\mathbb{Z}}$	FIRE HYDRANT	w	WATER LINE
X ® X	WATER GATE MANHOLE		UNDERGROUND PIPE (AS NOTED)
₩V	WATER VALVE		MINOR CONTOUR LINE
-	SOIL BORING		MAJOR CONTOUR LINE
**	DECIDUOUS TREE (AS NOTED)		BUILDING AREA
*	CONIFEROUS TREE (AS NOTED)		
	PARCEL BOUNDARY LINE		ASPHALT
	ADJOINER PARCEL LINE		
	SECTION LINE	4 4 4	CONCRETE

	REVISED PER REVIEW COMMENTS	ADD HIGH WATER MARK ELEVATION	FRITED STEPSONS SEPTIES	EDITED SONVETON S CENTIFICATION	ADDED SPLIT AND ADDITIONAL TREES	ADDITIONAL TOPO	DESCRIPTION	
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	07/26/22	07/12/22	06/36/30	77/07/00	01/26/22	11/24/21	DATE	
	5	4	2	า	2	1	REVISION	
10 /28 /21	10/20/21	10/28/21			2021	SCALE:	1'' = 20'	
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BY:	- [. BY:				, NO,		

2 OF 2 SHEETS

DEMOLITION NOTES

- CONTRACTOR SHALL OBTAIN ALL REQUIRED PERMITS PRIOR TO ANY DEMOLITION PROCESS. CERTAIN ACTIVITIES ASSOCIATED WITH CONSTRUCTION WILL REQUIRE AIR PERMITS INCLUDING BUT NOT LIMITED TO: MOBILE CONCRETE BATCH PLANTS, MOBILE ASPHALT PLANTS, CONCRETE CRUSHERS, LARGE GENERATORS. ETC. THESE ACTIVITIES WILL REQUIRE SPECIFIC CURRENT STATE'S EPA OR LOCAL GOVERNING AUTHORITIES AIR PERMITS FOR INSTALLATION AND OPERATION. CONTRACTORS MUST SEEK AUTHORIZATION FROM THE CORRESPONDING GOVERNING BODIES. FOR DEMOLITION OF ALL COMMERCIAL SITES, A NOTIFICATION FOR RESTORATION AND DEMOLITION MUST BE SUBMITTED TO THE CURRENT STATE'S EPA AND LOCAL GOVERNING AUTHORITIES TO DETERMINE ANY CORRECTIVE ACTIONS THAT MAY BE REQUIRED.
- 2. DEMOLITION INCLUDES THE FOLLOWING:

SITE UTILITIES IN PLACE (WHICHEVER IS APPLICABLE).

- 2.A. TRANSFER BENCHMARK CONTROL TO NEW LOCATIONS OUTSIDE THE DISTURBED AREA PRIOR TO COMMENCING DEMOLITION OPERATIONS (WHEN APPLICABLE).
- 2.B. DEMOLITION AND REMOVAL OF SITE IMPROVEMENTS NECESSARY FOR THE PROPOSED
- CONSTRUCTION OF NEW IMPROVEMENTS. 2.C. REROUTING, RELOCATING, DISCONNECTING, CAPPING OR SEALING, AND ABANDONING/REMOVING
- 3. REMOVE AND LEGALLY DISPOSE OF ITEMS CALLED OUT TO BE REMOVED. REMOVE AND TRANSPORT DEBRIS IN A MANNER THAT WILL PREVENT SPILLAGE ON ADJACENT SURFACES AND AREAS. THOSE ITEMS INDICATED TO BE REINSTALLED, SALVAGED, OR TO REMAIN SHALL BE CLEANED, SERVICED, AND OTHERWISE PREPARED FOR REUSE. CONTRACTOR TO STORE AND PROTECT AGAINST DAMAGE. REINSTALL ITEMS IN LOCATIONS INDICATED.
- . PROTECT ITEMS INDICATED TO REMAIN AGAINST DAMAGE AND SOILING THROUGHOUT CONSTRUCTION, WHEN PERMITTED BY THE CONSTRUCTION MANAGER OR OWNER, ITEMS MAY BE REMOVED TO A SUITABLE, PROTECTED STORAGE LOCATION THROUGHOUT CONSTRUCTION AND THEN CLEANED AND REINSTALLED IN THEIR ORIGINAL LOCATIONS. PROMPTLY REPAIR DAMAGES TO ADJACENT FACILITIES CAUSED BY DEMOLITION OPERATIONS AT THE CONTRACTORS COST.
- 5. CONTRACTOR SHALL SCHEDULE DEMOLITION ACTIVITIES WITH THE CONSTRUCTION/PROJECT MANAGER INCLUDING THE FOLLOWING:
- 5.A. DETAILED SEQUENCE OF DEMOLITION AND REMOVAL WORK, WITH STARTING AND ENDING DATES FOR EACH ACTIVITY.
- 5.B. DATES FOR SHUTOFF, CAPPING, AND CONTINUATION OF UTILITY SERVICES.
- 5.C. IDENTIFY AND ACCURATELY LOCATE UTILITIES AND OTHER SUBSURFACE STRUCTURAL, ELECTRICAL,
- OR MECHANICAL CONDITIONS. REGULATORY REQUIREMENTS: COMPLY WITH GOVERNING EPA NOTIFICATION REGULATIONS
- BEFORE STARTING DEMOLITION. COMPLY WITH HAULING AND DISPOSAL REGULATIONS OF AUTHORITIES HAVING JURISDICTION
- MAINTAIN EXISTING UTILITIES INDICATED TO REMAIN IN SERVICE AND PROTECT THEM AGAINST DAMAGE THROUGHOUT CONSTRUCTION OPERATIONS.
- 7.A. DO NOT INTERRUPT EXISTING UTILITIES SERVING OCCUPIED OR OPERATING FACILITIES, EXCEPT WHEN AUTHORIZED IN WRITING BY OWNER'S REPRESENTATIVE AND AUTHORITIES HAVING JURISDICTION. PROVIDE TEMPORARY SERVICES DURING INTERRUPTIONS TO EXISTING UTILITIES, AS ACCEPTABLE TO OWNER AND TO GOVERNING AUTHORITIES.
- 8. LOCATE, IDENTIFY, DISCONNECT, AND SEAL OR CAP OFF INDICATED UTILITY SERVICES SERVING THE SITE. ARRANGE TO SHUT OFF AND CAP UTILITIES WITH UTILITY COMPANIES AND FOLLOW THEIR RESPECTIVE UTILITY KILL AND CAP POLICIES. DO NOT START DEMOLITION WORK UNTIL UTILITY DISCONNECTING AND SEALING HAVE BEEN COMPLETED AND VERIFIED IN WRITING BY THE UTILITY COMPANY
- 9. CONDUCT DEMOLITION OPERATIONS TO PREVENT INJURY TO PEOPLE AND DAMAGE TO ADJACENT BUILDINGS AND FACILITIES TO REMAIN. ENSURE SAFE PASSAGE OF PEOPLE AROUND DEMOLITION AREA. SAFE PASSAGE INCLUDES THE ERECTION OF TEMPORARY PROTECTION AND/OR BARRICADES AS PER LOCAL GOVERNING AUTHORITIES AND IN ACCORDANCE WITH THE CURRENT ADA REGULATIONS. USE OF EXPLOSIVES WILL NOT BE PERMITTED.
- 10. CLEAN ADJACENT BUILDINGS AND IMPROVEMENT OF DUST, DIRT, AND DEBRIS CAUSED BY DEMOLITION OPERATIONS. RETURN ADJACENT AREAS TO CONDITION EXISTING BEFORE START OF DEMOLITION.
- 1. PROMPTLY DISPOSE OF DEMOLISHED MATERIALS. DO NOT ALLOW DEMOLISHED MATERIALS TO ACCUMULATE ON-SITE. STORAGE OR SALE OF REMOVED ITEMS OR MATERIALS ON-SITE WILL NOT BE PERMITTED. NO BURNING OF ANY MATERIALS ON SITE SHALL BE PERMITTED.
- 12. IT IS NOT EXPECTED THAT ASBESTOS WILL BE ENCOUNTERED IN THE COURSE OF THIS CONTRACT. IF ANY MATERIALS SUSPECTED OF CONTAINING ASBESTOS ARE ENCOUNTERED, DO NOT DISTURB THE MATERIALS, IMMEDIATELY NOTIFY THE CONSTRUCTION MANAGER AND THE OWNER.
- 13. SURVEY THE CONDITION OF THE STRUCTURE TO DETERMINE WHETHER REMOVING ANY ELEMENT MIGHT RESULT IN A STRUCTURAL DEFICIENCY OR UNPLANNED COLLAPSE OF ANY PORTION OF THE
- 14. DEMOLISH BUILDING AND STRUCTURAL PADS COMPLETELY AND REMOVE FROM THE SITE. USE METHODS REQUIRED TO COMPLETE WORK WITHIN LIMITATIONS OF GOVERNING REGULATIONS AND AS
- 14.A. DISPOSE OF DEMOLISHED ITEMS AND MATERIALS PROMPTLY.

STRUCTURE OR ADJACENT STRUCTURES THROUGHOUT CONSTRUCTION.

- 14.B. DEMOLISH CONCRETE AND MASONRY IN SMALL SECTIONS. 14.C. BREAK UP AND REMOVE CONCRETE SLABS ON GRADE.
- 15. BELOW-GRADE DEMOLITION: DEMOLISH FOUNDATION WALLS. PAVEMENTS. AND OTHER BELOW-GRADE DEMOLITION, AS FOLLOWS:
- 15.A. COMPLETELY REMOVE BELOW-GRADE DEMOLITION. INCLUDING FOUNDATION WALLS FOOTINGS KNOWN AND UNKNOWN PAVEMENT SECTIONS INCLUDING UNDERLYING CONCRETE SLABS, AND OTHER BELOW GRADE CONCRETE SLABS FOUND DURING DEMOLITION (INCLUDING ITEMS WHICH MAY NOT BE IDENTIFIED HEREIN).
- 16. FILLING BELOW-GRADE AREAS: COMPLETELY FILL BELOW-GRADE AREAS AND VOIDS RESULTING FROM DEMOLITION OF BUILDINGS, PAVEMENTS, AND OTHER REMOVED ITEMS WITH SOIL MATERIALS ACCORDING TO REQUIREMENTS PER SOILS REPORT AND ON-SITE GEOTECHNICAL ENGINEER'S REPRESENTATIVE. CONTRACTOR SHALL CONTACT GEOTECHNICAL ENGINEER PRIOR TO FILLING ANY AREAS TO OBSERVE FILL PROCEDURES.
- 17. CONDUCT DEMOLITION OPERATIONS AND REMOVE DEBRIS TO ENSURE MINIMUM INTERFERENCE WITH ROADS, STREETS, WALKS, AND OTHER ADJACENT OCCUPIED AND USED FACILITIES. DO NOT CLOSE OR OBSTRUCT STREETS, WALKS, OR OTHER ADJACENT OCCUPIED OR USED FACILITIES WITHOUT PERMISSION FROM OWNER AND AUTHORITIES HAVING JURISDICTION. PROVIDE ALTERNATE ROUTES AROUND CLOSED OR OBSTRUCTED TRAFFIC WAYS IF REQUIRED BY GOVERNING REGULATIONS.
- 18. CONTRACTOR TO WET SAWCUT EXISTING PAVEMENT TO REMAIN AT NEXT NEAREST JOINT PRIOR TO REMOVALS OF CURB, GUTTER, PAVEMENT, ETC.
- 19. THE CONTRACTOR SHALL REMOVE EXISTING PAVEMENT MARKINGS WITH SMALL HANDHELD GRINDERS OR SCARIFIERS OR OTHER METHODS, WITH THE APPROVAL OF THE CONSTRUCTION MANAGER. TAKE CARE DURING MARKING REMOVAL NOT TO SCAR, DISCOLOR, OR OTHERWISE DAMAGE THE PAVEMENT SURFACE. DO NOT OVERPAINT OR USE OTHER METHODS OF COVERING MARKINGS INSTEAD OF
- 20. IF UNDERGROUND TANKAGE IS CALLED FOR DEMOLITION, THE CONTRACTOR SHALL COORDINATE REMOVAL AND REPLACEMENT WITH THE STATE BUREAU OF UNDERGROUND STORAGE TANK REGULATIONS (BUSTR). UNDERGROUND TANK REMOVAL SHALL ALSO INCLUDE THE REMOVAL OF ANY MONITORING WELLS, OIL/GAS WELLS, AND MINE SHAFTS, IN ACCORDANCE WITH GOVERNING AUTHORITIES HAVING JURISDICTION.
- 21. CONTRACTOR SHALL FULLY SECURE WORK AREA WITH THE APPROPRIATE SIGNAGE, FENCING, AND BARRICADES WHICH ACCOMMODATE VISUALLY IMPAIRED PERSONS AS AGREED UPON WITH SITE CONSTRUCTION/PROJECT MANAGER AND OWNER TO WARN AND KEEP PEOPLE OUT OF THE SITE WORK AREA FOR THE DURATION OF THE PROJECT.

GENERAL PLAN AND SURVEY NOTES

- 1. PRIOR TO STARTING CONSTRUCTION THE CONTRACTOR SHALL BE RESPONSIBLE FOR MAKING SURE THAT ALL REQUIRED PERMITS AND APPROVALS HAVE BEEN OBTAINED. NO CONSTRUCTION OR FABRICATION SHALL BEGIN UNTIL THE CONTRACTOR HAS RECEIVED AND THOROUGHLY REVIEWED ALL PLANS AND OTHER DOCUMENTS APPROVED BY ALL OF THE PERMITTING AUTHORITIES.
- 2. THE CONTRACTOR'S ATTENTION IS DIRECTED TO THE SECTION OF THESE NOTES ENTITLED "GRADING PLAN NOTES" FOR DEFINITIONS AS MAY BE NECESSARY FOR "GEOTECHNICAL ENGINEER" AND "SOILS REPORT".
- 3. ALL WORK SHALL BE PERFORMED IN ACCORDANCE WITH THESE PLANS, SPECIFICATIONS AND THE REQUIREMENTS AND STANDARDS OF THE LOCAL GOVERNING AUTHORITY. THE SOILS REPORT AND RECOMMENDATIONS SET FORTH THEREIN ARE A PART OF THE REQUIRED CONSTRUCTION DOCUMENTS AND TAKE PRECEDENCE UNLESS SPECIFICALLY NOTED OTHERWISE ON THE PLANS, THE CONTRACTOR SHALL NOTIFY THE CONSTRUCTION/PROJECT MANAGER OF ANY DISCREPANCY BETWEEN SOILS REPORT AND PLANS, ETC.
- 4. THE CONTRACTOR SHALL, UPON BECOMING AWARE OF SUBSURFACE OR LATENT PHYSICAL CONDITIONS DIFFERING FROM THOSE DISCLOSED BY THE ORIGINAL SOIL EXPLORATION WORK, PROMPTLY NOTIFY THE OWNER VERBALLY TO PERMIT VERIFICATION OF THE CONDITIONS AND IN WRITING, AS TO THE NATURE OF THE DIFFERING CONDITIONS. NO CLAIM BY THE CONTRACTOR FOR ANY CONDITIONS DIFFERING FROM THOSE ANTICIPATED IN THE PLAN AND SPECIFICATIONS AND DISCLOSED BY THE SOIL STUDIES WILL BE ALLOWED UNLESS THE CONTRACTOR HAS SO NOTIFIED THE OWNER, VERBALLY AND IN WRITING AS REQUIRED ABOVE, OF SUCH DIFFERING CONDITIONS.
- 5. ALL WORK WITHIN THE RIGHTS OF WAY SHALL BE IN ACCORDANCE WITH THE GOVERNING JURISDICTION AND SPECIFICATIONS.
- 6. CONTRACTOR SHALL COORDINATE ANY MAINTENANCE OF TRAFFIC WITH THE OWNER'S REPRESENTATIVE AND THE LOCAL JURISDICTION PRIOR TO CONSTRUCTION.
- 7. CONTRACTOR SHALL AT ALL TIMES ENSURE THAT SWPP MEASURES PROTECTING EXISTING DRAINAGE FACILITIES BE IN PLACE PRIOR TO THE COMMENCEMENT OF ANY PHASE OF THE SITE CONSTRUCTION OR LAND ALTERATION. (SEE SWPP PLANS).
- 8. ALL WORK SHALL BE COMPLETED IN A NEAT AND ORDERLY MANNER REMOVING ALL EXCESS MATERIAL AND WASTE FROM THE SITE INCLUDING TIMELY REMOVAL OF ANY CONCRETE SPLATTER. UPON COMPLETION OF PROJECT, CONTRACTOR SHALL CLEAN THE PAVED AREAS PRIOR TO REMOVAL OF TEMPORARY SEDIMENT CONTROLS, AS DIRECTED BY THE CITY AND/OR CONSTRUCTION/PROJECT MANAGER. IF POWER WASHING IS USED, NO SEDIMENT LADEN WATER SHALL BE WASHED INTO THE STORM SYSTEM. ALL SEDIMENT LADEN MATERIAL ON PAVEMENT OR WITHIN THE STORM SYSTEM SHALL BE COLLECTED AND REMOVED FROM THE SITE AT CONTRACTOR'S EXPENSE (SEE SWPP PLANS).
- 9. THESE PROJECT CONSTRUCTION DOCUMENTS SHALL NOT CONSTITUTE A CONTRACTUAL RELATIONSHIP BETWEEN GPD GROUP: PROFESSIONAL CORPORATION AND THE CONTRACTOR / SUBCONTRACTOR / OR OTHER AFFILIATED PARTIES.
- 10. THE ENGINEER WILL NOT BE RESPONSIBLE FOR CONSTRUCTION OR SAFETY, MEANS, METHODS, TECHNIQUES, SEQUENCES OR PROCEDURES UTILIZED IN CONSTRUCTION BY THE CONTRACTOR OR SUBCONTRACTORS. ANY SEQUENCING OR SUGGESTED NOTATIONS WHICH MAY APPEAR IN THE PLANS IS INTENDED TO ASSIST IN THE UNDERSTANDING OF PROJECT INTENT.
- 11. DETAILS, NOTES, AND OTHER REFERENCES CONTAIN HEREIN MAY HAVE BEEN ATTAINED FROM OUTSIDE REFERENCE SOURCE LOCATIONS SUCH AS, BUT NOT LIMITED TO, LOCAL AUTHORITY AGENCIES, DESIGN REFERENCE MANUALS, MANUFACTURE'S RECOMMENDED DOCUMENTATION, OR OTHER INDUSTRY SOURCES. GPD DOES NOT WARRANT INFORMATION OR REPRESENTATION OF SAID CONTENT CONTAINED HEREIN, IT IS SHOWN SOLELY FOR REFERENCE ONLY OF DESIGN INTENT AT THE TIME OF PLAN PREPARATION. THE CONSTRUCTION TEAM MEMBERS (CONTRACTOR AND CONSTRUCTION MANAGER, WHERE APPLICABLE) SHALL OBTAIN THE MOST CURRENT DETAILED INFORMATION FROM THE RESPECTIVE SOURCE TO CONSTRUCT THE IMPROVEMENTS UNDER THE AUTHORITY OF THE RESPECTIVE GOVERNING AGENCIES. IF ANY DISCREPANCIES ARE DISCOVERED BETWEEN THE ORIGINAL DESIGN INTENT AND THE CONSTRUCTION TEAM OBTAINED REFERENCE MATERIAL. THE CONSTRUCTION MANAGER OR THE PROJECT'S CONTACT PERSON SHALL BE NOTIFIED PRIOR TO COMMENCING OF ASSOCIATED WORK.
- 12. CONDUCT CONSTRUCTION OPERATIONS TO ENSURE MINIMUM INTERFERENCE WITH ROADS. STREETS, WALKS, AND OTHER ADJACENT OCCUPIED AND USED FACILITIES. DO NOT CLOSE OR OBSTRUCT STREETS, WALKS, OR OTHER ADJACENT OCCUPIED OR USED FACILITIES WITHOUT PERMISSION FROM OWNER AND AUTHORITIES HAVING JURISDICTION. PROVIDE ALTERNATE ROUTES AROUND CLOSED OR OBSTRUCTED TRAFFIC WAYS.
- 13. THE A.L.T.A. / NSPS LAND TITLE SURVEY BY KEM-TEC, DATED 10/28/2021 SHALL BE CONSIDERED A PART OF THESE PLANS. THE G.C. IS RESPONSIBLE FOR LOCATING IMPROVEMENTS PER THESE PLANS.
- 14. THE LOCATIONS OF UNDERGROUND FACILITIES SHOWN ON THE PLANS ARE BASED ON THE A.L.T.A. / NSPS LAND TITLE SURVEY. IT SHALL BE THE CONTRACTOR'S FULL RESPONSIBILITY TO BECOME FAMILIAR WITH THE SITE'S POSSIBLE BELOW GRADE FEATURES, INCLUDING BUT NOT LIMITED TO, ROOMS, VAULTS, UTILITIES, ETC. AND SHALL CONDUCT A WALK THROUGH WITH THE OWNER'S REPRESENTATIVE. CONTRACTOR SHALL CONTACT THE VARIOUS UTILITY COMPANIES TO LOCATE THEIR FACILITIES PRIOR TO STARTING CONSTRUCTION. NO ADDITIONAL COMPENSATION SHALL BE PAID TO THE CONTRACTOR FOR REPAIR TO DAMAGE CAUSED BY THEIR WORK FORCE TO FACILITIES WHICH ARE NOT INTENDED TO BE DISTURBED
- 15. ALL DIMENSIONS, GRADES, AND UTILITY LOCATIONS SHOWN ON THESE PLANS WERE BASED ON THE SURVEY. THE CONTRACTOR SHALL FIELD VERIFY ALL EXISTING CONDITIONS PRIOR TO CONSTRUCTION. CONTRACTOR SHALL NOTIFY CONSTRUCTION/PROJECT MANAGER IF ANY DISCREPANCIES EXIST PRIOR TO PROCEEDING WITH CONSTRUCTION FOR NECESSARY CHANGES. NO EXTRA COMPENSATION SHALL BE PAID TO THE CONTRACTOR FOR WORK HAVING TO BE REDONE DUE TO INFORMATION SHOWN INCORRECTLY ON THESE PLANS IF SUCH NOTIFICATION HAS NOT BEEN GIVEN.
- 16. IN SOME CASES, THE DEVELOPER OR OWNER MAY HAVE PROVIDED THEIR OVERALL DEVELOPMENT PLANS FOR THE PROJECT DESIGN RATHER THAN A FIELD SURVEY. (SEE SITE PLAN FOR NOTES WHEN THIS IS THE CASE), ALL DIMENSIONS, GRADES, AND UTILITY LOCATIONS SHOWN ON THESE PLANS WERE BASED ON AN ALTA SURVEY. THE CONTRACTOR SHALL FIELD VERIFY ALL EXISTING CONDITIONS PRIOR TO CONSTRUCTION. CONTRACTOR SHALL NOTIFY CONSTRUCTION MANAGER IF ANY DISCREPANCIES EXIST PRIOR TO PROCEEDING WITH CONSTRUCTION FOR NECESSARY CHANGES. NO EXTRA COMPENSATION SHALL BE PAID TO THE CONTRACTOR FOR WORK HAVING TO BE REDONE DUE TO INFORMATION SHOWN INCORRECTLY ON THESE PLANS IF SUCH NOTIFICATION HAS NOT BEEN GIVEN.
- 17. THE CONTRACTOR SHALL RUN AN INDEPENDENT VERTICAL CONTROL TRAVERSE TO CHECK BENCHMARKS AND A HORIZONTAL CONTROL TRAVERSE THROUGH THE REFERENCED PROJECT CONTROL DATUM TO CONFIRM GEOMETRIC DATA. IT IS THE CONTRACTORS RESPONSIBILITY TO NOTIFY THE CONSTRUCTION MANAGER OF ANY DISCREPANCIES PRIOR TO THE START OF CONSTRUCTION.

GRADING PLAN NOTES 🔬

- 1. A GEOTECHNICAL REPORT HAS BEEN PREPARED BY PSI, DATED 11/10/2021 AND SHALL BE CONSIDERED TO BE A PART OF THIS PLAN SET.
- 2. BEFORE STARTING GRADING OPERATIONS, SEE STORMWATER POLLUTION PREVENTION PLAN, NOTES AND DETAILS (SWPPP) LANDSCAPE PLAN AND SOILS REPORT FOR TREATMENT OF EXISTING GRADE.
- 3. PRIOR TO SITE CONSTRUCTION ACTIVITY, THE CONTRACTOR SHALL INSTALL ALL SWPPP SWPP MEASURES TO PROTECT EXISTING DRAINAGE FACILITIES. CONTRACTOR SHALL PREVENT SILTATION FROM LEAVING THE SITE AT ALL TIMES.
- 4. STRIP BUILDING AND PAVEMENT AREAS OF ALL ORGANIC TOPSOILS. STOCKPILE SUITABLE TOPSOILS FOR RESPREADING ONTO LANDSCAPE AREAS. ALL EXCESS EXCAVATED MATERIALS SHALL BE REMOVED FROM THE SITE AT THE CONTRACTOR'S EXPENSE. SEE GEOTECHNICAL REPORT FOR STRIPPING AND TOPSOIL REQUIREMENTS.
- 5. OBTAIN APPROVED BORROW SOIL MATERIALS OFF-SITE WHEN SUFFICIENT SATISFACTORY SOIL MATERIALS ARE NOT AVAILABLE ON-SITE.
- 6. SITE GRADING SHALL BE PERFORMED IN ACCORDANCE WITH THESE PLANS AND SPECIFICATIONS AND THE RECOMMENDATIONS SET FORTH IN THE GEOTECHNICAL REPORT. THE CONTRACTOR SHALL BE RESPONSIBLE FOR REMOVING ALL SOFT, YIELDING OR UNSUITABLE MATERIALS AND REPLACING WITH SUITABLE MATERIALS AS SPECIFIED IN THE GEOTECHNICAL REPORT. UNLESS OTHERWISE SPECIFIED IN THE PLANS, SPECIFICATIONS, OR GEOTECHNICAL REPORT THE SITE GRADING, EXCAVATION, AND EMBANKMENT SHALL BE IN ACCORDANCE WITH THE STATE DEPARTMENT OF TRANSPORTATION CONSTRUCTION AND MATERIAL SPECIFICATIONS. SITE SHALL BE GRADED AND LAND BALANCED.
- 7. AT A MINIMUM ALL EXCAVATED OR FILLED AREAS SHALL BE COMPACTED TO 95% OF STANDARD PROCTOR MAXIMUM DRY DENSITY PER A.S.T.M. TEST D-698. MOISTURE CONTENT AT TIME OF PLACEMENT SHALL NOT EXCEED 2% ABOVE NOR 2% BELOW OPTIMUM. THE CONTRACTOR SHALL FOLLOW THE RECOMMENDATIONS OF THE GEOTECHNICAL REPORT AND RETAIN A QUALIFIED SOILS ENGINEER REGISTERED WITHIN THE STATE TO ENSURE COMPLIANCE WITH THE GEOTECHNICAL REPORT, MAKE GEOTECHNICAL RECOMMENDATIONS BASED ON FIELD CONDITIONS, AND ENSURE THAT ALL SHORING AND DEWATERING MEANS AND METHODS WILL NOT COMPROMISE THE STABILITY OF EXISTING OR PROPOSED FOOTINGS/FOUNDATIONS. THE OWNER SHALL RECEIVE ALL COMPACTION REPORTS PREPARED BY THE CONTRACTOR'S GEOTECHNICAL ENGINEER, VERIFYING THAT ALL FILLED AREAS AND SUBGRADE AREAS WITHIN THE BUILDING PAD AREA AND AREAS TO BE PAVED HAVE BEEN COMPACTED IN ACCORDANCE WITH THESE PLANS AND SPECIFICATIONS AND THE RECOMMENDATIONS SET FORTH IN THE GEOTECHNICAL REPORT. NOTIFY PROJECT CONSTRUCTION MANAGER IF ANY UNSUITABLE SOILS ARE FOUND.
- 8. FOLLOWING GRADING OF SUBSOIL TO SUBGRADE ELEVATIONS THE CONTRACTOR SHALL PLACE TOPSOIL TO A 6" DEPTH (UNLESS OTHERWISE SPECIFIED IN LANDSCAPING DETAILS) IN ALL DISTURBED AREAS WHICH ARE NOT TO BE PAVED. SMOOTHLY FINISH GRADE TO MEET SURROUNDING LAWN AREAS AND ENSURE POSITIVE DRAINAGE. STOCKPILED TOPSOIL SHALL BE SCREENED PRIOR TO RESPREADING. TOPSOIL SHALL BE FREE OF SUBSOIL, DEBRIS, BRUSH AND STONES LARGER THAN 1" IN ANY DIMENSION. ROCK HOUNDING IN PLACE WILL NOT BE PERMITTED. ALL EXCESS TOPSOIL SHALL BE LEGALLY DISPOSED OF OFF SITE.
- 9. ELEVATIONS GIVEN ARE AT BOTTOM FACE OF CURB AND/OR FINISHED PAVEMENT GRADE UNLESS OTHERWISE SPECIFIED ON GRADING PLAN. ALL PAVEMENT SHALL BE LAID ON A STRAIGHT, EVEN, AND UNIFORM GRADE WITH A MINIMUM OF 1% SLOPE TOWARD THE COLLECTION POINTS UNLESS OTHERWISE SPECIFIED ON THE GRADING PLAN. DO NOT ALLOW NEGATIVE GRADES OR PONDING OF WATER.
- 10. SLOPE BUILDING SIDEWALK AWAY FROM THE BUILDING AT A MAXIMUM OF 1.5% (UNLESS OTHERWISE INDICATED ON THE GRADING PLAN).
- 11. WHEN CONSTRUCTING ASPHALTIC CONCRETE PAVEMENTS, CONTRACTOR SHALL PROVIDE BUTT END JOINT TO MEET EXISTING PAVEMENT IN ELEVATION AT DRIVE RETURNS AND ENSURE POSITIVE DRAINAGE.

GENERAL UTILITY NOTES

- 1. CONTRACTOR SHALL CONTACT ALL UTILITY COMPANIES IMMEDIATELY AFTER BID IS AWARDED AND ENSURE THE UTILITY COMPANIES HAVE THE ESSENTIALS REQUIRED FOR COMPLETE SERVICE INSTALLATION. CONTRACTOR SHALL NOTIFY CONSTRUCTION MANAGER OF ANY TIME FRAMES ESTABLISHED BY UTILITY COMPANIES WHICH WILL NOT MEET OPENING DATE.
- 2. CONTRACTOR SHALL VERIFY THE SIZE, LOCATION, INVERT ELEVATION, AND CONDITION OF EXISTING UTILITIES WHICH ARE INTENDED TO BE UTILIZED AS A CONNECTION POINT FOR ALL PROPOSED UTILITIES PRIOR TO ANY CONSTRUCTION. CONTRACTOR TO ENSURE EXISTING UTILITIES ARE IN GOOD CONDITION AND FREE FLOWING (IF APPLICABLE). IF ELEVATIONS, SIZE, OR LOCATION DIFFER FROM WHAT IS SHOWN ON PLANS, CONTRACTOR SHALL NOTIFY CONSTRUCTION MANAGER IMMEDIATELY.
- 3. WHERE PLANS PROVIDE FOR PROPOSED WORK TO BE CONNECTED TO, OR CROSS OVER AN EXISTING SEWER OR UNDERGROUND UTILITY, THE CONTRACTOR SHALL LOCATE THE EXISTING PIPES OR UTILITIES BOTH AS TO LINE AND GRADE BEFORE STARTING THE PROPOSED WORK. IF IT IS DETERMINED THAT THE ELEVATION OF THE EXISTING CONDUIT, OR EXISTING APPURTENANCE RESULTS IN A CHANGE IN THE PLAN, THE CONSTRUCTION MANAGER SHALL BE NOTIFIED BEFORE STARTING CONSTRUCTION OF ANY PORTION OF THE PROPOSED WORK WHICH WOULD BE AFFECTED BY THE INTERFERENCE WITH AN EXISTING FACILITY. PAYMENT FOR ALL THE OPERATIONS DESCRIBED ABOVE SHALL BE INCLUDED IN THE CONTRACT PRICE FOR THE PERTINENT ITEM.
- 4. UTILITY SERVICE PROVIDERS RULES AND REQUIREMENTS TAKE PRECEDENCE OVER INFORMATION HEREIN. IF DISCREPANCY ARISES, CONTRACTOR SHALL FULLY COORDINATE WITH UTILITY SERVICE PROVIDER PRIOR TO START OF CONSTRUCTION.

SANITARY SEWER NOTES

- 1. SANITARY SEWER LATERAL INVERT AT BUILDING SHALL BE A MINIMUM OF 5.0' BELOW FINISH
- 2. CLEAN-OUTS TO BE INSTALLED AT ALL PIPE BENDS AND ANGLES, UNLESS A MANHOLE IS INDICATED.
- 3. THE CONTRACTOR SHALL HIRE A LOCAL PLUMBER LICENSED WITH THE LOCAL SANITARY JURISDICTION TO MAKE ALL CONNECTIONS FROM THE BUILDING TO THE EXISTING SEWER. CONTRACTOR SHALL SECURE A SANITARY SEWER CONNECTION PERMIT PRIOR TO ANY CONSTRUCTION. THE CONTRACTORS PRICE FOR SANITARY SEWER INSTALLATION SHALL INCLUDE ALL FEES AND APPURTENANCES REQUIRED BY THE LOCAL SANITARY JURISDICTION TO PROVIDE A COMPLETE WORKING SERVICE. COORDINATE ALL WORK WITH KEVIN JOHNSON OF MACOMB TOWNSHIP DEPARTMENT OF PUBLIC WORKS @ 586.598.0687.
- 4. ALL SANITARY PIPE MATERIAL SHALL BE 6" PVC CHEDULD 40 CONFORMING TO ASTM D 1785, WITH GLUED UNLESS OTHERWISE REQUIRED BY THE LOCAL JURISDICTION (OR APPROVED

STORM SEWER NOTES

1. ALL STORM SEWER PIPE 12" OR GREATER IN DIAMETER SHALL BE CORRUGATED HIGH DENSITY POLYETHYLENE (HDPE) SMOOTH INTERIOR PIPE (UNLESS OTHERWISE NOTED ON PLAN). HDPE PIPE SHALL CONFORM TO ASTM D 3350 AND JOINTS PER ASTM F477. STORM SEWER LESS THAN 12" IN DIAMETER SHALL BE PVC SCHEDULE 40 CONFORMING TO ASTM D 1785, WITH GLUED UNLESS OTHERWISE REQUIRED BY THE LOCAL JURISDICTION (OR APPROVED EQUAL).

2. THE CONTRACTOR SHALL BE RESPONSIBLE FOR ALL TRENCHING, BACKFILLING AND PIPE INSTALLATION, PIPE MATERIAL AND TAP CONNECTION, COORDINATE ALL WORK WITH DARYL GAPSHES @ 586-469-5343 @ MACOMB COUNTY DRAIN COMMISSION (PUBLIC WORKS).

<u>WATER NOTES</u> WATER SERVICE MATERIALS SHALL BE HDPE SDR 9. DIAMETER SHALL BE AS NOTED ON THESE PLANS AND SHALL BE INSTALLED WITH A MINIMUM COVER OF 5.0' OR BELOW FROST LINE, WHICHEVER IS GREATER.

2 MATERIALS PROVIDED BY THE WATER COMPANY: a. FURNISH WATER METER.

- COORDINATE ALL WORK WITH KEVIN JOHNSON OF MACOMB TOWNSHIP DEPARTMENT OF PUBLIC WORKS @ 586.598.0687.
- CONSTRUCTION AND MATERIALS PROVIDED BY THE CONTRACTOR: TAP SERVICE LINE AND INSTALL SERVICE LINE FROM TAP TO BUILDING.
- . INSTALL CURB STOP.
- ALL TRENCHING AND BACKFILLING. d. INSTALLING METER.

CURB INSTALLATION.

4. CONTRACTOR SHALL PROVIDE 100% IRRIGATION PER CONSTRUCTION/PROJECT MANAGER AND TOWNSHIP REQUIREMENTS. COORDINATE SLEEVE LOCATIONS WITH THE CONSTRUCTION/PROJECT MANAGER AND IRRIGATION CONSULTANT PRIOR TO PAVEMENT AND



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DATE	REMARKS				
3/8/22	Planning Comments				
3/21/22	Planning Comments				
4/21/22	Issued for Permit				
6/30/22	Macomb SESC Comments				
7/29/22	Macomb Township Comments				
	3/21/22 4/21/22 6/30/22				

CONTRACT DATE: 11.15.21 BUILDING TYPE: END. MED20 PLAN VERSION: MARCH 2021 **BRAND DESIGNER:** DICKSON SITE NUMBER: 315390 STORE NUMBER: 457226 PA/PM: DRAWN BY.

TACO BELL

2021088.48

JOB NO.:

17669 23 Mile Road Macomb, MI 48042



ENDEAVOR 2.0

GENERAL

GENERAL NOTES

- 1. ALL WORK SPECIFIED AS A DEPARTMENT OF TRANSPORTATION ITEM SHALL BE GOVERNED BY THE MICHIGAN DEPARTMENT OF TRANSPORTATION CONSTRUCTION AND MATERIAL SPECIFICATIONS AS WELL AS THE CURRENT EDITION OF THE LOCAL JURISDICTION STORM WATER MANAGEMENT MANUAL. IT IS THE CONTRACTOR'S RESPONSIBILITY TO POSSESS AND TO BE FAMILIAR WITH APPLICABLE SECTIONS.
- 2. THESE CONTRACT DRAWINGS SHALL BE MADE AVAILABLE ON SITE AT ALL TIMES AND PRESENTED UPON REQUEST. IF UNFORESEEN STORM WATER POLLUTION IS ENCOUNTERED, ADDITIONAL STORM WATER POLLUTION PREVENTION (SWPP) MEASURES SHALL BE IMPLEMENTED TO MANAGE THE CURRENT SITE CONDITIONS WHICH MAY BE REQUESTED BY THE OWNER, COUNTY ENGINEER, PROJECT ENGINEER OR SOIL AND WATER CONSERVATION SERVICE REPRESENTATIVE AT ANYTIME. SUCH REQUESTS AND CHANGE IN SITE CONDITIONS SHALL BE IMPLEMENTED IMMEDIATELY AT CONTRACTOR'S EXPENSE.
- 3. ALL STORM WATER POLLUTION PREVENTION PLAN (SWPPP) PRACTICES SHALL BE INSTALLED BEFORE ANY OTHER EARTH MOVING OCCURS.
- 4. SEDIMENT BARRIERS SHALL BE INSTALLED DOWNSLOPE OF DISTURBED AREAS. SEDIMENT BARRIERS SHALL BE INSTALLED ALONG LEVEL CONTOURS. MAXIMUM CONTRIBUTING DRAINAGE AREA TO SEDIMENT BARRIERS SHALL BE PER THE CURRENT STATE'S EPA OR THE LOCAL AUTHORITY REQUIREMENTS. COMPOSITE FILTER SOCKS USED IN LIEU OF SILT FENCE SHALL BE A MINIMUM OF 12 INCHES IN DIAMETER.
- 5. SILT BARRIERS SHALL BE INSTALLED AROUND ALL EXISTING AND NEW STORM INLETS, CATCH BASINS AND YARD DRAINS. INSTALL ROCK CHECK DAMS FOR HEADWALL INLETS FOR STORM WATER POLLUTION PREVENTION.
- 6. STORM WATER POLLUTION PREVENTION MEASURES SHALL BE INSTALLED AROUND ALL DIRT OR TOPSOIL STOCKPILES AND OTHER TEMPORARILY DISTURBED AREAS AS MAY BE SHOWN ON THESE PLANS AND/OR AS DIRECTED BY THE ENGINEER OR THE LOCAL AUTHORITY HAVING JURISDICTION.
- 7. SILT BARRIERS, CONSTRUCTION ENTRANCES, AND SILT PERIMETER CONTROLS SHALL REMAIN IN PLACE UNTIL A GOOD STAND OF GRASS HAS BEEN OBTAINED AND/OR PAVING OPERATIONS ARE COMPLETE. CONTRACTOR SHALL KEEP SILT FROM ENTERING ANY STORM DRAINAGE SYSTEM. ONCE SITE HAS BEEN COMPLETELY STABILIZED, ANY SILT IN PIPES AND DRAINAGE SWALES SHALL BE REMOVED WITHIN 10 DAYS.
- 8. ALL EXISTING WATER COURSES WITHIN THE PROJECT LIMITS SHALL BE TEMPORARILY PROTECTED DURING LAND CLEARING AND GRADING OPERATIONS. SOILS WITHIN 50 FEET OF SAID WATER COURSES SHALL BE STABILIZED WITHIN 2 DAYS OF THE INITIAL CLEARING / GRADING OPERATION.
- 9. CONSTRUCTION ENTRANCE SHALL BE UTILIZED. IF CONDITIONS ARE SUCH THAT MUD IS COLLECTING ON VEHICLE TIRES, THE TIRES MUST BE CLEANED BEFORE THE VEHICLES ENTER THE PUBLIC ROADWAY. THE SITE ENTRANCE SHALL BE MAINTAINED IN A CONDITION THAT WILL PREVENT THE TRACKING OR FLOW OF MUD ONTO THE PUBLIC RIGHT-OF-WAY. ALL MATERIALS SPILLED, DROPPED, WASHED OR TRACKED FROM VEHICLES ONTO THE ROADWAY MUST BE REMOVED PROMPTLY.
- 10. IF FOR ANY REASON, THE PROJECT IS SUSPENDED, THE CONTRACTOR SHALL ENSURE THAT ALL INSTALLED EROSION MEASURES ARE FUNCTIONING AND PROPERLY MAINTAINED DURING THIS PERIOD, AND THAT ALL BARE SOILS ARE SEEDED AND MULCHED WITH TEMPORARY SEED MIXTURE.
- 11. CONCRETE WASHOUT FACILITY (IF APPLICABLE) SHALL BE CONSTRUCTED IN ACCORDANCE WITH PLAN DETAILS AND LOCAL GOVERNING AUTHORITY REGULATIONS AND INSTRUCTIONS.
- 12. IMPLEMENTATION OF EROSION AND SEDIMENT CONTROLS SHALL CONFORM TO STATE OF MDOT CONSTRUCTION GENERAL PERMIT AND THE TOWNSHIP OF MACOMB CODIFIED ORDINANCES. IF A CONFLICT EXISTS BETWEEN THE TWO REGARDING EROSION AND SEDIMENT CONTROL IMPLEMENTATION, THE MORE RESTRICTIVE SHALL APPLY.
- 13. DISTURBED AREAS WITHIN 50' OF A STREAM SHALL HAVE PERMANENT STABILIZATION APPLIED WITHIN 2 DAYS OF FINAL GRADE.
- 14. DISTURBED AREAS WHICH WILL REMAIN DORMANT FOR OVER 1 YEAR OR ARE AT FINAL GRADE SHALL HAVE PERMANENT STABILIZATION APPLIED WITHIN 7 DAYS OF LAST EARTHWORK

INSPECTION NOTES

- 1. CONTRACTOR SHALL INSPECT ALL SWPPP MEASURES DAILY AND LOGGED BY THE CONTRACTOR FOR INSPECTION. LOGGING SHALL BE WEEKLY AND AFTER EVERY 1/2" RAINFALL EVENT. REPAIR AS NECESSARY TO PREVENT EROSION. SILTATION SHALL BE REMOVED FROM AREAS WHERE FAILURES HAVE OCCURRED AND CORRECTIVE ACTION TAKEN WITHIN 24 HOURS TO MAINTAIN ALL SWPPP.)
- 2. CONTRACTORS INSPECTOR SHALL BE A QUALIFIED INDIVIDUAL. ONLY A QUALIFIED INSPECTION PERSONNEL IS TO PERFORM THE INSPECTIONS. SITE INSPECTIONS SHALL BE DONE WEEKLY AND WITHIN 24 HRS AFTER EVERY RAINFALL EVENT EXCEEDING 1/2" OF RAINFALL. ALL NECESSARY REPAIRS SHOULD BE IMPLEMENTED IMMEDIATELY AFTER SUCH INSPECTIONS.
- 3. CONTRACTOR'S INSPECTOR SHALL BE RESPONSIBLE FOR PREPARING AND SIGNING WEEKLY AND ALL INTERMEDIATE EROSION CONTROL INSPECTION REPORTS AFTER EVERY INSPECTION, WHICH INCLUDE BUT NOT LIMITED TO (DISTURBED AREAS, MATERIAL STORAGE AREAS, EROSION AND SEDIMENT CONTROLS; DISCHARGE LOCATIONS AND VEHICLE ENTRANCE/EXIT LOCATIONS). SUCH REPORTS SHALL BE MADE AVAILABLE TO OWNER, ENGINEER AND CITY / STATE OFFICIALS UPON THEIR REQUEST.
- 4. REPORTS SHALL BE KEPT FOR 3 YEARS AFTER TERMINATION OF THE CONSTRUCTION
- 5. CONTRACTOR MAY SUBMIT A WAIVER REQUEST TO THE LOCAL AND STATE GOVERNING AUTHORITIES FOR A REDUCTION TO MONTHLY INSPECTIONS IF THE SITE WILL BE STABILIZED AND DORMANT FOR A LONG PERIOD, AND/OR THE RUNOFF IS UNLIKELY DUE TO WEATHER CONDITIONS FOR AN EXTENDED PERIOD OF TIME (FROZEN GROUND).
- 6. FOR BMPS THAT REQUIRE REPAIR OR MAINTENANCE NON SEDIMENT POND BMPS ARE TO BE REPAIRED WITHIN 3 DAYS OF INSPECTION AND SEDIMENT PONDS ARE TO BE REPAIRED OR CLEANED OUT WITHIN 10 DAYS OF INSPECTION.
- 7. FOR BMPS THAT DO NOT MEET THE INTENDED FUNCTION, A NEW BMP SHALL BE INSTALLED WITHIN 10 DAYS OF THE INSPECTION.
- 8. FOR MISSING BMPS REQUIRED, THE MISSING BMPS SHALL BE INSTALLED WITHIN 10 DAYS OF THE INSPECTION.

SPILLS AND CONTAMINATION

- 1. CONSTRUCTION PERSONNEL, INCLUDING SUBCONTRACTORS WHO MAY USE OR HANDLE HAZARDOUS OR TOXIC MATERIALS, SHALL BE MADE AWARE OF THE FOLLOWING GENERAL GUIDELINES REGARDING DISPOSAL AND HANDLING OF HAZARDOUS AND CONSTRUCTION
- a. PREVENT SPILLS
- a. USE PRODUCTS UP FOLLOW LABEL DIRECTIONS FOR DISPOSAL
- REMOVE LIDS FROM EMPTY BOTTLES AND CANS WHEN DISPOSING IN TRASH
- RECYCLE WASTES WHENEVER POSSIBLE
- DON'T POUR INTO WATERWAYS, STORM DRAINS OR ONTO THE GROUND DON'T POUR DOWN THE SINK, DOOR DRAIN OR SEPTIC TANKS
- DON'T BURY CHEMICALS OR CONTAINERS DON'T BURN CHEMICALS OR CONTAINERS
- DON'T MIX CHEMICALS TOGETHER

THE CURRENT STATE'S EPA.

2. ANY DISCHARGE OF PETROLEUM OR PETROLEUM PRODUCTS OF LESS THAN 25 GALLONS ONTO A PERVIOUS SURFACE SHALL BE LEGALLY REMOVED AND PROPERLY TREATED OR PROPERLY DISPOSED OF, OR OTHERWISE REMEDIATED, SO THAT NO CONTAMINATION FROM THE DISCHARGE REMAINS ON-SITE. SPILLS OF 25 GALLONS OR MORE OF PETROLEUM PRODUCTS SHALL BE REPORTED TO THE MICHIGAN'S EPA, THE LOCAL FIRE DEPARTMENT, AND THE LOCAL EMERGENCY PLANNING COMMITTEE WITHIN 30 MINUTES OF THE DISCOVERY OF

THE RELEASE. ALL SPILLS WHICH CONTACT WATERS OF THE STATE MUST BE REPORTED TO

- 3. SPILL REPORTING REQUIREMENTS: SPILLS ON PAVEMENT SHALL BE ABSORBED WITH SAWDUST OR KITTY LITTER AND DISPOSED OF WITH THE TRASH AT A LICENSED SANITARY LAND FILL. HAZARDOUS OR INDUSTRIAL WASTES SUCH AS MOST SOLVENTS, GASOLINE, OIL-BASED PAINTS, AND CEMENT CURING COMPOUNDS REQUIRE SPECIAL HANDLING. SPILLS SHALL BE REPORTED TO THE MICHIGAN'S EPA.
- 4. CONTAINERS SHALL BE PROVIDED FOR THE PROPER COLLECTION OF ALL WASTE MATERIAL INCLUDING CONSTRUCTION DEBRIS, TRASH, PETROLEUM PRODUCTS AND ANY HAZARDOUS MATERIALS USED ON-SITE. CONTAINERS SHALL BE COVERED AND NOT LEAKING. ALL WASTE MATERIAL SHALL BE DISPOSED OF AT FACILITIES APPROVED FOR THAT MATERIAL. CONSTRUCTION DEMOLITION AND DEBRIS (CD&D) WASTE MUST BE DISPOSED OF AT THE MICHIGAN'S EPA APPROVED CD&D LAND FILL.
- 5. PROCESS WASTE WATER/LEACHATE MANAGEMENT: EPA'S CONSTRUCTION GENERAL PERMIT ONLY ALLOWS THE DISCHARGE OF STORM WATER AND DOES NOT INCLUDE OTHER WASTE STREAMS/DISCHARGES SUCH AS VEHICLE AND/OR EQUIPMENT WASHING, ON-SITE SEPTIC LEACHATE CONCRETE WASH OUTS, WHICH ARE CONSIDERED PROCESS WASTEWATERS. ALL PROCESS WASTEWATERS MUST BE COLLECTED AND PROPERLY DISPOSED AT AN APPROVED DISPOSAL FACILITY. IN THE EVENT, LEACHATE OR SEPTAGE IS DISCHARGED; IT MUST BE ISOLATED FOR COLLECTION AND PROPER DISPOSAL AND CORRECTIVE ACTIONS TAKEN TO ELIMINATE THE SOURCE OF WASTE WATER.
- 6. WASTES GENERATED BY CONSTRUCTION ACTIVITIES (I.E. CONSTRUCTION MATERIALS SUCH AS PAINTS, SOLVENTS, FUELS, CONCRETE, WOOD, ETC) MUST BE DISPOSED OF IN ACCORDANCE WITH LOCAL REGULATIONS. HAZARDOUS AND TOXIC SUBSTANCES ARE USED ON VIRTUALLY ALL CONSTRUCTION SITES. GOOD MANAGEMENT OF THESE SUBSTANCES IS ALWAYS NEEDED.
- 7. NO CONSTRUCTION RELATED WASTE MATERIALS ARE TO BE BURIED OR BURNED ON-SITE.
- 8. HANDLING CONSTRUCTION CHEMICALS: MIXING, PUMPING, TRANSFERRING OR OTHER HANDLING OF CONSTRUCTION CHEMICALS SUCH AS FERTILIZER, LIME, ASPHALT, CONCRETE DRYING COMPOUNDS. AND ALL OTHER POTENTIALLY HAZARDOUS MATERIALS SHALL BE PERFORMED IN AN AREA AWAY FROM ANY WATERCOURSE. DITCH OR STORM DRAIN.
- 9. EQUIPMENT FUELING AND MAINTENANCE, OIL CHANGING, ETC., SHALL BE PERFORMED AWAY FROM WATERCOURSES. DITCHES OR STORM DRAINS. IN AN AREA DESIGNATED FOR THAT PURPOSE. THE DESIGNATED AREA SHALL BE EQUIPPED FOR RECYCLING OIL AND CATCHING SPILLS. SECONDARY CONTAINMENT SHALL BE PROVIDED FOR ALL FUEL OIL STORAGE TANKS. THESE AREAS MUST BE INSPECTED EVERY SEVEN DAYS AND WITHIN 24 HRS. OF A 0.5 INCH OR GREATER RAIN EVENT TO ENSURE THERE ARE NO EXPOSED MATERIALS WHICH WOULD CONTAMINATE STORM WATER. SITE OPERATORS MUST BE AWARE THAT SPILL PREVENTION CONTROL AND COUNTERMEASURES (SPCC) REQUIREMENTS MAY APPLY. AN SPCC PLAN IS REQUIRED FOR SITES WITH ONE SINGLE ABOVE GROUND TANK OF 660 GALLONS OR MORE, ACCUMULATIVE ABOVE GROUND STORAGE OF 1330 GALLONS OR MORE, OR 42,000 GALLONS OF UNDERGROUND STORAGE. CONTAMINATED SOILS MUST BE PROPERLY DISPOSED OF IN ACCORDANCE WITH LOCAL GOVERNING AUTHORITY REGULATIONS. SPCC PLAN AND APPROVALS ARE THE RESPONSIBILITY OF THE CONTRACTOR.
- 10. CONTAMINATED SOILS: IF SUBSTANCES SUCH AS OIL, DIESEL FUEL, HYDRAULIC FLUID, ANTIFREEZE, ETC. ARE SPILLED, LEAKED, OR RELEASED ONTO THE SOIL, THE SOIL SHOULD BE DUG UP AND DISPOSED OF AT LICENSED SANITARY LAND FILL OR OTHER APPROVED PETROLEUM CONTAMINATED SOIL REMEDIATION FACILITY (NOT A CONSTRUCTION / DEMOLITION DEBRIS LAND FILL). NOTE THOSE STORM WATER RUNOFFS ASSOCIATED WITH CONTAMINATED SOILS ARE NOT BE AUTHORIZED UNDER CURRENT REGULATIONS OF CONSTRUCTION ACTIVITIES.
- 11. CONTRACTOR SHALL TAKE PREVENTIVE MEASURES FOR WATER DISCHARGES FROM
- CONTAMINATED SOILS BY ANY MEANS POSSIBLE, INCLUDING THE FOLLOWING: 11.1. THE USE OF BERMS, TRENCHES, AND PITS TO COLLECT CONTAMINATED RUNOFF AND PREVENT DISCHARGES.
- 11.2. PUMPING RUNOFF INTO A SANITARY SEWER (WITH PRIOR WRITTEN APPROVAL OF THE SANITARY SEWER SERVICE OPERATOR) OR INTO A CONTAINER FOR TRANSPORT TO AN APPROPRIATE TREATMENT/DISPOSAL FACILITY.
- 11.3. COVERING AREAS OF CONTAMINATION WITH TARPS OR OTHER METHODS THAT PREVENT STORMWATER FROM COMING INTO CONTACT WITH CONTAMINATED MATERIALS.

TEMPORARY SEEDING

- 1. STRUCTURAL EROSION AND SEDIMENT CONTROL PRACTICES SUCH AS DIVERSIONS AND SEDIMENT TRAPS SHALL BE INSTALLED AND STABILIZED WITH TEMPORARY SEEDING PRIOR TO GRADING THE REST OF THE CONSTRUCTION SITE.
- 2. TEMPORARY SEEDING / STABILIZATION SHALL BE APPLIED WITHIN THE FOLLOWING TIME FRAMES FOR VARIOUS AREAS OF THE SITE:
- 2.1. ANY DISTURBED AREA WITHIN 50 FEET OF A WATERCOURSE AND NOT AT FINAL GRADE SHALL BE SEEDED AND MULCHED WITHIN 2 DAYS OF THE MOST RECENT DISTURBANCE,
- IF THAT AREA WILL REMAIN IDLE FOR MORE THAN 14 DAYS. 2.2. ALL CONSTRUCTION ACTIVITIES IN ANY DISTURBED AREA. INCLUDING SOIL STOCKPILES THAT WILL BE IDLE FOR MORE THAN 14 DAYS BUT LESS THAN ONE YEAR, AND NOT WITHIN 50 FEET OF A WATERCOURSE SHALL BE SEEDED AND MULCHED WITHIN 7 DAYS OF THE MOST RECENT DISTURBANCE IN THE AREA.
- 2.3. DISTURBED AREAS THAT WILL BE IDLE OVER THE WINTER SHALL BE SEEDED AND MULCHED PRIOR TO NOVEMBER 1.
- 3. THE SEED BED SHOULD BE PULVERIZED AND LOOSE TO ENSURE THE SUCCESS OF ESTABLISHING VEGETATION. TEMPORARY SEEDING SHOULD NOT BE POSTPONED IF IDEAL SEED BED PREPARATION IS NOT POSSIBLE.
- 4. TEMPORARY VEGETATION SEEDING RATES SHALL ESTABLISH ADEQUATE STANDS OF VEGETATION, WHICH MAY REQUIRE USE OF SOIL AMENDMENTS. BASE RATES FOR LIME AND FERTILIZER SHALL BE USED.
- 5. ALL SEED MIXES AND SEEDING RATES USED SHALL BE APPROVED BY THE LOCAL GOVERNING AUTHORITY AND THE OWNER.
- SEED SHALL BE APPLIED UNIFORMLY WITH A CYCLONE SPREADER, DRILL, CULTIPACKER, SEEDER, OR HYDROSEEDER. WHEN FEASIBLE, SEED THAT HAS BEEN BROADCAST SHALL BE COVERED BY RAKING OR DRAGGING AND THEN LIGHTLY TAMPED INTO PLACE USING A ROLLER OR CULTIPACKER. IF HYDROSEEDING IS USED, THE SEED AND FERTILIZER WILL BE MIXED ON-SITE AND THE SEEDING SHALL BE DONE IMMEDIATELY AND WITHOUT INTERRUPTION.
- 7. APPLICATIONS OF TEMPORARY SEEDING SHALL INCLUDE MULCH, WHICH SHALL BE APPLIED DURING OR IMMEDIATELY AFTER SEEDING. SEEDINGS MADE DURING OPTIMUM SEEDING DATES ON FAVORABLE, VERY FLAT SOIL CONDITIONS MAY NOT NEED MULCH TO ACHIEVE ADEQUATE STABILIZATION. IF MULCH IS USED, FOLLOW THE REQUIREMENTS AND INSTRUCTIONS IN THE MULCH APPLICATION.

1. MULCH AND OTHER APPROPRIATE VEGETATIVE PRACTICES SHALL BE APPLIED TO DISTURBED AREAS WITHIN 7 DAYS OF GRADING IF THE AREA IS TO REMAIN DORMANT (UNDISTURBED) FOR MORE THAN 21 DAYS OR ON AREAS AND PORTIONS OF THE SITE WHICH CAN BE BROUGHT TO FINAL GRADE.

2. MULCH SHALL CONSIST OF ONE OF THE FOLLOWING:

- 2.1. STRAW SHALL BE UNROTTED SMALL GRAIN STRAW APPLIED AT THE RATE OF 2 TONS/AC OR 90 LB./1,000 SQ. FT. (TWO TO THREE BALES) THE STRAW MULCH SHALL BE SPREAD UNIFORMLY BY HAND OR MECHANICALLY SO THE SOIL SURFACE IS COVERED. FOR UNIFORM DISTRIBUTION OF HAND-SPREAD MULCH, DIVIDE AREA INTO APPROXIMATELY 1,000 SQ. FT. SECTIONS AND PLACE TWO 45-LB BALES OF STRAW IN EACH SECTION.
- 2.2. WOOD CELLULOSE FIBER SHOULD BE USED AT 2,000 LB.AC, OR 46 LB/1,000 SQ. FT. 2.3. ACCEPTABLE MULCHES INCLUDE MULCH MATTINGS AND ROLLED EROSION CONTROL PRODUCTS APPLIED ACCORDING TO MANUFACTURER'S RECOMMENDATIONS OR WOOD MULCH/CHIPS APPLIED AT 10-20 TONS/AC.
- 3. MULCH SHALL BE ANCHORED IMMEDIATELY TO MINIMIZE LOSS BY WIND OR RUNOFF. THE FOLLOWING ARE ACCEPTABLE METHODS FOR ANCHORING MULCH
- 3.1. USE A DISK, CRIMPER, OR SIMILAR TYPE TOOL SET STRAIGHT TO PUNCH OR ANCHOR THE MULCH MATERIAL INTO THE SOIL. STRAW MECHANICALLY ANCHORED SHALL NOT BE FINELY CHOPPED BUT BE LEFT GENERALLY LONGER THAN 6 INCHES.
- 3.2. USE MULCH NETTINGS ACCORDING TO THE MANUFACTURER'S RECOMMENDATIONS, FOLLOWING ALL PLACEMENT AND ANCHORING REQUIREMENTS. USE IN AREAS OF WATER CONCENTRATION AND STEEP SLOPES TO HOLD MULCH IN PLACE.
- 3.3. FOR STRAW MULCH, SYNTHETIC BINDERS SUCH AS ACRYLIC DLR (AGRI-TAC), DCA-70, PETROSET, TERRA TACK OR EQUAL MAY BE USED AT RATES RECOMMENDED BY THE MANUFACTURER. ALL APPLICATIONS OF SYNTHETIC BINDERS MUST BE CONDUCTED IN SUCH A MANNER WHERE THERE IS NO CONTACT WITH WATERS OF THE STATE.
- 3.4. WOOD CELLULOSE FIBER MAY BE USED FOR ANCHORING STRAW. THE FIBER BINDER SHALL BE APPLIED AT A NET DRY WEIGHT OF 750 LB/AC. THE WOOD CELLULOSE FIBER SHALL BE MIXED WITH WATER AND THE MIXTURE SHALL CONTAIN A MAXIMUM OF 50 LB/100 GAL. OF WOOD CELLULOSE FIBER.

DUST CONTROL NOTES

- DUST CONTROL SHALL BE MAINTAINED THROUGHOUT CONSTRUCTION. IF POSSIBLE GRADING SHALL BE DONE BY PHASING IN ORDER TO MINIMIZE THE AMOUNT OF LAND DISTURBANCE AT ONE TIME. IF PHASING IS NOT AN OPTION, DUST SHALL BE CONTROLLED WITH WATER DURING EARTHWORK OPERATIONS. AFTER EARTHWORK OPERATIONS, THE EXPOSED SOILS SHALL BE COVERED WITH STRAW OR MULCH UNTIL SEEDED.
- 2. DUST CONTROL OR DUST SUPPRESSANTS MAY BE USED TO PREVENT NUISANCE CONDITIONS WHEN APPROVED BY THE LOCAL AUTHORITY HAVING JURISDICTION. WHEN USED, SUPPRESSANTS SHALL BE APPLIED IN ACCORDANCE WITH THE MANUFACTURER'S SPECIFICATIONS AND IN A MANNER, WHICH PREVENTS A DISCHARGE TO WATERS OF THE STATE. SUFFICIENT DISTANCE MUST BE PROVIDED BETWEEN APPLICATIONS AND NEARBY BRIDGES, CATCH BASINS, AND OTHER WATERWAYS. APPLICATION (EXCLUDING WATER) MAY NOT OCCUR WHEN RAIN IS IMMINENT AS NOTED IN THE SHORT TERM FORECAST. OIL MAY NOT BE APPLIED FOR DUST CONTROL.
- 3. SUGGESTED METHODS OF CONSTRUCTION DUST CONTROL MAY INCLUDE THE FOLLOWING: 3.1. CONSTRUCTION SEQUENCING AND DISTURBING ONLY SMALL AREAS AT A TIME CAN
- GREATLY REDUCE PROBLEMATIC DUST FROM THE SITE. IF LAND MUST BE DISTURBED ADDITIONAL TEMPORARY STABILIZATION MEASURES SHOULD BE CONSIDERED PRIOR TO DISTURBANCES. 3.2. APPLY TEMPORARY OR PERMANENT SEEDING AND MULCH TO AREAS THAT WILL REMAIN
- IDLE FOR OVER 14 DAYS. SAVING EXISTING TREES AND LARGE SHRUBS WILL ALSO REDUSE SOIL AND AIR MOVEMENT ACROSS DISTURBED AREAS. 3.3. SPRAY DISTURBED SITE WITH WATER UNTIL THE SURFACE IS WET BEFORE AND DURING
- GRADING AND REPEAT AS NEEDED, ESPECIALLY ON HAUL ROADS AND OTHER HEAVY TRAFFIC ROUTES. WATERING SHALL BE DONE AT A RATE THAT PREVENTS DUST BUT DOES NOT CAUSE SOIL EROSION. WETTING AGENTS MAY BE UTILIZED ACCORDING TO MANUFACTURERS INSTRUCTIONS.
- 3.4. GRADED ROADWAYS AND OTHER SUITABLE AREAS MAY BE STABALIZED USING CRUSHED STONE OR COARSE GRAVEL AS SOON AS PRACTICABLE AFTER REACHING AN INTERIM OR FINAL GRADE. CRUSHED STONE OR COARSE GRAVEL CAN BE USED AS A PERMANENT COVER TO PROVIDE CONTROL OF SOIL EMISSIONS.
- 3.5. EXISTING WINDBREAK VEGETATION SHALL BE MARKED AND PRESERVED TO THE EXTENT POSSIBLE. SNOW FENCING OR OTHER SUITABLE BARRIER MAY BE PLACED PERPENDICULAR TO PREVAILING AIR CURRENTS AT INTERVALS OF ABOUT 15 TIMES THE BARRIER HEIGHTS TO CONTROL AIR CURRENTS AND BLOWING SOIL.
- 3.6. WHEN TEMPORARY DUST CONTROL MEASURES ARE USED; REPETITIVE TREATMENT SHOULD BE APPLIED AS NEED TO ACCOMPLISH SATISFACTORY CONTROL
- 3.7. PAVED AREAS THAT HAVE ACCUMULATED SEDIMENT FROM CONSTRUCTION SHOULD BE CLEANED DAILY, OR AS NEEDED, UTILIZING A STREET SWEEPER OR BUCKET-TYPE ENDLOADER OR SCRAPER.

DEWATERING

DEWATERING REFERS TO THE ACT OF REMOVING AND DISCHARGING WATER FROM EXCAVATED AREAS ON CONSTRUCTION SITES, UTILITY LINE CONSTRUCTION OR FROM SEDIMENT TRAPS OR BASINS ON CONSTRUCTION SITES. GIVEN THE UNIQUE CONDITIONS AT ANY PARTICULAR CONSTRUCTION SITE, ANY OR ALL OF THE PRACTICES MAY APPLY. IN ALL CASES, EVERY EFFORT SHALL BE MADE TO ELIMINATE SEDIMENT POLLUTION ASSOCIATED WITH DEWATERING.

PRACTICES FOR DEWATERING EXCAVATED AREAS

- 1. PUMPING OF WATER TO AN EXISTING SEDIMENT BASIN OR TRAP IN WHICH THE ENTIRE VOLUME OF WATER FROM THE AREA TO BE DEWATERED CAN BE CONTAINED WITHOUT
- DISCHARGE TO RECEIVING WATERS. 2. PUMPING OF WATER TO AN EXISTING SEDIMENT BASIN OR TRAP SUCH THAT THE ENTIRE VOLUME OF WATER FROM THE AREA TO BE DEWATERED CAN BE MANAGED WITHOUT
- EXCEEDING THE DESIGN OUTFLOW FROM THE SEDIMENT CONTROL STRUCTURE. 3. USE OF A STRAW BALE/SILT FENCE PIT OR TRAP AS DESCRIBED HEREIN AND APPROVED BY THE LOCAL GOVERNING AUTHORITY.
- PUMPING WATER THROUGH A GEOTEXTILE BAG MADE SPECIFICALLY FOR THIS PURPOSE. 5. A WELL-VEGETATIVE FILTER STRIP, CAPABLE OF WITHSTANDING THE VELOCITY OF
- DISCHARGED WATER WITHOUT ERODING, INCLUDING THE INSTALLATION OF ENERGY DISSIPATION (HAYBALES, RIPRAP OR SHEET OF PLYWOOD) AT THE PUMP DISCHARGE. 6. USE A SUMP PIT TO REDUCE THE PUMPING OF MUD.

DEWATERING OF SEDIMENT TRAPS AND BASINS. IN ALL CASES, WATER REMOVED FROM TRAPS AND BASINS SHALL BE DISCHARGED SO THAT IT PASSES THROUGH A SEDIMENT CONTROL DEVICE APPROVED BY THE LOCAL GOVERNING AUTHORITY PRIOR TO ENTERING RECEIVING WATERS. PRACTICES FOR DEWATERING OF TRAPS AND BASINS MAY INCLUDE SOME OR ALL OF THE FOLLOWING AS MAY BE APPROVED AND APPLICABLE. IN ALL CASES, THE DEWAERING OPERATIONS UTILIZED MUST BE CONTINUOUSLY MONITORED BY THE CONTRACTOR.

USE OF A STRAW BALE/SILT FENCE PIT OR TRAP.

- 1.1. AN EXCAVATED BASIN (APPLICABLE TO "STRAW BALE/SILT FENCE PIT") MAY BE LINED WITH FILTER FABRIC TO HELP REDUCE SCOUR AND TO PREVENT EROSION OF SOIL FROM WITHIN THE STRUCTURE. IT MAY ALSO BE HELPFUL TO DIRECT THE DISCHARGE ONTO A HAY OR STRAW BALE OR RIPRAP
- MEASURES SHALL CONSIST OF STRAW BALES, SILT FENCE AND A STONE OUTLET CONSISTING OF A COMBINATION OF 4-8 INCH RIPRAP AND ½ TO 2 INCH AGGREGATE AND A WET STORAGE PIT ORIENTED AS SHOWN IN DRAWING.
- 1.3. THE EXCAVATED AREA SHOULD BE A MINIMUM OF 3 FEET BELOW THE BASE OF THE
- PERIMETER MEASURES (STRAW BALES OR SILT FENCE). 1.4. ONCE THE WATER LEVEL NEARS THE CREST OF THE STONE WEIR (EMERGENCY OVERFLOW), THE PUMP MUST BE STOPPED WHILE THE STRUCTURE DRAINS DOWN TO
- THE ELEVATION OF THE WET STORAGE. THE WET STORAGE PIT MAY BE DEWATERED ONLY AFTER A MINIMUM OF 6 HOURS OF SEDIMENT SETTLING TIME. THIS EFFLUENT SHOULD BE PUMPED ACROSS A WELL-VEGETATED AREA OR THROUGH A SILT FENCE PRIOR TO ENTERING A
- WATERCOURSE. 1.6. ONCE THE DEVICE HAS BEEN REMOVED, GROUND CONTOURS SHALL BE RETURNED TO ORIGINAL CONDITION.
- PUMPING WATER THROUGH A GEOTEXTILE BAG MADE SPECIFICALLY FOR THIS PURPOSE.
- 2.1. THE BAG SHALL BE INSTALLED ON A VERY SLIGHT SLOPE SO INCOMING WATER FLOWS DOWNHILL THROUGH THE BAG WITHOUT CREATING MORE EROSION. 2.2. THE INLET OPENING OF THE DEWATERING DEVICE SHALL HAVE A FILL SPOUT LARGE ENOUGH TO ACCOMMODATE THE DISCHARGE HOSE AND SHALL USE TWO STAINLESS STEEL STRAPS TO SECURE THE HOSE AND PREVENT PUMPED WATER FROM ESCAPING
- WITHOUT BEING FILTERED. 2.3. THE BAG SHOULD BE PLACED ON AN AGGREGATE OR HAY BALE BED TO MAXIMIZE
- WATER FLOW THROUGH THE ENTIRE SURFACE AREA OF THE BAG. 2.4. THE FILTER BAG IS FULL WHEN IT NO LONGER CAN EFFICIENTLY FILTER SEDIMENT OR
- PASS WATER AT A REASONABLE RATE. FLOW RATES VARY DEPENDING ON THE SIZE OF THE DEWATERING DEVICE, AMOUNT OF SEDIMENT DISCHARGED INTO THE DEWATERING DEVICE. THE TYPE OF GROUND, ROCK. OR OTHER SUBSTANCE UNDER THE BAG AND THE DEGREE OF THE SLOPE ON WHICH THE BAG LIES. THE FILTER BAG SHOULD BE SIZED TO ACCOMMODATE THE ANTICIPATED FLOW RATES FROM THE TYPE OF PUMP USED. IN ALL CASES FOLLOW THE MANUFACTURERS
- RECOMMENDATIONS FOR PUMPING FLOW RATES. 2.6. THE FILTER BAG CAN BE LEFT IN PLACE AFTER CUTTING THE TOP OFF AND SEEDING AND MULCHING THE ACCUMULATED SEDIMENT OR REMOVED AND DISPOSED OF OFFSITE IN AN APPROVED LANDFILL.
- 3. A WELL-VEGETATIVE FILTER STRIP, CAPABLE OF WITHSTANDING THE VELOCITY OF DISCHARGED WATER WITHOUT ERODING, INCLUDING THE INSTALLATION OF ENERGY DISSIPATION (HAYBALES, RIPRAP OR SHEET OF PLYWOOD) AT THE PUMP DISCHARGE. SUCH OTHER METHODS AS MAY BE APPROVED BY THE LOCAL GOVERNING AUTHORITY.
- 4. REGARDLESS OF THE TYPE OF TREATMENT, ALWAYS USE A FLOATING SUCTION HOSE TO PUMP THE CLEANER WATER FROM THE TOP OF THE POND. AS THE CLEANER WATER IS PUMPED. THE SUCTION HOSE WILL LOWER AND EVENTUALLY ENCOUNTER SEDIMENT-LADEN WATER. AT THIS POINT CEASE PUMPING OPERATIONS AND REMOVE THE REMAINDER OF THE TRAPPED SEDIMENT WITH MACHINERY. EVEN WHEN PUMPING FROM THE TOP OF THE WATER COLUMN, PROVISIONS MUST STILL BE MADE TO FILTER WATER AS REQUIRED IN THIS SECTION PRIOR TO DISCHARGING TO A STREAM, DURING THE DEWATERING, PERSONNEL SHOULD BE ASSIGNED TO MONITOR PUMPING OPERATIONS AT ALL TIMES TO ENSURE THAT SEDIMENT POLLUTION IS ABATED. PUMPING SEDIMENT-LADEN WATER INTO THE WATERS OF THE STATE WITHOUT FILTRATION IS PROHIBITED.
- 5. THE DEWATERING DEVICE MUST BE SIZED (AND OPERATED) TO ALLOW PUMPED WATER TO FLOW THROUGH THE FILTERING APPARATUS WITHOUT EXCEEDING THE CAPACITY OF THE

GPD GROUP **Professional Corporation** 520 South Main Street, Suite 2531 Akron, OH 44311 330.572.2100 Fax: 330.572.2102

	DATE	REMARKS
1	3/8/22	Planning Comments
2	3/21/22	Planning Comments
3	4/21/22	Issued for Permit
4	6/30/22	Macomb SESC Comments
5	7/29/22	Macomb Township Comments

CONTRACT DATE: 11.15.21 BUILDING TYPE: END. MED20 PLAN VERSION: MARCH 2021

BRAND DESIGNER: DICKSON SITE NUMBER: 315390 STORE NUMBER: 457226 PA/PM:

DRAWN BY. JOB NO.: 2021088.48

TACO BELL


17669 23 Mile Road Macomb, MI 48042




ENDEAVOR 2.0



- 1. STONE SIZE NO. 2 STONE SHALL BE USED, OR RECYCLED CONCRETE EQUIVALENT.
- 2. THE CONSTRUCTION ENTRANCE SHALL COINCIDE WITH THE PROPOSED DRIVE AS SHOWN ON THE PLAN.
- 3. PAVEMENT THICKNESS STONE LAYER SHALL BE 6" THICK FOR STANDARD DUTY ACTIVITY AND 10" THICK FOR HEAVY DUTY ACTIVITY.
- 4. DRIVEWAY WIDTH THE ENTRANCE SHALL BE AT LEAST 20' WIDE. CONTRACTOR SHALL ENSURE ALL VEHICLES UTILIZE THE CONSTRUCTION ENTRANCE UNTIL PAVEMENT IS IN
- 5. BEDDING-A GEOTEXTILE SHALL BE PLACED OVER THE ENTIRE AREA PRIOR TO PLACING STONE. IT SHALL BE COMPOSED OF STRONG ROT-PROOF POLYMERIC FIBERS AND MEET THE SPECIFICATIONS SHOWN BELOW.
- 6. CULVERT-A PIPE OR CULVERT SHALL BE CONSTRUCTED UNDER THE ENTRANCE IF NEEDED TO PREVENT SURFACE WATER FLOWING ACROSS THE ENTRANCE OR TO PREVENT RUNOFF FROM BEING DIRECTED OUT ONTO PAVED SURFACES.
- 7. WATER BAR A WATER BAR SHALL BE CONSTRUCTED AS PART OF THE CONSTRUCTION ENTRANCE IF NEEDED TO PREVENT SURFACE RUNOFF FROM FLOWING THE LENGTH OF THE CONSTRUCTION ENTRANCE AND OUT ONTO PAVED SURFACES.
- MAINTENANCE TOP DRESSING OF ADDITIONAL STONE SHALL BE APPLIED AS CONDITIONS DEMAND. MUD SPILLED, DROPPED, WASHED OR TRACKED ONTO PUBLIC ROADS, OR ANY SURFACE WHERE RUNOFF IS NOT CHECKED BY SEDIMENT CONTROLS, SHALL BE REMOVED IMMEDIATELY. REMOVAL SHALL BE ACCOMPLISHED BY SCRAPING OR SWEEPING.
- CONSTRUCTION ENTRANCES SHALL NOT BE RELIED UPON TO REMOVE MUD FROM VEHICLES AND PREVENT OFF SITE TRACKING. VEHICLES THAT ENTER AND LEAVE THE CONSTRUCTION SHALL BE RESTRICTED FROM MUDDY AREAS.
- 10. THE ENTRANCE SHALL REMAIN IN PLACE UNTIL THE DISTURBED AREA IS STABILIZED OR REPLACED WITH A PERMANENT ROADWAY OR ENTRANCE.

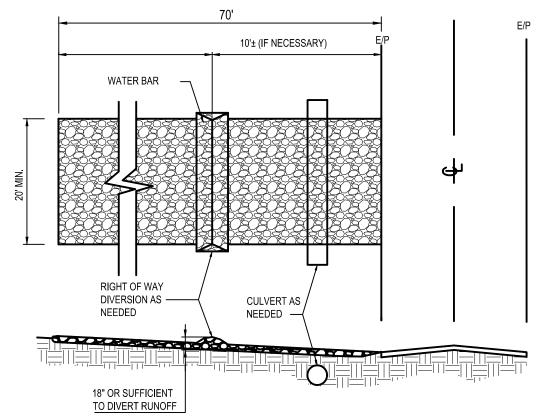



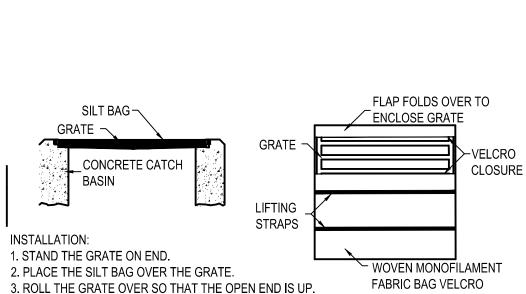

7. BE SURE THAT THE END OF THE GRATE IS COMPLETELY COVERED BY THE FLAP OR

8. HOLDING THE HANDLES, CAREFULLY PLACE THE SILT BAG WITH THE GRATE INSERTED

AND THE VICINITY OF THE UNIT WITH A SQUARE POINT SHOVEL OR STIFF BRISTLE BROOM

SATISFACTORY TO THE ENGINEER/INSPECTOR. REMOVE FINE MATERIAL FROM INSIDE SILT

TO INSPECT INLET, REMOVE SILT BAG WITH GRATE INSIDE, INSPECT CATCH BASIN AND

PONDING IS LIKELY IF SEDIMENT IS NOT REMOVED REGULARLY. THE SILT BAG MUST NEVER

BAG AS NEEDED. DISPOSE OF SILT BAG NO LONGER IN USE AT AN APPROPRIATE RECYCLING

AWAY FROM ENVIRONMENTALLY SENSITIVE AREAS AND WATERWAYS IN MANNER

CLOSURE

ADAPTED FROM FILTREXX

COMPOST SOCK FABRIC MINIMUM SPECIFICATIONS

PHOTO-

CHARACTERISTICS|DEGRADABLE |DEGRADABLE | DEGRADABLE | DEGRADABLE

23% AT

1000 HR.

MONTHS

PHOTO-

% AT 1000

HR.

MONTHS

INNER CONTAINMENT

OUTER FILTRATION

COMPOST SHALL MEET THE FOLLOWING STANDARDS:

ORGANIC MATTER CONTENT

ORGANIC PORTION

MOISTURE CONTENT

PARTICLE SIZE

SOLUBLE SALT CONCENTRATION

MIN 12"

N.T.S.

NETTING

DIAMETERS

MESH OPENING

TENSILE STRENGTH

ULTRAVIOLET STABILITY %

(ASTM G-155)

MINIMUM FUNCTIONAL

LONGEVITY

CONCRETE BLOCK OR

SAND BAG AT 10' O/C (ONLY WHEN STAKES

CANNOT BE USED) —

UNDISTURBED

GROUND

CONCRETE BLOCK -

NOT TO BE USED

WHERE IT COULD

INTERFERE WITH

VEHICULAR TRAFFIC.

A1

PROP. CONTOURS

DISTURBED

EX. CONTOURS UNDISTURBED \18" MIN.

ORIGINAL STRENGTH

MATERIAL TYPE | 3 mil HDPE | 5 mil HDPE | 5 mil HDPE | POLYPROPYLENE | POLYPROPYLENE | POLYPROPYLENE |

BIO-

26 PSI 26 PSI 44 PSI

MONTHS

TWO-PLY SYSTEMS

SOCK FABRICS COMPOSED OF BURLAP MAY BE USED ON PROJECTS LASTING 6 MONTHS OR LES

| MULTI-FILAMENT | MULTI-FILAMENT

100% AT

1000 HR.

HDPE BIAXIAL NE

CONTINUOUSLY WOUND

FUSION-WELDED JUNCTURES

3/4" X 3/4" MAX. APERTURE SIZE

COMPOSITE POLYPROPYLENE FABRIC

(WOVEN LAYER & NON-WOVEN FLEECE MECHANICALLY

FUSED VIA NEEDLE PUNCH)

80% - 100% (DRY WEIGHT BASIS)

FIBROUS AND ELONGATED

98% PASS THROUGH 1" SCREEN

5.0 dS MAXIMUM

DISTURBED

GROUND

3/16" MAX. APERTURE SIZE

- 2"x2" WOODEN STAKE (EXPOSED

3" TO 4" ABOVE SOCK) AT 10' O/C

BLOWN OR PLACED

BLOWN OR PLACED

COMPOST FILTER SOCK

- 2"x2" WOODEN STAKE (EXPOSED

3" TO 4" ABOVE SOCK) AT 10' O/C

COMPOST FILTER SOCK

(MFPP)

PHOTO-

DEGRADABLE

202 PSI

1000 HR.

YEARS

- 1. COMPOST FILTER SOCK SHALL BE PLACED AT EXISTING LEVEL GRADE. BOTH ENDS OF THE SOCK SHALL BE EXTENDED AT LEAST 8 FEET UP SLOPE AT 45 DEGREES TO THE MAIN SOCK
- ALIGNMENT TRAFFIC SHALL NOT BE PERMITTED TO CROSS FILTER SOCKS.
- ACCUMULATED SEDIMENT SHALL BE REMOVED WHEN IT REACHES 1/2 THE ABOVE GROUND HEIGHT OF THE SOCK AND DISPOSED IN THE MANNER DESCRIBED ELSEWHERE IN THE PLAN. 4. SOCKS SHALL BE INSPECTED WEEKLY AND AFTER EACH 1/2 INCH STORM RUNOFF EVENT. DAMAGED SOCKS SHALL BE REPAIRED ACCORDING TO MANUFACTURER'S SPECIFICATIONS OR
- REPLACED WITHIN 24 HOURS OF INSPECTION. BIODEGRADABLE FILTER SOCK SHALL BE REPLACED AFTER 6 MONTHS; PHOTODEGRADABLE SOCKS AFTER 1 YEAR. POLYPROPYLENE SOCKS SHALL BE REPLACED ACCORDING TO
- MANUFACTURER'S RECOMMENDATIONS. 6. UPON STABILIZATION OF THE AREA TRIBUTARY TO THE SOCK, STAKES SHALL BE REMOVED. THE SOCK MAY BE LEFT IN PLACE AND VEGETATED OR REMOVED. IN THE LATTER CASE. THE

BE USED WHERE OVERFLOW MAY ENDANGER AN EXPOSED SLOPE. MESH SHALL BE CUT OPEN AND THE MULCH SPREAD AS A SOIL SUPPLEMENT. COMPOST FILTER SOCK



4. PULL UP THE BAG.

5. TUCK THE FLAP IN.

MAINTENANCE:

6. PRESS THE VELCRO STRAPS TOGETHER.

INTO THE CATCH BASIN FRAME.

OR SOLID WASTE FACILITY.

INLET INSPECTION:

THE SILT BAG WILL NOT WORK PROPERLY.

REPLACE SILT BAG BACK INTO GRATE FRAME.

SHALL WASHOUT HERE BACKGROUND ANCHOR BALES WITH (2) 2"x2"x4' STAKES PER BALE ⊥PŎĽŸĒTHYLENE SHEETING T BALES TO BUTT 3'-0" MIN SOIL - AGGREGATE---**EMBEDMENT** — BINDING WIRE 30"± - STRAW BALE (TYPICAL) TO ENSURE PROPER OPERATION REMOVE SILT, SEDIMENT, AND DEBRIS FROM THE SURFACE SEASONAL HIGH

– 6" MIN DEPTH GROUNDWATER TABLE

AGGREGATE ALL AROUND . CONTAINMENT MUST BE STRUCTURALLY SOUND AND LEAK FREE AND CONTAIN ALL LIQUID WASTES. 2. CONTAINMENT DEVICES MUST BE OF SUFFICIENT QUANTITY OR VOLUME TO COMPLETELY CONTAIN THE LIQUID WASTES GENERATED.

TYPICAL SECTION

-GALVAN<mark>I</mark>ZED "U CHANNEL POS

FINISH GRADE

SIGN SHALL BE PLACED IN

A PROMINENT LOCATION

AT WASHOUT AREA

- 6" MIN IMBEDMENT

EXISTING GRADE —


---WOOD STAKE (TYPICAL)


(TYPICAL)

3. WASHOUT MUST BE CLEANED OR NEW FACILITIES CONSTRUCTED AND READY TO USE ONCE WASHOUT IS 75% FULL


4. WASHOUT AREA(S) SHALL BE INSTALLED IN A LOCATION EASILY ACCESSIBLE BY CONCRETE TRUCKS. 5. ONE OR MORE AREAS MAY BE INSTALLED ON THE CONSTRUCTION SITE AND MAY BE RELOCATED AS CONSTRUCTION PROGRESSES.

6. AT LEAST WEEKLY REMOVE ACCUMULATION OF SAND AND AGGREGATE AND DISPOSE OF PROPERLY.

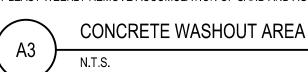


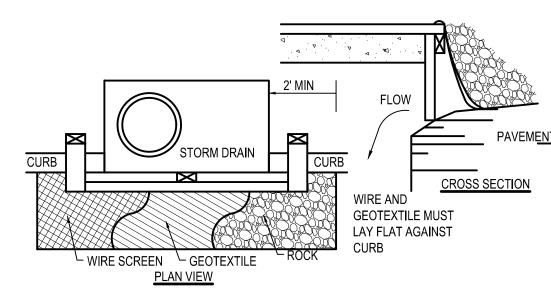

- 1. INLET PROTECTION SHALL BE CONSTRUCTED EITHER BEFORE UPSLOPE LAND DISTURBANCE
- BEGINS OR BEFORE THE INLET BECOMES FUNCTIONAL 2. CONSTRUCT A WOODEN FRAME OF 2-BY-4-IN. CONSTRUCTION-GRADE LUMBER. THE END SPACERS SHALL BE A MINIMUM OF 1 FT. BEYOND BOTH ENDS OF THE THROAT OPENING. THE ANCHORS
- SHALL BE NAILED TO 2-BY-4-IN. STAKES DRIVEN ON THE OPPOSITE SIDE OF THE CURB. 3. THE WIRE MESH SHALL BE OF SUFFICIENT STRENGTH TO SUPPORT FABRIC AND STONE. IT SHALL BE A CONTINUOUS PIECE WITH A MINIMUM WIDTH OF 30 IN. AND 4 FT. LONGER THAN THE THROAT LENGTH OF THE INLET, 2 FT. ON EACH SIDE.
- 4. GEOTEXTILE CLOTH SHALL HAVE AN EQUIVALENT OPENING SIZE (EOS) OF 20-40 SIEVE AND BE RESISTANT TO SUNLIGHT. IT SHALL BE AT LEAST THE SAME SIZE AS THE WIRE MESH.
- 5. THE WIRE MESH AND GEOTEXTILE CLOTH SHALL BE FORMED TO THE CONCRETE GUTTER AND AGAINST THE FACE OF THE CURB ON BOTH SIDES OF THE INLET AND SECURELY FASTENED TO THE 2-BY-4-IN. FRAME.
- 6. TWO-INCH STONE SHALL BE PLACED OVER THE WIRE MESH AND GEOTEXTILE IN SUCH A MANNER AS TO PREVENT WATER FROM ENTERING THE INLET UNDER OR AROUND THE GEOTEXTILE CLOTH.

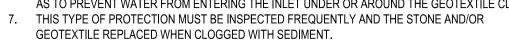

CURB INLET PROTECTION

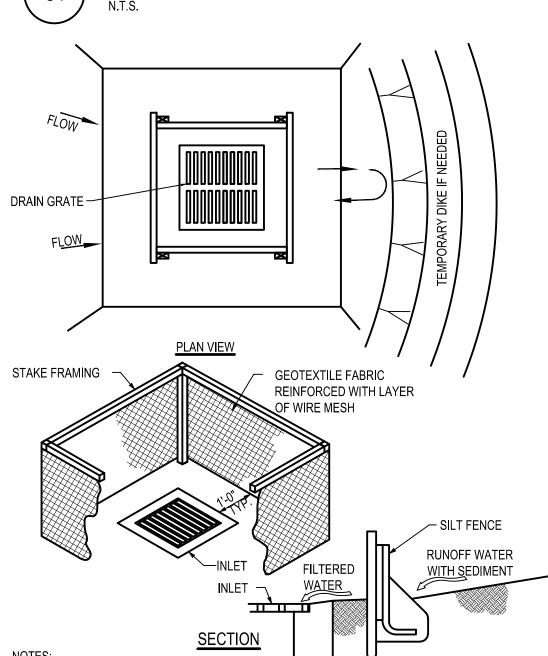

INLET PROTECTION SHALL BE CONSTRUCTED EITHER BEFORE UPSLOPE LAND DISTURBANCE

BEGINS OR BEFORE THE STORM DRAIN BECOMES OPERATIONAL. SILT FENCE SHALL BE GEOTEXTILE FABRIC, PER STATE'S DEPARTMENT OF TRANSPORTATION STANDARDS, AND SHOULD BE CUT FROM A CONTINUOUS ROLL TO AVOID JOINTS.

STAKES SHALL BE 1" x 2" WOOD (PREFERRED) OR EQUIVALENT METAL WITH A MINIMUM

LENGTH OF 3 FEET. STAKES SHALL BE SPACED AROUND THE PERIMETER OF THE INLET A MAXIMUM OF 3 FEET APART AND SECURELY DRIVEN INTO THE GROUND (MINIMUM OF 8 INCHES). THE TOP OF THE FRAME SHALL BE AT LEAST 6 IN. BELOW ADJACENT ROADS IF PONDED WATER WOULD POSE A SAFETY HAZARD TO TRAFFIC.

4. WIRE MESH SHALL BE OF SUFFICIENT STRENGTH TO SUPPORT FABRIC WITH WATER FULLY IMPOUNDED AGAINST IT. IT SHALL BE STRETCHED TIGHTLY AROUND THE FRAME AND

FASTENED SECURELY TO THE FRAME. 5. THE SILT FENCE SHALL BE STAPLED WITH HEAVY DUTY WIRE STAPLES AT LEAST 1/2 INCH LONG, TO THE WOODEN STAKES, AND 8 INCHES OF THE FABRIC SHALL BE EXTENDED INTO THE TRENCH. THE HEIGHT OF THE FILTER BARRIER SHALL BE A MINIMUM OF 15 INCHES AND SHALL NOT EXCEED 18 INCHES (PLATE 1.08B)


6. THE GEOTEXTILE SHALL OVERLAP ACROSS ONE SIDE OF THE INLET SO THE ENDS OF THE CLOTH ARE NOT FASTENED TO THE SAME POST.

7. A TRENCH SHALL BE EXCAVATED APPROXIMATELY 4 INCHES WIDE AND 4 INCHES DEEP AROUND THE OUTSIDE PERIMETER OF THE STAKES.

8. BACKFILL SHALL BE PLACED AROUND THE INLET IN COMPACTED 6 IN. LAYERS UNTIL THE EARTH IS EVEN WITH NOTCH ELEVATION ON ENDS AND TOP ELEVATION ON SIDES.

9. A COMPACTED EARTH DIKE OR A CHECK DAM SHALL BE CONSTRUCTED IN THE DITCH LINE BELOW THE INLET IF THE INLET IS NOT IN A DEPRESSION AND IF RUNOFF BYPASSING THE INLET WILL NOT FLOW TO A SETTLING POND. THE TOP OF EARTH DIKES SHALL BE AT LEAST 6 IN. HIGHER THAN THE TOP OF THE FRAME.

SILT FENCE SHOULD BE INSPECTED REGULARLY AND FREQUENTLY AS WELL AS AFTER EACH RAINFALL EVENT TO ENSURE THAT THEY ARE INTACT AND THERE ARE NO GAPS AT THE FENCE-GROUND INTERFACE OR TEARS ALONG THE LENGTH OF THE FENCE. IF GAPS OR TEARS ARE FOUND, THEY SHOULD BE REPAIRED OR THE FABRIC REPLACED IMMEDIATELY ACCUMULATED SEDIMENTS SHOULD BE REMOVED FROM THE FENCE BASE WHEN THE SEDIMENT REACHES ONE-THIRD TO ONE-HALF THE HEIGHT OF THE FENCE. SEDIMENT REMOVAL SHOULD OCCUR MORE FREQUENTLY IF ACCUMULATED SEDIMENT IS CREATING NOTICEABLE STRAIN ON THE FABRIC AND THERE IS THE POSSIBILITY OF THE FENCE FAILING FROM A SUDDEN STORM EVENT. WHEN THE SILT FENCE IS REMOVED, THE ACCUMULATED SEDIMENT SHOULD BE REMOVED.

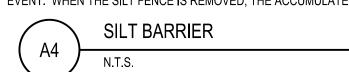



1) SILT FENCE SHALL BE CONSTRUCTED BEFORE UPSLOPE LAND DISTURBANCE BEGINS.

2) ALL SILT FENCE SHALL BE PLACED AS CLOSE TO THE CONTOUR AS POSSIBLE SO THAT WATER WILL NOT CONCENTRATE AT LOW POINTS IN THE FENCE AND SO THAT SMALL SWALES OR DEPRESSIONS WHICH MAY CARRY SMALL CONCENTRATED FLOWS TO THE SILT FENCE ARE DISSIPATED ALONG ITS LENGTH.

3) TO PREVENT WATER PONDED BY THE SILT FENCE FROM FLOWING AROUND THE ENDS, EACH END SHALL BE CONSTRUCTED UPSLOPE SO THAT THE ENDS ARE AT A HIGHER ELEVATION.

4) WHERE POSSIBLE, SILT FENCE SHALL BE PLACED ON THE FLATTEST AREA AVAILABLE.

5) WHERE POSSIBLE, VEGETATION SHALL BE PRESERVED FOR 5 FT. (OR AS MUCH AS POSSIBLE) UPSLOPE FROM THE SILT FENCE. IF VEGETATION IS REMOVED, IT SHALL BE REESTABLISHED WITHIN 7 DAYS FROM THE INSTALLATION OF THE SILT FENCE.

6) THE HEIGHT OF THE SILT FENCE SHALL BE A MINIMUM OF 16 IN. ABOVE THE ORIGINAL GROUND SURFACE.

7) THE FILTER FABRIC SHALL BE PURCHASED IN A CONTINUOUS ROLL CUT TO THE LENGTH OF THE BARRIER TO AVOID THE USE OF JOINTS. WHEN JOINTS ARE NECESSARY, FILTER CLOTH SHALL BE SPLICED TOGETHER ONLY AT A SUPPORT POST, WITH A MINIMUM 6 INCH OVERLAP, AND SECURELY SEALED.

8) POSTS SHALL BE A MINIMUM OF 5 FEET LONG, 2 INCHES IN DIAMETER AND SPACED A MAXIMUM OF 10 FEET APART AT THE BARRIER LOCATION AND DRIVEN SECURELY INTO THE GROUND. WHEN EXTRA STRENGTH FABRIC IS USED WITHOUT THE WIRE SUPPORT FENCE, POST SPACING SHALL NOT EXCEED 6 FEET.

9) THE SILT FENCE SHALL BE PLACED IN A TRENCH CUT A MINIMUM OF 6 INCHES DEEP. THE TRENCH SHALL BE CUT WITH A TRENCHER, CABLE LAYING MACHINE, OR OTHER SUITABLE DEVICE WHICH WILL ENSURE AN ADEQUATELY UNIFORM TRENCH DEPTH.

10) THE SILT FENCE SHALL BE PLACED WITH THE STAKES ON THE DOWNSLOPE SIDE OF THE GEOTEXTILE AND SO THAT 8 IN. OF CLOTH ARE BELOW THE GROUND SURFACE. EXCESS MATERIAL SHALL LAY ON THE BOTTOM OF THE 6 IN. DEEP TRENCH. THE TRENCH SHALL BE BACKFILLED AND COMPACTED.


11) WHEN EXTRA STRENGTH FILTER FABRIC AND CLOSER POST SPACING ARE USED, THE WIRE MESH SUPPORT FENCE MAY BE ELIMINATED. IN SUCH A CASE, THE FILTER FABRIC IS STAPLED OR WIRED DIRECTLY TO THE POSTS.

- 12) THE STANDARD STRENGTH FILTER FABRIC SHALL BE STAPLED OR WIRED TO THE FENCE, AND 8 INCHES OF THE FABRIC SHALL BE EXTENDED INTO THE TRENCH. THE FABRIC SHALL NOT EXTEND MORE THAN 36 INCHES ABOVE THE ORIGINAL GROUND SURFACE. FILTER FABRIC SHALL NOT BE STAPLED TO EXISTING TREES.
- 13) SEAMS BETWEEN SECTION OF SILT FENCE SHALL BE OVERLAPPED WITH THE END STAKES OF EACH SECTION WRAPPED TOGETHER BEFORE DRIVING INTO THE GROUND.

14) SILT FENCE SHALL ALLOW RUNOFF TO PASS ONLY AS DIFFUSE FLOW THROUGH THE GEOTEXTILE. IF RUNOFF OVERTOPS THE SILT FENCE, FLOWS UNDER OR AROUND THE ENDS, OR IN ANY OTHER WAY BECOMES A CONCENTRATED FLOW, ONE OF THE FOLLOWING SHALL BE PERFORMED, AS APPROPRIATE: A) THE LAYOUT OF THE SILT FENCE SHALL BE CHANGED, B) ACCUMULATED SEDIMENT SHALL BE REMOVED, OR C) OTHER PRACTICES SHALL BE INSTALLED.


MAINTENANCE:

SILT FENCE SHOULD BE INSPECTED REGULARLY AND FREQUENTLY AS WELL AS AFTER EACH RAINFALL EVENT TO ENSURE THAT THEY ARE INTACT AND THERE ARE NO GAPS AT THE FENCE-GROUND INTERFACE OR TEARS ALONG THE LENGTH OF THE FENCE. IF GAPS OR TEARS ARE FOUND. THEY SHOULD BE REPAIRED OR THE FABRIC REPLACED IMMEDIATELY. ACCUMULATED SEDIMENTS SHOULD BE REMOVED FROM THE FENCE BASE WHEN THE SEDIMENT REACHES ONE-THIRD TO ONE-HALF THE HEIGHT OF THE FENCE. SEDIMENT REMOVAL SHOULD OCCUR MORE FREQUENTLY IF ACCUMULATED SEDIMENT IS CREATING NOTICEABLE STRAIN ON THE FABRIC AND THERE IS THE POSSIBILITY OF THE FENCE FAILING FROM A SUDDEN STORM EVENT. WHEN THE SILT FENCE IS REMOVED, THE ACCUMULATED SEDIMENT SHOULD BE

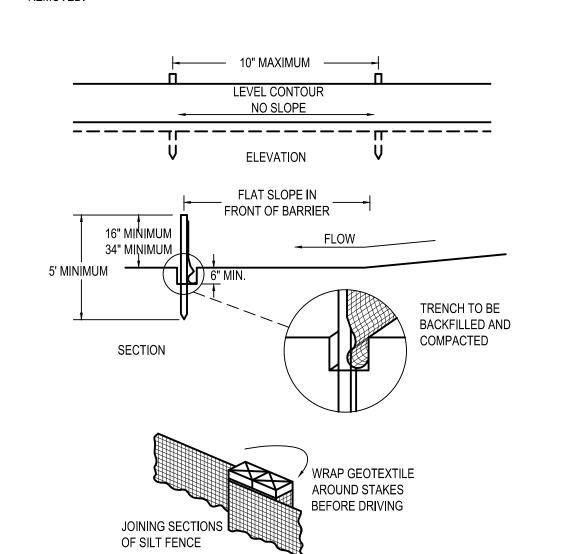

CRITERIA FOR GEOTEXTILE FABRIC SILT FENCE, PER CURRENT STATE'S DOT SPECIFICATIONS.

FABRIC PROPERTIES	VALUES	TEST METHOD	
MINIMUM TENSILE STRENGTH	120 LB. MINIMUM	ASTM D 4632	-
MINIMUM BURST STRENGTH	200 PSI MINIMUM		
MINIMUM PERMITTIVITY	1x10-2sec-1	ASTM D 4491	
APPARENT OPENING SIZE	AOS ≤ 0.84 mm	ASTM D 4751	
UV EXPOSURE STRENGTH RETENTION	70%	ASTM G 4335	
MAXIMUM ELONGATION AT 60 LBS.	50%	ASTM D 4632	
MINIMUM PUNCTURE STRENGTH	50 LBS (220N)	ASTM D 4833	
MINIMUM TEAR STRENGTH	40 LBS (180N)	ASTM D 4533	

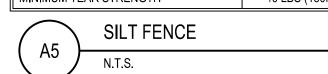

2	3/21/22	Planning Comments			
3	4/21/22	Issued for Permit			
4	6/30/22	Macomb SESC Comments			
5	7/29/22	Macomb Township Comments			
CONTRACT DATE: 11.15.2					
BU	ILDING TY	PE: END. MED20			

1 3/8/22 | Planning Comments

DATE

REMARKS

PLAN VERSION: MARCH 2021 BRAND DESIGNER: DICKSON SITE NUMBER: 315390 STORE NUMBER: 457226 PA/PM:

DRAWN BY. JOB NO.: 2021088.48


TACO BELL


17669 23 Mile Road Macomb, MI 48042




ENDEAVOR 2.0

DETAILS

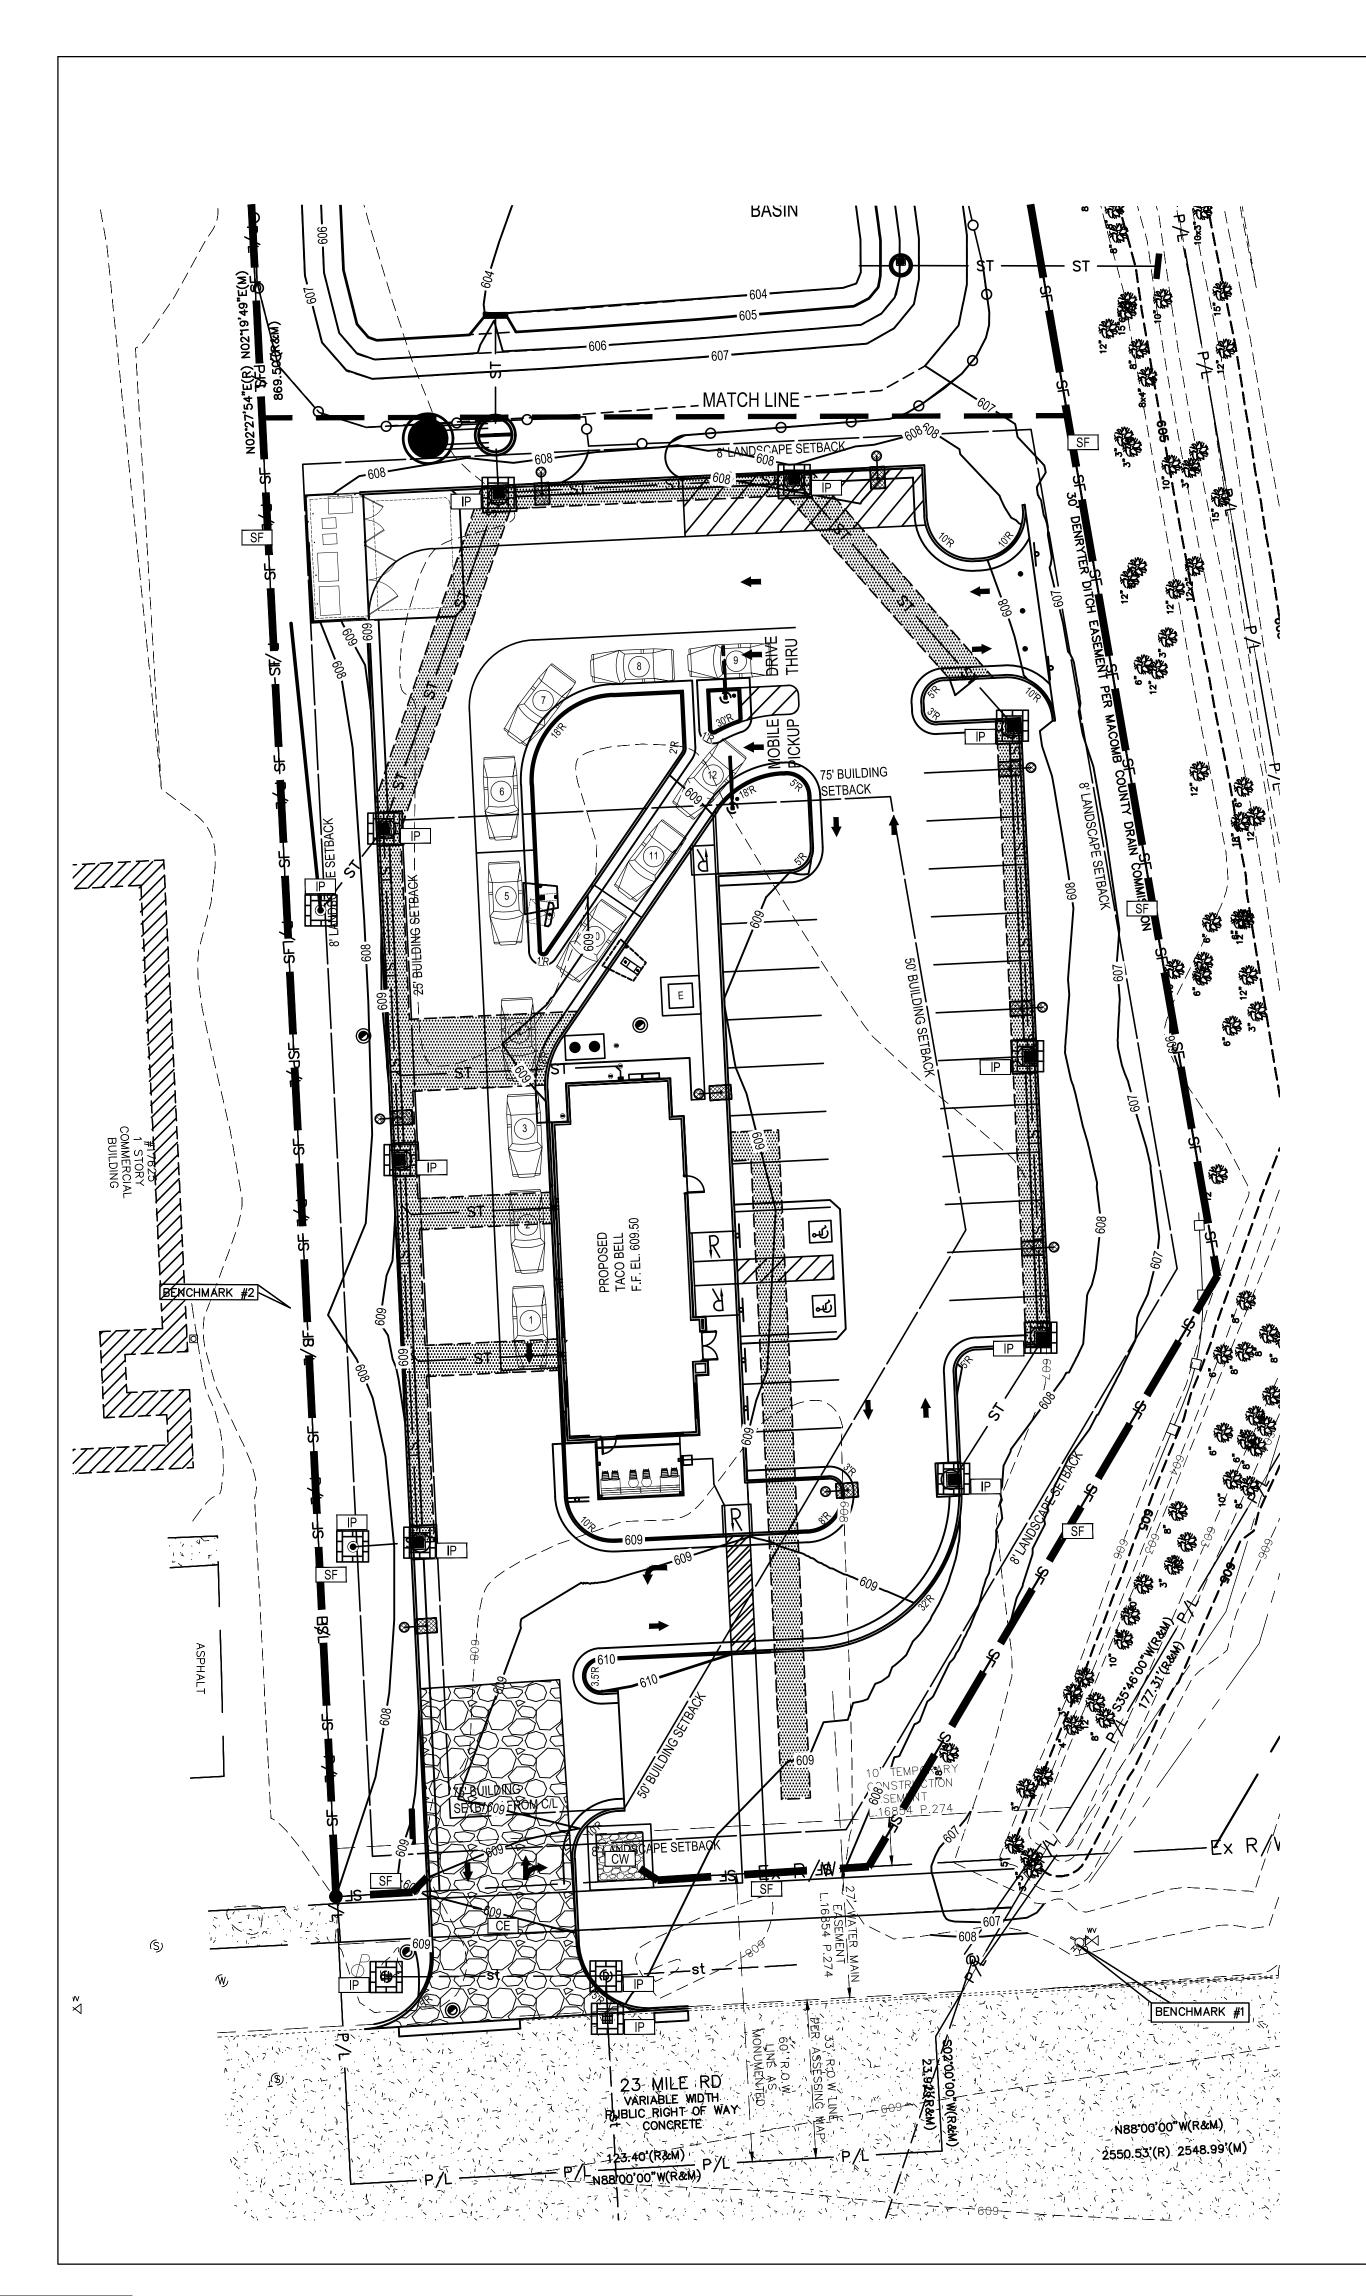

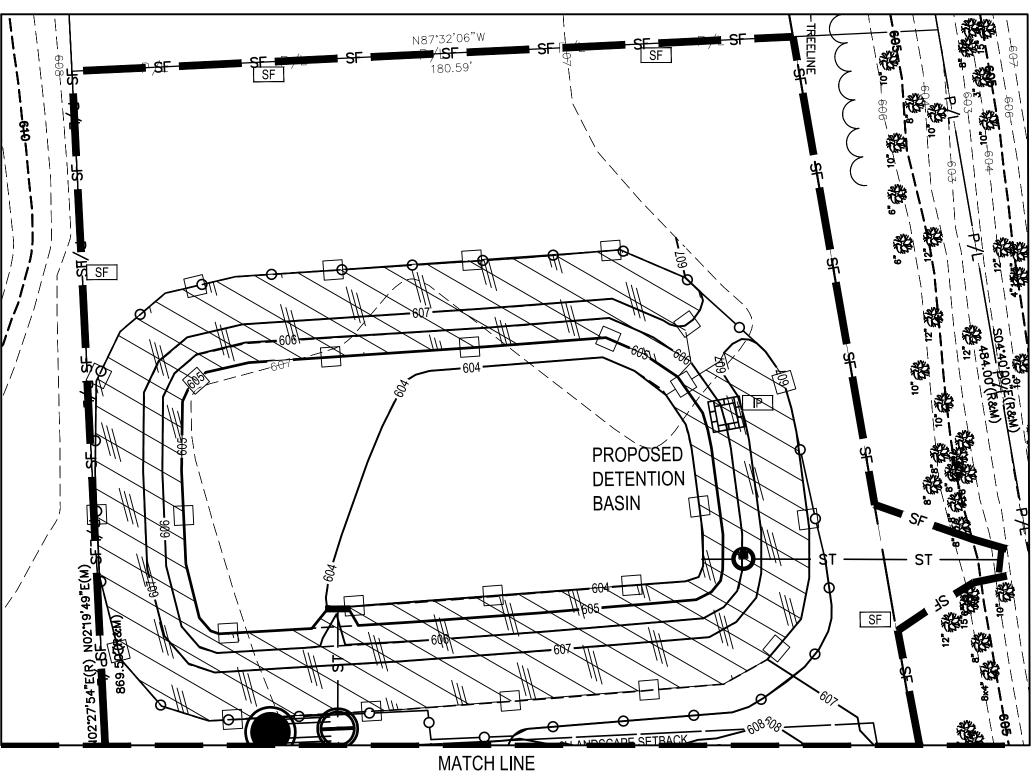

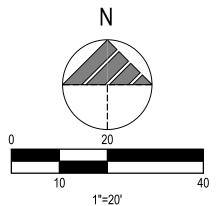

Horizontal Scale in Feet

SWPP KEYNOTES


CW CONCRETE WASHOUT AREA

CE CONSTRUCTION ENTRANCE


LEGEND
(SEE SHEET C-001 FOR GENERAL LEGEND)
PROPOSED SILT BARRIER

SF


PROPOSED SILT FENCE
REFER TO SWPP DETAILS

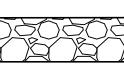

PROPOSED CONSTRUCTION ENTRANCE REFER TO SWPP DETAILS

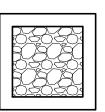

PROPOSED CONCRETE WASHOUT FACILITY REFER TO SWPP DETAILS

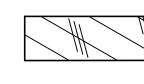

MULCH BLANKET SLOPE INSTALLATION REFER TO DETAIL ON SHEET C-013



IP INLET PROTECTION

SF SILT FENCE

CONSTRUCTION SEQUENCE

1. DURING PRECONSTRUCTION MEETING ALL EROSION & SEDIMENT CONTROL FACILITIES & PROCEDURES SHALL BE DISCUSSED. A GENERAL CONSTRUCTION SEQUENCE FOLLOWS AND MAY NEED TO BE UPDATED BY THE CONTRACTOR TO SUIT THE SPECIFICS OF THE SITE AND INTENDED CONTRACTOR SPECIFIC SEQUENCING.

1.1. INSTALL CONSTRUCTION ENTRANCE AS DETAILED ON PLANS. TEMPORARY CONSTRUCTION FENCING SHALL BE INSTALLED AROUND PERIMETER OF CONSTRUCTION SITE. WHERE THERE IS EXISTING FENCE ALONG THE PERIMETER OF THE SITE, IT CAN BE UTILIZED. FENCING SHALL BE USED TO RESTRICT OUTSIDE TRAFFIC TO SITE.

1.2. DELIVER CONSTRUCTION TRAILER TO SITE AND INSTALL TEMPORARY POWER AND TELEPHONE, IF REQUIRED. TEMPORARY UTILITY SERVICES ARE THE SOLE RESPONSIBILITY OF THE CONTRACTOR.
 1.3. STAKE AND/OR FLAG LIMITS OF CLEARING.

.4. CLEAR & GRUB, AS NECESSARY, FOR INSTALLATION OF PERIMETER CONTROLS. INSTALL SILT PERIMETER CONTROLS AS SHOWN ON PLANS. SILT PERIMETER CONTROLS SHALL BE INSTALLED LEVEL, ALONG THE CONTOURS, WITH ENDS TURNED UPSLOPE TO PREVENT CONCENTRATED FLOW AT THE SILT PERIMETER CONTROLS.

INSTALL TEMPORARY SILT INLET PROTECTION ON ALL EXISTING CATCH BASINS AND INLETS, AS DESIGNATED IN THE PLANS. REMOVAL OF SILT INLET PROTECTION FROM DESIGNATED INLETS CAN ONLY OCCUR WHEN A STRUCTURE IS REMOVED, AND AS REQUIRED BY THE PROGRESSION OF THE DEMOLITION AND CONSTRUCTION.
 CLEAR & GRUB, AS NECESSARY, FOR INSTALLATION OF TEMPORARY SEDIMENT

THE PLANS. CONSTRUCT AND MAINTAIN TEMPORARY DIVERSION SWALE AND / OR DIVERSION BERM DURING FILLING & GRADING ACTIVITIES.

1.7. CLEAR & GRUB THE REMAINING SITE AS NECESSARY. TOPSOIL SHALL BE STRIPPED AND STOCKPILED ON SITE FOR REUSE, OR REMOVED TO AN APPROVED OFFSITE SPOIL AREA.

TRAP/BASIN. INSTALL TEMPORARY SEDIMENT TRAP/BASIN, IF REQUIRED, AS DETAILED IN

1.8. UTILIZE DUST CONTROL MEASURES AS REQUIRED TO MINIMIZE AIR-BORNE POLLUTION BY METHODS APPROVED BY THE AUTHORIZING EPA OFFICE.
 1.9. BEGIN FILLING & GRADING AS REQUIRED TO REACH SUBGRADE.

1.10. ONCE PAVEMENT GRADES HAVE BEEN ESTABLISHED, AS DESIGNATED ON THE PLANS, THE CONTRACTOR SHALL UTILIZE THESE AREAS FOR STRUCTURE CONSTRUCTION.
1.11. CONSTRUCT UNDERGROUND UTILITY WORK INCLUDING STORM DRAINAGE FACILITIES. UPON INSTALLATION OF STORM DRAINAGE CATCH BASINS, YARD DRAINS AND INLETS,

INSTALL REQUIRED INLET PROTECTION.

1.12. DO NOT REPLACE ANY TOPSOIL, SEED OR INSTALL FINAL PAVEMENT PRIOR TO COMPLETION OF BUILDING SHELL. SHOULD SITEWORK BE COMPLETED PRIOR TO THIS DATE, MULCH DISTURBED AREAS TO BE PLANTED AND INSTALL STONE SUBBASE IN DISTURBED AREAS TO BE PAVED.

1.13. FOLLOWING COMPLETION OF BUILDING SHELL AND PAVEMENT INSTALLATION, BEGIN LANDSCAPE INSTALLATION.

1.14. COMPLETE SITEWORK, PAVEMENT MARKINGS AND FINAL CLEAN-UP. RESEED ANY AREAS THAT MAY REQUIRE ATTENTION IMMEDIATELY. NOTE THAT LAWN AREAS WILL NOT BE

DEEMED STABLE UNTIL A MINIMUM 80% VEGETATIVE DENSITY HAS BEEN ACHIEVED.

1.15. MAINTAIN EROSION & SEDIMENTATION CONTROL MEASURES UNTIL THE SITE HAS BEEN COMPLETELY STABILIZED. ALL AREAS OF VEGETATIVE SURFACE, WHETHER PERMANENT OR TEMPORARY, SHALL BE CONSIDERED TO BE IN PLACE AND FUNCTIONAL WHEN THE REQUIRED UNIFORM RATE OF COVERAGE (80%) IS OBTAINED.

1.16. REMOVE SEDIMENT CONTROLS.

PROJECT DESCRIPTION

THIS SUBJECT PROJECT AREA IS 2.17 ACRE SITE WHICH IS A VACANT LOT. THE IMPROVEMENTS TO THIS SITE WILL INCLUDE BUT NOT LIMITED TO A NEW TACO BELL RESTAURANT, NEW PARKING LOT, CONCRETE SIDEWALKS, ALL APPURTENANT UTILITY CONNECTIONS, DETENTION POND, GRADING AND LANDSCAPING.

PROJECT COMPLETION STATISTICS PARCEL SIZE : 2.17 ACRES TOTAL DISTURBED AREA: 1.73 ACRES EXISTING LAND USE FOR THE SITE IS VACANT LOT. 0.00 ACRES ESTIMATED PRE-CONSTRUCTION IMPERVIOUS AREA: ESTIMATED PRE-CONSTRUCTION IMPERVIOUS PERCENT: 0.0% PRE-CONSTRUCTION RUN-OFF COEFFICIENT: PROPOSED LAND USE WILL BE A TACO BELL ESTIMATED POST-CONSTRUCTION IMPERVIOUS AREA: 1.07 ACRES ESTIMATED POST-CONSTRUCTION IMPERVIOUS PERCENT: 49.3%
(IMPERVIOUS AREA: 1.07 AC (C= 0.95) PERVIOUS AREA: 1.10 AC (C=0.45) (POST-CONSTRUCTION RUN-OFF COEFFICIENT: 0.70 (WEIGHTED C),

PROJECT LOCATION:
LATITUDE LONGITUD
42.6725° -82.94732°

EXISTING SITE SOIL TYPES:

BX: BREVORT-SELFRIDGE COMPLEX.

LG: LENAWEE SILTY CLAY LOAM.

SDA: SELFRIDGE LOAMY SAND REFERENCE: USDA NATIONAL RESOURCES CONSERVATION SERVICE WEB SOIL SURVEY.

WETLAND INFORMATION:
THERE ARE NO KNOWN WETLANDS ON THIS SITE.

FIRST AND SUBSEQUENT RECEIVING STREAM:
INITIAL RECEIVING WATER IS DENRYTER DRAIN AND THE SUBSEQUENT RECEIVING WATER IS THE
MIDDLE BRANCH CLINTON RIVER.

POST CONSTRUCTION WQv / BMP DESCRIPTION

IN ORDER TO MEET THE MACOMB COUNTY STORMWATER MANAGEMENT REGULATIONS AN ABOVE GROUND DETENTION SYSTEM IS PROVIDED WITH STORAGE TO HOLD 100 YEAR STORM EVENT AND A WATER QUALITY UNIT IS PROVIDED TO MEET THE WATER QUALITY REQUIREMENTS.

JULY 15, 2022

OCTOBER 15, 2022

OWNER CONTACT:
4Z MACOMB, LLC
PETE ZINGAS
645 GRISWOLD, SUITE 3466
DETROIT, MI 48226
313.962.6400 EXT. 227 FAX: 131.963.4614
PZINGAS@SSZPC.COM

ANTICIPATED TIMING:
CONSTRUCTION BEGIN:
CONSTRUCTION COMPLETE:

CONTRACTOR: T.B.D.
CONTACT:
PHONE NUMBER:

CONTRACTOR SHALL MAINTAIN A CONSTRUCTION LOG DOCUMENTING ALL GRADING AND STABILIZATION ACTIVITIES.

BENCHMARKS AND BASIS OF BEARING: NORTH 88°00'00" WEST, BEING THE SOUTH LINE OF SECTION 17, AS DESCRIBED.

BENCHMARK #1

ARROW ON FIRE HYDRANT, EAST OF EAST PROPERTY
LINE, NORTH SIDE OF 23 MILE RD.

ELEVATION = 611.36' (NAVD 88)

ELEVATION = 608.83' (NAVD 88)

BENCHMARK #2
MAG NAIL IN NORTH MOST UTILITY POLE BY WEST PROPERTY LINE.

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5 7/29/22 Macomb Township Comments

GPD GROUP

Professional Corporation

520 South Main Street, Suite 2531

330.572.2100 Fax: 330.572.2102

Akron, OH 44311

CONTRACT DATE: 11.15.21
BUILDING TYPE: END. MED20
PLAN VERSION: MARCH 2021
BRAND DESIGNER: DICKSON
SITE NUMBER: 315390
STORE NUMBER: 457226

JOB NO.: 2021088.48

TACO BELL

PA/PM:

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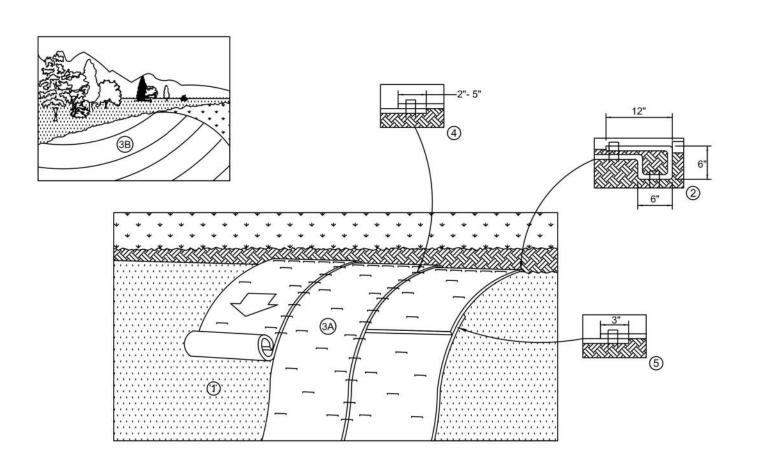


ENDEAVOR 2.0

SWPP PLAN

C-012

MULCH BLANKET SLOPE INSTALLATION (SESC-15)



1. PREPARE SOIL BEFORE INSTALLING ROLLED EROSION CONTROL PRODUCTS (RECP's), INCLUDING ANY NECESSARY APPLICATION OF LIME, FERTILIZER, AND SEED. 2. BEGIN AT THE TOP OF THE CHANNEL BY ANCHORING THE RECP's IN A 6" DEEP X 6" WIDE TRENCH WITH APPROXIMATELY 12" OF RECP's EXTENDED BEYOND THE UP-SLOPE PORTION OF THE TRENCH. ANCHOR THE RECP's WITH A ROW OF STAPLES/STAKES APPROXIMATELY 12" APART IN THE BOTTOM OF THE TRENCH. BACKFILL AND COMPACT THE TRENCH AFTER STAPLING, APPLY SEED TO COMPACTED SOIL AND FOLD REMAINING 12" APART IN THE RECP'S BACK OVER SEED AND COMPACTED SOIL. SECURE RECP'S OVER COMPACTED SOIL WITH A ROW OF STAPLES/STAKES SPACED APPROXIMATELY 12" ACROSS THE WIDTH OF THE RECP's. 3. ROLL THE RECP'S (A) DOWN OR (B) HORIZONTALLY ACROSS THE SLOPE. RECP'S WILL UNROLL WITH APPROPRIATE SIDE AGAINST THE

SOIL SURFACE. ALL RECP'S MUST BE SECURELY FASTENED TO SOIL SURFACE BY PLACING STAPLES/STAKES IN APPROPRIATE LOCATIONS AS SHOWN IN THE STAPLE PATTERN GUIDE (SEE DETAIL SESC-16). WHEN USING THE DOT SYSTEM, STAPLES/STAKES SHOULD BE PLACED THROUGH EACH OF THE COLORED DOTS CORRESPONDING TO THE APPROPRIATE STAPLE PATTERN (SEE DETAIL SESC-16). 4. THE EDGES OF PARALLEL RECP'S MUST BE STAPLED WITH APPROXIMATELY 2"-5" OVERLAP DEPENDING ON RECP'S TYPE 5. CONSECUTIVE RECP'S SPLICED DOWN THE SLOPE MUST BE PLACED END OVER END (SHINGLE STYLE) WITH AN APPROXIMATE 3"

OVERLAP. STAPLE THROUGH OVERLAPPED AREA, APPROXIMATELY 12" APART ACROSS ENTIRE RECP'S WIDTH.

* IN LOOSE SOIL CONDITIONS, THE USE OF STAPLE OR STAKE LENGTHS GREATER THAN 6" MAY BE NECESSARY TO PROPERLY ANCHOR THE

MACOMB COUNTY PUBLIC WORKS SOIL EROSION AND SEDIMENTATION CONTROL NOTES:

THIS PROJECT SHALL BE CONSTRUCTED IN COMPLIANCE WITH PART 91 OF ACT 451 OF 1994, AS AMENDED, THE SOIL EROSION AND SEDIMENTATION CONTROL ACT AND THE MACOMB COUNTY SOIL EROSION AND SEDIMENTATION CONTROL ORDINANCE.

ALL EROSION AND SEDIMENTATION CONTROL WORK SHALL CONFORM TO THE STANDARDS AND SPECIFICATIONS OF THE MACOMB COUNTY PUBLIC WORKS OFFICE.

EROSION AND ANY SEDIMENTATION FROM WORK ON THIS SITE SHALL BE CONTAINED ON THE SITE AND NOT ALLOWED TO COLLECT ON ANY OFF SITE AREAS OR IN WATERWAYS. WATERWAYS INCLUDE BOTH NATURAL AND MAN MADE OPEN DITCHES, STREAMS, STORM DRAINS, LAKES AND PONDS.

STAGING THE WORK WILL BE DONE BY THE LANDOWNER OR LANDOWNER'S REPRESENTATIVE AS DIRECTED IN THESE PLANS AND AS REQUIRED TO ENSURE PROGRESSIVE STABILIZATION OF DISTURBED EARTH CHANGE.

THE LANDOWNER OR LANDOWNER'S REPRESENTATIVE SHALL BE RESPONSIBLE FOR INSTALLATION AND MAINTENANCE OF SOIL EROSION AND SEDIMENTATION CONTROL DEVICES.

THE LANDOWNER OR LANDOWNER'S REPRESENTATIVE SHALL IMPLEMENT AND MAINTAIN THE SOIL EROSION CONTROL MEASURES AS SHOWN ON THE PLANS BEFORE AND AT ALL TIMES DURING CONSTRUCTION ON THIS PROJECT. ANY MODIFICATIONS OR ADDITIONS TO SOIL EROSION CONTROL MEASURES DUE TO CONSTRUCTION OR CHANGED CONDITIONS SHALL BE COMPLIED WITH AS REQUIRED OR DIRECTED BY THE MACOMB COUNTY PUBLIC WORKS OFFICE.

IF ANY OF THE SESC MEASURES ON THE SITE ARE DEEMED INADEQUATE OR INEFFECTIVE, THE MACOMB COUNTY PUBLIC WORKS OFFICE SESC DIVISION HAS THE RIGHT TO REQUIRE ADDITIONAL SESC MEASURES AT THE EXPENSE OF THE LANDOWNER.

INSTALL A CRUSHED CONCRETE ACCESS DRIVE PLACED ON GEOTEXTILE FABRIC AS INDICATED ON THE PLAN. THE ACCESS DRIVE MUST BE A MINIMUM OF 12'X50'X8".

A. NEW LAYERS OF CRUSHED CONCRETE WILL BE ADDED AS OLD LAYERS BECOME COMPACTED.

INSTALL SILT FENCE AS INDICATED ON THE PLAN AND AT ADDITIONAL AREAS AS NECESSARY.

- A. SILT FENCE SHALL BE INSTALLED PER DETAIL. B. BUILD UP OF SEDIMENT SHALL BE REMOVED WHEN SEDIMENT ACCUMULATES TO 1/3 TO ½ OF THE HEIGHT OF THE SILT FENCE.
- C. IF SILT FENCE FABRIC DECOMPOSES OR BECOMES INEFFECTIVE PRIOR TO THE END OF EXPECTED USABLE LIFE AND THE BARRIER IS STILL REQUIRED, THE SILT FENCE SHALL BE REPLACED PROMPTLY.
- D. SILT FENCE SHALL IN INSPECTED WEEKLY UNDER NORMAL CONDITIONS, WITHIN 24 HOURS OF RAINFALL AND DAILY DURING A PROLONGED RAIN EVENT. REQUIRED MAINTENANCE SHALL BE PROVIDED PROMPTLY.

INSTALL INLET FILTER ON ALL PAVEMENT CATCH BASINS PER DETAIL.

- A. INLET FILTERS SHALL BE INSPECTED WEEKLY UNDER NORMAL CONDITIONS, WITHIN 24 HOURS OF A RAINFALL AND DAILY DURING A PROLONGED RAIN EVENT.
- B. BUILDUP OF SEDIMENT AND DEBRIS SHALL BE REMOVED PROMPTLY.
- C. IF FABRIC DECOMPOSES OR BECOMES INEFFECTIVE PRIOR TO THE END OF EXPECTED USABLE LIFE AND THE BARRIER IS STILL REQUIRED, THE FABRIC SHALL BE REPLACED PROMPTLY.

INSTALL DRAIN GUARD ON ALL CATCH BASINS PER DETAIL, SEED OR SOD THE AREA BETWEEN THE SILT FENCE AND THE INLET.

- A. DRAIN GUARDS SHALL BE INSPECTED WEEKLY UNDER NORMAL CONDITIONS, WITHIN 24 HOURS OF RAINFALL AND DURING A PROLONGED RAIN EVENT.
- B. BUILD UP OF SEDIMENT SHALL BE REMOVED WHEN SEDIMENT ACCUMULATES TO 1/3 TO 1/2 OF
- THE HEIGHT OF THE SILT FENCE C. IF FABRIC DECOMPOSES OR BECOME INEFFECTIVE PRIOR TO THE END OF EXPECTED USABLE
- LIFE AND THE BARRIER IS STILL REQUIRED, THE SILT FENCE SHALL BE REPLACED PROMPTLY. INLET SEDIMENT TRAPS AND ALL DITCH SEDIMENT TRAPS SHALL BE INSPECTED DAILY. THE SEDIMENT

PITS SHALL BE CLEANED OUT WHEN HALF FULL, OR AS DIRECTED BY THE MACOMB COUNTY PUBLIC

DETENTION/RETENTION/SILTATION PONDS.

- A. INSTALL SILT FENCE AROUND TOP OF BANK OF DETENTION POND.
- B. SEED/MULCH BANKS USING MULCH BLANKET OF POND IMMEDIATELY AFTER EXCAVATION. ALL PONDS MUST BE STABILIZED PRIOR TO BEING PLACED IN SERVICE.
- C. THE POND MUST BE CLEANED OF SEDIMENT AND OTHER DEBRIS PRIOR TO FINALIZATION OF THE PERMIT. ANY AREAS LACKING VEGETATION MUST BE REPAIRED BEFORE FINAL APPROVAL FOR THE PROJECT IS GRANTED.

UTILITIES AND PUMP STATION

A. THE ROAD RIGHT OF WAY MUST BE SEEDED AND MULCHED WITHIN 5 DAYS AFTER UTILITIES HAVE BEEN INSTALLED. IF THIS IS NOT POSSIBLE, ALL SESC MEASURES MUST STAY IN PLACE AND MUST BE MAINTAINED UNTIL PERMANENT STABILIZATION IS COMPLETED.

ALL STOCKPILED SOILS SHALL BE MAINTAINED IN SUCH A WAY AS TO PREVENT EROSION FROM LEAVING THE SITE. IF THE STOCKPILE WILL BE ON SITE FOR MORE THAN 30 DAYS, THEN THE STOCKPILE MUST BE SEEDED. SILT FENCE MUST BE INSTALLED AROUND THE PERIMETER OF THE STOCKPILE.

IMMEDIATELY AFTER SEEDING, MULCH ALL SEEDED AREAS WITH UNWEATHERED SMALL GRAIN STRAW, SPREAD UNIFORMLY AT THE RATE OF 1 TO 2 TONS PER ACRE OR 100 POUNDS (2-3 BALES) PER 1000 SQUARE FEET. THIS MULCH SHOULD BE ANCHORED WITH DISC TYPE MULCH ANCHORING TOOL OR OTHER MEANS AS APPROVED BY THE MACOMB COUNTY PUBLIC WORKS OFFICE. MULCH MATTING MAY BE USED IN LIEU OF LOOSE MULCH.

IF ANY DEWATERING IS NEEDED, IT SHALL BE DISCHARGED THROUGH A FILTER BAG OVER A WELL-VEGETATED AREA. THE PUMP MUST DISCHARGE AT A NON-EROSIVE VELOCITY. IF NECESSARY, AN APPROVED ENERGY DISSIPATER MAY BE USED.

ALL DIRT TRACKED ONTO ANY ROADWAY SHALL BE REMOVED IMMEDIATELY.


STREETS AND OR PARKING AREAS WILL BE SCRAPED ON A DAILY BASIS AND SWEPT AT A MINIMUM OF ONCE PER WEEK BY THE LANDOWNER OR LANDOWNER'S REPRESENTATIVE.

DURING DRY PERIODS, ALL DISTURBED AREAS SHALL BE WATERED FOR DUST CONTROL.

PERMANENT SOIL EROSION CONTROL MEASURES FOR ALL SLOPES, CHANNELS, DITCHES, OR ANY DISTURBED LAND AREA SHALL BE COMPETED WITHIN 5 CALENDAR DAYS AFTER FINAL GRADING OR THE FINAL EARTH CHANGE HAS BEEN COMPLETED. WHEN IT IS NOT POSSIBLE TO PERMANENTLY STABILIZE A DISTURBED AREA AFTER EARTH CHANGE ACTIVITY CEASES, TEMPORARILY SOIL EROSION CONTROL MEASURES SHALL BE IMPLEMENTED IMMEDIATELY. ALL TEMPORARY SOIL EROSION CONTROL SHALL BE MAINTAINED UNTIL PERMANENT SOIL EROSION CONTROL MEASURES ARE IMPLEMENTED. ALL PERMANENT SOIL EROSION CONTROL MEASURES WILL BE IMPLEMENTED AND ESTABLISHED BEFORE A CERTIFICATE OF COMPLIANCE IS ISSUED.

FINAL GRADE, ESTABLISH VEGETATION AND OR LANDSCAPE ALL DISTURBED AREAS NOT BUILT OR PAVED UPON.

REMOVE ALL TEMPORARY SOIL EROSION DEVICES AFTER PERMANENT STABILIZATION IS ESTABLISHED.

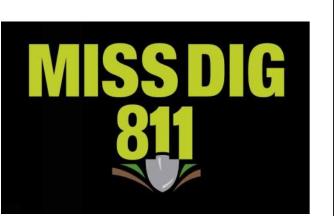



FOR FERENCE

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1	3/8/22	Planning Comments
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CONTRACT DATE: 11.15.21 BUILDING TYPE: END. MED20 PLAN VERSION: MARCH 2021 BRAND DESIGNER: DICKSON SITE NUMBER: 315390 STORE NUMBER:

PA/PM: DRAWN BY.

457226

2021088.48

TACO BELL

17669 23 Mile Road Macomb, MI 48042

JOB NO.:



ENDEAVOR 2.0 MACOMB COUNTY PUBLIC **WORKS SOIL EROSION** NOTES AND DETAILS



PLAN KEYNOTES (#)

- EXISTING CURB/GUTTER TO BE REMOVED. EXISTING ASPHALT / CONCRETE APRON TO BE REMOVED.
- EXISTING LANDSCAPING (INCLUDING BUSHES, TREES, ETC.) TO BE REMOVED.
- EXISTING CURB/GUTTER TO REMAIN AND BE PROTECTED THROUGHOUT CONSTRUCTION.
- EXISTING PAVEMENT TO REMAIN AND BE PROTECTED THROUGHOUT CONSTRUCTION. EXISTING WALK TO REMAIN AND BE PROTECTED THROUGHOUT CONSTRUCTION. REMOVE
- EXISTING UTILITIES TO REMAIN AND BE PROTECTED THROUGHOUT CONSTRUCTION.
- 8. EXISTING GUY WIRES TO BE RELOCATED PER UTILITY COMPANY. CONTRACTOR SHALL COORDINATE WITH THE UTILITY COMPANY.

DEMOLITION NOTE:

ALL EXISTING SITE AND SURROUNDING FEATURES SUCH AS UTILITIES, PAVEMENT, CURB, LANDSCAPING, ETC. SHALL REMAIN AND BE PROTECTED THROUGHOUT CONSTRUCTION UNLESS NOTED OTHERWISE, OR ARE REQUIRED TO BE MODIFIED OR REMOVED FOR THE INSTALLATION OF PROPOSED IMPROVEMENTS. ALL DISTURBED FEATURES SHALL BE RESTORED OR RELOCATED AS REQUIRED TO THE SATISFACTION OF THE OWNER. CONTRACTOR SHALL REPAIR/REPLACE ANY SURROUNDING FEATURES DAMAGED AS A RESULT OF CONSTRUCTION ACTIVITIES AT NO ADDITIONAL COST AND TO THE SATISFACTION OF THE OWNER.

LEGEND (SEE SHEET C-001 FOR GENERAL LEGEND)

EXISTING ASPHALT TO BE REMOVED EXISTING CONCRETE TO BE REMOVED DENOTES LIMITS OF SAWCUT DEMOLITION KEYNOTE

LIMITS OF DISTURBANCE

E	XISTING STRUCTURES
STRCT. ID	STRUCTURE DETAILS
STMH 334	EXISTING STORM SEWER MANHOLE RIM = 608.44 BOTTOM OF STRUCTURE = 599.24 TOP OF WATER = 602.79
SSMH 336	EXISTING SANITARY SEWER MANHOLE RIM = 608.81 INV. 8" (SE) = 598.06 INV. 8" (N) = 598.11
SSMH 337	EXISTING SANITARY SEWER MANHOLE RIM = 608.26 BOLTED COULD NOT OPEN
CB 338	EXISTING CATCH BASIN RIM = 606.87 INV. 12 " (E) = 602.22
CB 340	EXISTING CATCH BASIN RIM = 608.31 INV. 12" (N) = 602.61 INV. 12" (S) = 603.11
STMH 344	EXISTING STORM SEWER MANHOLE RIM = 608.48 INV. 24" (E) = 602.53 INV. 12" (S) = 602.63 INV. 12" (W) = 602.78

BENCHMARKS AND BASIS OF BEARING: NORTH 88°00'00" WEST, BEING THE SOUTH LINE OF SECTION 17, AS DESCRIBED.

1 3/8/22 Planning Comments 2 3/21/22 Planning Comments 3 4/21/22 Issued for Permit 4 6/30/22 Macomb SESC Comments 5 7/29/22 Macomb Township Comments CONTRACT DATE:

GPD GROUP

Professional Corporation

520 South Main Street, Suite 2531 Akron, OH 44311 330.572.2100 Fax: 330.572.2102

BUILDING TYPE: END. MED20 PLAN VERSION: MARCH 2021 BRAND DESIGNER: DICKSON SITE NUMBER: 315390 STORE NUMBER: 457226

DRAWN BY. JOB NO.: 2021088.48


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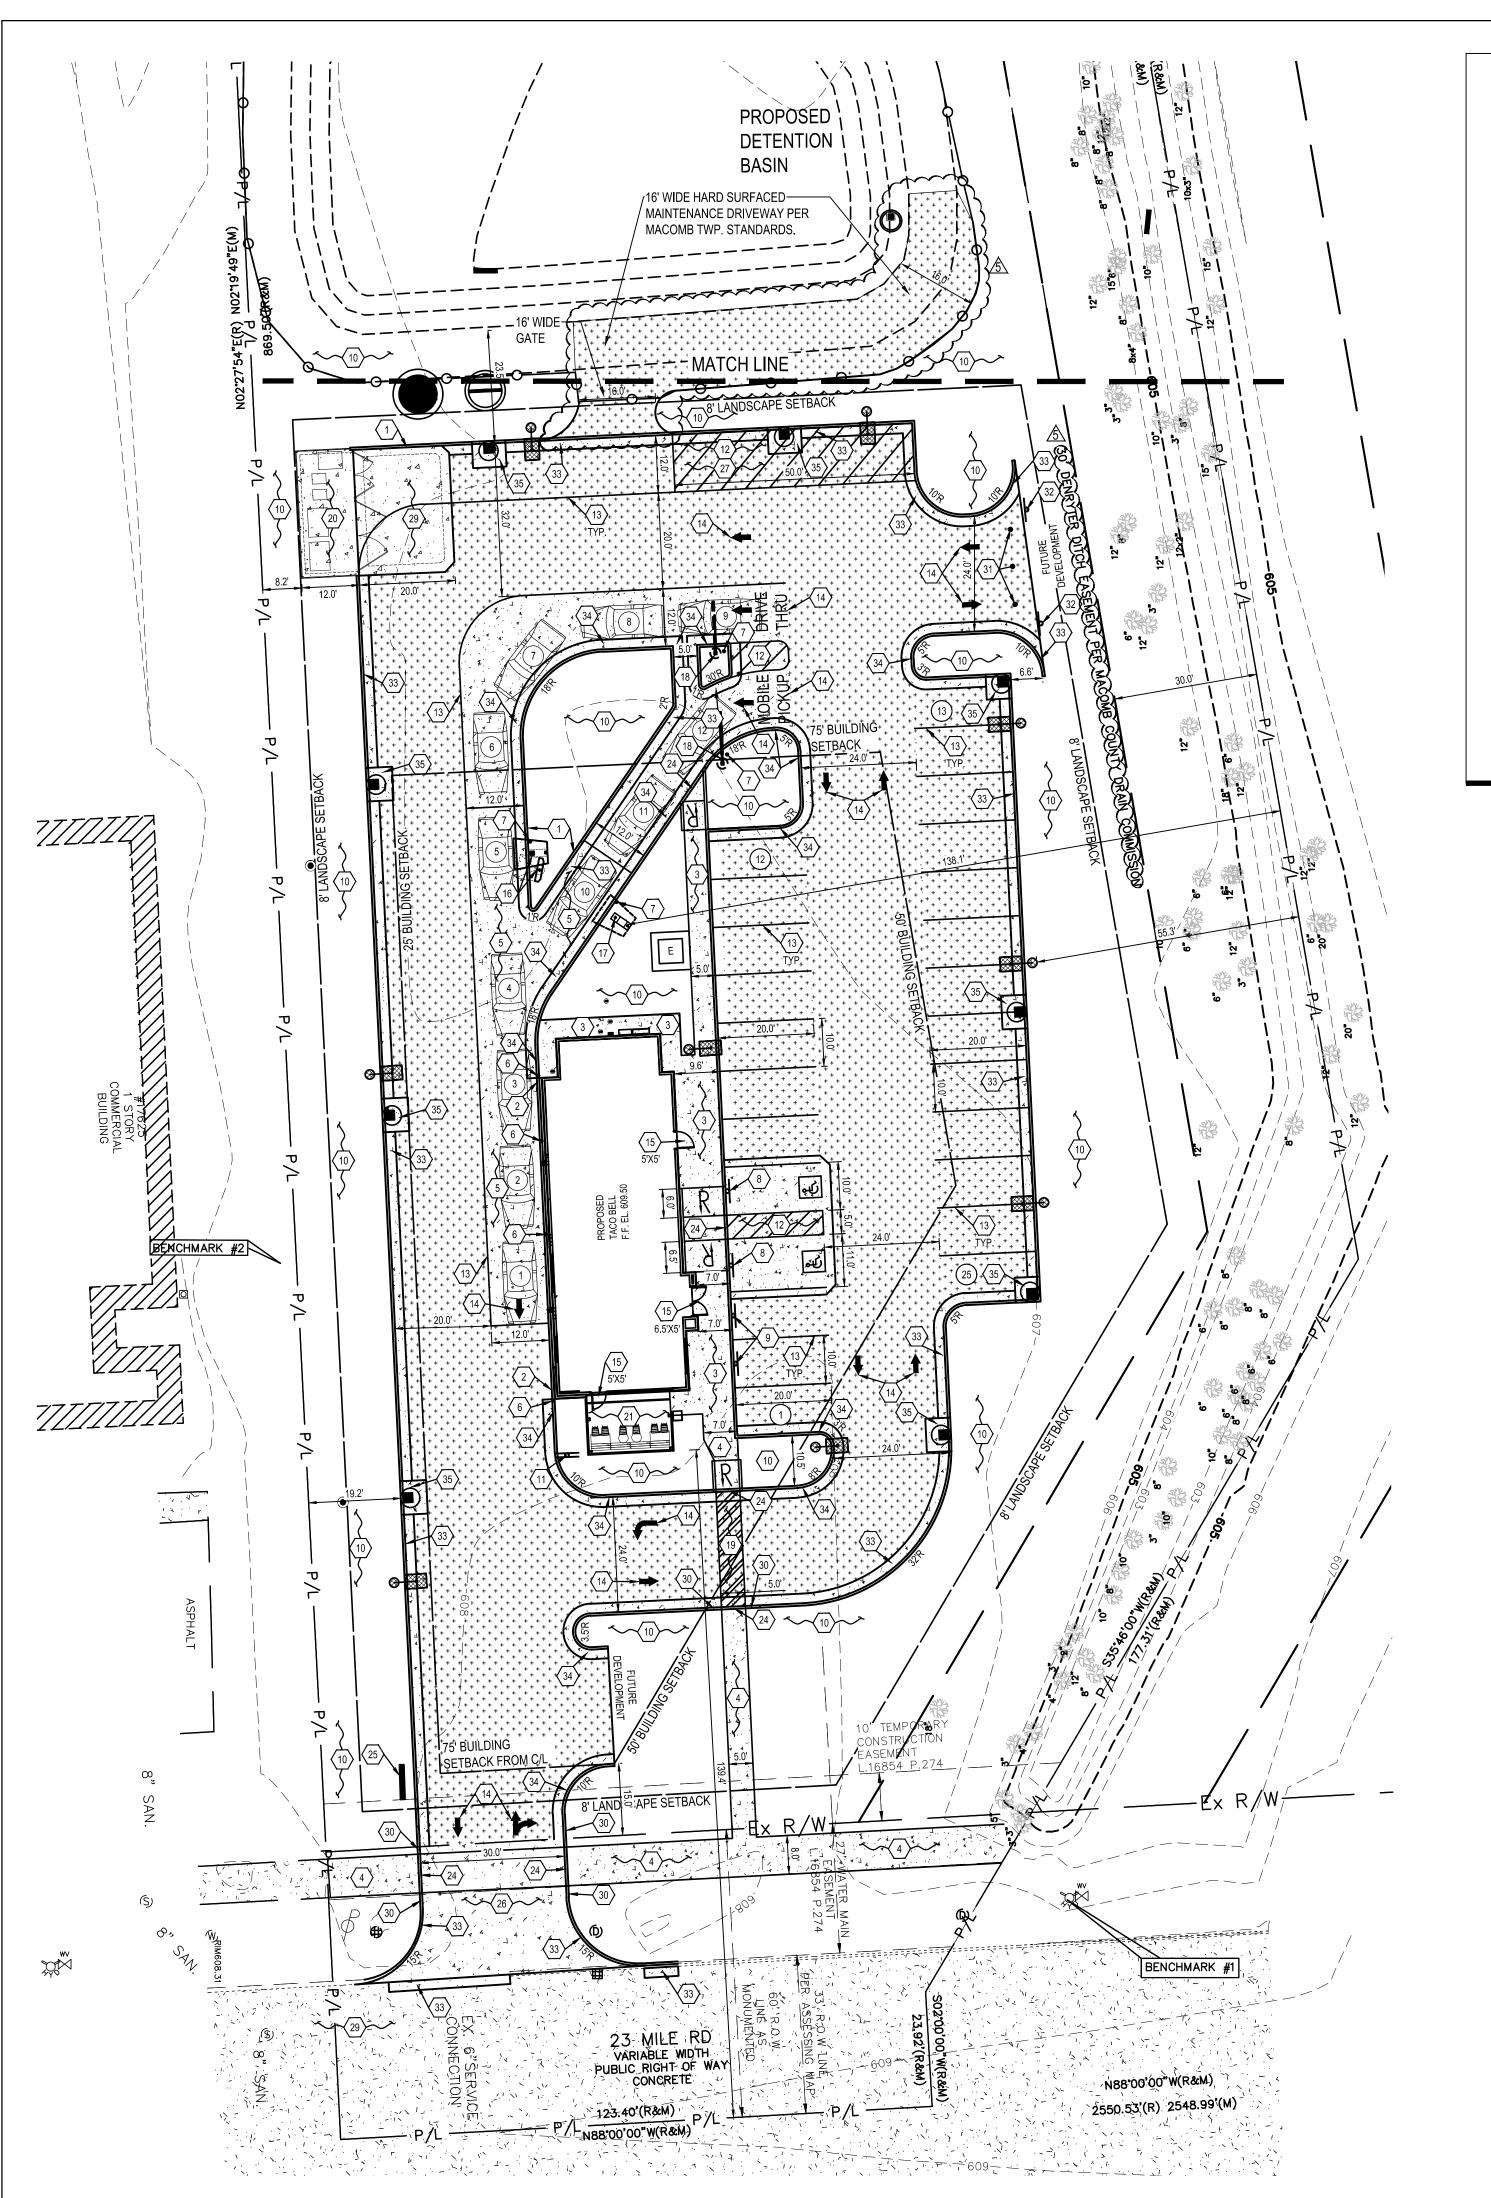
TACO BELL


17669 23 Mile Road Macomb, MI 48042

ENDEAVOR 2.0

DEMOLITION PLAN



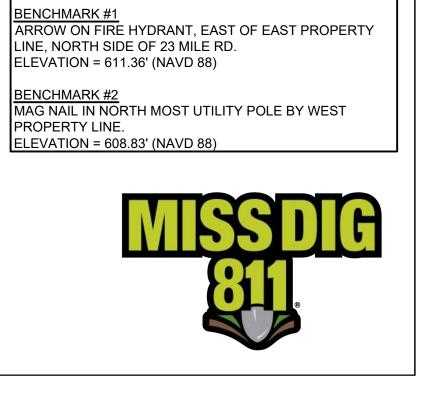

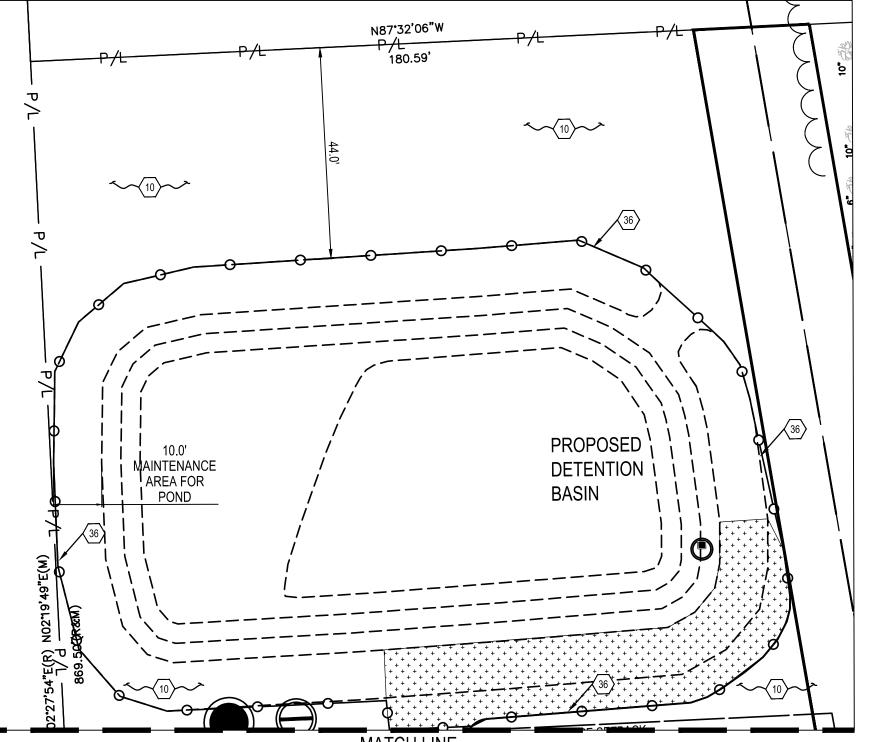

(SEE SHEET C-001 FOR GENERAL LEGEND) PROPOSED ASPHALT PAVEMENT PER MACOMB TOWNSHIP & PAVING DETAILS SEE SHEET C-506. PROPOSED CONCRETE CONSTRUCTION KEYNOTE PROPOSED PARKING SPACE NUMBER

|(00)|

PROPOSED DRIVE THRU STACK CAR AND NUMBER PROPOSED ADA ACCESSIBLE RAMP PER PER MACOMB COUNTY STANDARDS Horizontal Scale in Feet AND SPECIFICATIONS AND ADA SPECIFICATIONS. SEE SHEET C-507

PROPOSED PAINTED INTERNATIONAL ADA SYMBOL PER ADA SPECIFICATIONS. SEE SHEET C-502

PROPOSED UYILITY STRUCTURES.

PER FEMA MAP 26099C0237G EFFECTIVE DATE SEPTEMBER 29, 2006,THE PROPOSED PROPERTY IS IN ZONE X, AREA DETERMINED TO BE OUTSIDE OF THE 0.2% ANNUAL CHANCE 2. DEVELOPER SHALL BE RESPONSIBLE TO INSTALL AND MAINTAIN ALL SIDEWALKS WITHIN THE

PROPERTY LIMITS AND IN FRONT OF PROPERTY.

MACOMB TOWNSHIP STANDARD NOTES

- NOTIFY THE MACOMB TOWNSHIP BUILDING DEPARTMENT (586-992-0710) AND WATER AND SEWER DEPARTMENT (586-598-0687) A MINIMUM OF 48-HOURS PRIOR TO THE START OF CONSTRUCTION.
- ALL CONSTRUCTION MUST BE CONFORMING TO THE CURRENT STANDARDS AND SPECIFICATIONS ADOPTED
- CALL MISS DIG (1-800-482-7171) A MINIMUM OF 72-HOURS PRIOR TO THE START OF CONSTRUCTION.
- ALL SOIL EROSION AND SILT MUST BE CONTROLLED AND CONTAINED ONSITE.
- ALL EXCAVATION UNDER OR WITHIN 3-FEET OF PUBLIC PAVEMENT, EXISTING OR PROPOSED, SHALL BE BACKFILLED AND COMPACTED WITH SAND (CLASS II MDOT - MINIMUM).
- THE CONTRACTOR IS RESPONSIBLE FOR ALL DAMAGE TO EXISTING UTILITIES.
- THE CONTRACTOR IS RESPONSIBLE FOR OBTAINING ALL MACOMB TOWNSHIP PERMITS INCLUDING A PERMIT TO OCCUPY PUBLIC UTILITY EASEMENTS AND PUBLIC RIGHTS-OF-WAY.
- TRENCH BACKFILL IN COUNTY RIGHTS-OF-WAY SHALL CONFORM TO MCDOR REQUIREMENTS AND BE SUBJECT TO THE APPROVAL OF THE MCDOR ENGINEER.
- CONTACT THE OFFICE OF THE MACOMB COUNTY PUBLIC WORKS COMMISSIONER AT 586-469-5325, 48-HOURS BEFORE CONSTRUCTION.
- THE DEVELOPER SHALL BE RESPONSIBLE FOR PROVIDING POSITIVE DRAINAGE TO STORM WATER OUTLETS ON SITE TO ELIMINATE STANDING WATER IN VACANT AREAS DURING CONSTRUCTION OF THE DEVELOPMENT. THIS INCLUDES CONSTRUCTION OF ALL INDIVIDUAL HOMES/UNITS WITHIN RESIDENTIAL



PLAN KEYNOTES (#)

- NOT USED.
- PROPOSED CONCRETE CURB AT DRIVE THRU. SEE SHEET C-501
 PROPOSED CONCRETE INTERGRAL WALK/CURB PER MACOMB TOWNSHIP PAVING DETAILS. SEE
- PROPOSED CONCRETE WALK PER MACOMB TOWNSHIP PAVING DETAILS. SEE SHEET C-506. PROPOSED LIGHT DUTY 8" P.C.C. PAVEMENT WITH W.W.F. 6" X 6" - W2.9 X W2.9 CENTERED (CONTROL
- JTS. 12'-0" O.C.) OVER 6" CRUSHED AGGREGATE BASE COURSE (MDOT 21AA) APPLY LIQUID ASPHALT AT ALL JOINTS BETWEEN CONCRETE AND ASPHALT. SEE SHEET C-506. PROPOSED DETERRENT BOLLARD IN CURB. SEE SHEET C-501.
- PROPOSED DETERRENT BOLLARD. SEE SHEET C-501.
- PROPOSED HANDICAPPED PARKING SIGN. SEE SHEET C-502. PROPOSED MOBILE ORDER PICK-UP SIGN, IN BOLLARD. CONTRACTOR TO INSTALL SIGN POST AND
- BOLLARD PER THE HANDICAP SIGN DETAIL. SIGN TO BE PROVIDED BY SIGN VENDOR.
- 0. PROPOSED LÁNDSCAPING AREA.) (5).
 1. PROPOSED DO NOT ENTER' AND 'STOP' SIGN PER MOOT STANDARDS. SEE SHEET C-501.
- 2. PROPOSED PAINTED TRANSVERSE STRIPING. SEE SHEET C-501.
- 13. PROPOSED PAINTED 4" WIDE SOLID STRIPE WHITE ON ASPHALT, YELLOW ON CONCRETE, AND BLUE IN ADA AREAS. SEE SHEET C-501.
- 14. PROPOSED DIRECTIONAL PAVEMENT MARKINGS WHITE ON ASPHALT, YELLOW ON CONCRETE. SEE
- 5. PROPOSED FROST SLAB AT DOOR. SEE STRUCTURAL PLANS FOR DETAILS. 16. PROPOSED MENU BOARD AND ORDER CONFIRMATION BOARD INCLUDING SENSOR LOOP PER SIGN SUPPLIER SPECIFICATIONS. SIGN SUPPLIER TO PROVIDE A TEMPLATE FOR G.C. G.C. TO COORDINATE A MEETING WITH THE CONSTRUCTION/PROJECT MANAGER AND OPERATIONS TO VERIFY LOCATION AND PLACEMENT OF MENU BOARD AND ORDER CONFIRMATION BOARD PRIOR TO

ANY CONSTRUCTION. SIGN SUPPLIER SHALL PROVIDE G.C. WITH FOUNDATION DETAILS. G.C.

- PROPOSED ORDER CONFIRMATION BOARD INCLUDING SENSOR LOOP PER SIGN SUPPLIER SPECIFICATIONS. SIGN SUPPLIER TO PROVIDE A TEMPLATE FOR G.C. G.C. TO COORDINATE A MEETING WITH THE CONSTRUCTION/PROJECT MANAGER AND OPERATIONS TO VERIFY LOCATION AND PLACEMENT OF MENU BOARD AND ORDER CONFIRMATION BOARD PRIOR TO ANY CONSTRUCTION. SIGN SUPPLIER SHALL PROVIDE G.C. WITH FOUNDATION DETAILS. G.C.
- RESPONSIBLE FOR SIGN FOUNDATIONS/ELECTRICAL. SEE SHEET C-503. B. PROPOSED EVOLUTION PORTAL CLEARANCE BAR, SEE SHEET C-503.

RESPONSIBLE FOR SIGN FOUNDATIONS/ELECTRICAL. SEE SHEET C-503.

- 9. PROPOSED CROSSWALK. SEE SHEET C-501
- MEETING WITH THE CONSTRUCTION MANAGER TO VERIFY TYPE, LOCATION AND PLACEMENT OF FENCE PRIOR TO ANY CONSTRUCTION. OUTDOOR SEATING PER CONSTRUCTION MANAGER SPECIFICATIONS.
- 22. NOT USED.
- 23. NOT USED.
- 24. PROPOSED FLUSHED CURB. SEE SHEET C-501.
- 25. PROPOSED MONUMENT SIGN PER SIGN SUPPLIER SPECIFICATIONS. SIGN SUPPLIER SHALL DESIGN
- C-506. 27. PROPOSED 12' BY 50' LOADING / UNLOADING ZONE.
- 29. PROPOSED HEAVY DUTY 8" P.C.C. PAVEMENT WITH W.W.F. 6" X 6" W2.9 X W2.9 CENTERED (CONTROL JTS. 12'-0" O.C.) OVER 6" CRUSHED AGGREGATE BASE COURSE (MDOT 21AA) - APPLY LIQUID ASPHALT AT ALL JOINTS BETWEEN CONCRETE AND ASPHALT. SEE SHEET C-506.
- 30. PROPOSED CURB TAPER. SEE SHEET C-502.
- 1. PROPOSED TEMPORARY PORTABLE CONCRETE BOLLARDS.
- PROPOSED 'NO EXIT' SIGN, SEE SHEET C-501 33. PROPOSED CONCRETE CURB AND GUTTER PER MACOMB TOWNSHIP PAVING DETAILS. SEE SHEET
- 4. PROPOSED CONCRETE CURB AND GUTTER (REVERSE PITCH) PER MACOMB TOWNSHIP PAVING
- DETAILS. SEE SHEET C-506.

 35. PROPOSED CONCRETE COLLAR, SEE SHEET C-501.
- PROPOSED 6.0' HIGH WROUGHT-IRON STYLE DECORATIVE FENCE WITH DOUBLE OPENING ACCESS GATE 16 FEET WIDE MINIMUM PER MACOMB TWP. REQUIREMENTS.

PROPERTY DESCRIPTION (Part of P.P. # 08-17-451-002)

LAND SITUATED IN THE TOWNSHIP OF MACOMB, COUNTY OF MACOMB, STATE OF MICHIGAN, AND

A PART OF LAND LOCATED IN AND BEING PART OF THE SOUTHEAST 1/4 OF SECTION 17, TOWN 3 NORTH, RANGE 13 EAST. MACOMB TOWNSHIP, AND BEING MORE PARTICULARLY DESCRIBED AS FOLLOWS: COMMENCING AT A POINT 2550.53 FEET NORTH 88 DEGREES 00 MINUTES WEST OF THE SOUTHEAST CORNER OF SAID SECTION 17; THENCE EXTENDING NORTH 88 DEGREES 00 MINUTES WEST 123.40 FEET ALONG THE SOUTHERLY LINE OF SAID SECTION 17; THENCE NORTH 02 DEGREES 27 MINUTES 54 SECONDS EAST 869.50 FEET; THENCE ALONG THE CENTER LINE OF A DRAIN, THE FOLLOWING COURSES AND DISTANCES: SOUTH 51 DEGREES 29 MINUTES EAST 82.60 FEET; THENCE SOUTH 26 DEGREES 39 MINUTES EAST 191.76 FEET; THENCE SOUTH 04 DEGREES 40 MINUTES EAST 484.00 FEET; THENCE SOUTH 35 DEGREES 46 MINUTES WEST 177.31 FEET; THENCE SOUTH 02 DEGREES 00 MINUTES WEST 23.92 FEET TO

THE POINT OF BEGINNING CONTAINING THEREIN 2.170 ACRES OF LAND.						
BUILDING SETBACKS				PARKING SPACES		
	REQUIRED	PROVIDED			REQUIRED	PROVIDE
FRONT: 23 MILE RD.	75' FROM C/L	139.4'		NUMBER OF SPACES	28	25
RIGHT SIDE: EAST	50'	70.8'		PARKING REQUIREMENTS	<u>S</u>	
BACK: NORTH	75'	14.5'		1 SPACE PER 75 SF OF GI	ROSS AREA	•
LEFT SIDE: WEST	25'	11.8'				
LANDSCAPE S	ETBACKS	3				
	REQUIRED	PROVIDED				
FRONT: 23 MILE RD.	8.0'	81.2'		LAND USE DATA		
RIGHT SIDE: EAST	8.0'	17.0'			% OF	AREA
BACK: NORTH	8.0'	14.4'			SITE AREA	PROVIDE
LEFT SIDE: WEST	8.0'	21.2'		BUILDING	2.30%	0.05 AC.
PARKING SETE	BACKS			PAVEMENT/IMPERVIOUS	47.00%	1.02 AC.
		PROVIDED	ł	LANDSCAPING	50.70%	1.10 AC.
FRONT: 23 MILE RD.	75.0'	81.2'		TOTAL	100%	2.17 AC.
RIGHT SIDE: EAST	8.0'	17.0'		CURRENT ZONING: C-2 (C	GENERAL C	OMMERCIA
BACK: NORTH	8.0'	14.4'		DISTRICT)	SE. 12. V (2 O	CIVINIENCIA
LEFT SIDE: WEST	8.0'	21.2'		Dio i i dio i j		

BENCHMARKS AND BASIS OF BEARING

SECTION 17, AS DESCRIBED.

PROPERTY LINE.

LINE, NORTH SIDE OF 23 MILE RD. ELEVATION = 611.36' (NAVD 88)

ELEVATION = 608.83' (NAVD 88)

NORTH 88°00'00" WEST, BEING THE SOUTH LINE OF

ARROW ON FIRE HYDRANT, EAST OF EAST PROPERTY

MAG NAIL IN NORTH MOST UTILITY POLE BY WEST

REMARKS 1 | 3/8/22 | Planning Comments 2 3/21/22 Planning Comments 3 4/21/22 Issued for Permit 4 6/30/22 Macomb SESC Comment 5 7/29/22 Macomb Township Comments

GPD GROUP

Professional Corporation

520 South Main Street, Suite 2531

330.572.2100 Fax: 330.572.2102

Akron, OH 44311

CONTRACT DATE: 11.15.21 BUILDING TYPE: END. MED20 PLAN VERSION: MARCH 2021 BRAND DESIGNER: DICKSON SITE NUMBER: 315390 STORE NUMBER: 457226 PA/PM:

DRAWN BY.

JOB NO.:

TACO BELL

2021088.48


17669 23 Mile Road Macomb, MI 48042



ENDEAVOR 2.0


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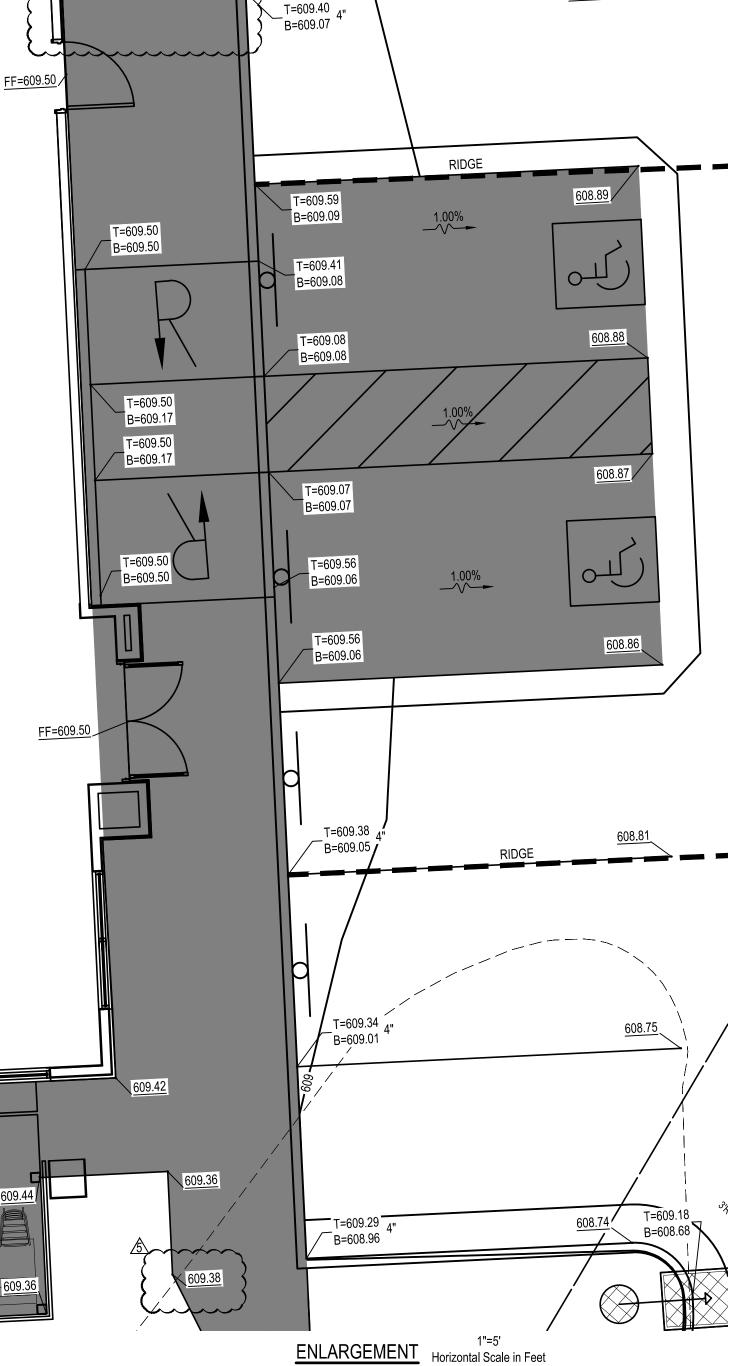
ELEVATION = 608.83' (NAVD 88)

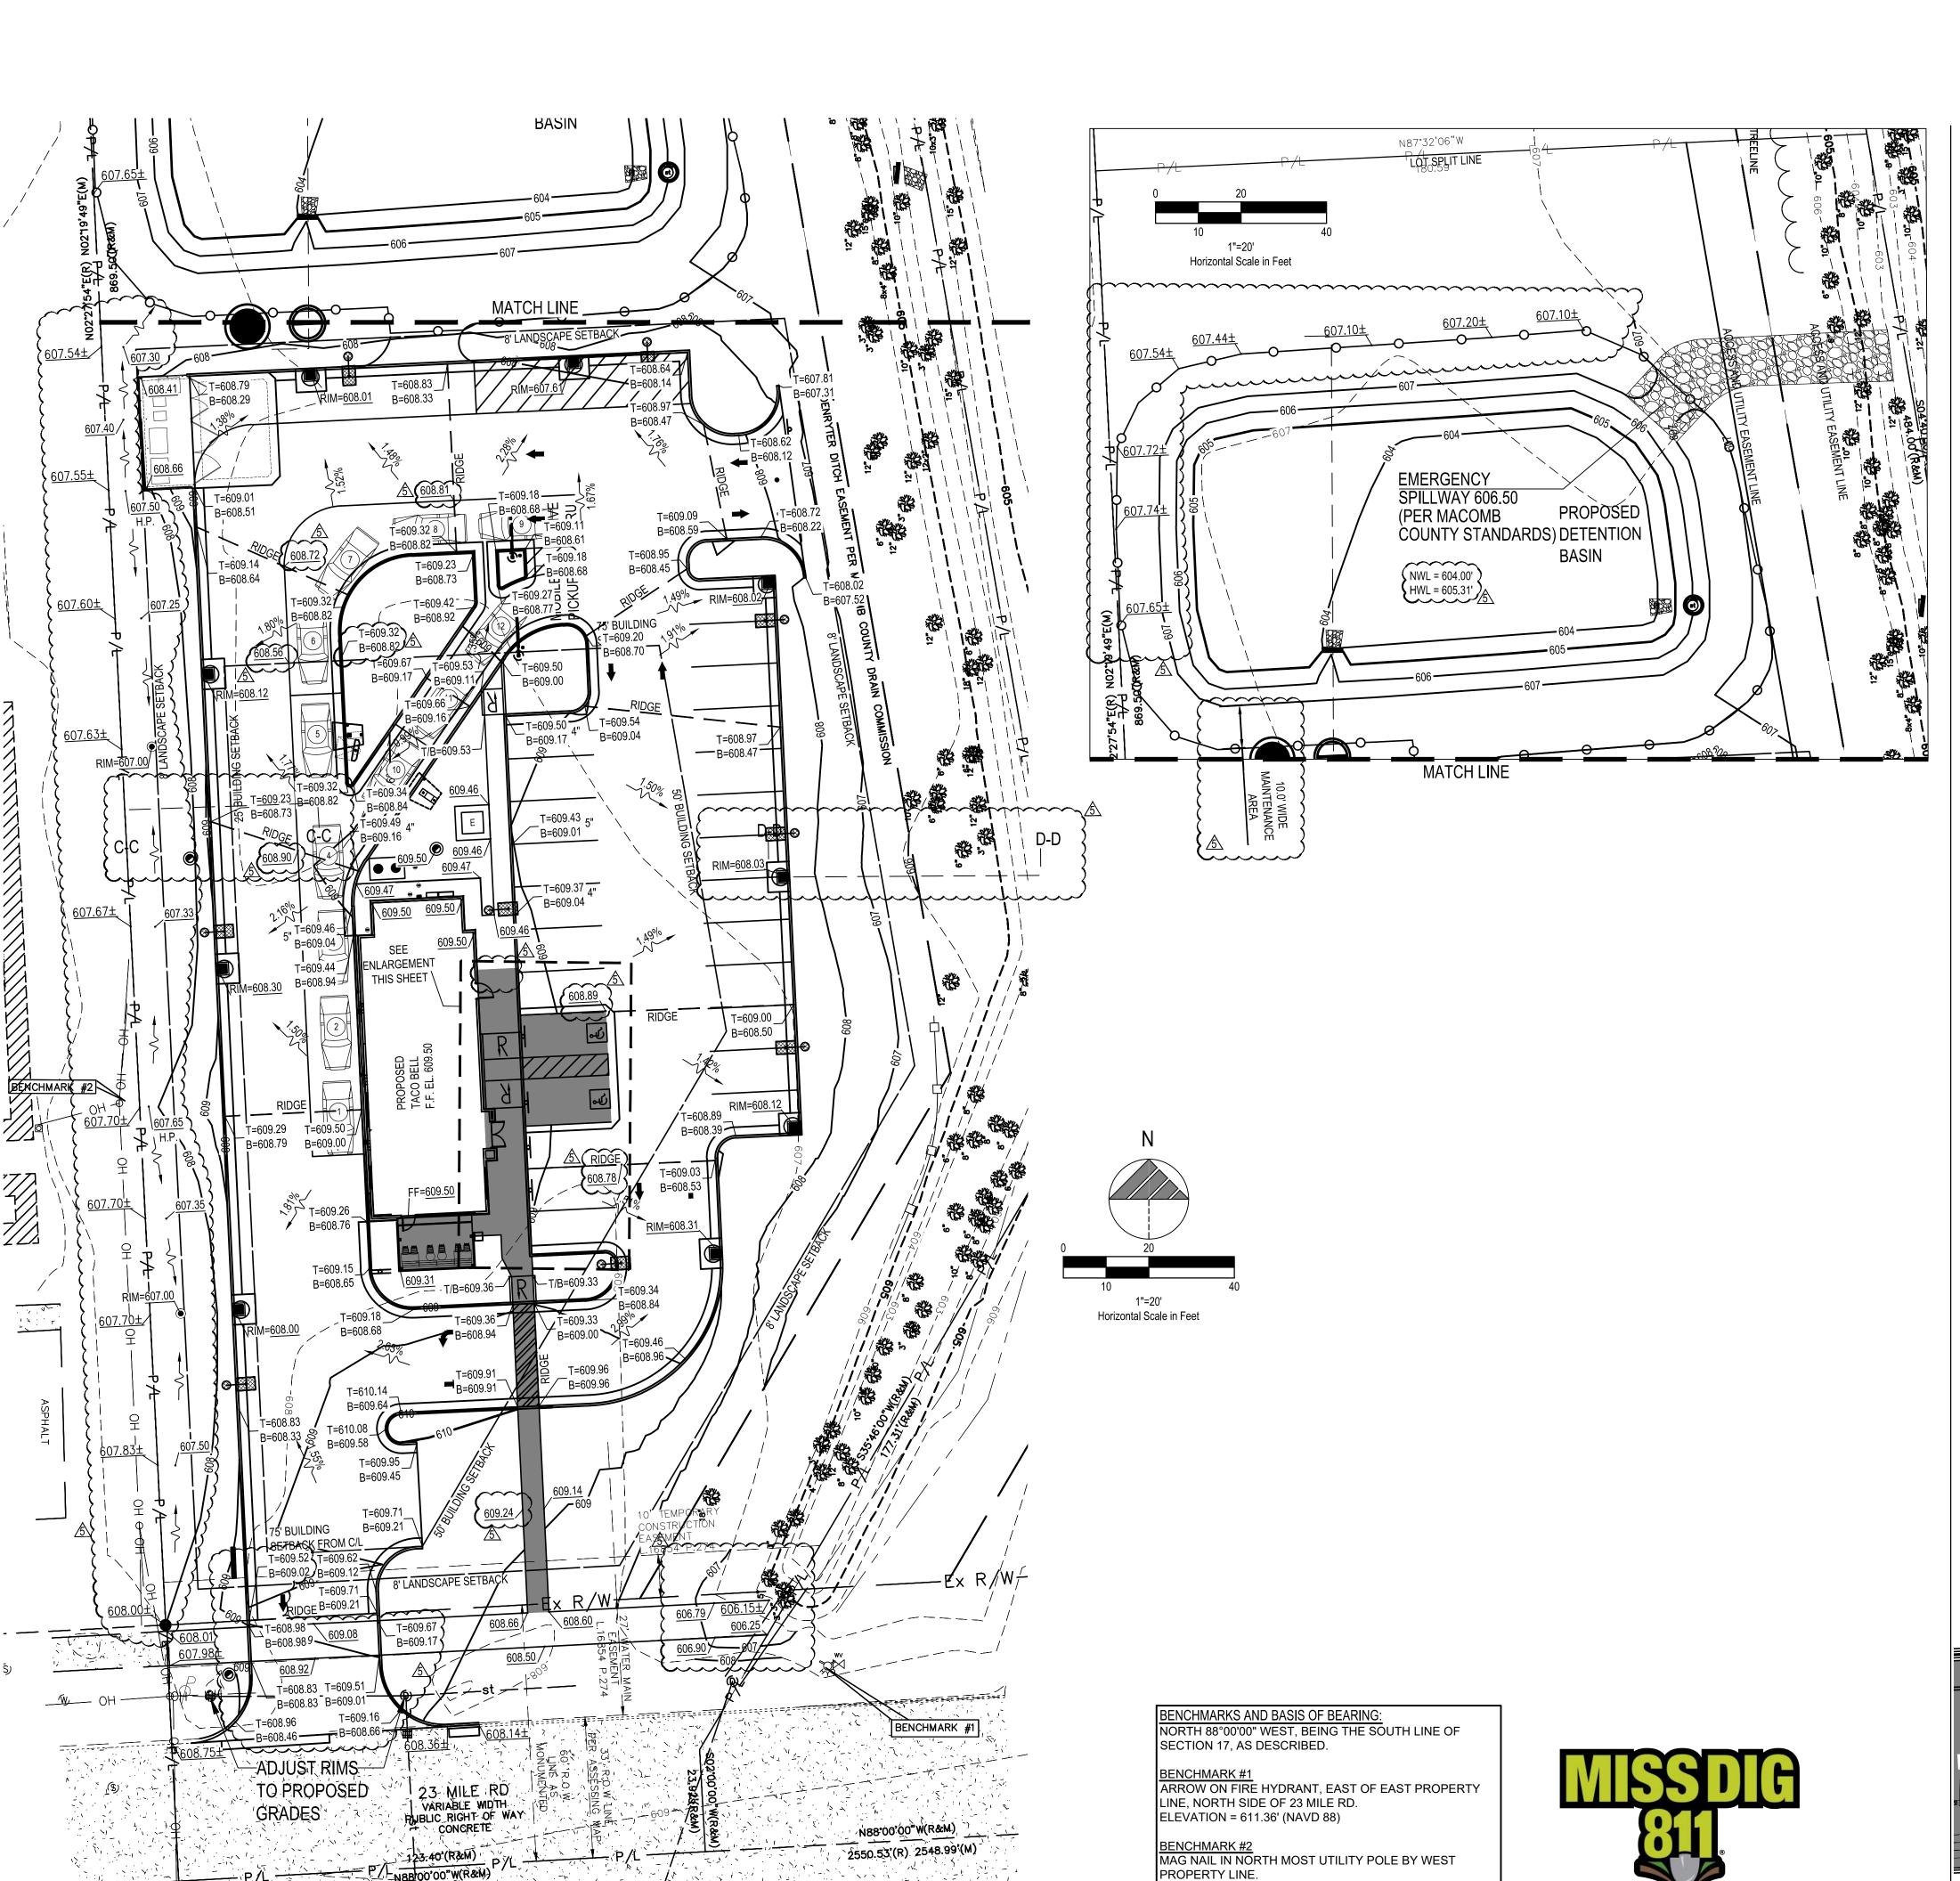

PROPOSED ELEVATION KEYNOTE

<u>608.76</u>

LIMITS OF ADA ROUTING

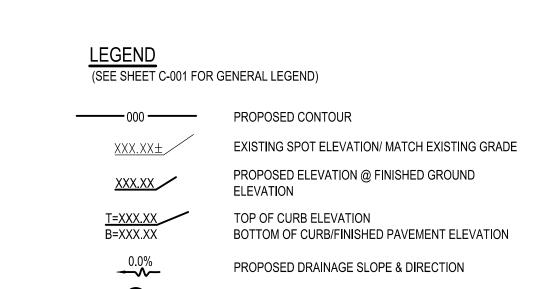

~~~~~

|  |   | DATE    | REMARKS                  |
|--|---|---------|--------------------------|
|  | 1 | 3/8/22  | Planning Comments        |
|  | 2 | 3/21/22 | Planning Comments        |
|  | 3 | 4/21/22 | Issued for Permit        |
|  | 4 | 6/30/22 | Macomb SESC Comments     |
|  | 5 | 7/29/22 | Macomb Township Comments |
|  |   |         |                          |

**GPD GROUP Professional Corporation** 

520 South Main Street, Suite 2531 Akron, OH 44311 330.572.2100 Fax: 330.572.2102

CONTRACT DATE: BUILDING TYPE: END. MED20 PLAN VERSION: MARCH 2021 BRAND DESIGNER: DICKSON SITE NUMBER: 315390 STORE NUMBER: 457226 PA/PM: DRAWN BY.

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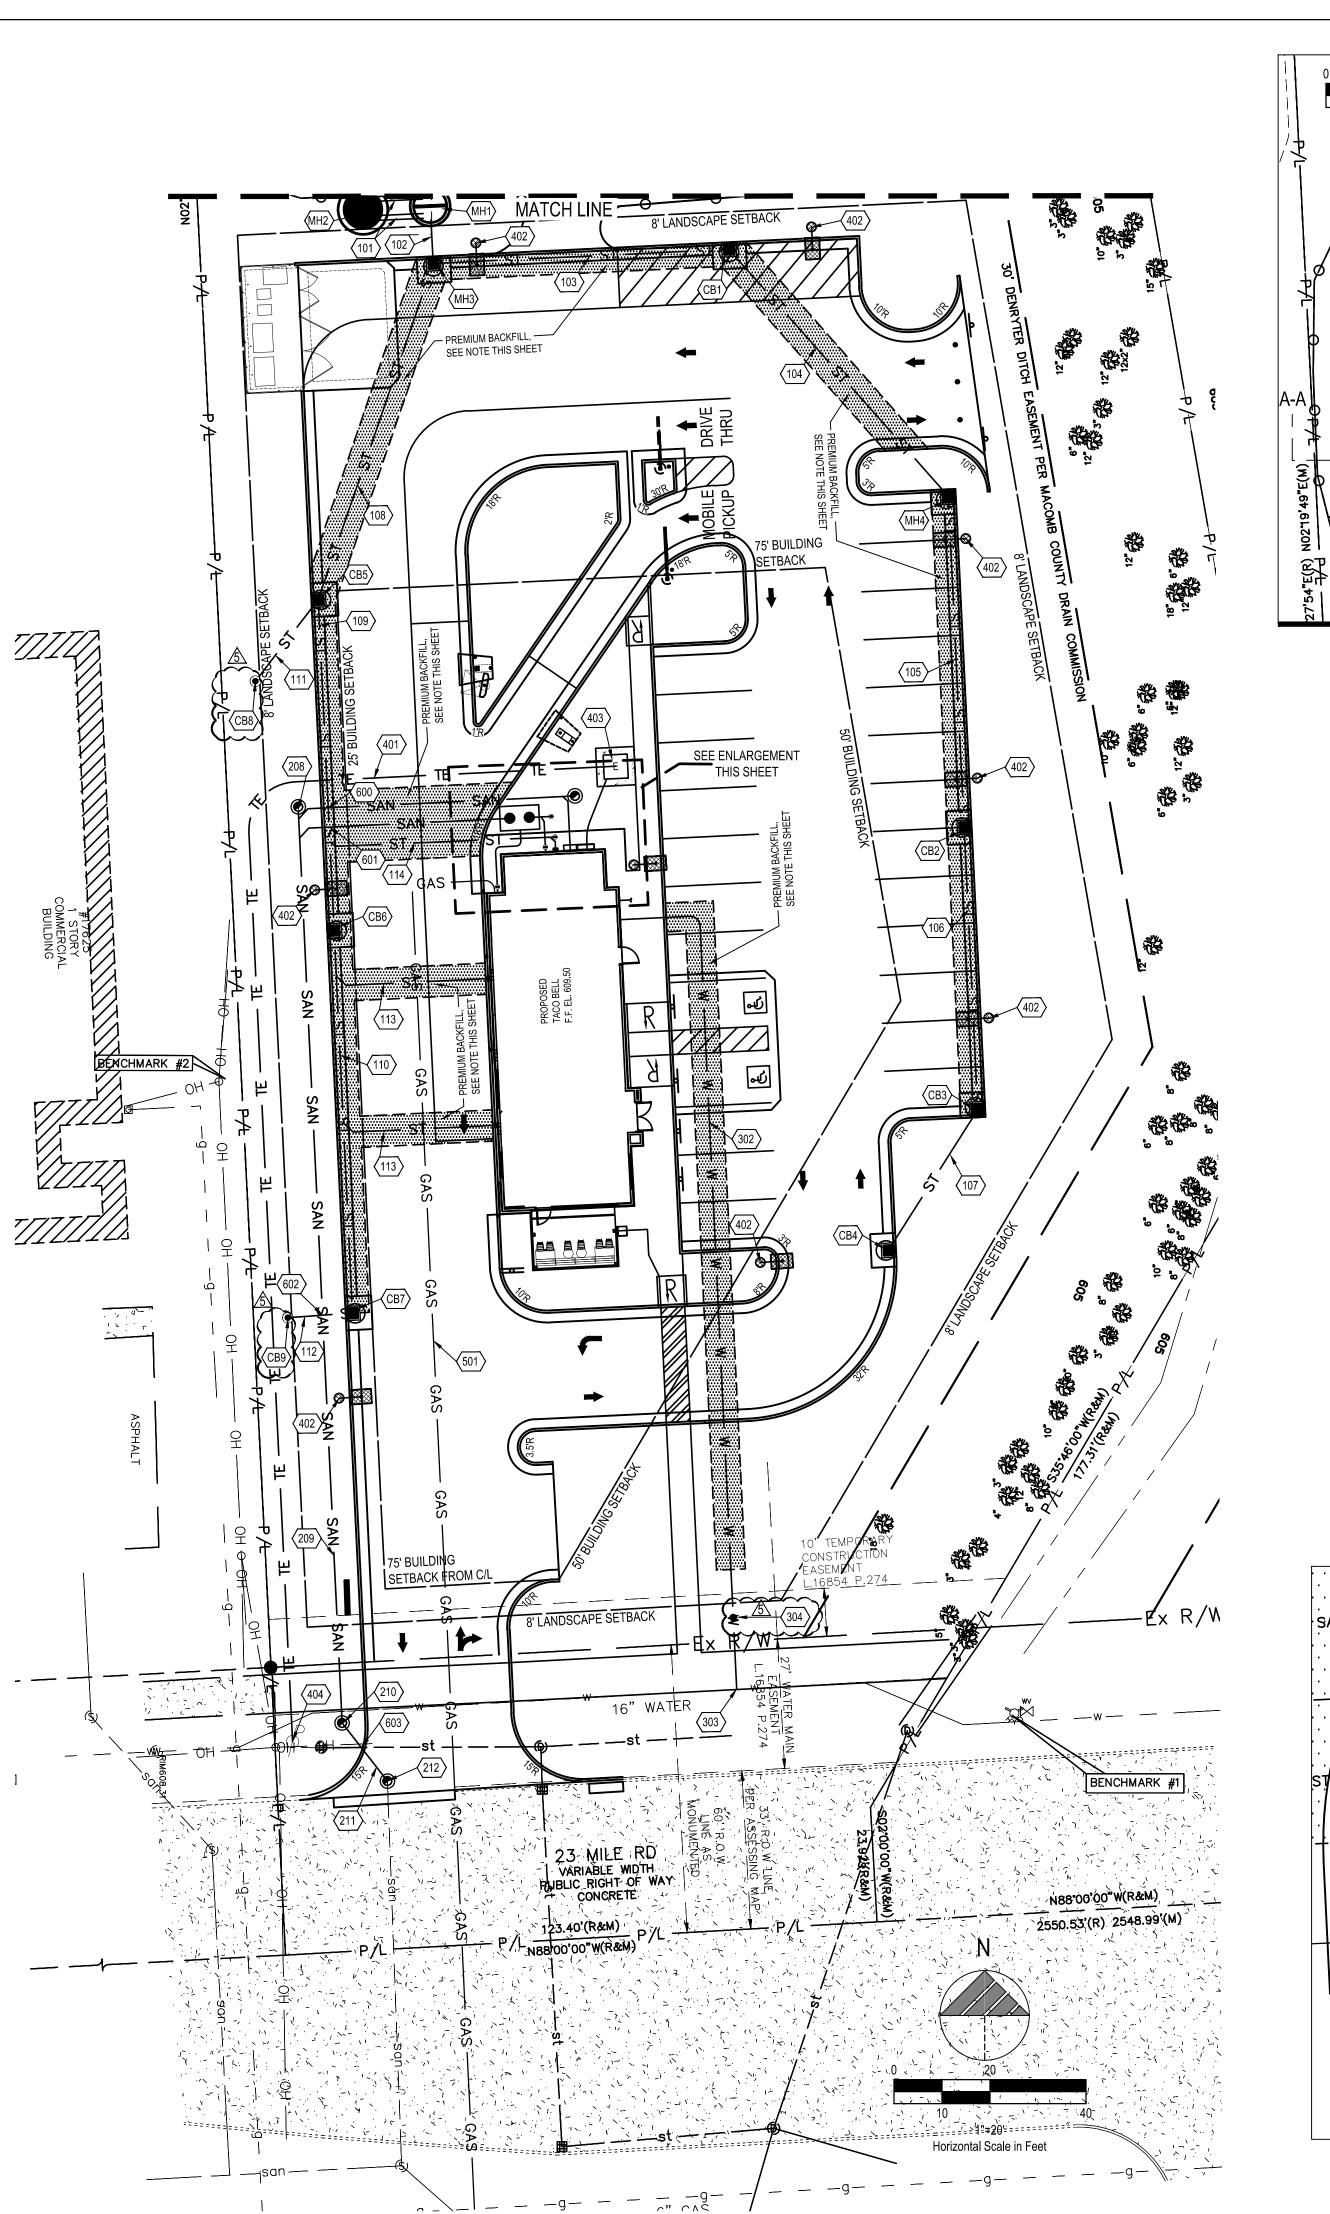
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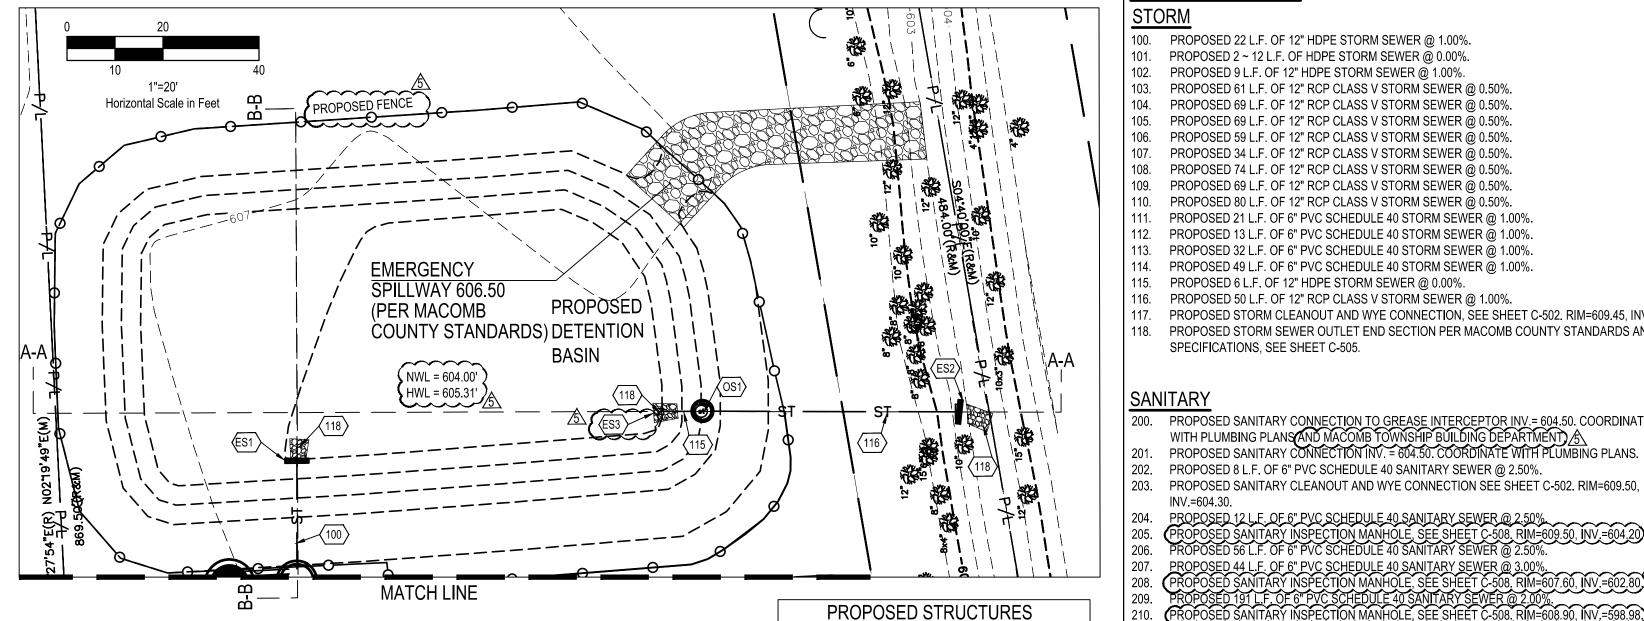
17669 23 Mile Road Macomb, MI 48042



**ENDEAVOR 2.0** 

GRADING PLAN





(SEE SHEET C-001 FOR GENERAL LEGEND)

PROPOSED STORM SEWER (12" AND SMALLER) PROPOSED SANITARY SEWER PROPOSED WATER SERVICE PROPOSED GAS SERVICE

PROPOSED UNDERGROUND ELECTRIC SERVICE PROPOSED UNDERGROUND TELEPHONE & CABLE SERVICE APPURTENANCES

UTILITY CONSTRUCTION KEYNOTE

8/N/ 301 300

ENLARGEMENT 1"=5'

Horizontal Scale in Feet

PROPOSED STORM SEWER CATCH BASIN (SEE SHEET C-505) RIM=608.30 INV. 12" (N,S) = 605.23 PROPOSED STORM SEWER CATCH BASIN (SEE SHEET C-505) RIM=608.00 INV. 12" (N) 605.63 INV. 6" (W) 605.73 PROPOSED 36" STORM SEWER CATCH BASIN (SEE SHEET C-504) RIM=606.50 INV. 6" (NE) = 605.09 PROPOSED 36" STORM SEWER CATCH BASIN (SEE SHEET C-504) RIM=607.00 INV. 6" (E) = 605.86

PROPOSED OUTLET STRUCTURE STORM SEWER MANHOLE 60" DIA. WITH FLAT TOP (SEE SHEET C-503 & C-505) RIM=606.00 INV. 12" (W) = 604.00 INV. 12" (E) = 603.75 PROPOSED 1,000 GALLON EXTERIOR GREASE INTERCEPTOR (SEE SHEET C-502) RIM=609.50

PLAN KEYNOTES (#)

STORM

100. PROPOSED 22 L.F. OF 12" HDPE STORM SEWER @ 1.00%.

101. PROPOSED 2 ~ 12 L.F. OF HDPE STORM SEWER @ 0.00%. 102. PROPOSED 9 L.F. OF 12" HDPE STORM SEWER @ 1.00%. 103. PROPOSED 61 L.F. OF 12" RCP CLASS V STORM SEWER @ 0.50%. 104. PROPOSED 69 L.F. OF 12" RCP CLASS V STORM SEWER @ 0.50%.

105. PROPOSED 69 L.F. OF 12" RCP CLASS V STORM SEWER @ 0.50%. 106. PROPOSED 59 L.F. OF 12" RCP CLASS V STORM SEWER @ 0.50%. 107. PROPOSED 34 L.F. OF 12" RCP CLASS V STORM SEWER @ 0.50%. 108. PROPOSED 74 L.F. OF 12" RCP CLASS V STORM SEWER @ 0.50%. 109. PROPOSED 69 L.F. OF 12" RCP CLASS V STORM SEWER @ 0.50%. 110. PROPOSED 80 L.F. OF 12" RCP CLASS V STORM SEWER @ 0.50%.

111. PROPOSED 21 L.F. OF 6" PVC SCHEDULE 40 STORM SEWER @ 1.00% 112. PROPOSED 13 L.F. OF 6" PVC SCHEDULE 40 STORM SEWER @ 1.00%. 113. PROPOSED 32 L.F. OF 6" PVC SCHEDULE 40 STORM SEWER @ 1.00%. 114. PROPOSED 49 L.F. OF 6" PVC SCHEDULE 40 STORM SEWER @ 1.00%.

115. PROPOSED 6 L.F. OF 12" HDPE STORM SEWER @ 0.00%. 116. PROPOSED 50 L.F. OF 12" RCP CLASS V STORM SEWER @ 1.00%

117. PROPOSED STORM CLEANOUT AND WYE CONNECTION, SEE SHEET C-502. RIM=609.45, INV. 605.52. 118. PROPOSED STORM SEWER OUTLET END SECTION PER MACOMB COUNTY STANDARDS AND SPECIFICATIONS, SEE SHEET C-505.

l SANITARY

STRCT. ID STRUCTURE DETAILS

(SEE SHEET C-505)

(SEE SHEET C-505)

INV. 12" (E)= 603.75

(SEE SHEET C-505)

(SEE SHEET C-505)

NV. 12" (N.SW) = 604.41 (NV. 12" (E) = 604.61)/5

(SEE SHEET C-505) RIM=607.71

WITH FLAT TOP AND 2.0' SUMP

INV. 12" (NW,S) = 605.27

INV. 12" (N,S) = 605.62

RIM=608.12 INV. 12" (N,SW) = 605.92

INV. 12" (NE) = 606.09

RIM=608.12 (INV. 12" (NE,S) = 604.88)

INV. 12" (W,SE) = 604.92

RIM=608.02

RIM=608.03

RIM=608.12

(SEE SHEET C-505)

(SEE SHEET C-505)

(SEE SHEET C-505) RIM=608.31

(SEE SHEET C-505)

INV 6" (SW) = 604.88

INV. 6" PVC (E)=604.25 INV. 6" PVC (W)=604.00 \* FINGER DRAIN INVERT SHALL MATCH THE BOTTOM OF THE PAVEMENT AGGREGATE BASE

INV. 12" (E) (TO MH1) = 604.32

INV. 12" (W) (FROM MH1) = 604.32

WITH FLAT TOP AND 2.0' SUMP

SOLID COVER)

ES 1 |INV. 12" (S)= 604.10

PROPOSED STORM SEWER END SECTION

PROPOSED STORM SEWER END SECTION

ES 2 (SEE SHEET C-505)

NV. 12" (W)=603.25)

PROPOSED STORM SEWER END SECTION .

PROPOSED STORM SEWER MANHOLE 84" DIA.

WITH FLAT TOP (SEE SHEET C-504 & C-505)

SOLID COVER) (NV. 12" (N)=604.32, INV. 12" (S)=604.42) (NV. 12" (W) (TO WQ UNIT) = 604.32

INV. 12" (W) (FROM WQ UNIT) = 604.32

RIM=607.45 (EJIW # 1040 FRAME WITH TYPE 'A' |

PROPOSED WATER QUALITY TREATMENT UNIT (SEE SHEET C-510)) STANDARD STORM MANHOLE 96" DIA.

RIM=607.45 (EJIW # 1040 FRAME WITH TYPE 'A' |

PROPOSED STORM SEWER MANHOLE 48" DIA.

PROPOSED STORM SEWER CATCH BASIN

PROPOSED STORM SEWER MANHOLE 48" DIA.

PROPOSED STORM SEWER CATCH BASIN

200. PROPOSED SANITARY CONNECTION TO GREASE INTERCEPTOR INV. = 604.50. COORDINATE WITH PLUMBING PLANS AND MACOMB TOWNSHIP BUILDING DEPARTMENT S. 201. PROPOSED SANITARY CONNECTION INV. = 604.50. COORDINATE WITH PLUMBING PLANS. 202. PROPOSED 8 L.F. OF 6" PVC SCHEDULE 40 SANITARY SEWER @ 2.50%.

INV =604.30

PROPOSED 12 L.F. OF 6" PVC SCHEDULE 40 SANITARY SEWER @ 2.50%.

PROPOSED SANITARY INSPECTION MANHOLE, SEE SHEET C-508, RIM=609.50, INV.=604.20

PROPOSED 56 L.F. OF 6" PVC SCHEDULE 40 SANITARY SEWER @ 2.50%.

INV. 598.65±. CONTRACTOR TO VERIFY EXISTING SANITARY SEWER LATERAL, LOCATION, SIZE AND INVERT PRIOR TO START OF ANY SANITARY SEWER WORK. ALL WORK SHALL BE

COORDINATED WITH MACOMB TOWNSHIP DEPARTMENT OF PUBLIC WORKS.

13. PROPOSED 3" VENT PVC SCHEDULE 40 FROM GREASE INTERCEPTOR.

14. PROPOSED SANITARY CLEANOUT AND WYE CONNECTION SEE SHEET C-502. RIM=609.50,

\$215. PROPOSED SANITARY CLEANOUT AND WYE CONNECTION SEE SHEET C-502. RIM=609.50, INV.=604.45.

300. PROPOSED WATER CONNECTION. COORDINATE WITH PLUMBING PLANS.

301. PROPOSED 1" IRRIGATION TAP COORDINATE WITH PLUMBING PLANS.

302. PROPOSED 177 L.F. 1-1/2( HDPE SDR 9 WITH 3 TRACER WIRES WATER SERVICE LINE.

303. PROPOSED WATER SERVICE TAP PERMACOMB TOWNSHIP WATER MAIN DETAILS.

304. PROPOSED CURB STOP PER MACOMB TOWNSHIP WATER MAIN DETAILS.

WATER METER AND BACKFLOW PREVENTOR INSIDE BUILDING PER MACOMB TOWNSHIP WATER MAIN DETAILS. BACKFLOW PREVENTOR SHALL BE LOCATED AFTER THE METER, COORDINATE ALL WORK WITH MACOMB TOWNSHIP DEPARTMENT OF PUBLIC WORKS.

**ELECTRIC AND COMMUNICATIONS** 

400. PROPOSED ELECTRIC METER PER ELECTRIC COMPANY SPECIFICATIONS. SEE BUILDING DRAWINGS FOR EXACT LOCATION. ELECTRIC SERVICE LINE TO BE COORDINATED WITH THE ELECTRIC COMPANY.

401. PROPOSED ELECTRIC AND TELECOMMUNICATIONS SERVICE LINE. 402. PROPOSED LIGHT POLE, SEE ELECTRICAL DRAWINGS FOR SPECIFICATIONS. 403. PROPOSED ELECTRICAL TRANSFORMER PER ELECTRICAL COMPANY SPECIFICATIONS. G.C.

404. PROPOSED ELECTRIC AND TELECOMMUNICATIONS SERVICE CONNECTION TO BE COORDINATED WITH THE UTILITY COMPANIES.

TO VERIFY EXACT LOCATION AND SIZE WITH UTILITY ENGINEER.

500. PROPOSED GAS METER PER GAS COMPANY SPECIFICATIONS. SEE BUILDING DRAWINGS FOR EXACT LOCATION. GAS SERVICE LINE TO BE COORDINATED WITH THE GAS COMPANY.

PROPOSED 295 L.F. GAS SERVICE LINE. 502. PROPOSED GAS SERVICE CONNECTION. COORDINATED ALL WORK WITH THE GAS COMPANY

**UTILITY CROSSINGS** 

CONTRACTOR SHALL COORDINATE ALL CROSSINGS/RELOCATIONS WITH THE RESPECTIVE UTILITY COMPANIES. EXISTING AND PROPOSED PRESSURIZED (WATER & GAS) AND SECONDARY (ELECTRIC & COMMUNICATIONS) UTILITIES SHALL DEFLECT TO MAINTAIN 18" CLEAR AT SANITARY

WHEN A PROPOSED PRESSURIZED/SECONDARY UTILITY IS IN CROSSING CONFLICT WITH AN EXISTING PRESSURIZED/SECONDARY UTILITY, THE PROPOSED UTILITY SHALL DEFLECT TO OBTAIN MINIMUM CLEARANCE CONTRACTOR SHALL FIELD LOCATE EXISTING PRESSURIZED/SECONDARY UTILITIES AT PROPOSED CROSSINGS.

OR STORM SEWER CROSSINGS WHEN CONFLICTS OCCUR.

FOR CLEARANCE BETWEEN PIPES OF LESS THAN 18", THE CONTRACTOR SHALL PROVIDE CONCRETE ENCASEMENT PER SHEET C-503.

PROP. 6" SAN. INV. = 602.88 PROP. 12" STORM INV. = 605.12

PROP. 6" SAN. INV. = 598.88
PROP. 12" STORM INV. = 602.22

NOTE: BACKFILL SHALL BE PER MDOT CLASS II SAND BACKFILL COMPACTED TO 95% MAX. DENSITY IN 6 INCH LIFTS, SEE DETAIL SHEET C-505, C-508 & C-509.

BENCHMARKS AND BASIS OF BEARING: NORTH 88°00'00" WEST, BEING THE SOUTH LINE OF SECTION 17, AS DESCRIBED.

ARROW ON FIRE HYDRANT, EAST OF EAST PROPERTY LINE, NORTH SIDE OF 23 MILE RD. ELEVATION = 611.36' (NAVD 88)

BENCHMARK #2

MAG NAIL IN NORTH MOST UTILITY POLE BY WEST PROPERTY LINE.

ELEVATION = 608.83' (NAVD 88)





|   |          | DATE    | REMARKS                  |
|---|----------|---------|--------------------------|
|   | 1        | 3/8/22  | Planning Comments        |
|   | 2        | 3/21/22 | Planning Comments        |
| Γ | 3        | 4/21/22 | Issued for Permit        |
| [ | 4        | 6/30/22 | Macomb SESC Comments     |
|   | 5        | 7/29/22 | Macomb Township Comments |
|   |          |         |                          |
| Ľ | <u> </u> | 1129122 | Macomb Township Comments |

11.15.21

CONTRACT DATE:

BUILDING TYPE: END. MED20 PLAN VERSION: MARCH 2021 **BRAND DESIGNER:** DICKSON SITE NUMBER: 315390 STORE NUMBER: 457226 PA/PM: DRAWN BY.


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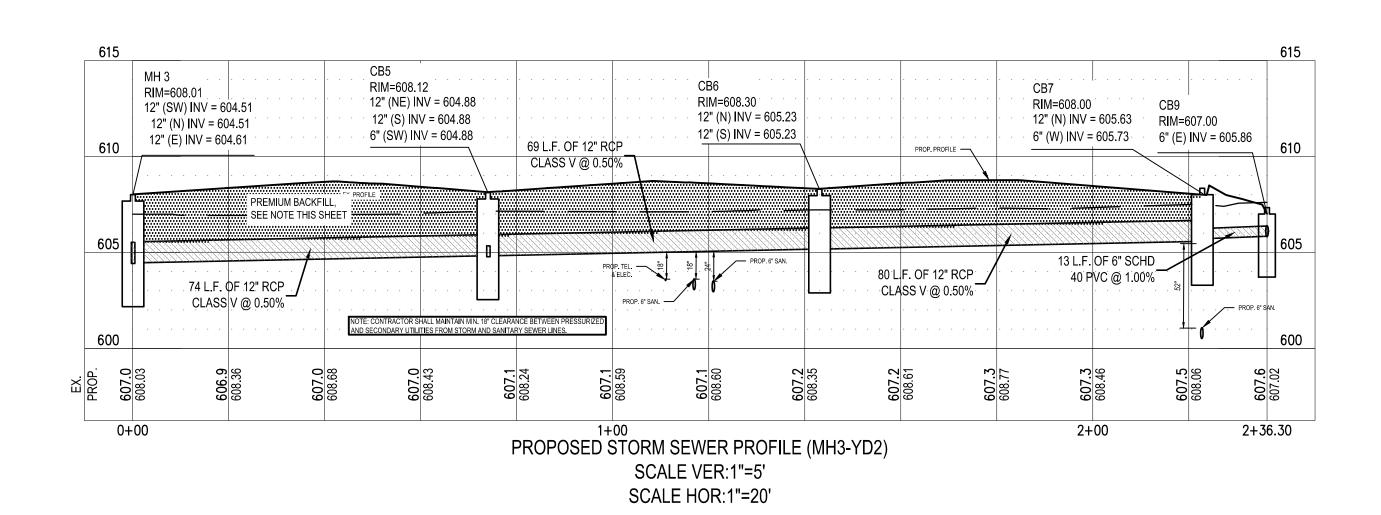
> 17669 23 Mile Road Macomb, MI 48042





**ENDEAVOR 2.0** 

UTILITY PLAN




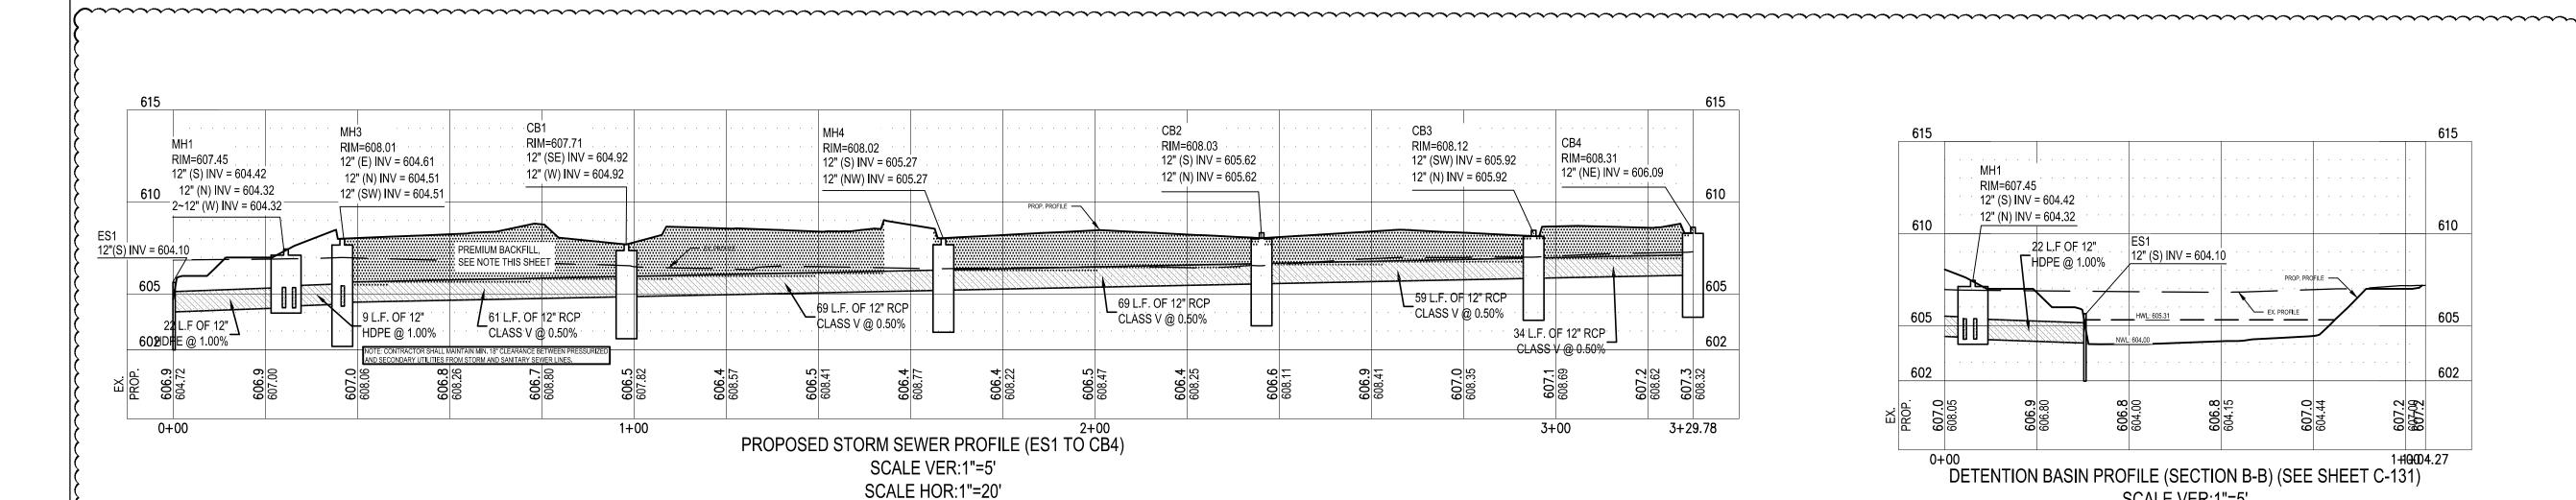

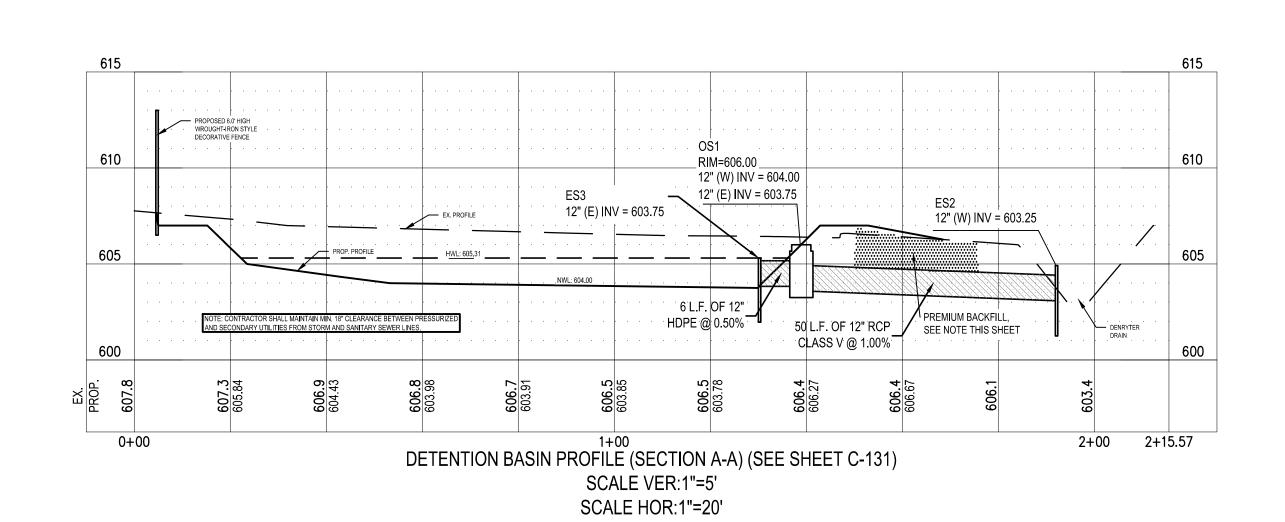


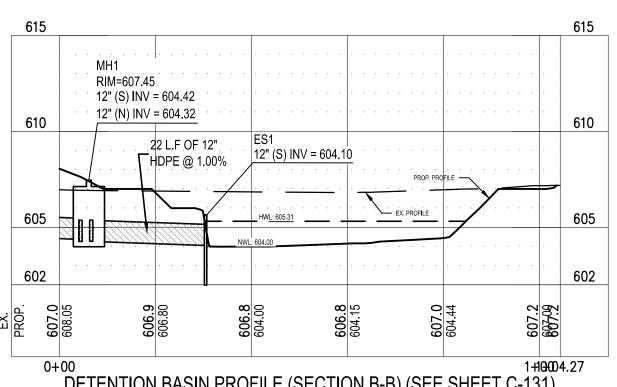


DETENTION BASIN PROFILE (SECTION B-B) (SEE SHEET C-131) SCALE VER:1"=5' SCALE HOR:1"=20'

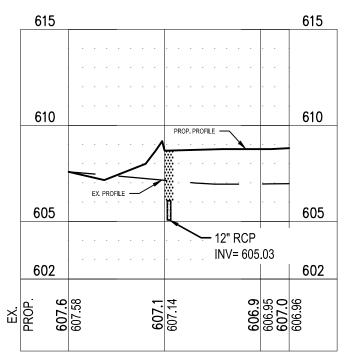

0+00 O+45.93
CROSS SECTION WEST C-C (SEE SHEET C-121) SCALE VER:1"=5' SCALE HOR:1"=20'

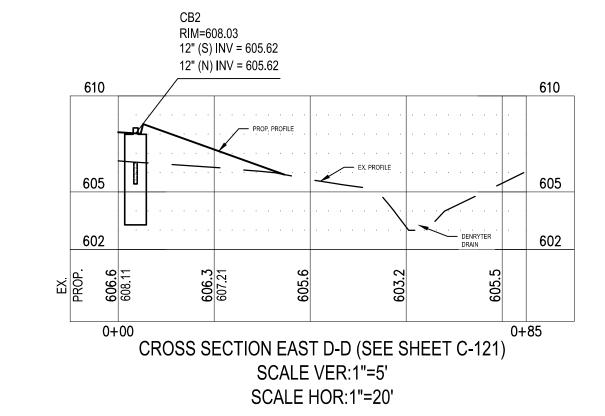

,....,

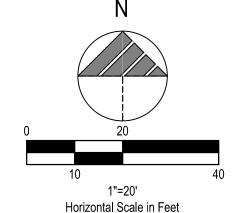



NOTE: BACKFILL SHALL BE PER MDOT CLASS II SAND BACKFILL COMPACTED TO 95% MAX. DENSITY IN 6 INCH LIFTS, SEE DETAIL SHEET C-505, C-508 & C-509.

BENCHMARKS AND BASIS OF BEARING:

NORTH 88°00'00" WEST, BEING THE SOUTH LINE OF SECTION 17, AS DESCRIBED.

BENCHMARK #1 ARROW ON FIRE HYDRANT, EAST OF EAST PROPERTY LINE, NORTH SIDE OF 23 MILE RD. ELEVATION = 611.36' (NAVD 88)

MAG NAIL IN NORTH MOST UTILITY POLE BY WEST PROPERTY LINE. ELEVATION = 608.83' (NAVD 88)

| GPD GROUP                                            |
|------------------------------------------------------|
| Professional Corporation                             |
| 520 South Main Street, Suite 2531<br>Akron, OH 44311 |
| 330.572.2100 Fax: 330.572.2102                       |
|                                                      |
|                                                      |
|                                                      |
|                                                      |
|                                                      |

|   | DATE    | REMARKS                  |
|---|---------|--------------------------|
| 1 | 3/8/22  | Planning Comments        |
| 2 | 3/21/22 | Planning Comments        |
| 3 | 4/21/22 | Issued for Permit        |
| 4 | 6/30/22 | Macomb SESC Comments     |
| 5 | 7/29/22 | Macomb Township Comments |
|   |         |                          |

CONTRACT DATE: BUILDING TYPE: END. MED20 PLAN VERSION: MARCH 2021 **BRAND DESIGNER:** DICKSON SITE NUMBER: 315390 STORE NUMBER: 457226 PA/PM: DRAWN BY.

TACO BELL


2021088.48


17669 23 Mile Road Macomb, MI 48042


JOB NO.:



**ENDEAVOR 2.0** STORM SEWER **PROFILES** 

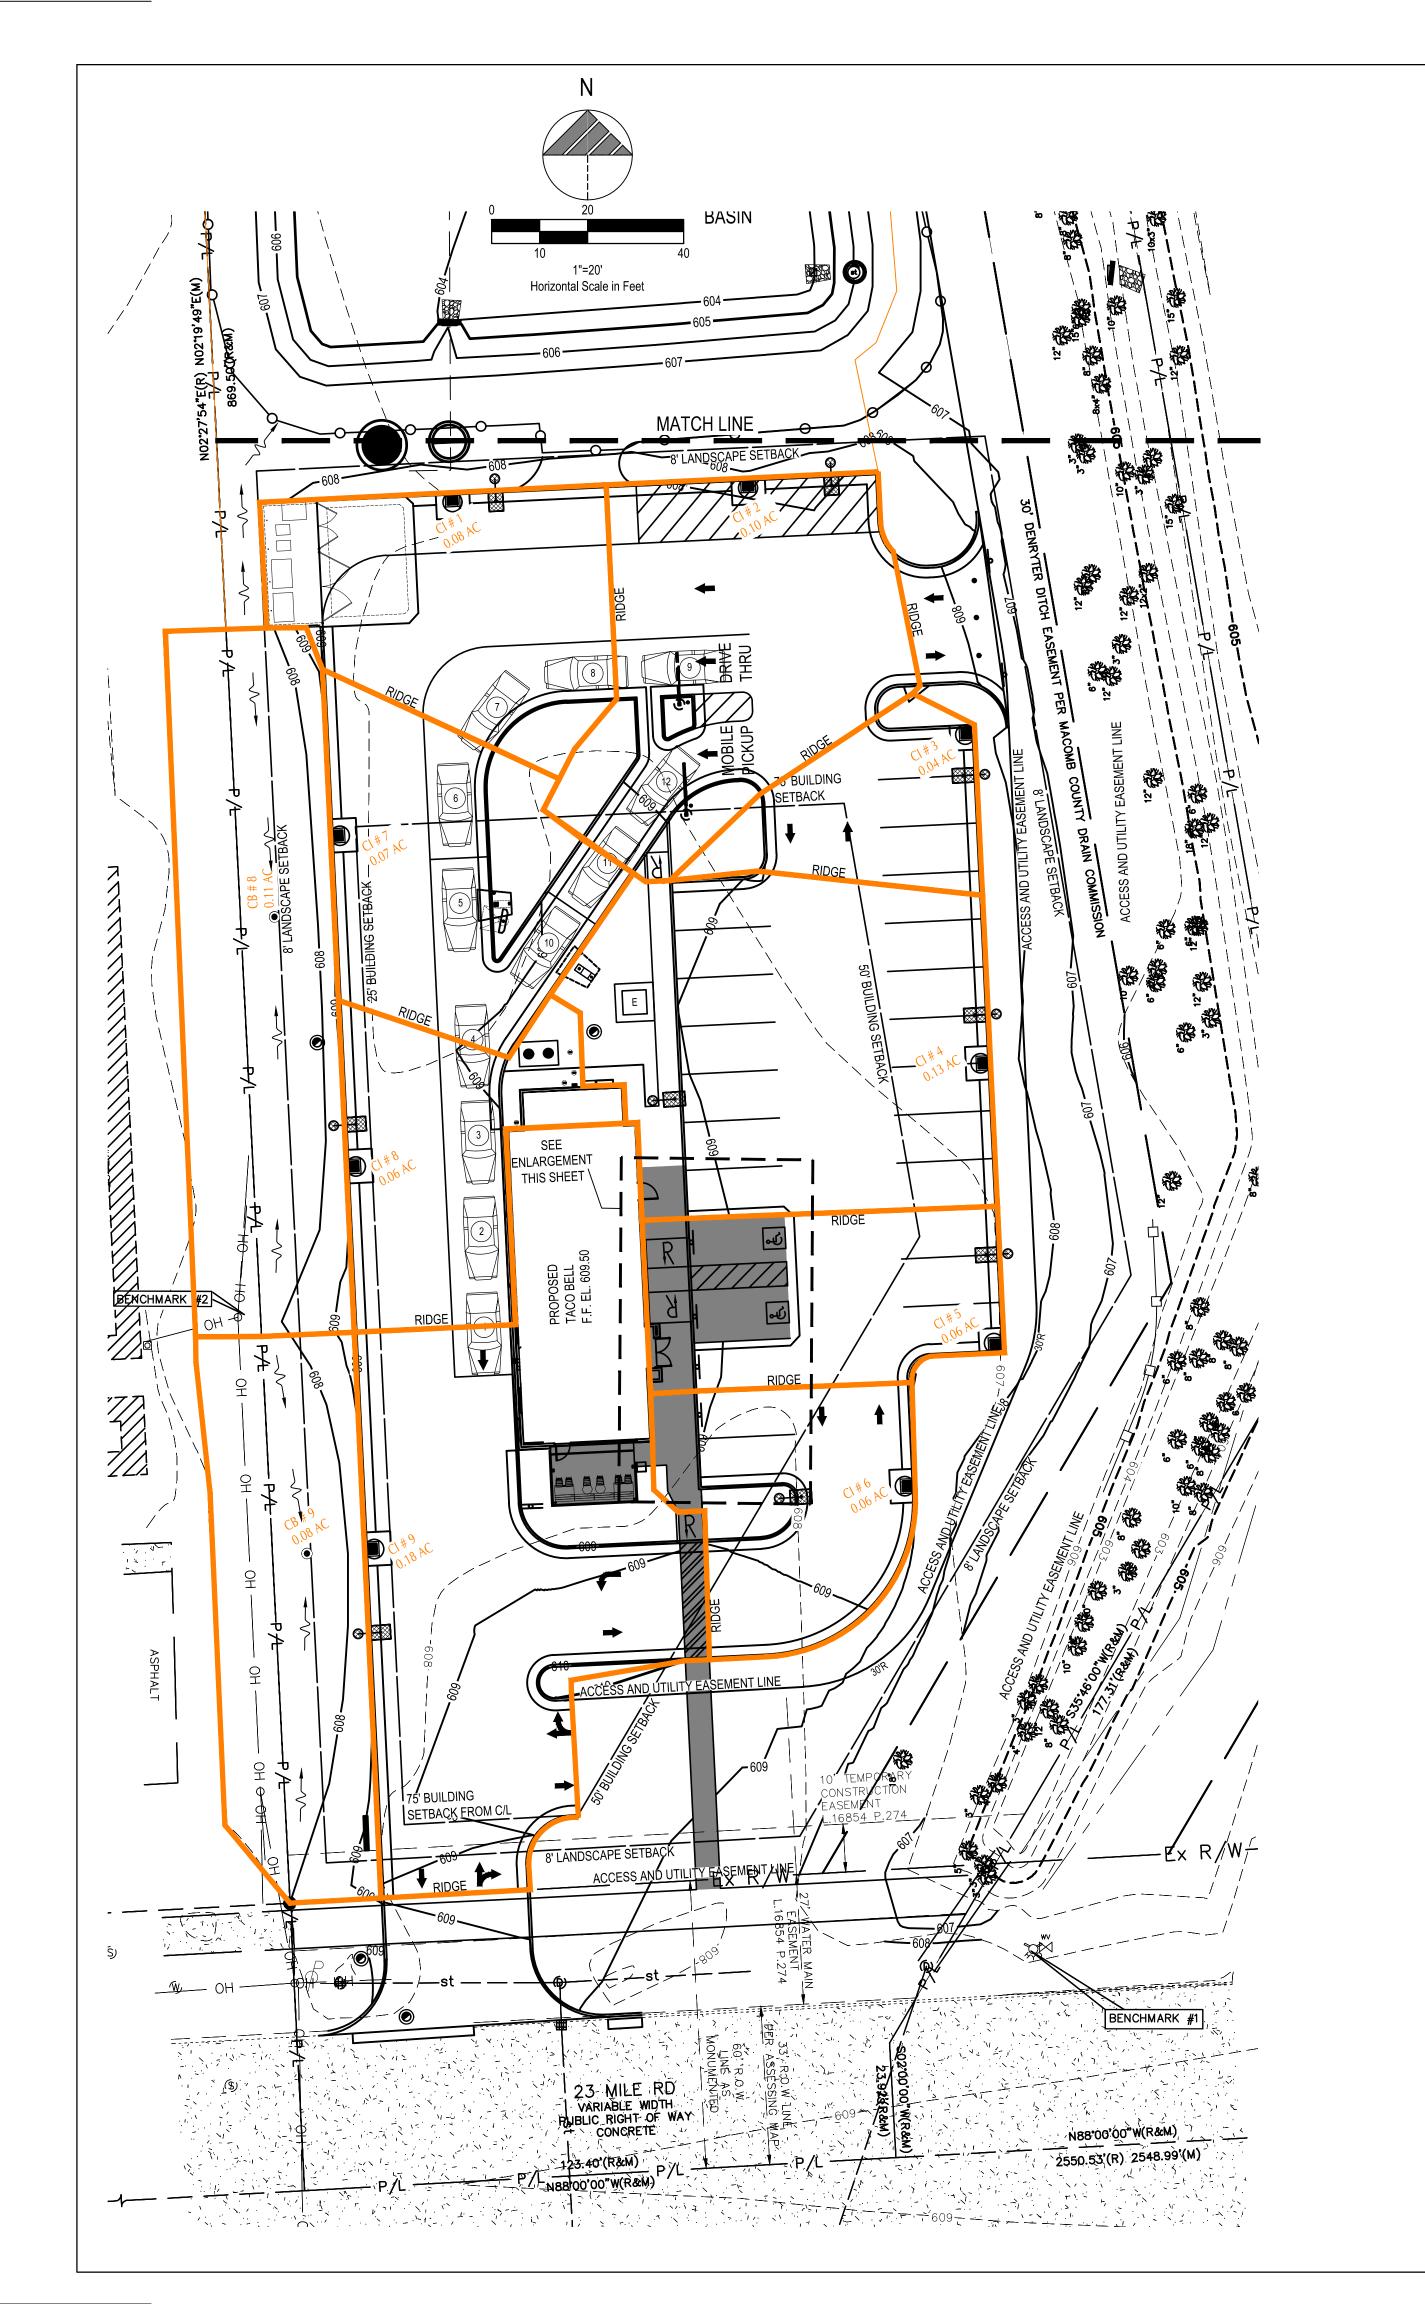


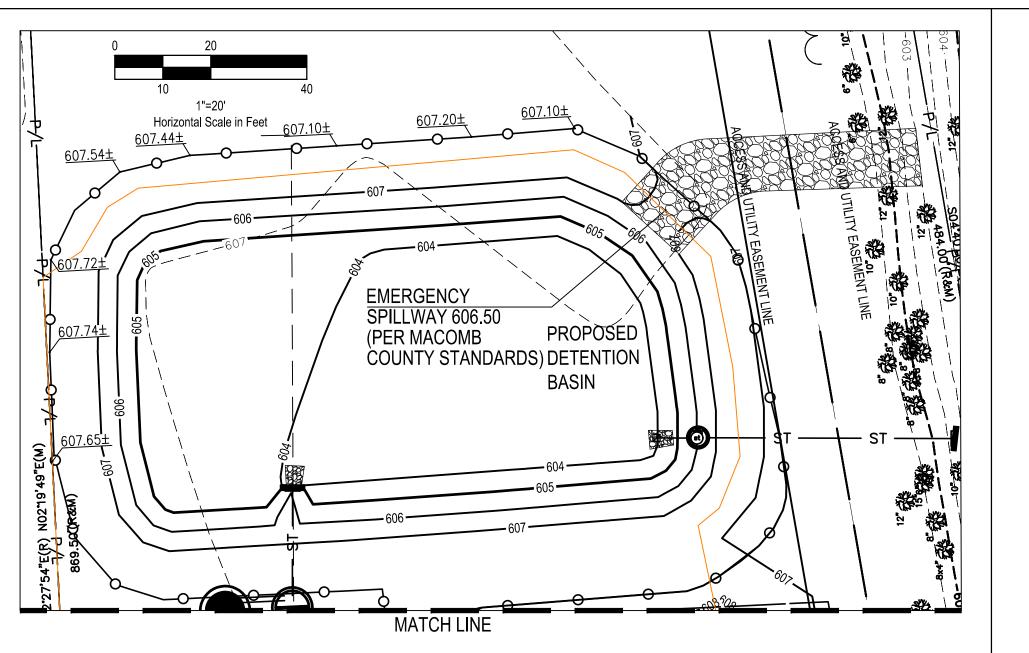

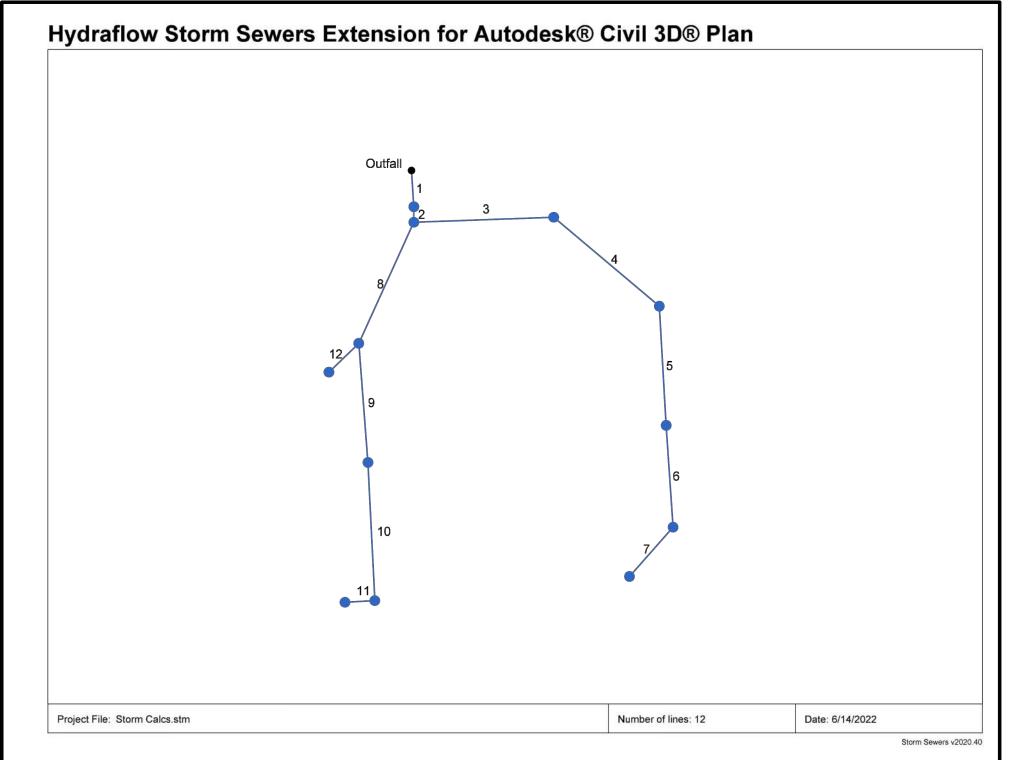

| Station                                                     | n                                                           | Len                                                                                                       | Drng A                                                                       | rea                                                                                          | Rnoff                                                        | Area x                                                                               | axC                                                                                          | Тс                                                           |                                                                                              | Rain                                                                             |                                                                                              |                                                                                      | ull    -                                                                     | Pipe                                                               | ipe Invert Elev                                              |                                                                                                            | ev                                                                                                                   | HGL Elev                                                                                                             |                                                                                                                      | Grnd / Rim Elev                                                                                  |                                                                                                            | Line ID |
|-------------------------------------------------------------|-------------------------------------------------------------|-----------------------------------------------------------------------------------------------------------|------------------------------------------------------------------------------|----------------------------------------------------------------------------------------------|--------------------------------------------------------------|--------------------------------------------------------------------------------------|----------------------------------------------------------------------------------------------|--------------------------------------------------------------|----------------------------------------------------------------------------------------------|----------------------------------------------------------------------------------|----------------------------------------------------------------------------------------------|--------------------------------------------------------------------------------------|------------------------------------------------------------------------------|--------------------------------------------------------------------|--------------------------------------------------------------|------------------------------------------------------------------------------------------------------------|----------------------------------------------------------------------------------------------------------------------|----------------------------------------------------------------------------------------------------------------------|----------------------------------------------------------------------------------------------------------------------|--------------------------------------------------------------------------------------------------|------------------------------------------------------------------------------------------------------------|---------|
| Line                                                        |                                                             |                                                                                                           | Incr                                                                         | Total                                                                                        | coeff                                                        | Incr                                                                                 | Total                                                                                        | Inlet                                                        | Syst                                                                                         |                                                                                  | flow                                                                                         | full                                                                                 |                                                                              | Size S                                                             | Slope                                                        | Dn                                                                                                         | Up                                                                                                                   | Dn                                                                                                                   | Up                                                                                                                   | Dn                                                                                               | Up                                                                                                         |         |
|                                                             | Line                                                        | (ft)                                                                                                      | (ac)                                                                         | (ac)                                                                                         | (C)                                                          |                                                                                      |                                                                                              | (min)                                                        | (min)                                                                                        | (in/hr)                                                                          | (cfs)                                                                                        | (cfs)                                                                                | (ft/s)                                                                       | (in)                                                               | (%)                                                          | (ft)                                                                                                       | (ft)                                                                                                                 | (ft)                                                                                                                 | (ft)                                                                                                                 | (ft)                                                                                             | (ft)                                                                                                       |         |
| 12<br>11<br>10<br>9<br>8<br>7<br>6<br>5<br>4<br>3<br>2<br>1 | 8<br>10<br>9<br>8<br>2<br>6<br>5<br>4<br>3<br>2<br>1<br>End | 21.000<br>13.000<br>80.000<br>69.000<br>74.000<br>34.000<br>59.000<br>69.000<br>61.000<br>9.000<br>21.000 | 0.08<br>0.18<br>0.06<br>0.07<br>0.06<br>0.06<br>0.13<br>0.04<br>0.10<br>0.08 | 0.11<br>0.08<br>0.26<br>0.32<br>0.50<br>0.06<br>0.12<br>0.25<br>0.29<br>0.39<br>0.97<br>0.98 | 0.90<br>0.90<br>0.90<br>0.90<br>0.90<br>0.90<br>0.90<br>0.90 | 0.10<br>0.07<br>0.16<br>0.05<br>0.06<br>0.05<br>0.12<br>0.04<br>0.09<br>0.07<br>0.01 | 0.10<br>0.07<br>0.23<br>0.29<br>0.45<br>0.05<br>0.11<br>0.23<br>0.26<br>0.35<br>0.87<br>0.88 | 10.0<br>10.0<br>10.0<br>10.0<br>10.0<br>10.0<br>10.0<br>10.0 | 10.0<br>10.0<br>10.1<br>11.0<br>11.7<br>10.0<br>11.7<br>13.1<br>14.0<br>14.7<br>15.2<br>15.2 | 5.0<br>5.0<br>4.9<br>4.7<br>4.6<br>5.0<br>4.6<br>4.3<br>4.1<br>4.0<br>3.9<br>3.9 | 0.49<br>0.36<br>1.15<br>1.35<br>2.05<br>0.27<br>0.49<br>0.96<br>1.08<br>1.41<br>3.43<br>3.46 | 0.61<br>0.61<br>2.73<br>2.75<br>2.73<br>2.75<br>2.75<br>2.75<br>2.75<br>3.86<br>3.95 | 2.50<br>2.39<br>2.82<br>2.61<br>3.47<br>1.80<br>2.50<br>2.63<br>5.14<br>5.16 | 6<br>6<br>12<br>12<br>12<br>12<br>12<br>12<br>12<br>12<br>12<br>12 | 1.00<br>1.00<br>0.50<br>0.51<br>0.50<br>0.51<br>0.51<br>0.51 | 604.78<br>605.53<br>605.13<br>604.78<br>604.41<br>605.72<br>605.07<br>604.72<br>604.41<br>604.32<br>604.10 | 604.99<br>605.66<br>605.53<br>605.13<br>604.78<br>605.89<br>605.72<br>605.42<br>605.07<br>604.72<br>604.41<br>604.32 | 605.57<br>605.98<br>605.74<br>605.57<br>605.20<br>606.01<br>605.83<br>605.51<br>605.46<br>605.20<br>605.11<br>604.90 | 605.71<br>605.96<br>605.98<br>605.66<br>605.42<br>606.10<br>606.01<br>605.83<br>605.51<br>605.27<br>605.20<br>605.11 | 608.12<br>608.00<br>608.30<br>608.12<br>608.01<br>608.02<br>607.61<br>608.01<br>607.45<br>606.00 | 607.00<br>607.00<br>608.00<br>608.30<br>608.31<br>608.12<br>608.03<br>608.02<br>607.61<br>608.01<br>607.45 |         |
| Proje                                                       | ect File:                                                   | Storm (                                                                                                   | Calcs.st                                                                     | m                                                                                            |                                                              |                                                                                      |                                                                                              |                                                              |                                                                                              |                                                                                  |                                                                                              |                                                                                      |                                                                              |                                                                    |                                                              | Number                                                                                                     | of lines: 1                                                                                                          | 2                                                                                                                    |                                                                                                                      | Run Da                                                                                           | te: 6/14/20                                                                                                | 022     |



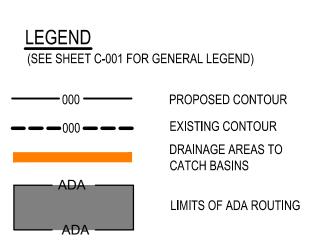

|   | DATE    | REMARKS                  |
|---|---------|--------------------------|
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|   |         |                          |

CONTRACT DATE: 11.15.21

BUILDING TYPE: END. MED20

PLAN VERSION: MARCH 2021

BRAND DESIGNER: DICKSON

SITE NUMBER: 315390

STORE NUMBER: 457226

PA/PM: SM

DRAWN BY.: EA

TACO BELL

2021088.48

JOB NO.:

17669 23 Mile Road Macomb, MI 48042



ENDEAVOR 2.0
STORM SEWER DA
MAP AND
CALCULATIONS

C-133

PLOT DATE:



BENCHMARKS AND BASIS OF BEARING: NORTH 88°00'00" WEST, BEING THE SOUTH LINE OF SECTION 17, AS DESCRIBED.


BENCHMARK #1
ARROW ON FIRE HYDRANT, EAST OF EAST PROPERTY
LINE, NORTH SIDE OF 23 MILE RD.

ELEVATION = 608.83' (NAVD 88)

ELEVATION = 611.36' (NAVD 88)

BENCHMARK #2

MAG NAIL IN NORTH MOST UTILITY POLE BY WEST PROPERTY LINE.

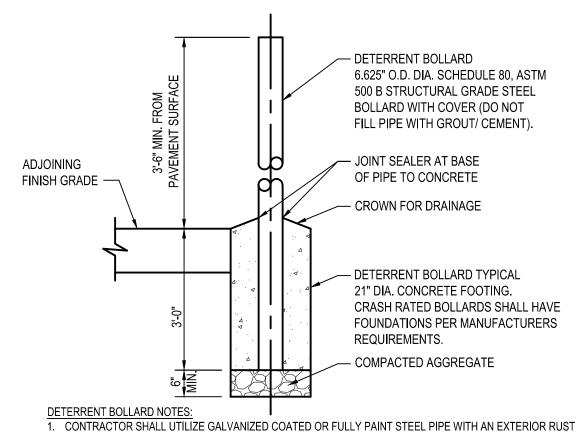



INHIBITIVE PAINT PRIOR TO INSTALLATION AND TOUCH UP AFTER INSTALLATION SUCH AS SHERWIN-WILLIAMS MACROPOXY 646 FAST CURE (B58W610), IN ACCORDANCE WITH MANUFACTURERS PREPARATION REQUIREMENTS. PROVIDE A YELLOW (BLUE FOR ADA) BOLLARD COVER SUCH AS A STREET SMART SOLUTIONS POST GUARD, DOME-TOP COVER BY US-POSTMAN.COM OR APPROVED EQUAL.

WHERE BOLLARDS ARE SEPARATING PEDESTRIANS / STOREFRONTS AND VEHICLES THE CONTRACTOR SHALL INSTALL A CRASH RATED BOLLARD AND FOOTING PER ASTM F3016/3016M. TYPICAL CLEAR SPACING OF 60" WITH AN ANTICIPATED S20 RATING FOR BIDDING PURPOSES - FINAL SPACING AND RATING SHALL BE IN ACCORDANCE WITH ASTM AND THE MANUFACTURERS REQUIREMENTS FOR PROPOSED LOCATIONS AND POSSIBLE VEHICLE APPROACH SPEED. THE NOTED ASTM CRASH RATED PRODUCT SUCH AS, BUT NOT LIMITED TO, CRASHCORE BOLLARD BY MCCUE.COM OR APPROVED CRASH RATED EQUIVALENT SHALL BE UTILIZED IN ACCORDANCE WITH MANUFACTURE SPECIFICATIONS. INSTALLER / CONTRACTOR SHALL BE OR



CONCRETE COLLAR

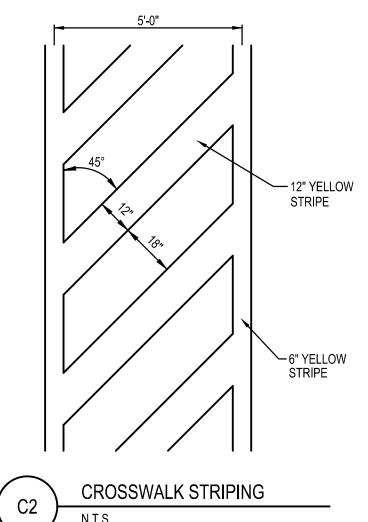


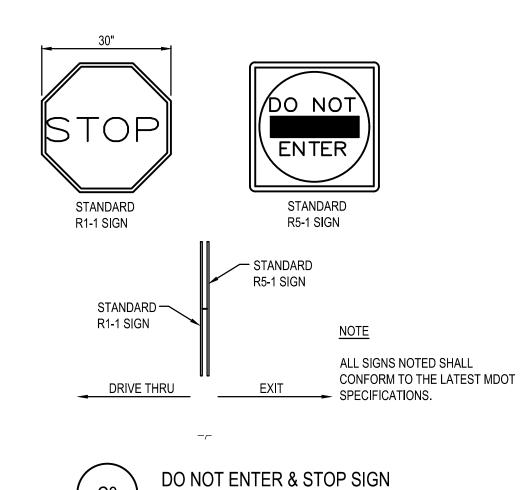

6.625" O.D. DIA. SCHEDULE

GRADE STEEL BOLLARD

80, ASTM 500 B STRUCTURAL

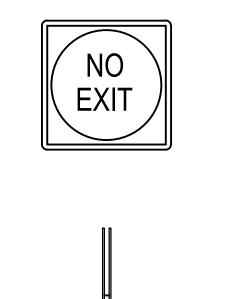



- CURB AT DRIVE


ELSEWHERE

· 1/2" PRE-MOLDED EXP.

THRU AS DETAILED

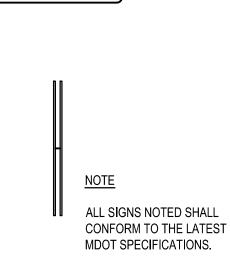

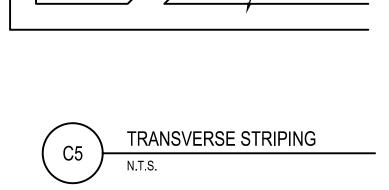

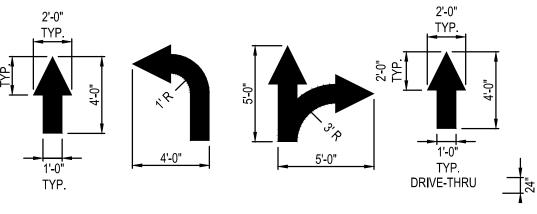

— 4" WHITE STRIPE ON

ASPHALT/ YELLOW ON CONCRETE AND

BLUE IN ADA AREAS


ALL PAVEMENT MARKINGS TO BE WHITE PAVEMENT PAINT, UNLESS STATED OTHERWISE. ALL PAVEMENT MARKINGS WITHIN ADA AREAS SHALL BE PAINTED BLUE EXCEPT FOR COLORS DEFINED ON THE ADA PAVEMENT SYMBOL.


MARKING (STRIPING) PAINT FOR PARKING SPACES, TRAFFIC ARROWS, ADA PARKING AND SYMBOLS, ETC., PER LOCAL REQUIREMENTS AND AS FOLLOWS:


PAINT SHALL BE WATER BASE FAST DRYING 100% ACRYLIC TYPE: WATER BASE TO MEET FEDERAL SPECIFICATION TTP-01952B. FOR COLD WEATHER APPLICATION PAINT PRODUCT SHALL BE IN ACCORDANCE WITH ASTM-D2369, D1394, D3723, D1475, D562 AND


PROVIDE A NON-SLIP AGGREGATE ADDITIVE TO MARKING PAINT USED AT ADA ACCESS

APPLY 2 COATS WITH STRAIGHT EDGES, YELLOW ON CONCRETE/WHITE ON ASPHALT EXCEPT WHEN MATCHING ADJACENT OR EXISTING COLOR WHEN THE PAVING IS AN EXPANSION OR SEGMENT OF A LARGER LOT. CONTRACTOR SHALL APPLY THE SECOND COAT NO SOONER THAN 30 DAYS OF APPLYING THE FIRST COAT.

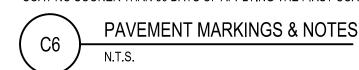


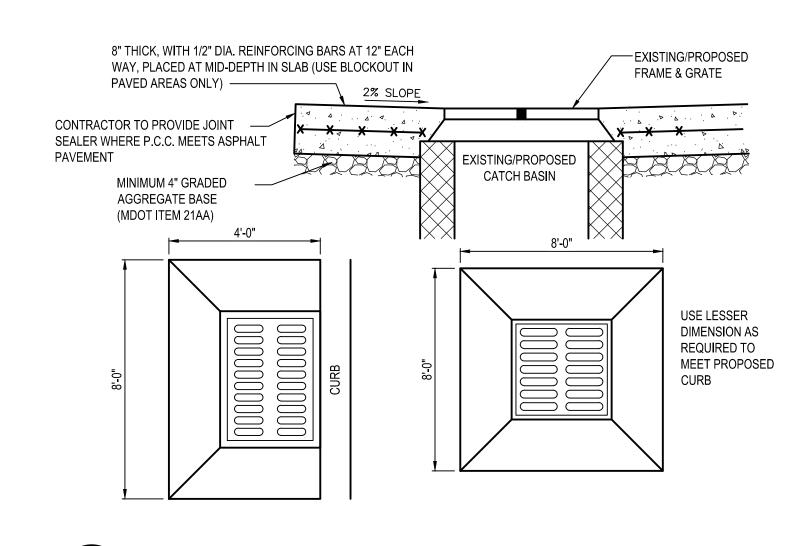


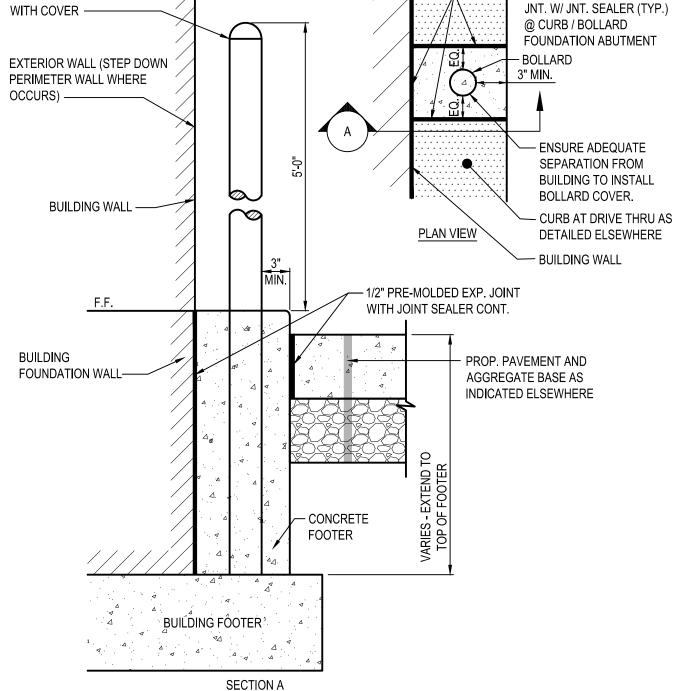

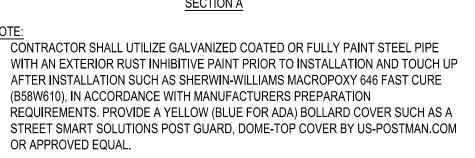



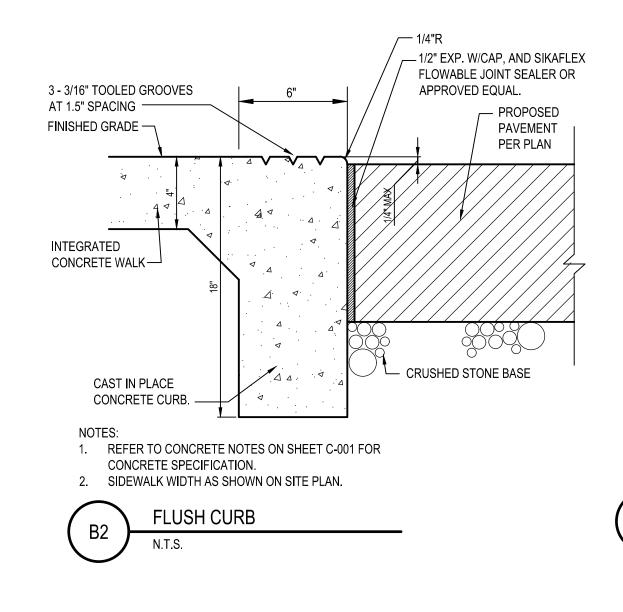

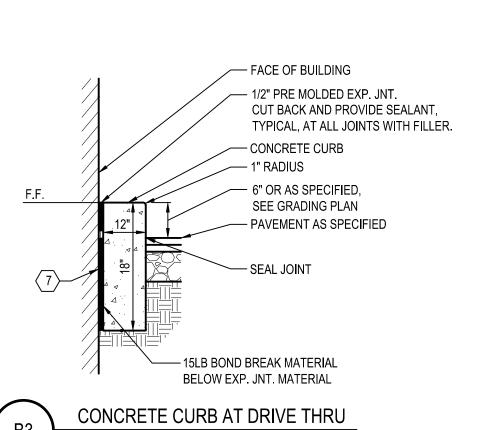

PLAN VERSION: MARCH 2021 **BRAND DESIGNER:** DICKSON SITE NUMBER: 315390 STORE NUMBER: 457226

DATE

CONTRACT DATE:

BUILDING TYPE:

REMARKS

11.15.21

END. MED20

1 3/8/22 Planning Comments

2 3/21/22 Planning Comments

3 4/21/22 Issued for Permit

4 6/30/22 Macomb SESC Comments

5 7/29/22 Macomb Township Comments

**GPD GROUP** 

**Professional Corporation** 

520 South Main Street, Suite 2531

330.572.2100 Fax: 330.572.2102

Akron, OH 44311

PA/PM: DRAWN BY.

JOB NO.: 2021088.48

17669 23 Mile Road

TACO BELL


Macomb, MI 48042




**ENDEAVOR 2.0** 

**DETAILS** 

C-501

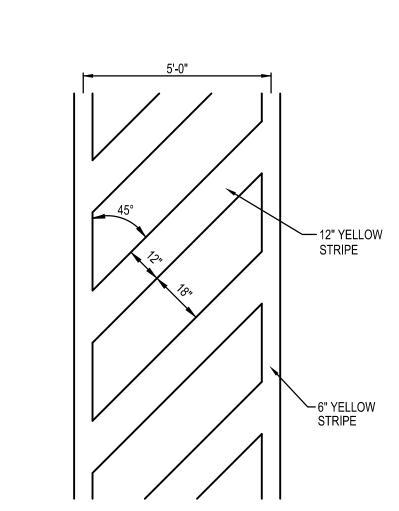


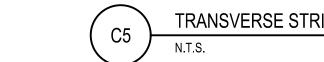





#### KEYED NOTES


- 1 CONCRETE, MATCH PAVEMENT SPEC.
- 2 6" (MIN.) AGGREGATE BASE
- 3 6" DIA. CLEAN-OUT PIPE
- 4 CAP AND SEAL CONDUIT
- 5 THREADED CLEAN-OUT CAP
- 6 CAST-IRON MONUMENT BOX, EJIW 1565 OR APPROVED EQUAL
- 7 45° BEND
- 8 WYE

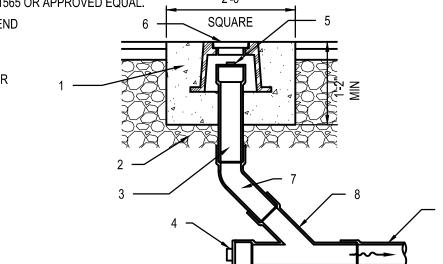

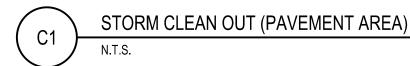


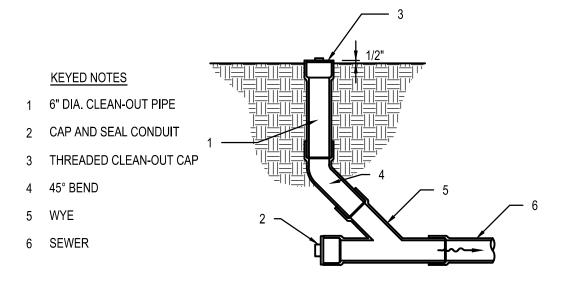




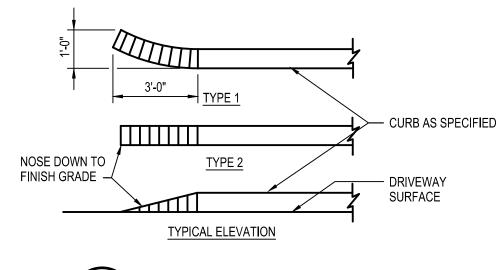




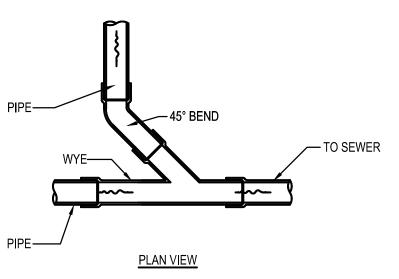



WYE CONNECTION

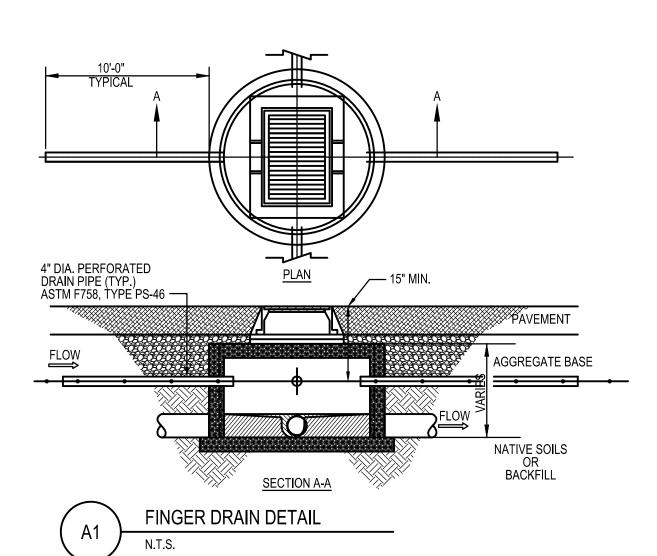

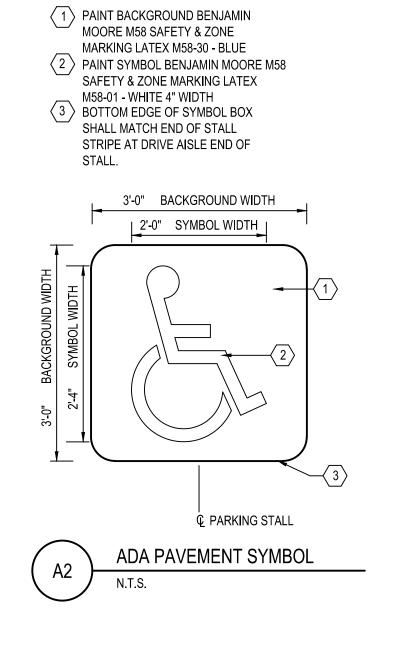

KEYED NOTES

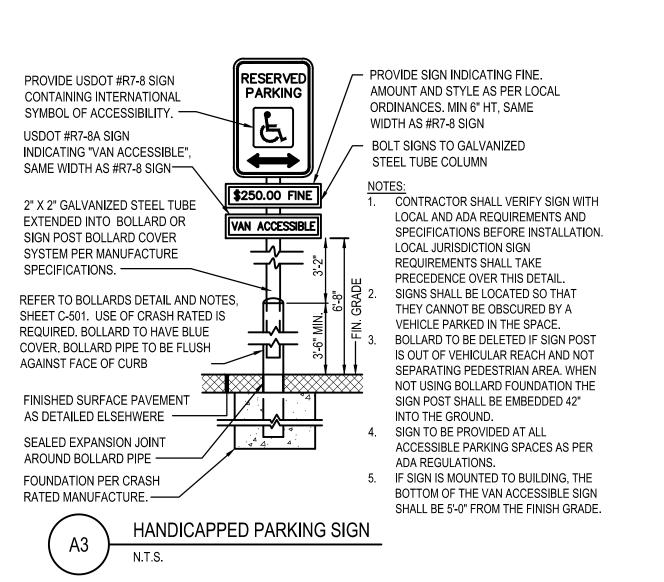

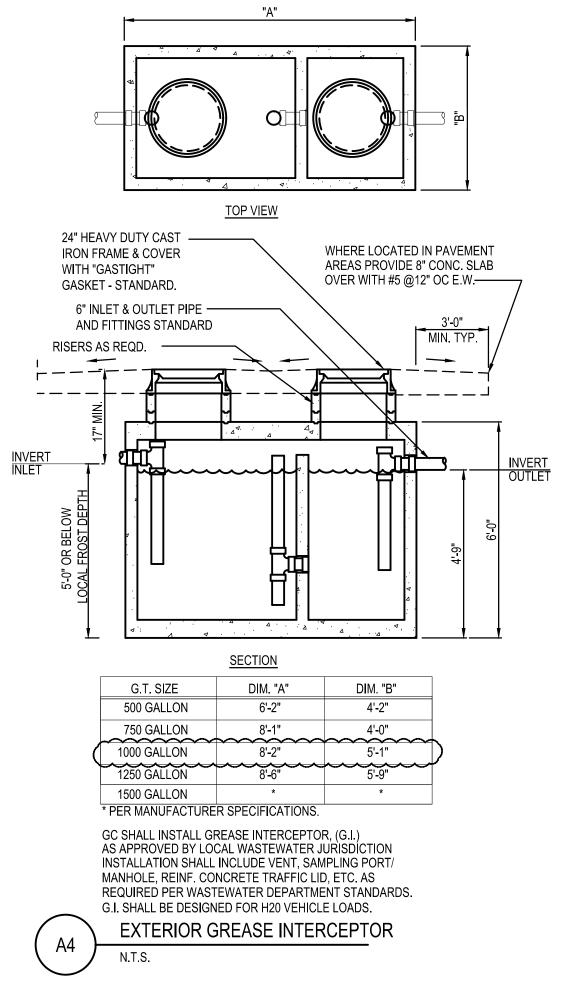

| ٤                                         |                                                                                                                                                                          | "A"                                                                                                 |                                                                         | <u> </u>      |
|-------------------------------------------|--------------------------------------------------------------------------------------------------------------------------------------------------------------------------|-----------------------------------------------------------------------------------------------------|-------------------------------------------------------------------------|---------------|
| IRON FR<br>WITH "G<br>GASKET<br>6" INL    | VY DUTY CAST ————————————————————————————————————                                                                                                                        |                                                                                                     | WHERE LOCATED IN<br>AREAS PROVIDE 8" C<br>OVER WITH #5 @12" (           | CONC. SLAB    |
| 5'-0" OR BELOW LOCAL FROST DEPTH 17" MIN. | S REQD.                                                                                                                                                                  |                                                                                                     |                                                                         | INVERT OUTLET |
| _                                         |                                                                                                                                                                          | SECTION                                                                                             |                                                                         |               |
|                                           | G.T. SIZE                                                                                                                                                                | DIM. "A"                                                                                            | DIM. "B"                                                                |               |
| -                                         | 500 GALLON<br>750 GALLON                                                                                                                                                 | 6'-2"<br>8'-1"                                                                                      | 4'-2"<br>4'-0"                                                          |               |
| /                                         | 1000 GALLON                                                                                                                                                              | 8'-2"                                                                                               | 5'-1"                                                                   | )             |
| 1                                         | 1250 GALLON                                                                                                                                                              | 8'-6"                                                                                               | 5'-9"                                                                   | /             |
|                                           | 1500 GALLON                                                                                                                                                              | *                                                                                                   | *                                                                       |               |
|                                           | FER MANUFACTURE<br>GC SHALL INSTALL GR<br>AS APPROVED BY LOC<br>INSTALLATION SHALL I<br>MANHOLE, REINF. CON<br>REQUIRED PER WASTE<br>G.I. SHALL BE DESIGNE<br>EXTERIOR G | EASE INTERCEPTOF<br>IAL WASTEWATER JU<br>INCLUDE VENT, SAM<br>ICRETE TRAFFIC LID<br>EWATER DEPARTME | JRISDICTION<br>IPLING PORT/<br>), ETC. AS<br>INT STANDARDS.<br>E LOADS. |               |
| 44                                        | N.T.S.                                                                                                                                                                   |                                                                                                     | <b></b>                                                                 |               |
| _                                         |                                                                                                                                                                          |                                                                                                     |                                                                         |               |

**ENDEAVOR 2.0** 

TACO BELL

17669 23 Mile Road

Macomb, MI 48042

DATE

CONTRACT DATE:

**BUILDING TYPE:** 

PLAN VERSION:

BRAND DESIGNER:

SITE NUMBER:

PA/PM:

DRAWN BY.:

JOB NO.:

STORE NUMBER:

REMARKS

11.15.21

END. MED20

MARCH 2021

DICKSON

315390


457226

2021088.48


1 3/8/22 Planning Comments 2 3/21/22 Planning Comments 3 4/21/22 Issued for Permit 4 6/30/22 Macomb SESC Comments 5 7/29/22 Macomb Township Comments


**DETAILS** 



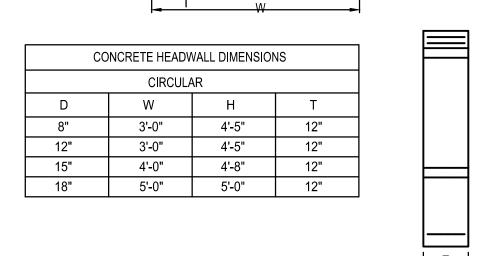


REINFORCING STEEL —

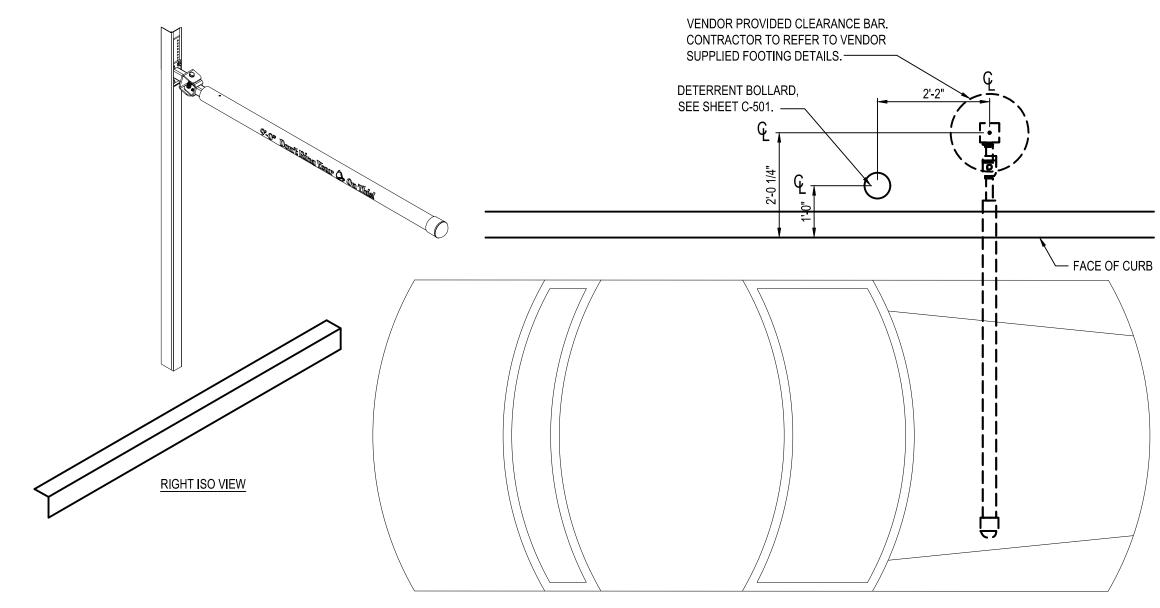


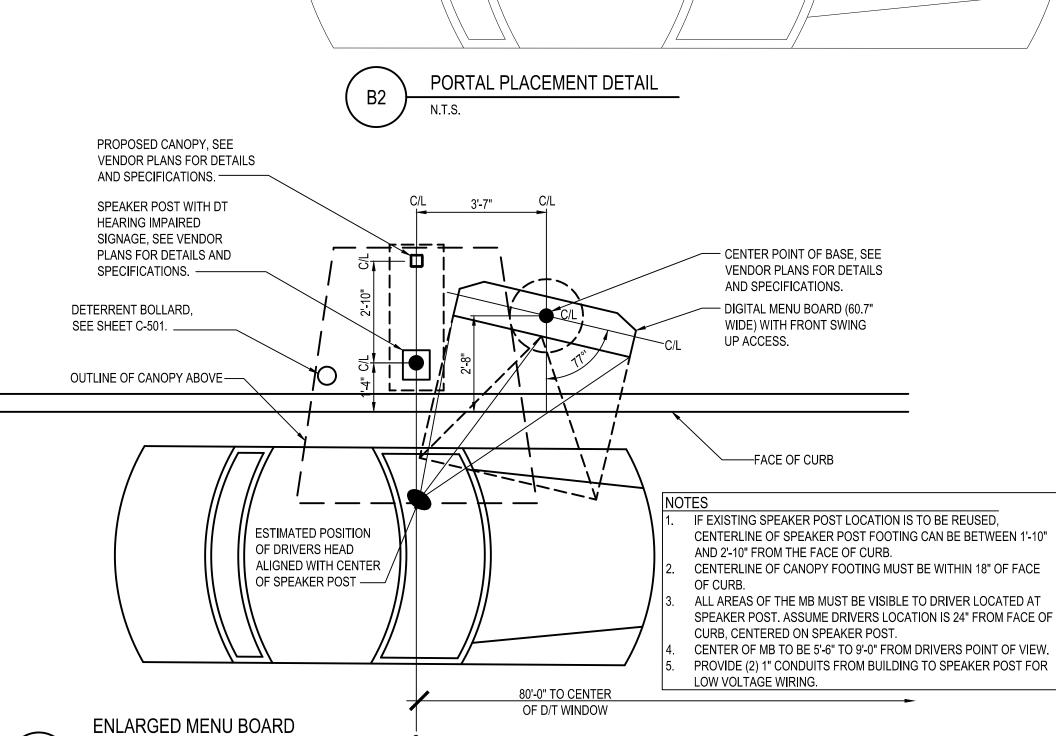

DETAIL @ STRAIGHT CURB

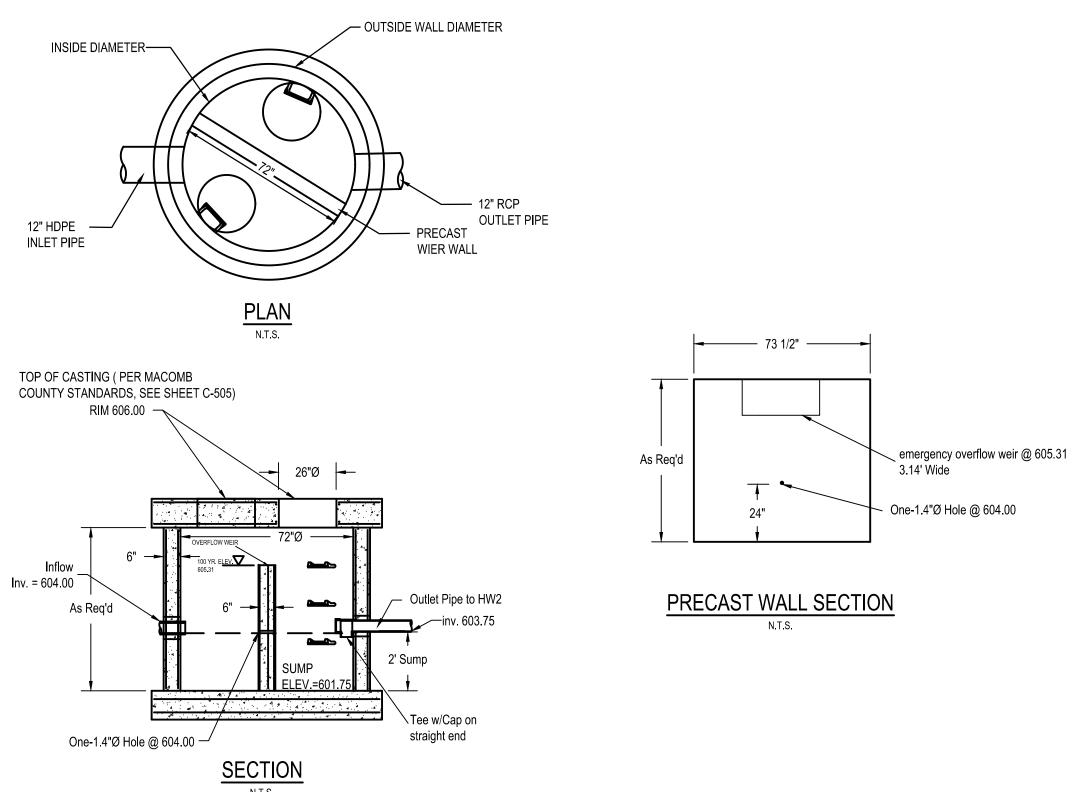

# 72" DIAMETER STORM SEWER MANHOLE, SEE SHEET C-505 OUTLET CONTROL STRUCTURE (OCS1)

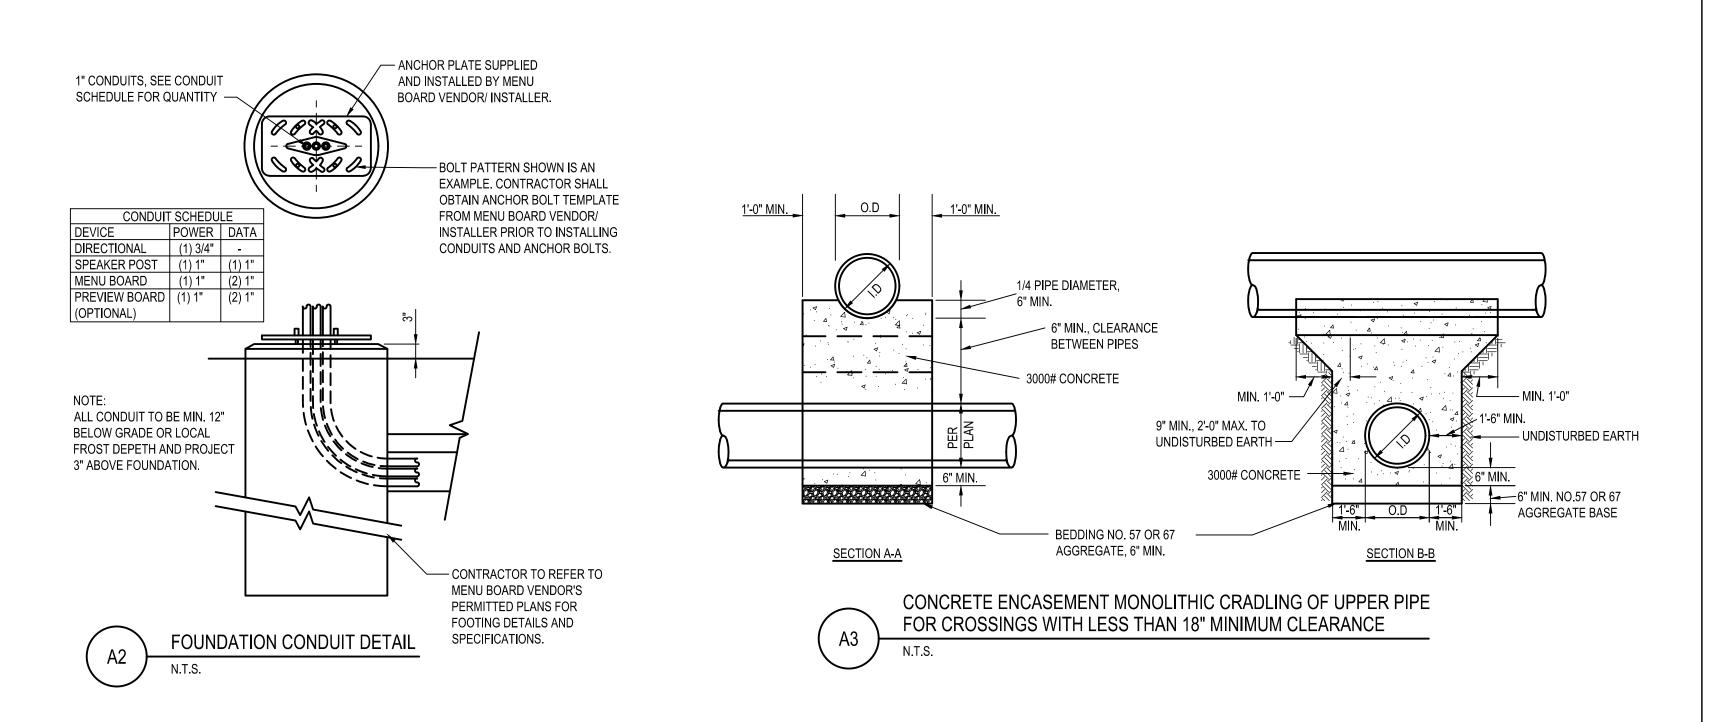



|   | DATE    | REMARKS                  |
|---|---------|--------------------------|
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|   |         |                          |

11.15.21 CONTRACT DATE: **BUILDING TYPE:** END. MED20 PLAN VERSION: MARCH 2021 BRAND DESIGNER: DICKSON SITE NUMBER: 315390 STORE NUMBER: 457226 PA/PM: DRAWN BY.

TACO BELL

2021088.48


17669 23 Mile Road Macomb, MI 48042

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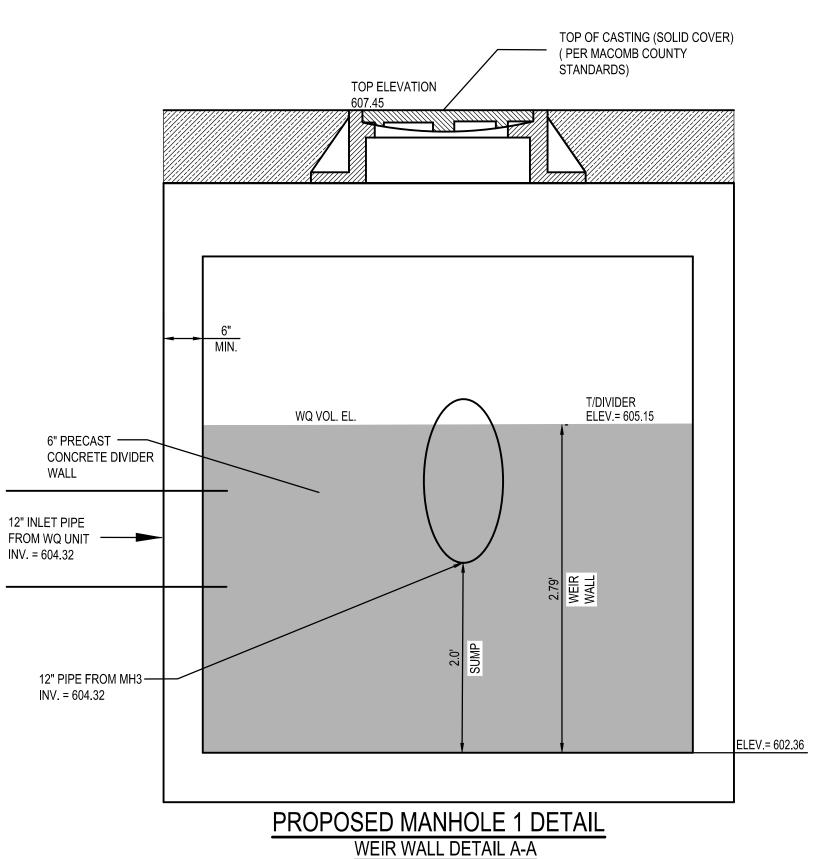


**ENDEAVOR 2.0** 


**DETAILS** 

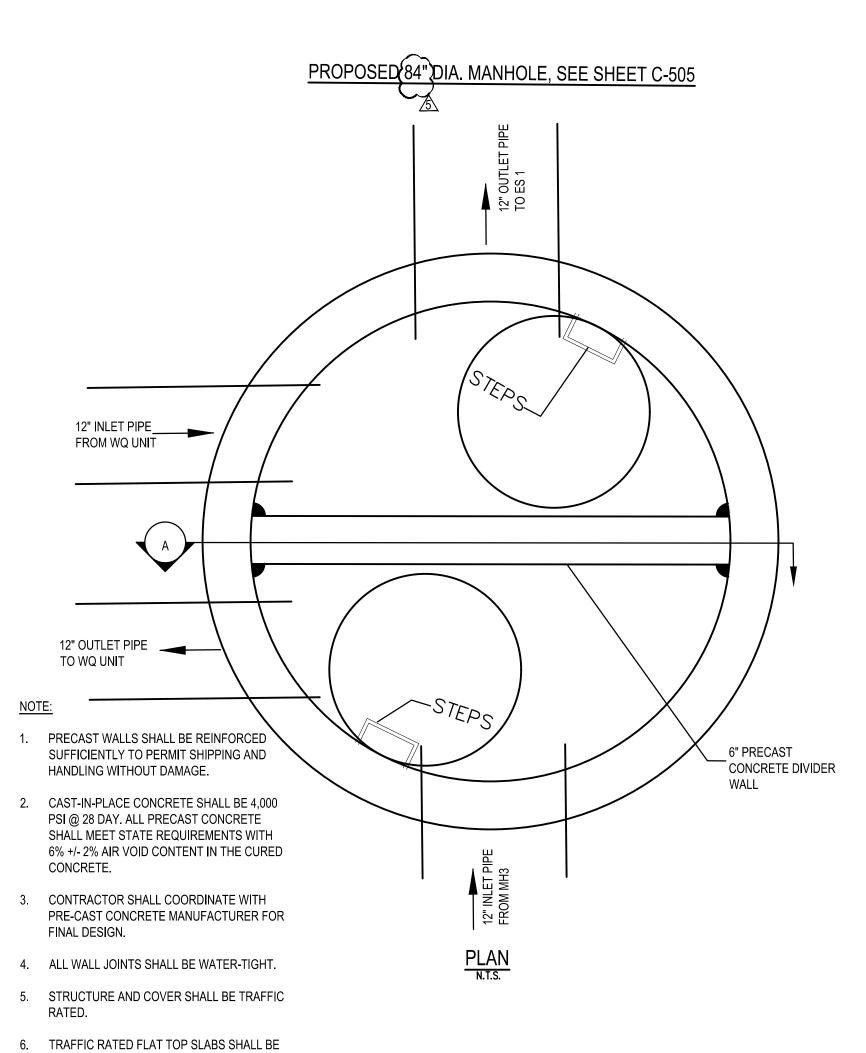

USED AS REQUIRED.





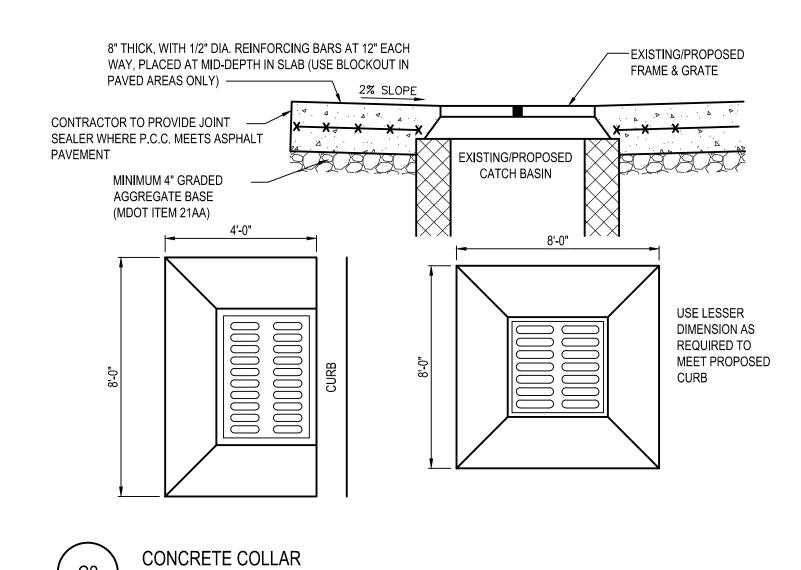

DATE REMARKS
1 3/8/22 Planning Comments

CONTRACT DATE: 11.15.21
BUILDING TYPE: END. MED20
PLAN VERSION: MARCH 2021
BRAND DESIGNER: DICKSON
SITE NUMBER: 315390
STORE NUMBER: 457226
PA/PM: SM

2 3/21/22 Planning Comments 3 4/21/22 Issued for Permit

4 6/30/22 Macomb SESC Comments
5 7/29/22 Macomb Township Comments

TACO BELL

2021088.48

DRAWN BY.:

JOB NO.:


17669 23 Mile Road Macomb, MI 48042



**ENDEAVOR 2.0** 

**DETAILS** 

C-504

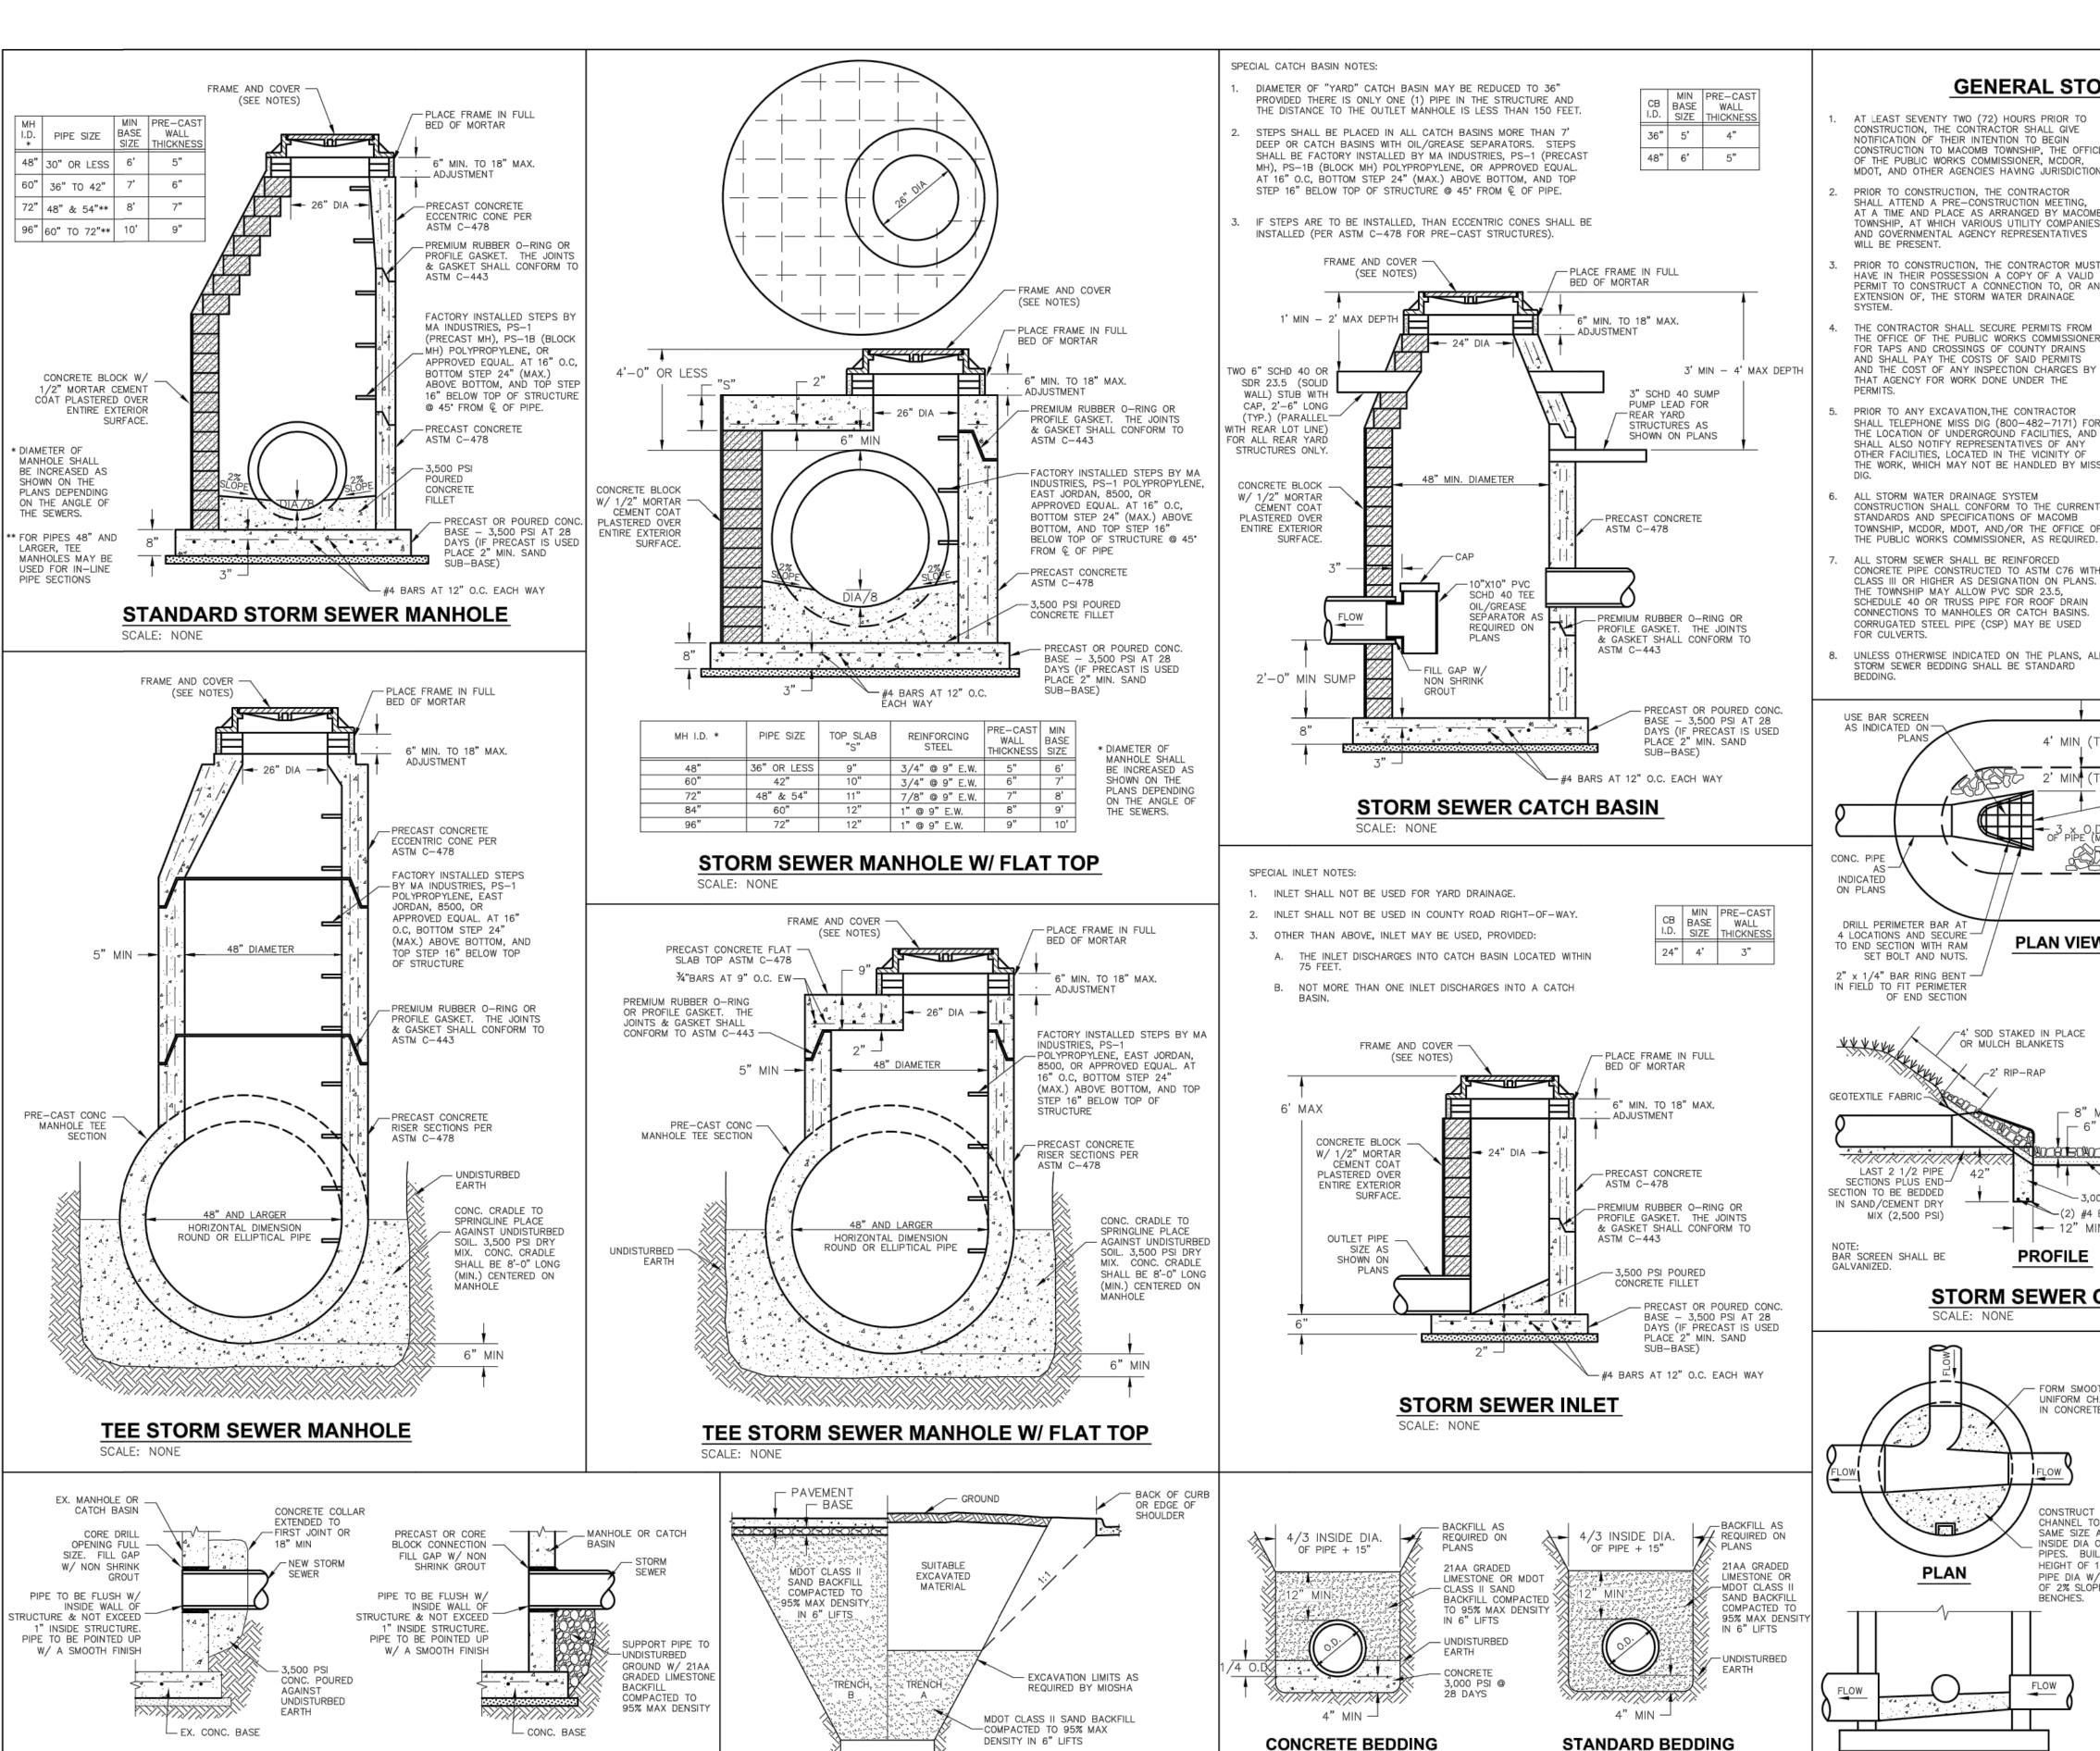

- SEE STANDARD BEDDING DETAIL

SCALE: NONE

TRENCH DETAIL

BEDDING DETAIL

SCALE: NONE

EX. STORM STRUCTURE

SCALE: NONE

PIPE SUPPORT DETAIL

NEW STORM STRUCTURE

# **GENERAL STORM SEWER NOTES**

- AT LEAST SEVENTY TWO (72) HOURS PRIOR TO CONSTRUCTION, THE CONTRACTOR SHALL GIVE NOTIFICATION OF THEIR INTENTION TO BEGIN CONSTRUCTION TO MACOMB TOWNSHIP. THE OFFICE OF THE PUBLIC WORKS COMMISSIONER, MCDOR. MDOT, AND OTHER AGENCIES HAVING JURISDICTION.
- PRIOR TO CONSTRUCTION, THE CONTRACTOR SHALL ATTEND A PRE-CONSTRUCTION MEETING AT A TIME AND PLACE AS ARRANGED BY MACOMB TOWNSHIP, AT WHICH VARIOUS UTILITY COMPANIES AND GOVERNMENTAL AGENCY REPRESENTATIVES
- PRIOR TO CONSTRUCTION, THE CONTRACTOR MUST HAVE IN THEIR POSSESSION A COPY OF A VALID PERMIT TO CONSTRUCT A CONNECTION TO, OR AN EXTENSION OF, THE STORM WATER DRAINAGE
- THE CONTRACTOR SHALL SECURE PERMITS FROM THE OFFICE OF THE PUBLIC WORKS COMMISSIONER FOR TAPS AND CROSSINGS OF COUNTY DRAINS AND THE COST OF ANY INSPECTION CHARGES BY THAT AGENCY FOR WORK DONE UNDER THE
- SHALL TELEPHONE MISS DIG (800-482-7171) FOR THE LOCATION OF UNDERGROUND FACILITIES, AND SHALL ALSO NOTIFY REPRESENTATIVES OF ANY OTHER FACILITIES, LOCATED IN THE VICINITY OF THE WORK, WHICH MAY NOT BE HANDLED BY MISS
- TOWNSHIP, MCDOR, MDOT, AND/OR THE OFFICE OF THE PUBLIC WORKS COMMISSIONER, AS REQUIRED ALL STORM SEWER SHALL BE REINFORCED CONCRETE PIPE CONSTRUCTED TO ASTM C76 WITH CLASS III OR HIGHER AS DESIGNATION ON PLANS. THE TOWNSHIP MAY ALLOW PVC SDR 23.5, SCHEDULE 40 OR TRUSS PIPE FOR ROOF DRAIN CONNECTIONS TO MANHOLES OR CATCH BASINS CORRUGATED STEEL PIPE (CSP) MAY BE USED
- UNLESS OTHERWISE INDICATED ON THE PLANS, ALL STORM SEWER BEDDING SHALL BE STANDARD

4' MIN (TYP)

**PLAN VIEW** 

\_ 8" MIN

~(2) #4 BARS

PROFILE

- 6" MIN /

√4' SOD STAKED IN PLACE

~2' RIP-RAP

CHANNEL DETAIL

SCALE: NONE

- ALL BUILDING SUMP PUMP SERVICE CONNECTIONS SHALL BE
- $3\rlap{''}$  PVC SCHEDULE 40 PIPE AND SHALL BE CONNECTED AT MANHOLES AND CATCH BASINS. NO BLIND TAPS TO THE STORM SEWER SHALL BE ACCEPTED.
- UNLESS OTHERWISE NOTED ON THE PLANS, STRUCTURE FRAM AND COVERS SHALL BE AS FOLLOWS:
- MH IN CONC. ROADWAYS EJIW 1047 - TYPE B VENTED COVER
- MH IN ASPHALT ROADWAYS EJIW 1048 - TYPE B VENTED COVER
- MH OUTSIDE OF ROADWAYS EJIW 1040- TYPE B VENTED COVER
- CB IN CONC. ROADS W/ MOUNTABLE CONC. CURBS EJIW 5100 - TYPE M1 5105 GRATE - CB IN ASPHALT ROADS W/ MOUNTABLE CONC. CURBS
- CB IN YARD AREAS EJIW 1040 - TYPE N OVAL GRATE

EJIW 5100 - TYPE M1 5105 GRATE

- CB IN STANDARD STRAIGHT CURBS EJIW 7045 - W/ TYPE M2 ADJUSTING GRATE
- CB IN PARKING LOTS AND DRIVEWAYS EJIW 5100 - W/ TYPE M1 5105 GRATE
- ALL CONCRETE STORM SEWER JOINTS SHALL HAVE PREMIUM RUBBER O-RINGS OR PROFILE GASKETS AND SHALL CONFORM TO ASTM C-443. BITUMINOUS COMPOUND JOINT FILLER MATERIAL MAY BE ALLOWED FOR REAR YARD STORM SEWER (ASTM D994) PROVIDED JOINTS ARE COVERED IN GEOTEXTILE FABRIC AND THE PIPE IS BEDDED IN SAND.
- 12. ONLY NEW UNDAMAGED STORM SEWER PIPE SHALL BE USED. MACOMB TOWNSHIP SHALL HAVE THE RIGHT TO REJECT ANY AND ALL PIPE.

- LIMITS OF SOD OR

MULCH BLANKETS

- RIP-RAP ROCK

(PERIMETER)

FRAGMENT

GEOTEXTILE FABRIC

CONCRETE END

HEADER

VARIES -

**END VIEW** 



MACOMB TOWNSHIP 54111 BROUGHTON ROAD

586-992-0710

MACOMB, MI 48042



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PRIOR TO CONSTRUCTION, ALL LOCATIONS AND DEPTHS OF EXISTING UTILITIES (IN CONFLICT WITH PROPOSED IMPROVEMENTS) SHALL BE VERIFIED IN THE FIELD. CALL MISS DIG 3 WORKING DAYS PRIOR TO CONSTRUCTION.

#### **TOWNSHIP OF** MACOMB

STORM SEWER STANDARD DETAILS

TOWN 3 NORTH RANGE 13 EAST MACOMB TOWNSHIP MACOMB COUNTY

NO. DATE REVISION 10-15-14 SHEET UPDATE 11-06-15 SHEET UPDATE 05-10-16 SHEET UPDATE 01-24-17 SHEET UPDATE 07-11-17 SHEET UPDATE

STORM SEWER OUTLET END SECTION DETAIL SCALE: NONE

-STAKED IN PLACE SOD

OR MULCH BLANKETS

-#4 BARS' 6" x 6"

MAX, SPACING

RIP-RAP ROCK FRAGMENT


8" TO 15"

FRAGMENT

-3/16" - 2" CRUSHED STONE

-3,000 PSI CONCRETE END HEADER

RIP-RAP ROCK

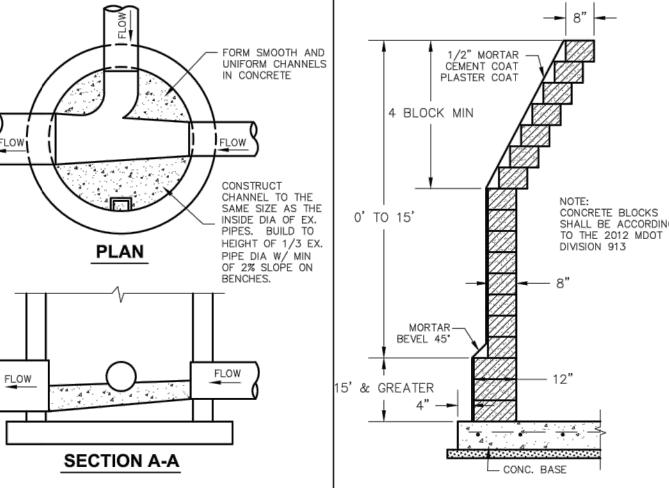

SCALE: NONE

SHALL BE ACCORDING CONC. BLOCK WALL SECTION

VERIFY SCALES

BAR IS ONE INCH ON ORIGINAL DRAWING IF NOT ONE INCH ON THIS SHEET. ADJUST SCALES ACCORDINGLY
D. DRAWING NO.

N.T.S.

MA-DET-STM

STM1

PLOT DATE:

FOR FRENCE 2

DATE REMARKS 1 | 3/8/22 | Planning Comments 2 | 3/21/22 | Planning Comments 3 4/21/22 Issued for Permit 4 6/30/22 Macomb SESC Comments 5 7/29/22 Macomb Township Comments CONTRACT DATE: 11.15.21

BUILDING TYPE: END. MED20 PLAN VERSION: MARCH 2021 **BRAND DESIGNER:** DICKSON SITE NUMBER: 315390 STORE NUMBER: 457226

PA/PM: DRAWN BY.

JOB NO .:

**TACO BELL** 

EΑ

2021088.48

17669 23 Mile Road Macomb, MI 48042



**ENDEAVOR 2.0 TOWNSHIP STORM DETAILS** 

# **PAVING NOTES**

#### GENERAL NOTES

- EXISTING TOPSOIL, VEGETATION AND ORGANIC MATERIALS SHALL BE STRIPPED AND REMOVED FROM PROPOSED PAVEMENT AREA PRIOR TO PLACEMENT OF BASE MATERIALS. TREE ROOTS SHALL BE COMPLETELY REMOVED.
- EXCAVATE TO THE DEPTH OF THE FINAL SUBGRADE ELEVATION TO ALLOW FOR GRADE CHANGES AND THE PLACEMENT OF THE RECOMMENDED PAVEMENT SYSTEM.
- 3. THE PAVEMENT SUBGRADE SHALL BE COMPACTED TO 95% OF THE MAXIMUM DRY DENSITY (MODIFIED PROCTOR) PRIOR TO PLACEMENT OF PROPOSED PAVEMENT. THE FINAL SUBGRADE SHALL BE THOROUGHLY PROOF—ROLLED IN THE PRESENCE OF A GEOTECHNICAL/PAVEMENT ENGINEER TO DETERMINE STABILITY. LOOSE OR YIELDING AREAS WHICH CANNOT BE MECHANICALLY STABILIZED SHALL BE REMOVED AND REPLACED WITH CLASS II SAND OR AS DIRECTED BY THE ENGINEER. ALL FILL MATERIAL AND BASE MATERIAL SHALL BE TESTED AND ITS COMPACTION AND SUITABILITY FOR ACCEPTANCE OF THE BASE MATERIAL AND PAVEMENT SHALL BE CERTIFIED BY SAID TESTING FIRM. THE OWNER SHALL SUPPLY THREE COPIES OF GEOTECHNICAL REPORTS TO MACOMB TOWNSHIP.
- 4. IF IN THE OPINION OF THE INSPECTOR/ENGINEER, FIELD CONDITIONS WARRANT ADDITIONAL TESTING, THE DEVELOPER SHALL ARRANGE FOR AND PAY FOR ALL REQUIRED ADDITIONAL TESTING.
- 5. 21AA AGGREGATE BASE SHALL BE COMPACTED TO ACHIEVE A 95% COMPACTION LEVEL (MODIFIED PROCTOR ASTM D 1557—91) (98% COMPACTION REQUIRED BELOW HMA PAVEMENTS). THE BASE SHALL EXTEND A MINIMUM OF 2 FEET BEYOND THE BACK OF CURB OR THE PAVED EDGE.
- 6. CONCRETE AND ASPHALT PAVEMENT TESTING SHALL BE REQUIRED FOR ALL PROJECTS.
- 7. ALL WORKMANSHIP AND MATERIALS SHALL BE IN ACCORDANCE WITH THE CURRENT STANDARDS AND SPECIFICATIONS OF MACOMB TOWNSHIP, THE MACOMB COUNTY DEPARTMENT OF ROADS (MCDOR), AND THE MICHIGAN DEPARTMENT OF TRANSPORTATION STANDARD SPECIFICATIONS FOR CONSTRUCTION, CURRENT EDITION.
- FOR ANY WORK WITHIN THE PUBLIC RIGHT-OF-WAY, THE CONTRACTOR SHALL PAY FOR AND SECURE ALL NECESSARY PERMITS AND LIKEWISE ARRANGE FOR ALL INSPECTION.
- 1.0 INCH AND 2.0 INCH EXPANSION JOINTS SHALL BE INSTALLED PER MCDOR STANDARDS.
- 10. FILL AREAS SHALL BE MACHINE COMPACTED IN UNIFORM LIFTS NOT EXCEEDING 9 INCHES THICK TO 95% OF THE MAXIMUM DRY DENSITY (MODIFIED PROCTOR) PRIOR TO PLACEMENT OF PROPOSED PAVEMENT.
- 11. 6" UNDER DRAIN WRAPPED IN GEOTEXTILE FABRIC FILTER SHALL BE INSTALLED ON BOTH SIDES OF ALL ROADWAYS. ALSO, PLACE UNDER DRAINS AT ALL DRAINAGE STRUCTURES WITHIN PARKING AREAS (SEE UNDERDRAIN DETAILS SHEET 2 OF 2).
- 12. CONSTRUCTION TRAFFIC SHALL BE MINIMIZED ON THE NEW BITUMINOUS PAVEMENT.

  IF CONSTRUCTION TRAFFIC IS ANTICIPATED ON THE PAVEMENT STRUCTURE, SUBJECT TO MACOMB TOWNSHIP AND MCDOR APPROVAL, THE PLACEMENT OF THE FINAL LIFT SHALL BE DELAYED UNTIL THE MAJORITY OF THE CONSTRUCTION ACTIVITIES HAVE BEEN COMPLETED BY THE DEVELOPER. PAVEMENT SHALL BE OF THE TYPE, THICKNESS AND CROSS SECTION AS INDICATED ON THE PLANS.
- THESE DETAILS ARE SUPPLEMENTAL TO THE MACOMB COUNTY DEPARTMENT OF ROADS (MCDOR) ROAD PAVING STANDARD DETAILS SHEETS 1 & 2.
- 14. ALL ROAD PAVING WITHIN THE TOWNSHIP SHALL COMPLY WITH THE MCDOR PAVING STANDARD DETAILS UNLESS OTHERWISE NOTED ON THE PLANS OR ON THIS SUPPLEMENTAL DETAIL SHEET.
- 15. NO BITUMINOUS PAVEMENT IS PERMITTED FOR ROADS WITHIN PLATTED SUBDIVISIONS OR SITE CONDOMINIUMS (MCDOR PAVING STANDARD DETAILS 1B & 2B).

# CONCRETE PAVEMENT

- 1. CONCRETE SHALL CONSIST OF:
  PORTLAND CEMENT TYPE IA (AIR-ENTRAINED) WITH A MAXIMUM CEMENT CONTENT OF
  SIX SACKS PER CUBIC YARD, MINIMUM 28 DAY COMPRESSIVE STRENGTH OF 3500 PSI
  AND A SLUMP OF 1½ TO 3 INCHES. PAVEMENT SHALL CONFORM TO M.D.O.T. GRADE P1.
  CONCRETE MIXES SHALL BE DESIGNED TO MITIGATE ASR IN ACCORDANCE WITH ASTM
  1260, ASTM 1293, OR ASTM 1567.
- ALL CONCRETE PAVEMENT, DRIVEWAYS, CURB & GUTTER, ETC., SHALL BE SPRAY CURED WITH WHITE MEMBRANE CURING COMPOUND IMMEDIATELY FOLLOWING FINISHING OPERATION.
- THE CONCRETE BATCH PLANT SHALL BE M.D.O.T. CERTIFIED WITH LOCATION APPROVED BY THE TOWNSHIP BOARD AND MCDOR.
- 4. NO CONCRETE PAVING SHALL BE ALLOWED PRIOR TO MAY 1, OR AFTER NOVEMBER 1 (UNLESS APPROVED BY MDOT, MCDOR OR MACOMB TOWNSHIP).
- 5. AIR TEMPERATURE AT POINT OF PLACEMENT, AWAY FROM ARTIFICIAL HEAT SHALL BE
- MINIMUM 25° F AND RISING.

  6. TEMPERATURE OF CONCRETE AT TIME OF PLACEMENT SHALL BE BETWEEN 45° F AND


# BITUMINOUS PAVEMENT


- BITUMINOUS MIXTURE FOR INDUSTRIAL PARKING LOTS SHALL CONSIST OF: BASE COURSE — MDOT BITUMINOUS MIXTURE NO. 2C; LEVELING COURSE — MDOT BITUMINOUS MIXTURE NO. 3C OR 4E1; WEARING COURSE — MDOT BITUMINOUS MIXTURE NO. 4C OR 5E1; ASPHALT PERFORMANCE GRADE PG 64—22 RECLAIMED ASPHALT PAVEMENT (RAP) SHALL NOT BE ALLOWED IN THE TOP COURSE.
- 2. FOR PRIVATE RESIDENTIAL ROADWAYS MOOT BITUMINOUS MIXTURE 5E1/4E1, AND/OR 36A/13A MAY BE USED, WITH APPROVAL FROM THE TOWNSHIP ENGINEER.
- 3. ALL BITUMINOUS MATERIAL SHALL BE COMPACTED TO A DENSITY OF 97% OF THE FIELD CONTROL DENSITY AS DETERMINED BY THE MARSHALL METHOD.
- 4. A BOND COAT OF SS-1H EMULSION IS REQUIRED BETWEEN THE BASE COURSE AND LEVELING COURSE AND BETWEEN THE LEVELING COURSE AND WEARING COURSE WHEN EITHER 48 HOURS HAVE ELAPSED BETWEEN PLACEMENT OF THE BITUMINOUS COURSES OR THE SURFACE OF THE PAVEMENT HAS BEEN CONTAMINATED WITH DIRT, DUST, OR FOREIGN MATERIAL. THE BOND COAT SHALL BE APPLIED IN A UNIFORM MANNER OVER THE SURFACE AT A RATE OF 0.10 GALLON/S.Y. (BETWEEN LEVELING COURSE AND BASE COURSE & 0.05 GALLON/SY BETWEEN WEARING COURSE AND LEVELING COURSE) THE COATS MAY DIFFER. IN THE EVENT A BOND COAT IS NOT REQUIRED, THE LEVELING COURSE MAY REQUIRE LOCALIZED BROOM CLEANING.
- 5. DO NOT PLACE HMA OR APPLY BOND COAT WHEN PRECIPITATION IS IMMINENT OR WHEN MOISTURE ON THE EXISTING SURFACE WILL PREVENT SATISFACTORY CURING. UNLESS OTHERWISE APPROVED BY THE ENGINEER IN WRITING, TEMPERATURE AND SEASONAL REQUIREMENTS FOR PLACING HMA WILL BE ACCORDING TO SECTION 5.01.03.I OF THE CURRENT MDOT SPECIFICATIONS. PAVING WILL NOT BE ALLOWED BELOW THESE MINIMUM TEMPERATURES, NOR WHEN FROST IS ON OR IN THE GRADE OR ON THE EXISTING SURFACE.


# CONCRETE PATHWAY NOTES

- 1. FOR CONCRETE PATHWAY PROVIDE TRANSVERSE PLANE OF WEAKNESS SAW CUT JOINTS AT APPROXIMATELY 8' INTERVALS. SAW '8" WIDE x 1" DEEP JOINTS AND DO NOT SEAL THE JOINTS. TOOLED JOINTS ARE NOT ACCEPTABLE.
- PROVIDE FULL DEPTH TRANSVERSE EXPANSION JOINTS, BY INSTALLING ½" THICK PREMOLDED JOINT FILLER SET ¼" BELOW THE SURFACE OF THE CONCRETE IN THE JOINTS AT 50' INTERVALS (MAX.).
- 3. PLACE ½" FIBER EXPANSION JOINT FILLERS AT EACH SIDE OF DRIVE.
- PROVIDE 1" FIBER EXPANSION JOINT FILLERS AT CURB AND BUILDING OR R.O.W. LINE.
- AT DRIVEWAYS WITH CURB & GUTTER, PROVIDE CURB DROP PER MDOT STANDARDS.
   AT UNPAVED DRIVE OR PAVED DRIVE WITH POOR
- CONDITION, INCREASE THE SLAB THICKNESS TO 6" OR EXISTING SLAB THICKNESS WHICHEVER IS GREATER.
- 7. PROVIDE 10' BETWEEN EDGE OF PATHWAY TO TOP OF BANK FOR DETENTION BASINS, OPEN DRAINS, ETC.
- ADJACENT FINISHED GRADE SHALL BE SET 2" BELOW TO ACCOMMODATE SOD.
- THE MAXIMUM GRADE ALONG PATHWAY SHALL NOT EXCEED 1 ON 12.
- PROVIDE 2% MAXIMUM CROSS SLOPE FOR DRAINAGE OFF AND AWAY FROM PATHWAY AND GRADED SHOULDERS.
- 11. PROVIDE 95' MINIMUM CENTER LINE RADII FOR PATHWAY HORIZONTAL ALIGNMENT.12. PROVIDE A MINIMUM OF 3' HORIZONTAL CLEARANCE AND
- 12. PROVIDE A MINIMUM OF 3' HORIZONTAL CLEARANCE AND 10' VERTICAL CLEARANCE FROM ALL FIXED OBJECTS AND THE EDGE OF PATHWAY SURFACE. RELOCATE EXISTING OBJECTS (I.E. MAIL BOXES, SIGNS, ETC.), IF REQUIRED.
- 13. PROVIDE HANDICAP ACCESSIBLE RAMPS AT EXISTING PAVED DRIVEWAYS IN GOOD CONDITION AND AT STREET
- 14. PATHWAY RAMPS SHALL BE CONSTRUCTED IN ACCORDANCE WITH MDOT STANDARDS AND SHALL BE A MINIMUM OF 8' WIDE.
- A CLEAN SAW CUT JOINT SHALL BE PROVIDED WHEREVER NEW PAVEMENT MATCHES EXISTING PAVEMENT.
- 16. UTILITY STRUCTURES SHALL BE ADJUSTED IN ACCORDANCE WITH MACOMB TOWNSHIP STANDARDS AND SHALL MATCH THE PROPOSED GRADE OF THE PATHWAY.

# PAVEMENT CURB & RAMP PATHWAY GUTTER 2" MAX.— TRUNCATED DOMES RAMP SLOPE 5% - 7% (8.3% MAX.) MIN. 6" CONC. EPOXY COATED #4 BARS SIDE VIEW

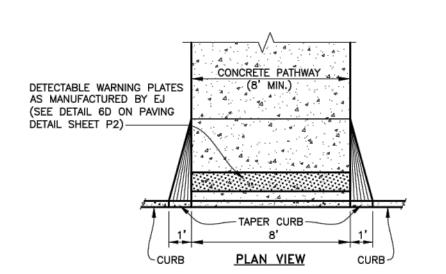

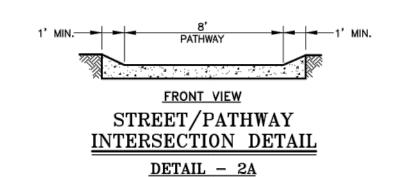

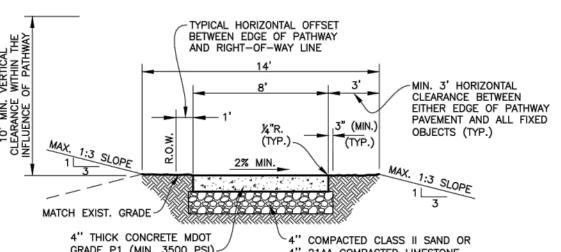


4" THICK CONCRETE MDOT 4" COMPACTED CLASS II SAND OR 4" 21AA COMPACTED LIMESTONE

CONCRETE PATHWAY SECTION

DETAIL — 2B


NOT TO SCALE

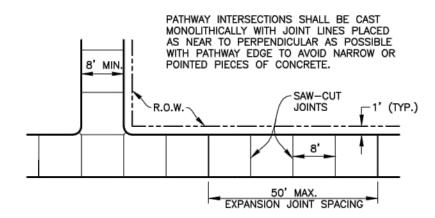

TYPICAL CONCRETE PATHWAY JOINT LAYOUTS

DETAIL - 2D

NOT TO SCALE

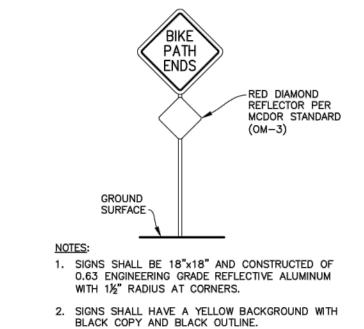


 SIGN POST AND FASTENERS SHALL BE LOCATED PER M.M.U.T.C.D. (MICHIGAN MANUAL ON UNIFORM TRAFFIC CONTROL DEVICES) STANDARDS.

CONCRETE PATHWAY SIGNAGE

DETAIL - 2C

NOT TO SCALE

# CONCRETE PATHWAY DETAILS - 2

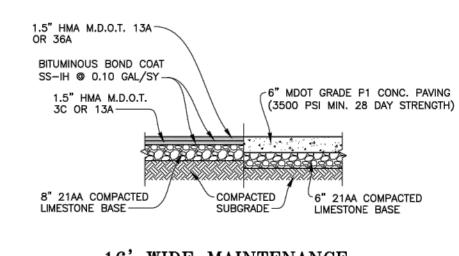

16' WIDE MAINTENANCE DRIVEWAY DETAIL - 3 8"-3500 PSI (MIN.) M.D.O.T.
GRADE P1 CONCRETE PAVEMENT

COMPACTED SUBGRADE

4" 21AA COMPACTED LIMESTONE BASE

NOTE:
DUMPSTER PAD SHALL EXTEND MIN. 6'

8" CONCRETE DUMPSTER PAD DETAIL - 4

BEYOND DUMPSTER ENCLOSURE OPENING.

CENTER OF THE COUNTY HEART OF THE COUNTY HEART

MACOMB TOWNSHIP
54111 BROUGHTON ROAD
MACOMB, MI 48042

586-992-0710



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TOWNSHIP OF MACOMB

PAVING STANDARD DETAILS (1 OF 2)

REVISION

SHEET UPDATE

VERIFY SCALES

BAR IS ONE INCH ON ORIGINAL DRAWING

IF NOT ONE INCH ON THIS SHEET,

ADJUST SCALES ACCORDINGLY
DRAWING NO.

N.T.S.

MA-DET-PAV

SHEET NO.

TOWN 3 NORTH RANGE 13 EAST MACOMB TOWNSHIP MACOMB COUNTY

10-15-14

NO. DATE

2 11-06-15 SHEET UPDATE
3 03-28-16 SHEET UPDATE
4 10-14-16 SHEET UPDATE
5 01-24-17 SHEET UPDATE
6 08-20-18 SHEET UPDATE

17669 23 Mile Road

Macomb, MI 48042

TACO BELL

 $\bigcirc$ 

1 3/8/22 | Planning Comments

2 | 3/21/22 | Planning Comments

4 6/30/22 Macomb SESC Comments

5 7/29/22 Macomb Township Comments

3 4/21/22 Issued for Permit

REMARKS

11.15.21

END. MED20

MARCH 2021

DICKSON

315390

457226

2021088.48

FOR

DATE

**CONTRACT DATE:** 

BUILDING TYPE:

PLAN VERSION:

SITE NUMBER:

PA/PM:

DRAWN BY.

JOB NO.:


STORE NUMBER:


BRAND DESIGNER:



ENDEAVOR 2.0 TOWNSHIP PAVING DETAILS

C-506

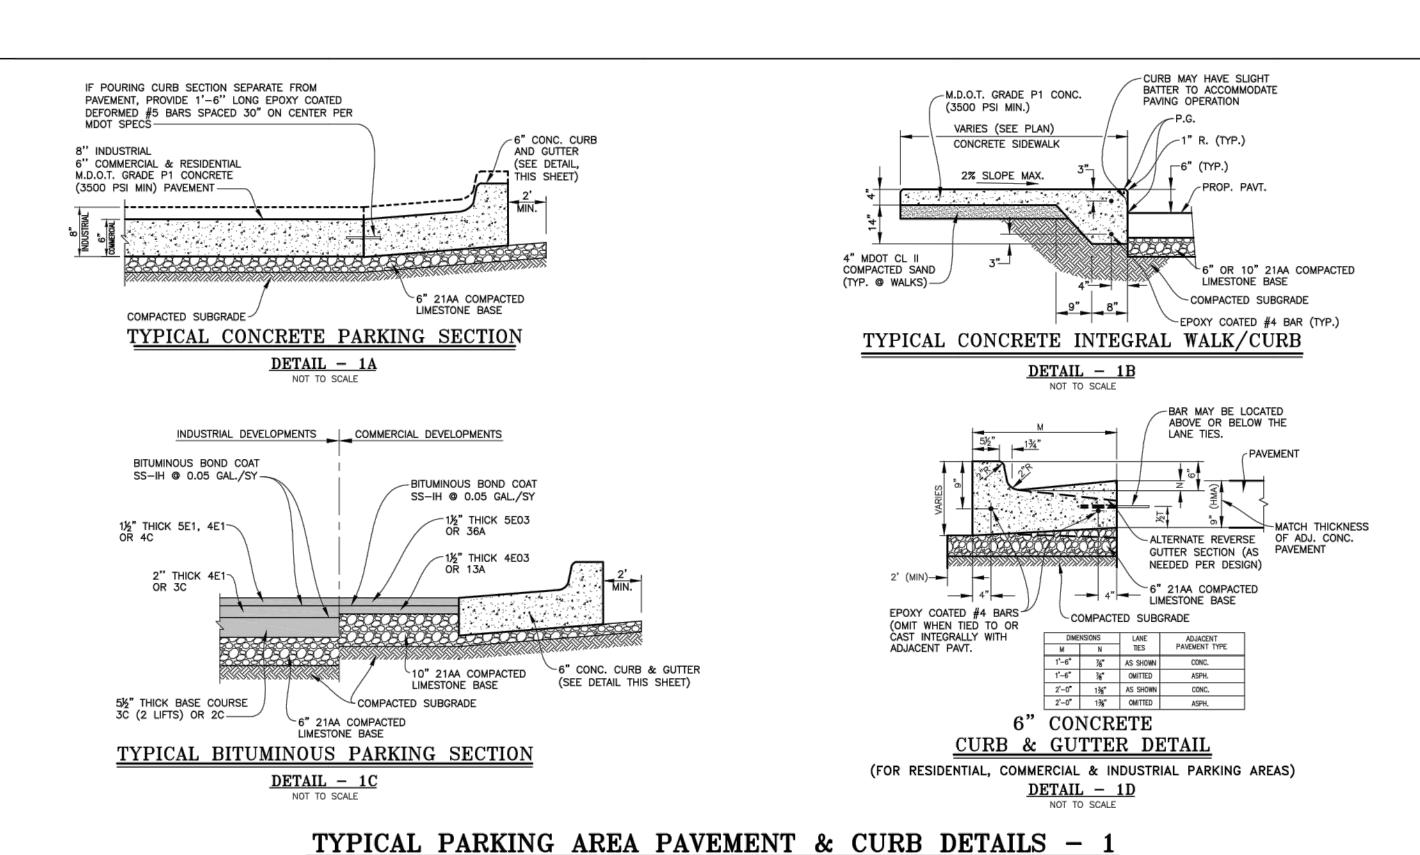


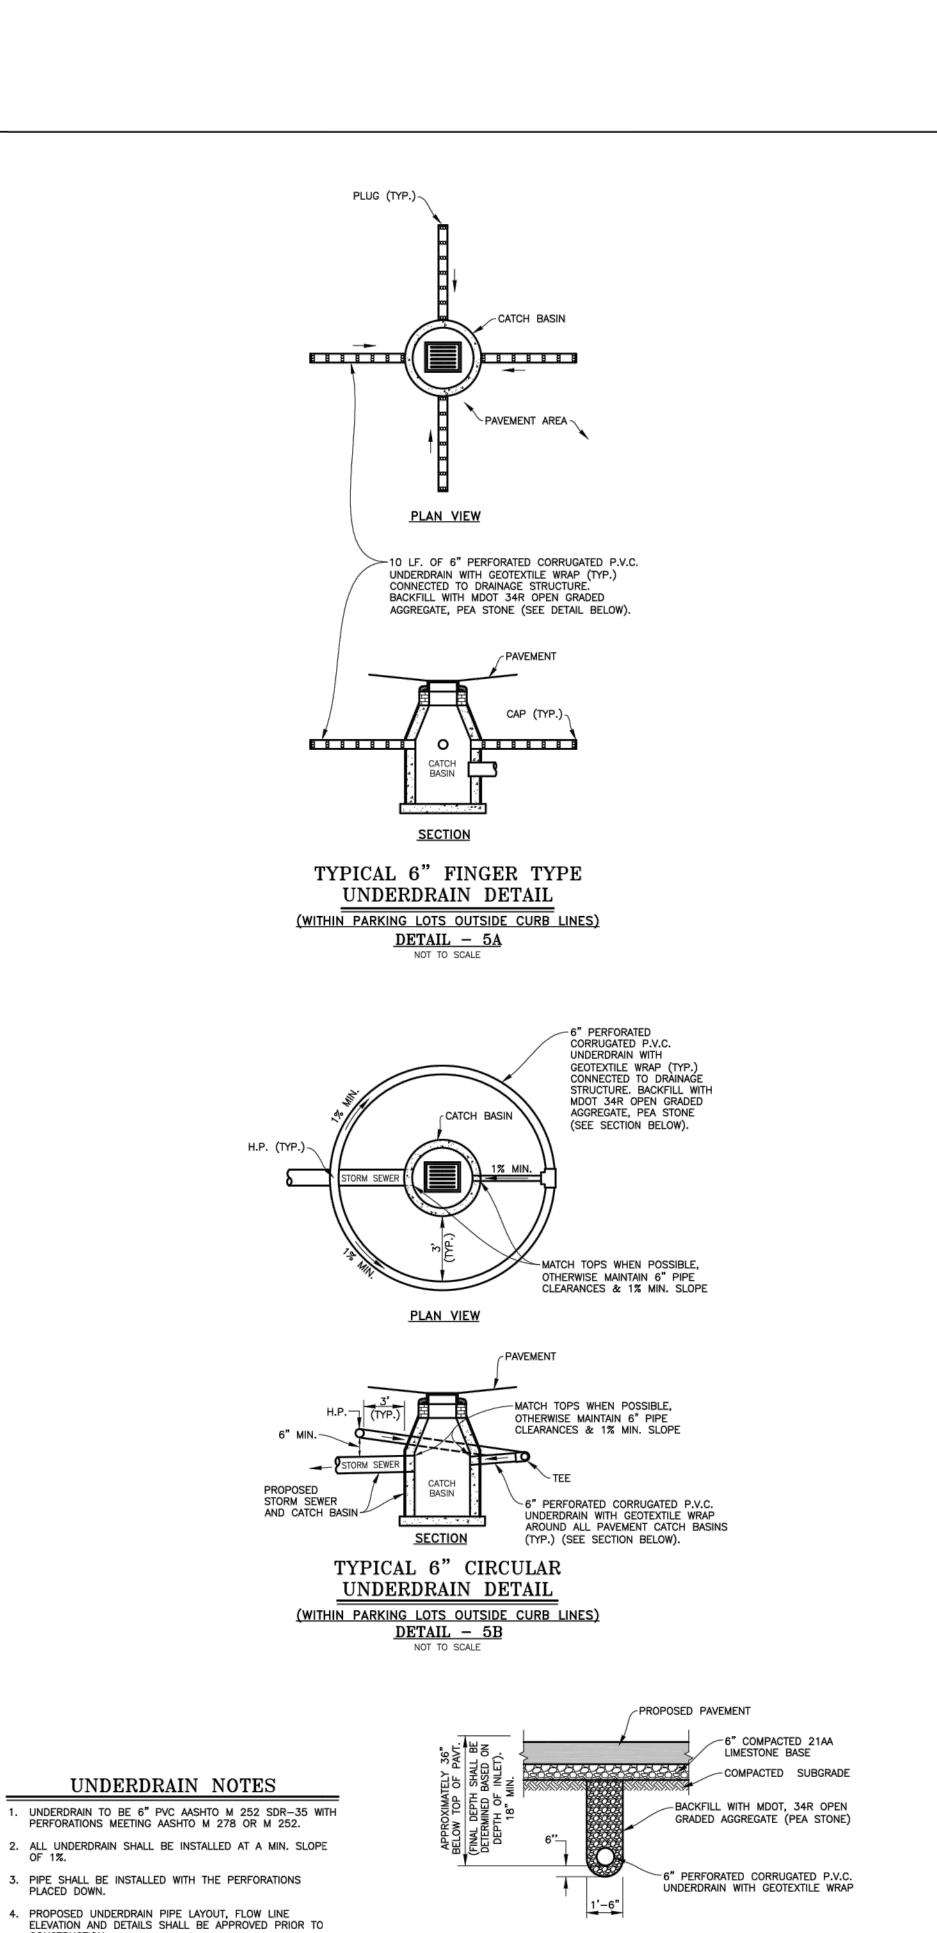

UNDERDRAIN DETAIL

DETAIL - 5C

TYPICAL UNDERDRAIN DETAILS - 5

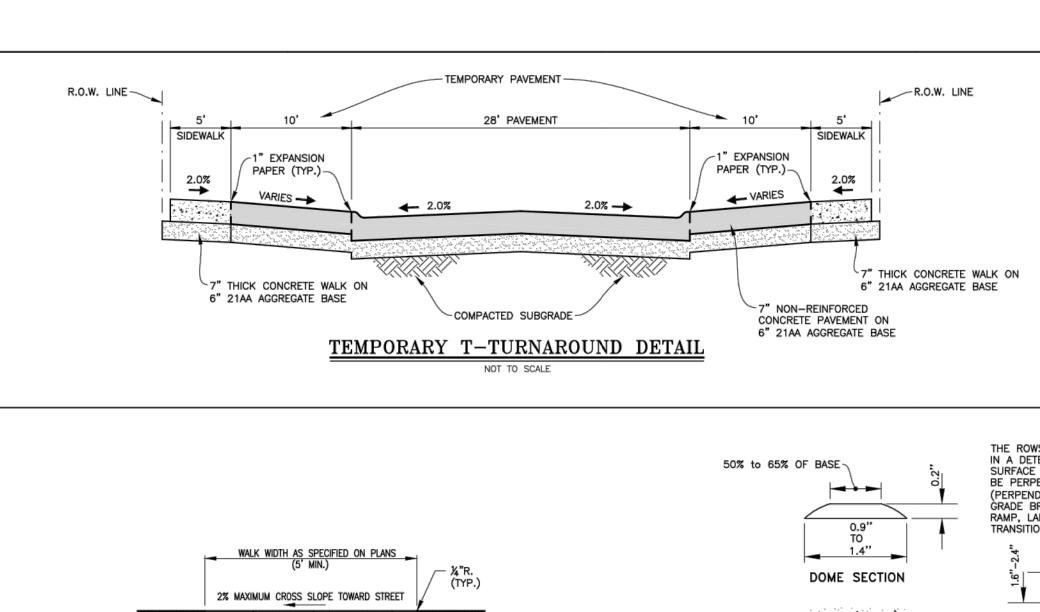

TYPICAL CONCRETE SIDEWALK DETAILS - 6



TEMPORARY T-TURNAROUND NOTES

PROVIDE TEMPORARY T-TURNAROUND PER FIGURE 2-02 OF THE MACOMB COUNTY SUBDIVISION DEVELOPMENT PROCEDURES,

2. CONSTRUCT TEMPORARY T-TURNAROUND CROSS SECTION PER THE

STANDARDS AND SPECIFICATIONS.

MACOMB, MI 48042

586-992-0710



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OF EXISTING UTILITIES (IN CONFLICT WITH PROPOSED IMPROVEMENTS) SHALL BE VERIFIED IN THE FIELD. CALL MISS DIG 3 WORKING DAYS PRIOR TO CONSTRUCTION.

PAVING STANDARD DETAILS

TOWN 3 NORTH RANGE 13 EAST

| NO. | DATE     | REVISION                |
|-----|----------|-------------------------|
| 1   | 10-15-14 | SHEET UPDATE            |
| 2   | 11-06-15 | SHEET UPDATE            |
| 3   | 01-04-16 | SIDEWALK RAMP THICKNESS |
| 4   | 01-24-17 | SHEET UPDATE            |
| 5   | 08-20-18 | SHEET UPDATE            |
| 6   | 09-26-19 | TEMP. T-TURNAROUND      |
|     |          |                         |

VERIFY SCALES
BAR IS ONE INCH ON ORIGINAL DRAWING

IF NOT ONE INCH ON THIS SHEET,
ADJUST SCALES ACCORDINGLY
NO. DRAWING NO.

N.T.S.

MA-DET-PAV

P2

TACO BELL

 $\circ$ 

REMARKS

11.15.21

END. MED20

MARCH 2021

DICKSON

315390

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1 3/8/22 Planning Comments

2 | 3/21/22 | Planning Comments

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FOR

DATE

CONTRACT DATE:

BUILDING TYPE:

PLAN VERSION:

SITE NUMBER:

PA/PM:

DRAWN BY.

JOB NO.:

STORE NUMBER:

**BRAND DESIGNER:** 


17669 23 Mile Road Macomb, MI 48042



**ENDEAVOR 2.0 TOWNSHIP PAVING DETAILS** 

PLOT DATE:

PRIOR TO CONSTRUCTION, ALL LOCATIONS AND DEPTHS **TOWNSHIP OF MACOMB** (2 OF 2) MACOMB TOWNSHIP MACOMB COUNTY

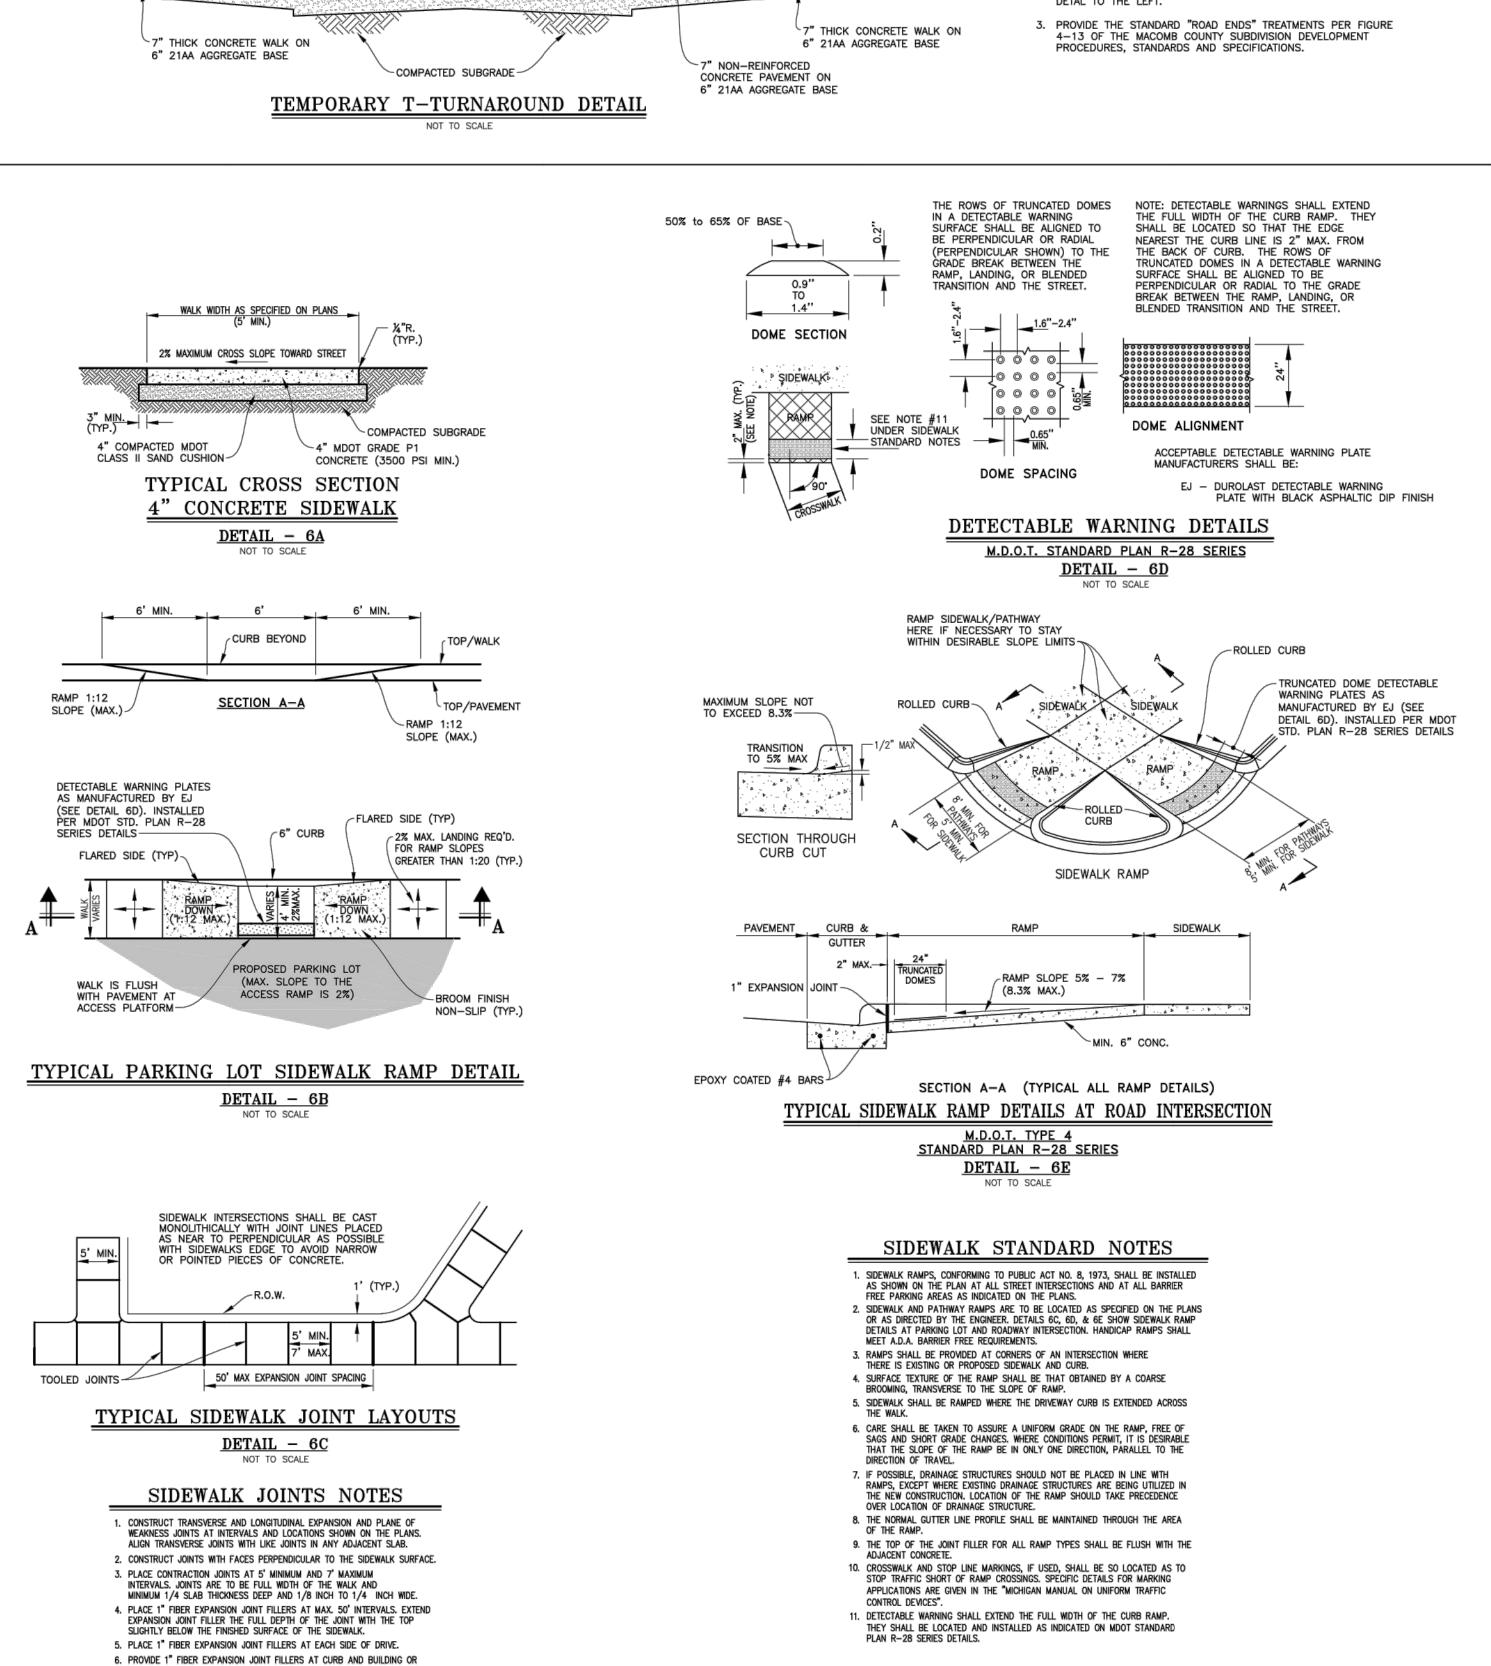

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<u>~</u>

REMARKS

Issued for Permit

11.15.21

END. MED20

**MARCH 2021** 

DICKSON

315390

457226

2021088.48

**TACO BELI** 

17669 23 Mile Road

Macomb, MI 48042

TACO BELL

**ENDEAVOR 2.0** 

**TOWNSHIP** 

SANITARY

**DETAILS** 

PLOT DATE:


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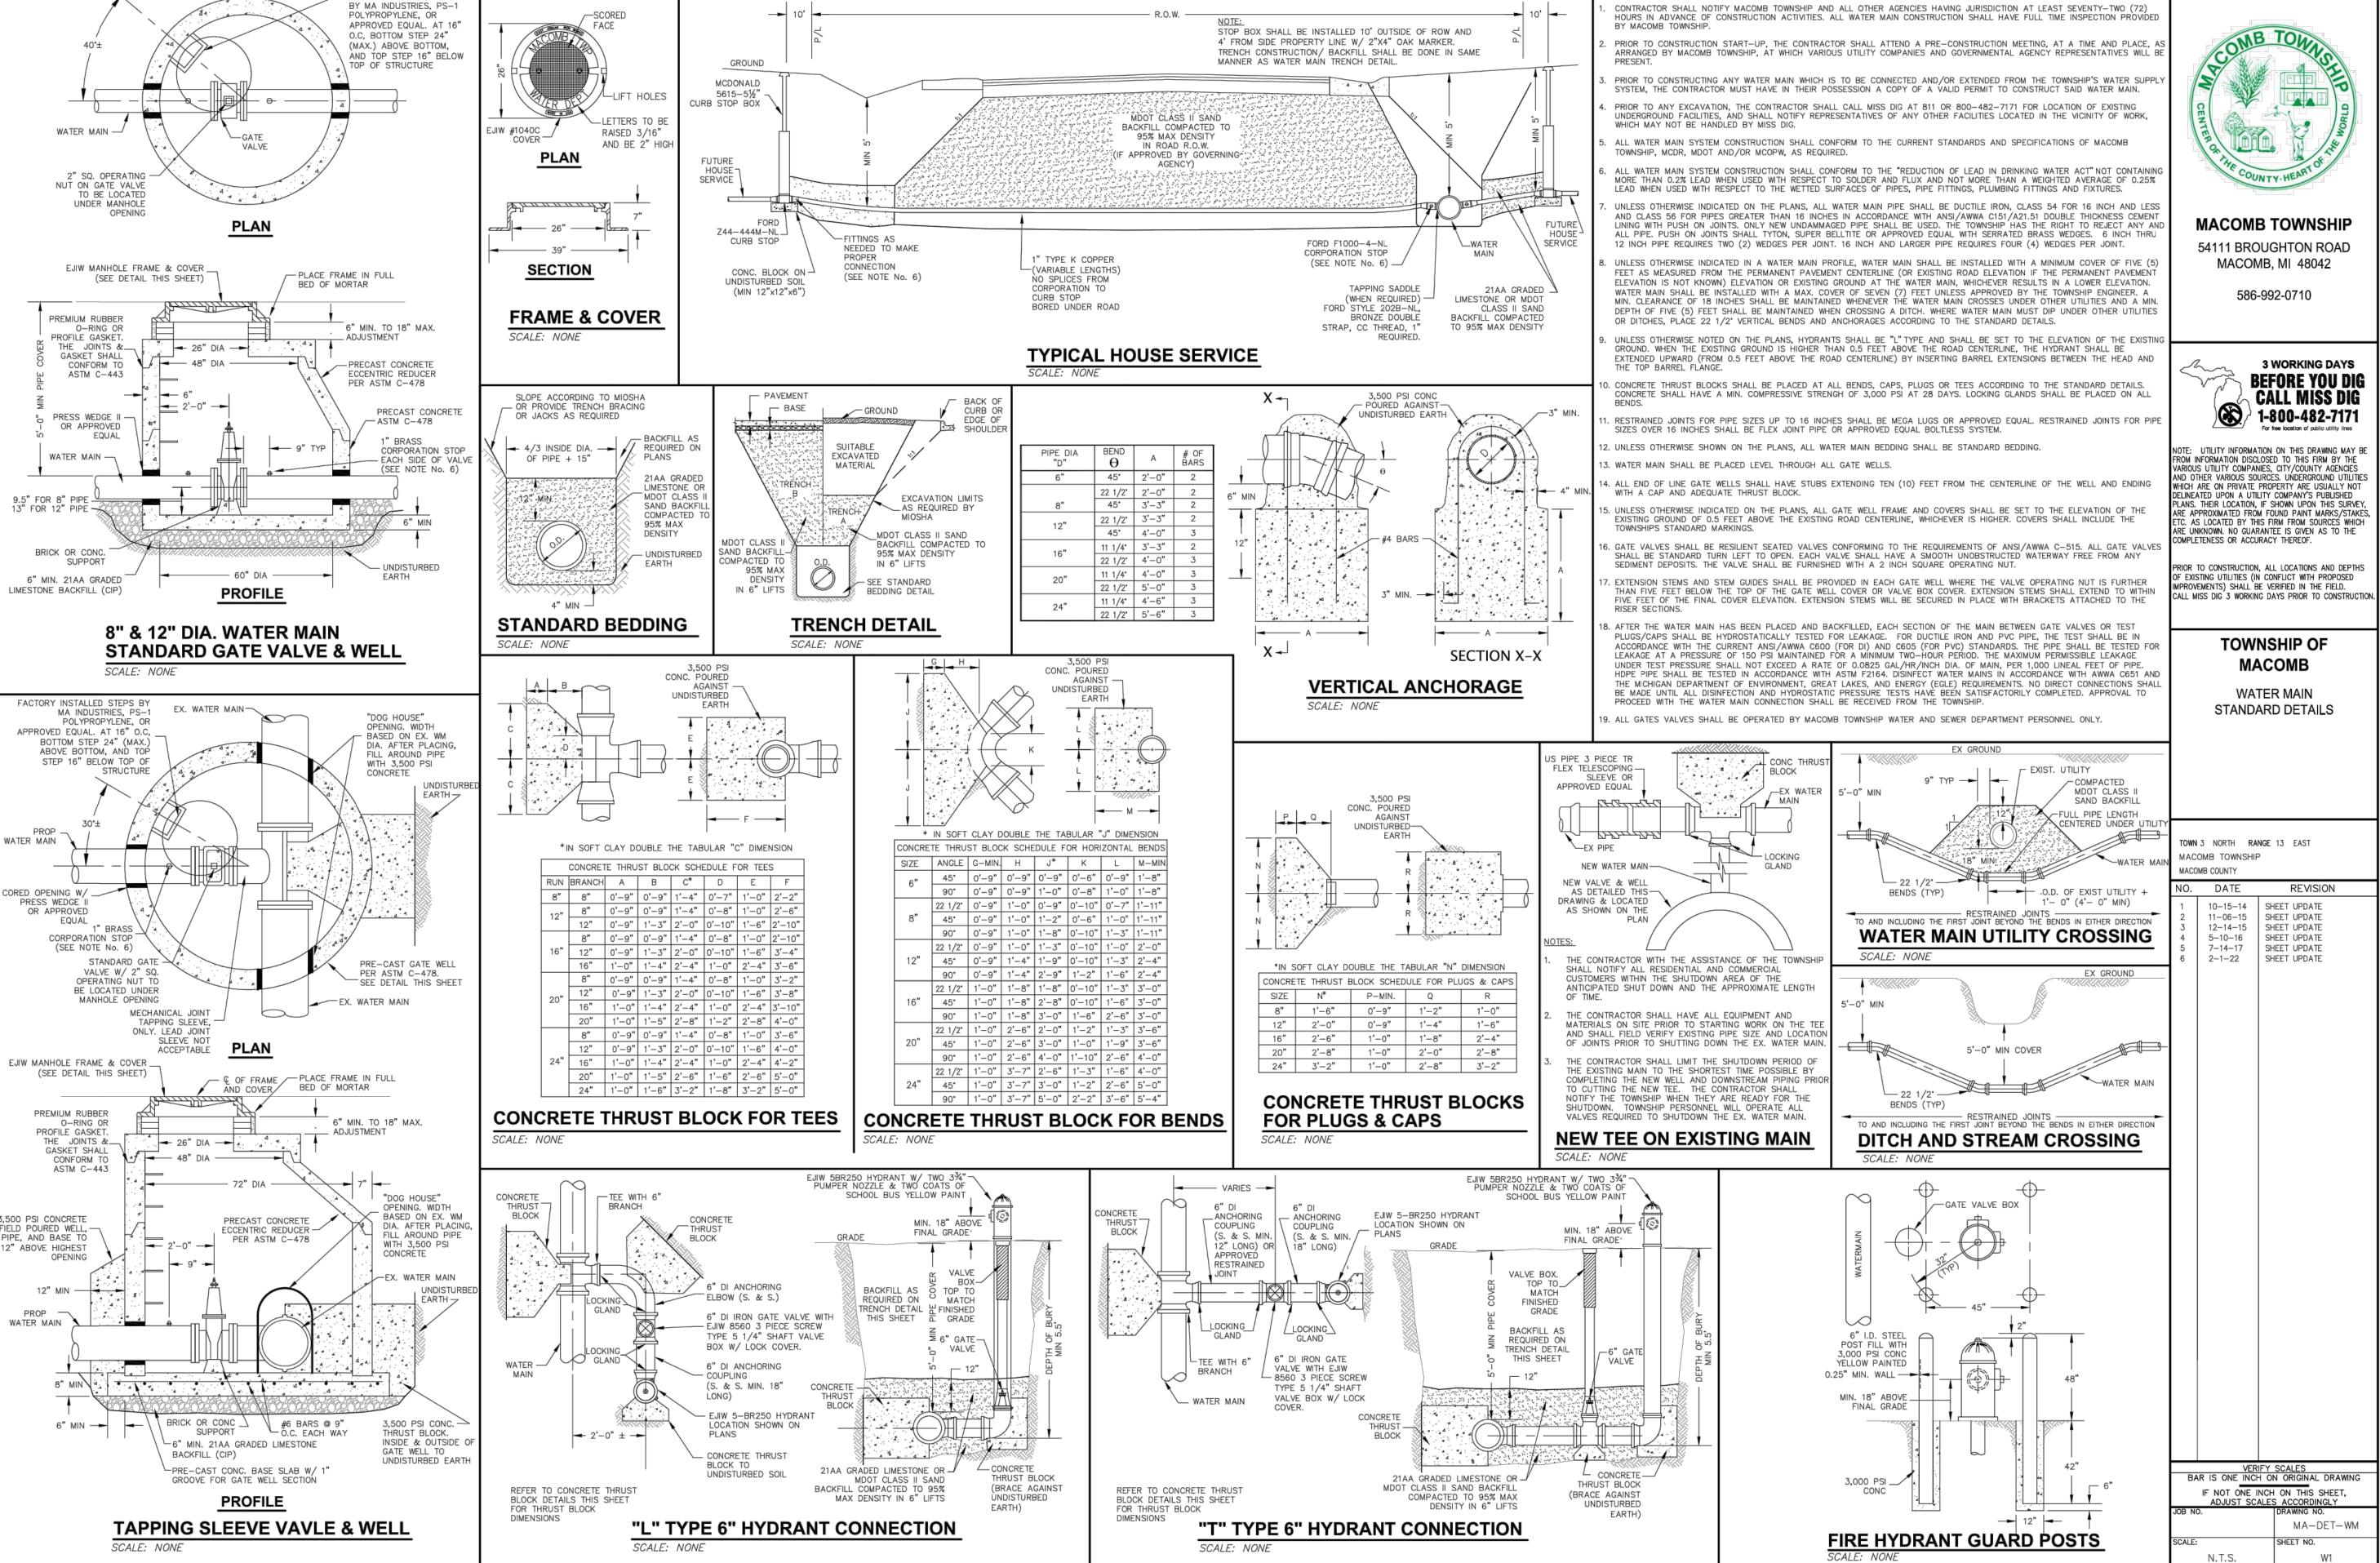
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FOR

DATE



SCALE: NONE

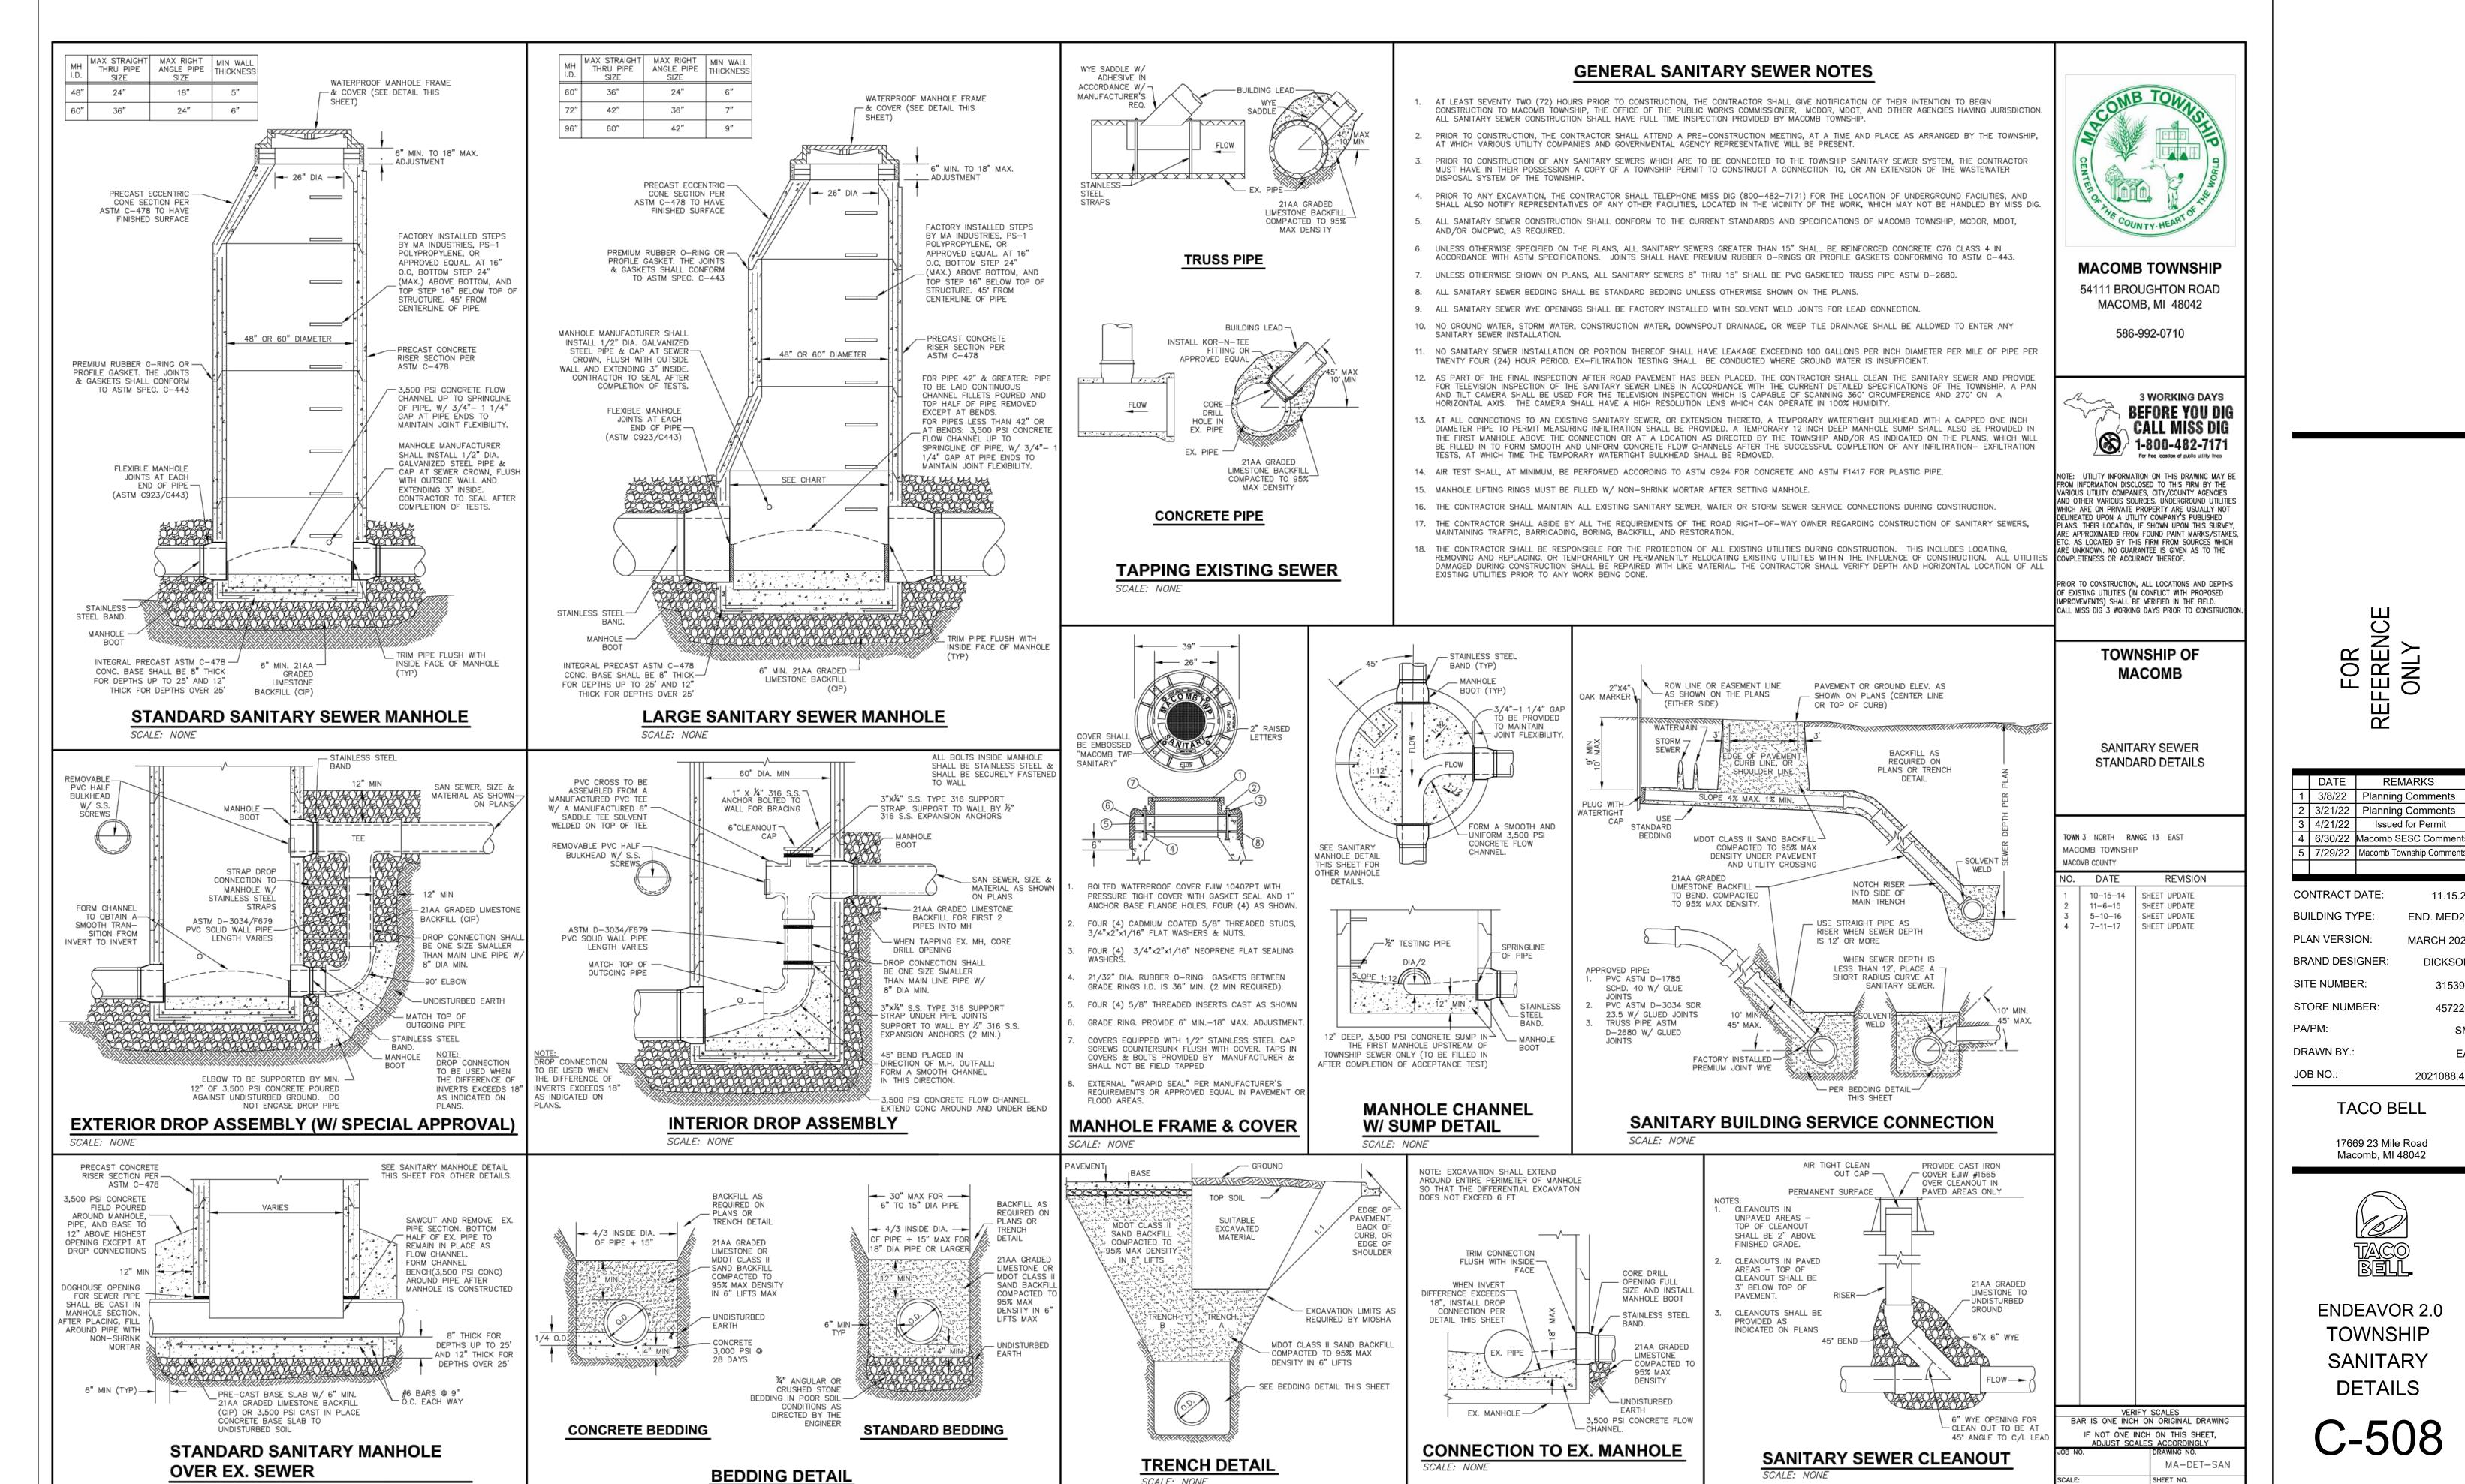

FACTORY INSTALLED STEPS

**GENERAL WATER MAIN NOTES** 

|             | ı |   | DATE    | REMARKS                  |
|-------------|---|---|---------|--------------------------|
|             |   | 1 | 3/8/22  | Planning Comments        |
|             | 1 | 2 | 3/21/22 | Planning Comments        |
| IGE 13 EAST | ı | 3 | 4/21/22 | Issued for Permit        |
|             | ı | 4 | 6/30/22 | Macomb SESC Comments     |
|             |   | 5 | 7/29/22 | Macomb Township Comments |
| DEVISION    | ı |   |         |                          |

CONTRACT DATE: 11.15.21 BUILDING TYPE: END. MED20 PLAN VERSION: **MARCH 2021** BRAND DESIGNER: DICKSON SITE NUMBER: 315390 STORE NUMBER 457226 PA/PM:

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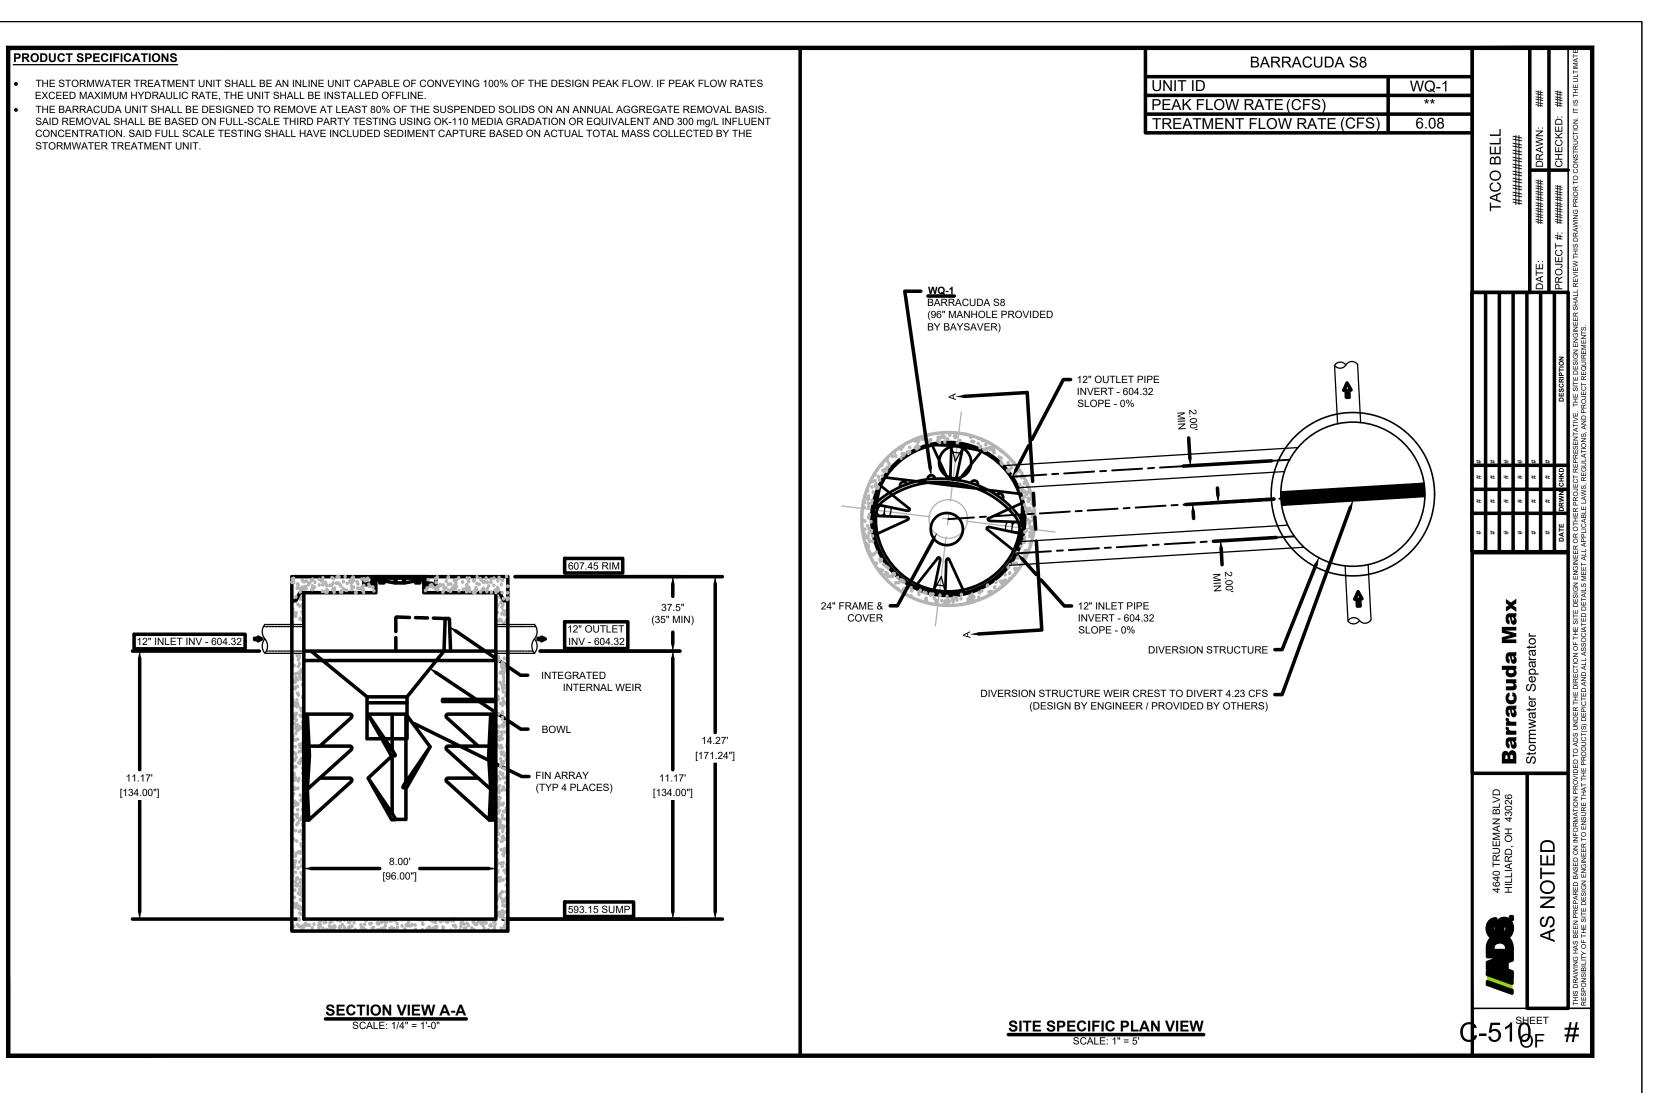
DRAWN BY. JOB NO.: 2021088.48

TACO BELI

17669 23 Mile Road Macomb, MI 48042



**ENDEAVOR 2.0 TOWNSHIP WATER DETAILS** 





FOR REFERENCE ONLY

|  |   | DATE    | REMARKS                  |
|--|---|---------|--------------------------|
|  | 1 | 3/8/22  | Planning Comments        |
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TACO BELL


17669 23 Mile Road Macomb, MI 48042



**ENDEAVOR 2.0** 

**DETAILS** 

C-510

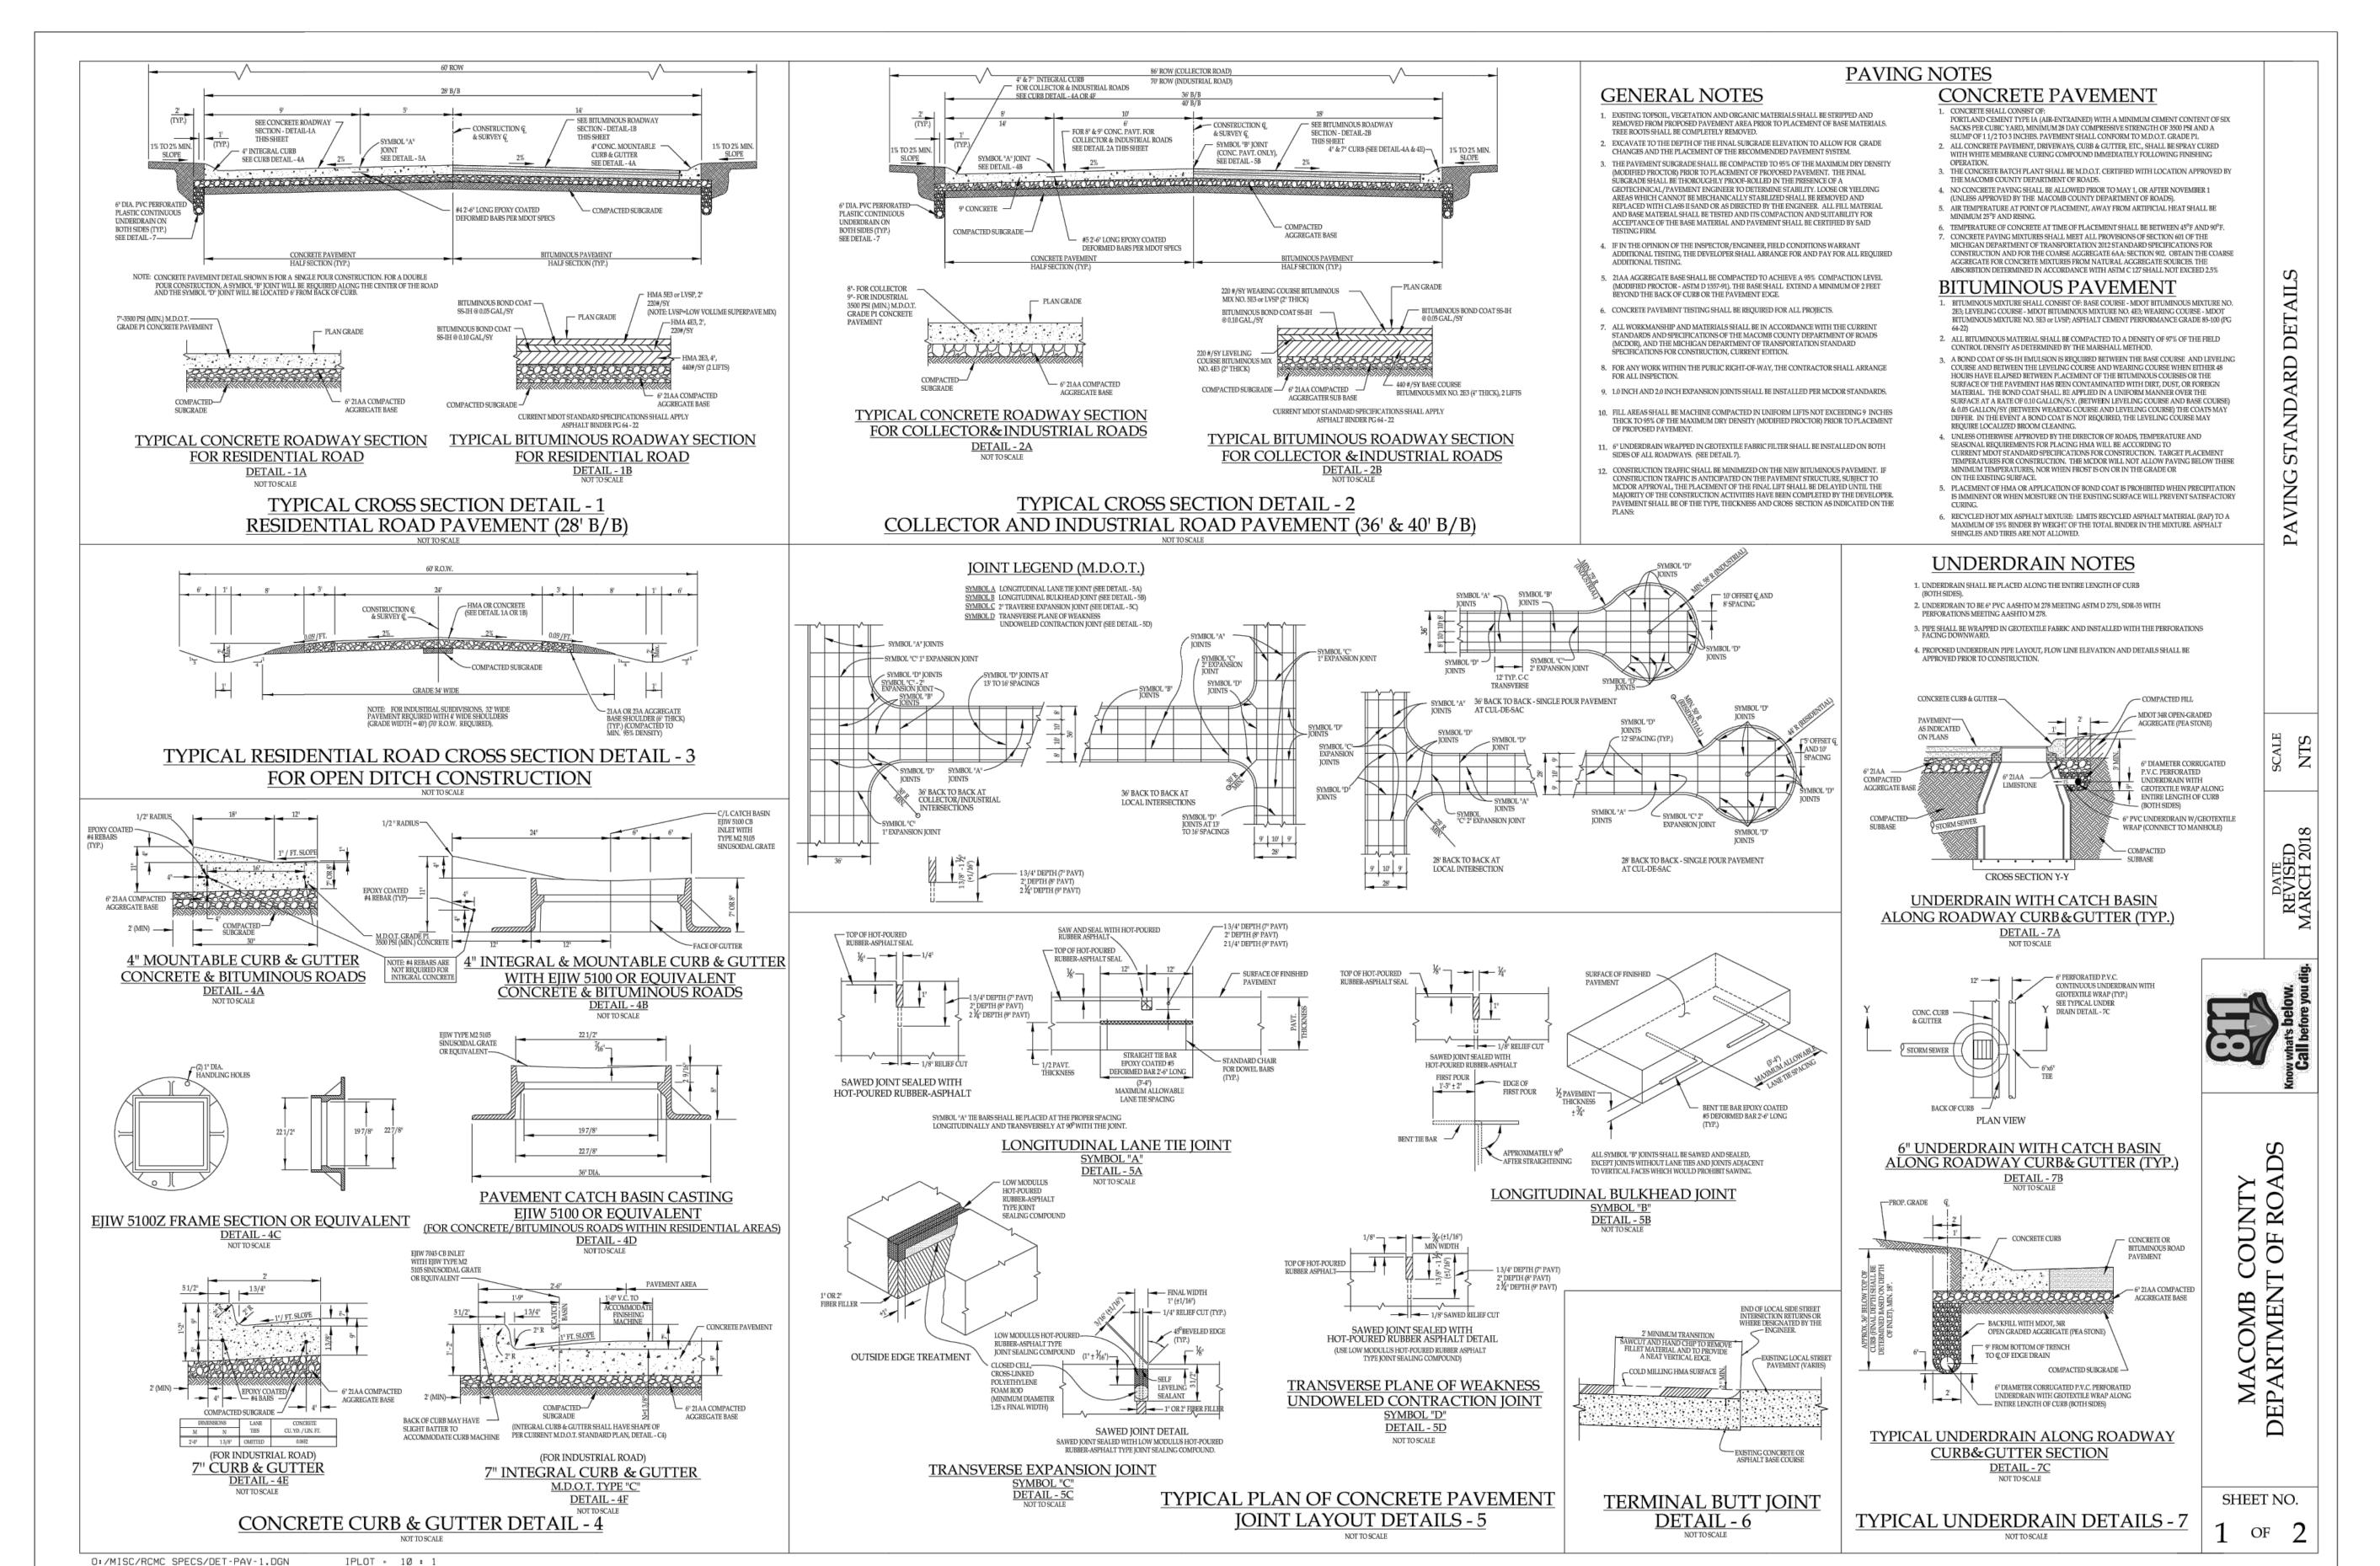

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|   | 1 | 3/8/22  | Planning Comments        |
|   | 2 | 3/21/22 | Planning Comments        |
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| l |   |         |                          |

CONTRACT DATE: 11.15.21
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PLAN VERSION: MARCH 2021
BRAND DESIGNER: DICKSON
SITE NUMBER: 315390
STORE NUMBER: 457226

PA/PM:
DRAWN BY.:

JOB NO.: 20:

TACO BELL

2021088.48


17669 23 Mile Road Macomb, MI 48042



**ENDEAVOR 2.0** 

MCDR PAVING DETAILS

C-511

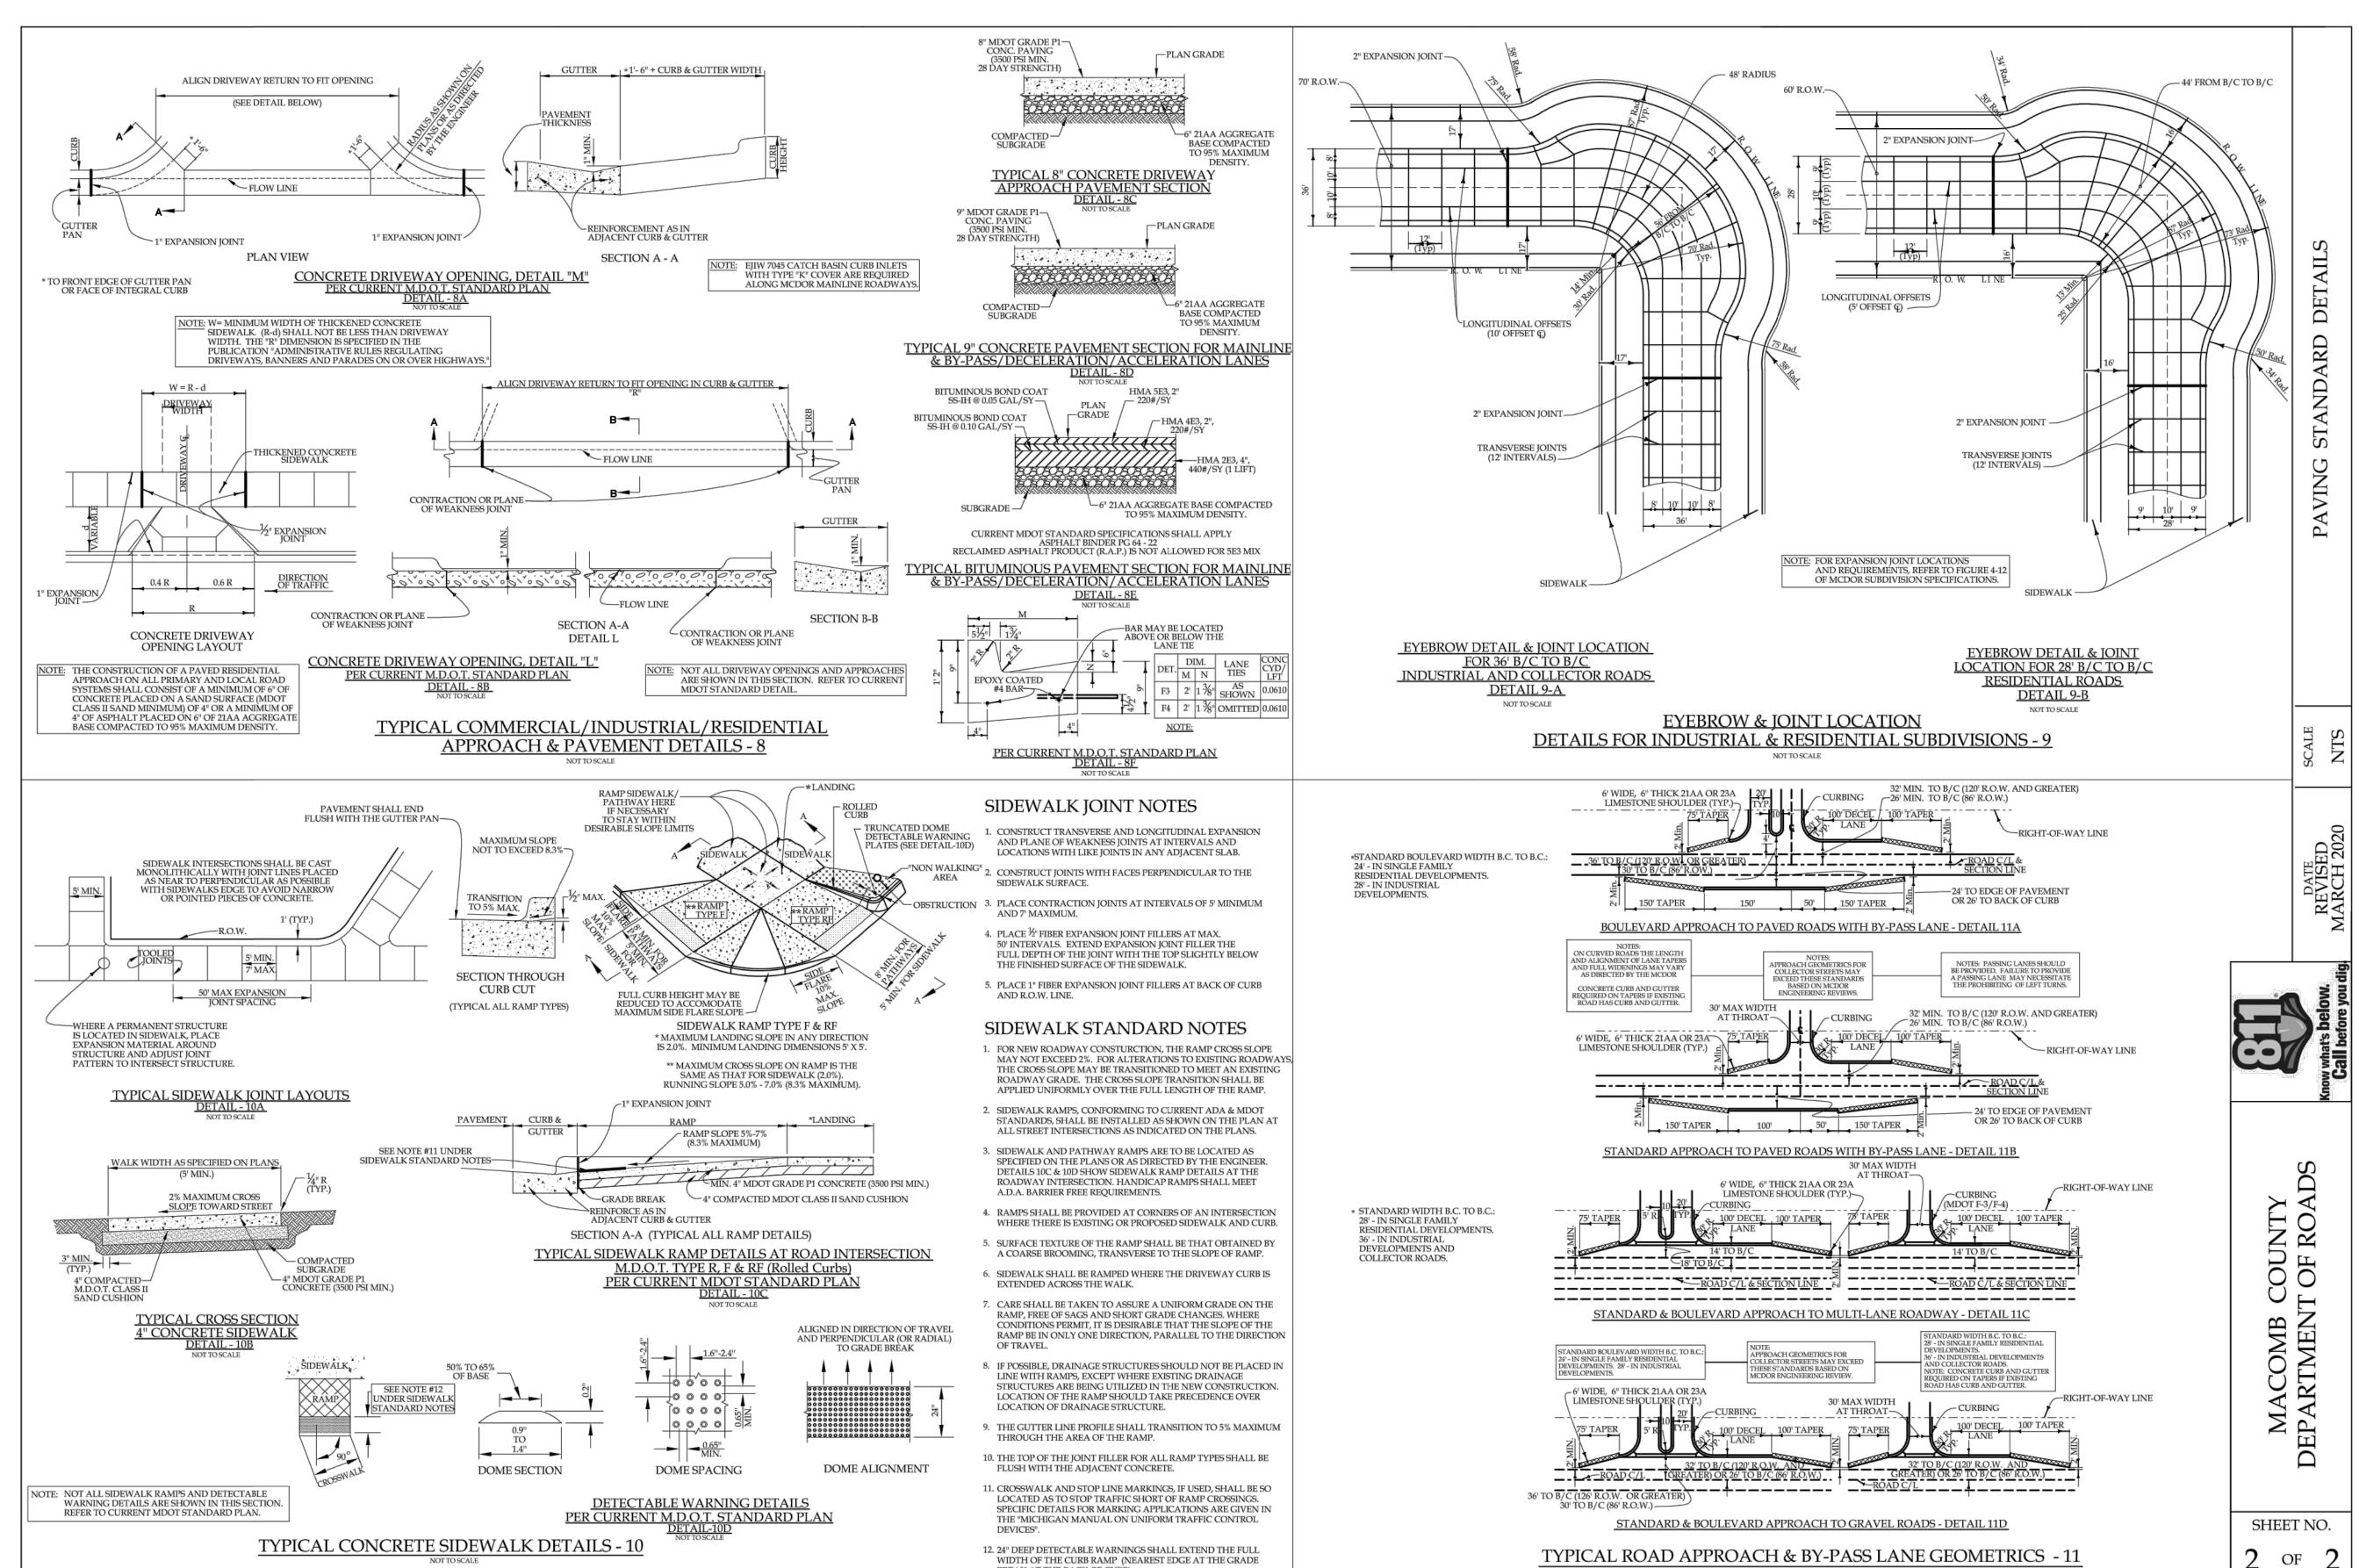

BREAK AT THE BACK OF CURB).

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|  | 1 | 3/8/22  | Planning Comments        |
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CONTRACT DATE: 11.15.21
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PA/PM: SM

JOB NO.: 2021088.48

TACO BELL

DRAWN BY.

17669 23 Mile Road Macomb, MI 48042



**ENDEAVOR 2.0** 

MCDR PAVING DETAILS

C-512

#### SCOPE OF WORK

- 1. THIS WORK SHALL CONSIST OF PERFORMING CLEARING AND GRUBBING, SOIL PREPARATION, FINISH GRADING, PLANTING AND DRAINAGE, INCLUDING ALL LABOR, MATERIALS, TOOLS, EQUIPMENT, AND ANY OTHER APPURTENANCES NECESSARY FOR THE COMPLETION OF THIS PROJECT.
- 2. QUANTITY TAKEOFF IS SUPPLIED FOR CONTRACTOR'S ASSISTANCE ONLY. CONTRACTOR IS RESPONSIBLE FOR SUPPLYING ALL PLANT MATERIALS AS PER PLAN.
- 3. NO ADDITIONAL COMPENSATION SHALL BE PAID TO THE CONTRACTOR FOR DAMAGE AND REPAIR WITHIN EASEMENT OR RIGHT-OF-WAY LIMITS.

#### PRESERVATION/PROTECTION (IF APPLICABLE)

- CONTRACTOR SHALL MAINTAIN AND PRESERVE TREES AND SHRUBS NOT BEING REMOVED, INCLUDING THEIR ROOTS. TREE PROTECTION FENCING SHALL BE USED AT THE DRIP LINE OF ALL TREES AND SHRUBS WITHIN 50 FEET OF CONSTRUCTION EXCEPT AS SHOWN ON PLAN. FENCING SHALL REMAIN IN PLACE UNTIL FINAL PLANT INSPECTION FOLLOWING CONSTRUCTION. MATERIALS SHALL NOT BE STOCKPILED WITHIN THIS DEFINED AREA AND VEHICLES AND OTHER EQUIPMENT SHALL BE OPERATED TO AVOID SOIL COMPACTION.
- 2. FEEDER ROOTS SHOULD NOT BE CUT IN AN AREA EQUAL TO TWICE THE TREE CIRCUMFERENCE (MEASURED 6" ABOVE THE GROUND LINE IN INCHES) EXPRESSED IN FEET. (EXAMPLE: A CIRCUMFERENCE OF 10" WOULD HAVE A 'NO CUT' ZONE OF 20 FEET IN ALL DIRECTIONS FROM THE TREE). THIS SHOULD APPLY TO UTILITY SERVICES, IF FEASIBLE. THE ONLY EXCEPTION TO THIS REQUIREMENT WILL BE THOSE SPECIFICALLY ALLOWED BY THE LANDSCAPE ARCHITECT, SPECIFICATIONS OR AS INDICATION ON THE PLANS.
- 3. TREE TRUNKS AND EXPOSED ROOTS DAMAGED DURING EQUIPMENT OPERATIONS SHALL BE TREATED IN ACCORDANCE WITH THE ARBOR CULTURAL STANDARDS OF THE CITY.

#### PLANT MATERIALS

- I. GENERAL ALL MATERIALS SHALL BE OF ITS KIND AVAILABLE AND SHALL HAVE BEEN GROWN IN A CLIMATE SIMILAR TO THAT ON SITE.
- 2. PLANTS ALL PLANTS SHALL BE HEALTHY, OF NORMAL GROWTH, WELL ROOTED, FREE FROM DISEASE AND INSECTS. QUALITY AND SIZE OF PLANT MATERIAL SHALL CONFORM TO ANSI Z60.1 "AMERICAN STANDARDS FOR NURSERY STOCK".
- 3. VARIETIES AND SIZES OF PLANTS SHALL BE AS SHOWN ON DRAWINGS.
- 4. PLANTS SHALL BE IN A HEALTHY, VIGOROUS CONDITION, FREE OF DEAD OR BROKEN BRANCHES, SCARS THAT ARE NOT COMPLETELY HEALED, FROST CRACKS, DISFIGURING KNOTS, BROKEN OR ABRADED BARK, REDUNDANT LEADERS OR BRANCHES, OR ABERRATIONS OF ANY KIND. PLANTS SHALL NOT HAVE MULTIPLE LEADERS, UNLESS THIS IS THE NATURAL FORM.
- 5. BALLED AND BURLAPPED (B&B) PLANTS SHALL BE DUG WITH A FIRM ROOT BALL OF NATURAL EARTH, OF A SIZE IN PROPORTION TO THE PLANT'S SIZE, AS MEASURED BY CALIPER, HEIGHT, OR SPREAD. BALLED AND BURLAPPED PLANTS SHALL BE HANDLED ONLY BY THE ROOT BALL, NOT BY THE TRUNK OR BRANCHES, AS THIS MAY BREAK OR LOOSEN THE ROOT BALL AND DAMAGE THE ROOT SYSTEM. CONTAINER PLANTS SHALL HAVE BEEN ESTABLISHED FOR A MINIMUM OF ONE FULL GROWING SEASON IN THEIR CONTAINERS BEFORE INSTALLATION. CONTAINER PLANTS SHALL BE HANDLED ONLY BY THE CONTAINER, NOT BY THE STEMS OR BRANCHES, AS THIS MAY PULL THE PLANT OUT OF THE CONTAINER AND BREAK OR LOOSEN THE ROOT BALL AND DAMAGE THE ROOT SYSTEM.
- 6. PLANTS SHALL BE PROTECTED FROM DRYING OUT DURING SHIPPING WITH TARPAULINS OR OTHER COVERINGS. PLANTS SHALL BE PROTECTED FROM DRYING OUT AFTER DELIVERY BY PLANTING IMMEDIATELY; IF THIS IS NOT POSSIBLE, THE ROOT BALL SHALL BE COVERED WITH PEAT MOSS OR EARTH, AND WATERED FREQUENTLY TO KEEP IT MOIST UNTIL PLANTING.
- 7. DO NOT HANDLE, MOVE, BIND, TIE OR OTHERWISE TREAT PLANTS SO AS TO DAMAGE THE ROOT BALL, ROOTS, TRUNK, OR BRANCHES IN ANY WAY.

# TOPSOIL

- TOPSOIL HAS BEEN (OR WILL BE) STOCKPILED FOR REUSE IN LANDSCAPE WORK. IF QUANTITY OF STOCKPILED TOPSOIL IS INSUFFICIENT, PROVIDE ADDITIONAL TOPSOIL AS REQUIRED TO COMPLETE LANDSCAPE WORK. IMPORTED TOPSOIL SHALL CONSIST OF LOOSE, FRIABLE, LOAMY TOPSOIL WITHOUT ADMIXTURE OF SUBSOIL OR REFUSE. ACCEPTABLE TOPSOIL SHALL CONTAIN NOT LESS THAN 3 PERCENT NOR MORE THAN 20 PERCENT ORGANIC MATTER.
- 2. PLANTING BACKFILL FOR PARKING LOT ISLANDS SHALL CONSIST OF A HOMOGENEOUS MIXTURE OF 3 PARTS TOPSOIL TO ONE PART SPHAGNUM PEAT INSTALLED OVER A 6" THICKNESS OF NO. 57 AGGREGATE.

#### SOIL CONDITIONING

- OBTAIN LABORATORY ANALYSIS OF STOCKPILED AND IMPORTED TOPSOIL COMPLETE WITH RECOMMENDATIONS FOR SOIL AMENDMENT.
- 2. BEFORE MIXING, CLEAN TOPSOIL OF ROOTS, PLANTS, SOD, STONES, CLAY LUMPS, AND OTHER EXTRANEOUS MATERIALS HARMFUL OR TOXIC TO PLANT GROWTH.
- 3. MIX SPECIFIED SOIL AMENDMENTS AND FERTILIZERS WITH TOPSOIL AT RATES SPECIFIED BY THE LAB REPORT. DELAY MIXING OF FERTILIZER IF PLANTING WILL NOT FOLLOW PLACING OF PLANTING SOIL WITHIN A FEW DAYS.
- FOR PLANTING BEDS AND LAWNS, MIX PLANTING SOIL EITHER PRIOR TO PLANTING OR APPLY ON SURFACE OF TOPSOIL AND MIX THOROUGHLY BEFORE PLANTING. MIX LIME WITH DRY SOIL PRIOR TO MIXING OF FERTILIZER.
- 5. PREVENT LIME FROM CONTACTING ROOTS OF ACID-LOVING PLANTS.
- 6. APPLY PHOSPHORIC ACID FERTILIZER (OTHER THAN THAT CONSTITUTING A PORTION OF COMPLETE FERTILIZERS) DIRECTLY TO SUBGRADE BEFORE APPLYING PLANTING SOIL AND TILLING.

#### PLANTING SOIL

1. PLANTING SOIL MIX SHALL BE CLEAR OF ALL STONES AND DEBRIS 1" OR LARGER, AND CONSIST OF THE FOLLOWING: 25% ORGANIC COMPOST, 75% ACCEPTABLE TOPSOIL.

#### OTHER MATERIALS

- 1. BED EDGING EDGING SHALL BE 4" STEEL EDGING WITH THREE (3) METAL ANCHOR STAKES PER 20 FOOT SECTION. ALL MASS PLANTING BEDS SHALL HAVE EDGING PLACED BETWEEN MULCH AREA AND ANY ADJACENT TURF AREA.
- . MULCH: ORGANIC MULCH FREE FROM DELETERIOUS MATERIALS AND SUITABLE FOR TOP DRESSING OF TREES, SHRUBS, OR PLANTS AND CONSISTING OF THE FOLLOWING:
- a. NON-DRYED, DOUBLE SHREDDED HARDWOOD SHALL BE INSTALLED IN ALL OTHER LANDSCAPE BEDS AT A DEPTH OF 3 INCHES.

#### **GENERAL WORK PROCEDURES**

- 1. LANDSCAPE WORK SHALL BE ACCORDING TO THE WORKMANLIKE STANDARDS ESTABLISHED FOR LANDSCAPE CONSTRUCTION AND PLANTING IN THE MICHIGAN STANDARDIZED LANDSCAPE SPECIFICATIONS (ASLA) AND ANY LOCAL LANDSCAPE ORDINANCES.
- 2. CONTRACTOR SHALL OBTAIN A COPY OF LOCAL ORDINANCES REGARDING ACCEPTABLE PLANT AND PLANTING DETAILS AND ABIDE BY THOSE ORDINANCES AND DETAILS.
- ENGINEER RESERVES THE RIGHT TO REJECT ALL PLANT MATERIAL DEEMED NOT ACCEPTABLE.
- 4. ANY PROPOSED PLANT SUBSTITUTIONS SHALL BE EQUIVALENT IN FORM, HABIT, STRUCTURE, BRANCHING AND LEAF TYPE AND MUST BE ISSUED TO THE LANDSCAPE ARCHITECT FOR APPROVAL, IN WRITING, PRIOR TO INSTALLATION.

#### **WEEDING**

1. BEFORE AND DURING PRELIMINARY GRADING AND FINISH GRADING, ALL WEEDS AND GRASSES SHALL BE DUG OUT BY THE ROOTS AND DISPOSED OF AT THE CONTRACTOR'S EXPENSE.

#### **PLANTING**

- 1. POSITION TREES AND SHRUBS AT THEIR INTENDED LOCATIONS AS PER THE PLANS AND SECURE THE APPROVAL OF THE OWNER BEFORE EXCAVATING PITS, MAKING NECESSARY ADJUSTMENTS AS DIRECTED.
- 2. PLANTING PITS SHALL BE AS PER DETAILS.
- 3. PREPARED SOIL SHALL BE TAMPED FIRMLY AT BOTTOM OF PIT. FILL WITH PLANTING SOIL AROUND BALL OF PLANT. COMPLETE BACKFILLING AND WATER THOROUGHLY.
- 4. EACH TREE AND SHRUB SHALL RECEIVE THE LANDSCAPER'S BIONUTRITION (3-0-3) GRANULAR WITH MYCORRHIZAL TECHNOLOGY FERTILIZER OR APPROVED OTHER. APPLY FERTILIZER PER MANUFACTURER'S SPECIFICATIONS.
- 5. WATER IMMEDIATELY AFTER PLANTING. WATER SHALL BE APPLIED TO EACH TREE AND SHRUB IN SUCH MANNER AS NOT TO DISTURB BACKFILL AND TO THE EXTENT THAT ALL MATERIALS IN THE PLANTING HOLE ARE THOROUGHLY SATURATED.
- 6. INSTALL BED EDGING AND MULCH PER MATERIALS SPECIFICATION AND DETAILS.
- REMOVE ALL SALES TAGS, STRINGS, STRAPS, WIRE, ROPE OR OTHER MATERIALS THAT MAY INHIBIT PLANT GROWTH BOTH ABOVE AND BELOW THE SURFACE OF THE SOIL.
- REMOVE ANY BROKEN, SUCKERING, DISEASED, CRISSCROSSED OR AESTHETICALLY
  DISPLEASING BRANCHES BACK TO LIVE LEADER OR SIDE LATERAL WITH A FLUSH CUT.

#### FINISH GRADING

- ALL AREAS WILL BE GRADED BY THE CONTRACTOR TO SUBSTANTIALLY PLUS/MINUS 0.1 FOOT OF FINISH GRADE.
- 2. ALL LAWN AND PLANTING AREAS SHALL BE GRADED TO A SMOOTH, EVEN, UNIFORM PLANE WITH NO ABRUPT CHANGE OF SURFACE. SOIL AREAS ADJACENT TO THE BUILDINGS SHALL SLOPE AWAY FROM THE BUILDINGS.
- 3. ALL PLANTING AREAS SHALL BE GRADED AND MAINTAINED TO ALLOW FREE FLOW OF SURFACE WATER.
- 4. PARKING LOT ISLAND SHALL BE BACKFILLED AS PART OF THIS CONTRACT.

# GROUND COVER

- 1. SPACING AND VARIETY OF GROUND COVER SHALL BE AS SHOWN ON DRAWINGS.
- 2. MULCH GROUND COVER WITH 2" THICKNESS OF SPHAGNUM PEAT.
- 3. IMMEDIATELY AFTER PLANTING GROUND COVER, CONTRACTOR SHALL THOROUGHLY WATER GROUND COVER.
- ALL GROUND COVER AREAS SHALL BE TREATED WITH A PRE-EMERGENT BEFORE FINAL LANDSCAPE INSPECTION. GROUND COVER AREAS SHALL BE WEEDED PRIOR TO APPLYING PRE-EMERGENT. PRE-EMERGENT TO BE APPLIED AS PER MANUFACTURER'S RECOMMENDATION.

## <u>GUARANTEE</u>

1. CONTRACTOR SHALL GUARANTEE ALL PLANTS FOR A PERIOD OF ONE (1) YEAR FROM DATE OF PROJECT ACCEPTANCE BY THE OWNER.

## <u>CLEANUP</u>

1. UPON THE COMPLETION OF ALL PLANTING WORK AND BEFORE FINAL ACCEPTANCE, THE CONTRACTOR SHALL REMOVE ALL MATERIAL, EQUIPMENT, AND DEBRIS RESULTING FROM HIS WORK. AN 'ACCEPTABLE CONDITION' SHALL BE AS DEFINED AND APPROVED BY THE OWNER'S AUTHORIZED REPRESENTATIVE.

# LANDSCAPE NOTES & PLANTING SPECIFICATIONS

#### IRRIGATION

- CONTRACTOR SHALL PROVIDE & INSTALL AN IRRIGATION SYSTEM TO PROVIDE 100% COVERAGE OF THE SITE.
- IRRIGATED AREAS WITHIN 5 FEET OF BUILDING WALLS SHALL BE IRRIGATED BY DRIP IRRIGATION OR SIMILAR. CONTRACTOR SHALL ENSURE BUILDING WALLS AND WINDOWS WILL NOT BE DAMAGED OR STAINED BY IMPROPER IRRIGATION INSTALLATION OR POOR SELECTION OF FIXTURES.
- 3. SYSTEM SHALL INCLUDE ALL SPRINKLER FIXTURES, DRIP TUBING, PIPING, VALVES, WIRING AND CONTROLS TO PROVIDE A COMPLETE FUNCTIONAL SYSTEM THAT SHALL COMPLY WITH CITY CODE.
- 5. IRRIGATION CONTRACTOR SHALL PROVIDE A METHOD FOR WINTERIZATION. WINTERIZATION SHALL BE PERFORMED BY CONTRACTOR UPON COMPLETION IF SYSTEM IS INSTALLED BETWEEN NOVEMBER 1 AND MARCH 31.
- 6. PRIOR TO UPDATING THE IRRIGATION SYSTEM, A CERTIFIED IRRIGATION DESIGNER SHALL PROVIDE SHOP DRAWINGS TO ENGINEER FOR APPROVAL.
- 5. UPON APPROVAL OF SHOP DRAWINGS, THE UPDATED IRRIGATION SYSTEM SHALL BE APPROVED BY OWNER FOR FINAL ACCEPTANCE.

#### MAINTENANCE

(MAINTENANCE PERIOD TO COMMENCE AFTER FINAL INSPECTION.)

- 1. MAINTENANCE PERIOD FOR THIS CONTRACT SHALL BE 90 CALENDAR DAYS COMMENCING AFTER FINAL INSPECTION OF CONSTRUCTION.
- 2. MAINTAIN TREES, SHRUBS AND OTHER PLANTS BY PRUNING, CULTIVATING AND WEEDING AS REQUIRED FOR HEALTHY GROWTH. RESTORE PLANTING SAUCERS. RESET TREES AND SHRUBS TO PROPER GRADES OR VERTICAL POSITION AS REQUIRED.
- 3. MAINTAIN LAWNS BY WATERING, MOWING, TRIMMING, AND OTHER OPERATIONS SUCH AS ROLLING, REGRADING AND REPLANTING AS REQUIRED TO ESTABLISH A SMOOTH, ACCEPTABLE LAWN, FREE OF ERODED OR BARE AREAS.
- 4. MAINTAIN THE LANDSCAPING BY KEEPING ALL PLANTS DISEASE-FREE AND PLANTING BEDS GROOMED, EXCEPT IN NATURALLY OCCURRING VEGETATION AREAS.
- 5. REPLACE ANY REQUIRED PLANTING(S), WHICH SEVERELY DECLINE OR DIE AFTER THE DATE OF PLANTING. SUCH REPLACEMENT SHALL OCCUR DURING THE NEXT APPROPRIATE PLANTING SEASON.

#### **SODDING**

1. SOD SHALL BE FIRST GRADE CERTIFIED BLENDS OF THE FOLLOWING SPECIES PER HARDINESS ZONE CONTAINING NOT MORE THAN 30 PERCENT OF OTHER GRASSES AND CLOVERS, AND FREE FROM ALL NOXIOUS WEEDS.

ZONES 3, 4 & 5: APPROVED BLUE GRASS BLEND ZONE 6: APPROVED FESCUE BLEND ZONES 7 & 8: APPROVED BERMUDA BLEND

2. SOD SHALL BE RECENTLY MOWED TO A HEIGHT OF NOT LESS THAN 3 INCHES. IT SHALL BE

ZONES 9 & 10: APPROVED ST AUGUSTINE FLORATAM BLEND

- CUT INTO STRIPS OF NOT LESS THAN 3 FEET AND NOT OVER 6 FT. WITH A UNIFORM WIDTH OF NOT OVER 24 INCHES.
- 3. SOD SHALL BE CUT TO A DEPTH EQUAL TO THE GROWTH OF THE FIBROUS ROOTS BUT IN NO CASE LESS THAN 1 INCH.

4. SOD SHALL BE DELIVERED TO THE JOB WITHIN 24 HOURS AFTER BEING CUT AND SHALL BE

INSTALLED WITHIN 48 HOURS AFTER BEING CUT.

5. BEFORE SOD IS PLACED, THE SOD BED WILL HAVE BEEN EXCAVATED TO SUCH A DEPTH

- THAT WHEN THE SOD IS IN PLACE THE TOP OF THE SOD WILL BE FLUSH WITH THE SURROUNDING GRADE.

  6. NO SOD SHALL BE PLACED WHEN THE TEMPERATURE IS BELOW 32 DEGREES F. NO FROZEN
- PLACED BETWEEN THE DATES OF JUNE 1ST AND OCTOBER 15TH, IT SHALL BE COVERED IMMEDIATELY WITH A STRAW MULCH 1 INCH THICK (LOOSE MEASUREMENT).

  7. AFTER LAYING. THE SOD SHALL BE WATERED THOROUGHLY AND TAMPED WITH APPROVED

SOD SHALL BE PLACED NOR SHALL ANY SOD BE PLACED ON FROZEN SOIL. WHEN SOD IS

- SOD TAMPERS SUFFICIENTLY TO BRING THE SOD INTO CLOSE CONTACT WITH THE SOD BED AND INSURE TIGHT JOINTS BETWEEN THE SECTIONS OR STRIPS.
- MOIST FOR 30 DAYS AFTER SODDING.

  9. THE CONTRACTOR SHALL REPAIR ANY AREAS DAMAGED FOLLOWING INSTALLATION AS
  - DIRECTED BY THE ENGINEER. SOD SHALL BE IN PLACE AT LEAST 30 DAYS BEFORE FINAL ACCEPTANCE.

8. THE CONTRACTOR SHALL KEEP ALL SODDED AREAS INCLUDING SUBGRADE, THOROUGHLY

#### PLANTING SCHEDULE

1. ALL PLANTING IS RECOMMENDED TO BE DONE WITHIN THE FOLLOWING DATES. WHEN PLANTING OUTSIDE THESE DATES, WRITTEN DOCUMENTATION SHALL BE PROVIDED THAT SURVIVAL OR REPLACEMENT WILL BE ENSURED. NO PLANTING SHALL BE DONE IN FROZEN SOIL.

| NORMAL PLANTING SEASONS | SPRING          | <u>FALL</u>           |
|-------------------------|-----------------|-----------------------|
| ALL TREES AND SHRUBS    | MARCH 15-MAY 15 | OCTOBER 1-DECEMBER 1  |
| EVERGREENS              | APRIL 1-MAY 15  | OCTOBER 1-NOVEMBER 15 |
| GROUNDCOVERS            | APRIL 1-JUNE1   | WHEN SOD IS WORKABLE  |
| SEED AND MULCH          | APRIL 1-MAY 15  | OCTOBER 1-NOVEMBER 15 |
|                         |                 |                       |

# DETENTION BASIN SEEDING

- 1. GRASS SEED SHALL BE FRESH, CLEAN, DRY, NEW-CROP SEED COMPLYING WITH THE ASSOCIATION OF OFFICIAL SEED ANALYSTS' "RULES FOR TESTING SEEDS" FOR PURITY AND GERMINATION TOLERANCES.
- ALL AREAS TO BE SEEDED SHALL RECEIVE NO LESS THAN FIVE POUNDS OF SEED PER ONE THOUSAND SQUARE FEET. APPLY SEED AND PROTECT WITH STRAW MULCH AS REQUIRED FOR NEW LAWNS. GRASS SEED MIX SHALL CONSIST OF THE FOLLOWING:

PERENNIAL RYE GRASS (LOLIUM PERENNE)

| OPORTION |                                                     | MIN.%<br>GERM. |    | MAX.%<br>WEED<br>SEED |
|----------|-----------------------------------------------------|----------------|----|-----------------------|
| 0%       | KENTUCKY BLUEGRASS (POA PRATENSIS)                  | 80             | 85 | 0.50                  |
| 0%       | KENTUCKY 31 FESCUE (FESTUCA ARUNDINACEA VAR. KY 31) | 85             | 98 | 0.50                  |

90 98





|                         | DATE    | REMARKS           |  |  |  |  |  |
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| 1                       | 3/8/22  | Planning Comments |  |  |  |  |  |
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| CONTRACT DATE: 11.15.21 |         |                   |  |  |  |  |  |

END. MED20

2021088.48

PLAN VERSION: MARCH 2021
BRAND DESIGNER: DICKSON
SITE NUMBER: 315390
STORE NUMBER: 457226

DRAWN BY.: JOB NO.:

PA/PM:

BUILDING TYPE:

17669 23 Mile Road Macomb, MI 48042

**TACO BELL** 



ENDEAVOR 2.0

LANDSCAPE

L-00'



LANDSCAPE LEGEND

##" **3** 

EXISTING TREE AND SIZE TO REMAIN



EXISTING TREE AND SIZE TO BE REMOVED





|   | DATE    | REMARKS           |
|---|---------|-------------------|
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> 17669 23 Mile Road Macomb, MI 48042

TACO BELL

2021088.48

Macomb, MI 4804.



**ENDEAVOR 2.0** 

TREE DEMOLITION PLAN

L-101

PLOT DATE:

UTILITY NOTIFICATION ORGANIZATION


THREE FULL WORKING DAYS BEFORE YOU DIG, CALL THE MISS DIG SYSTEM AT

1-(800)-482-7171

OR CALL **#DIG** FREE FROM YOUR AT&T OR CINGULAR CELLULAR PHONE


THE MISS DIG MEMBER UTILITIES WILL MARK THE APPROXIMATE LOCATION OF THEIR UNDERGROUND PUBLIC UTILITY LINES AT NO CHARGE.

MICHIGAN'S ONE— CALL

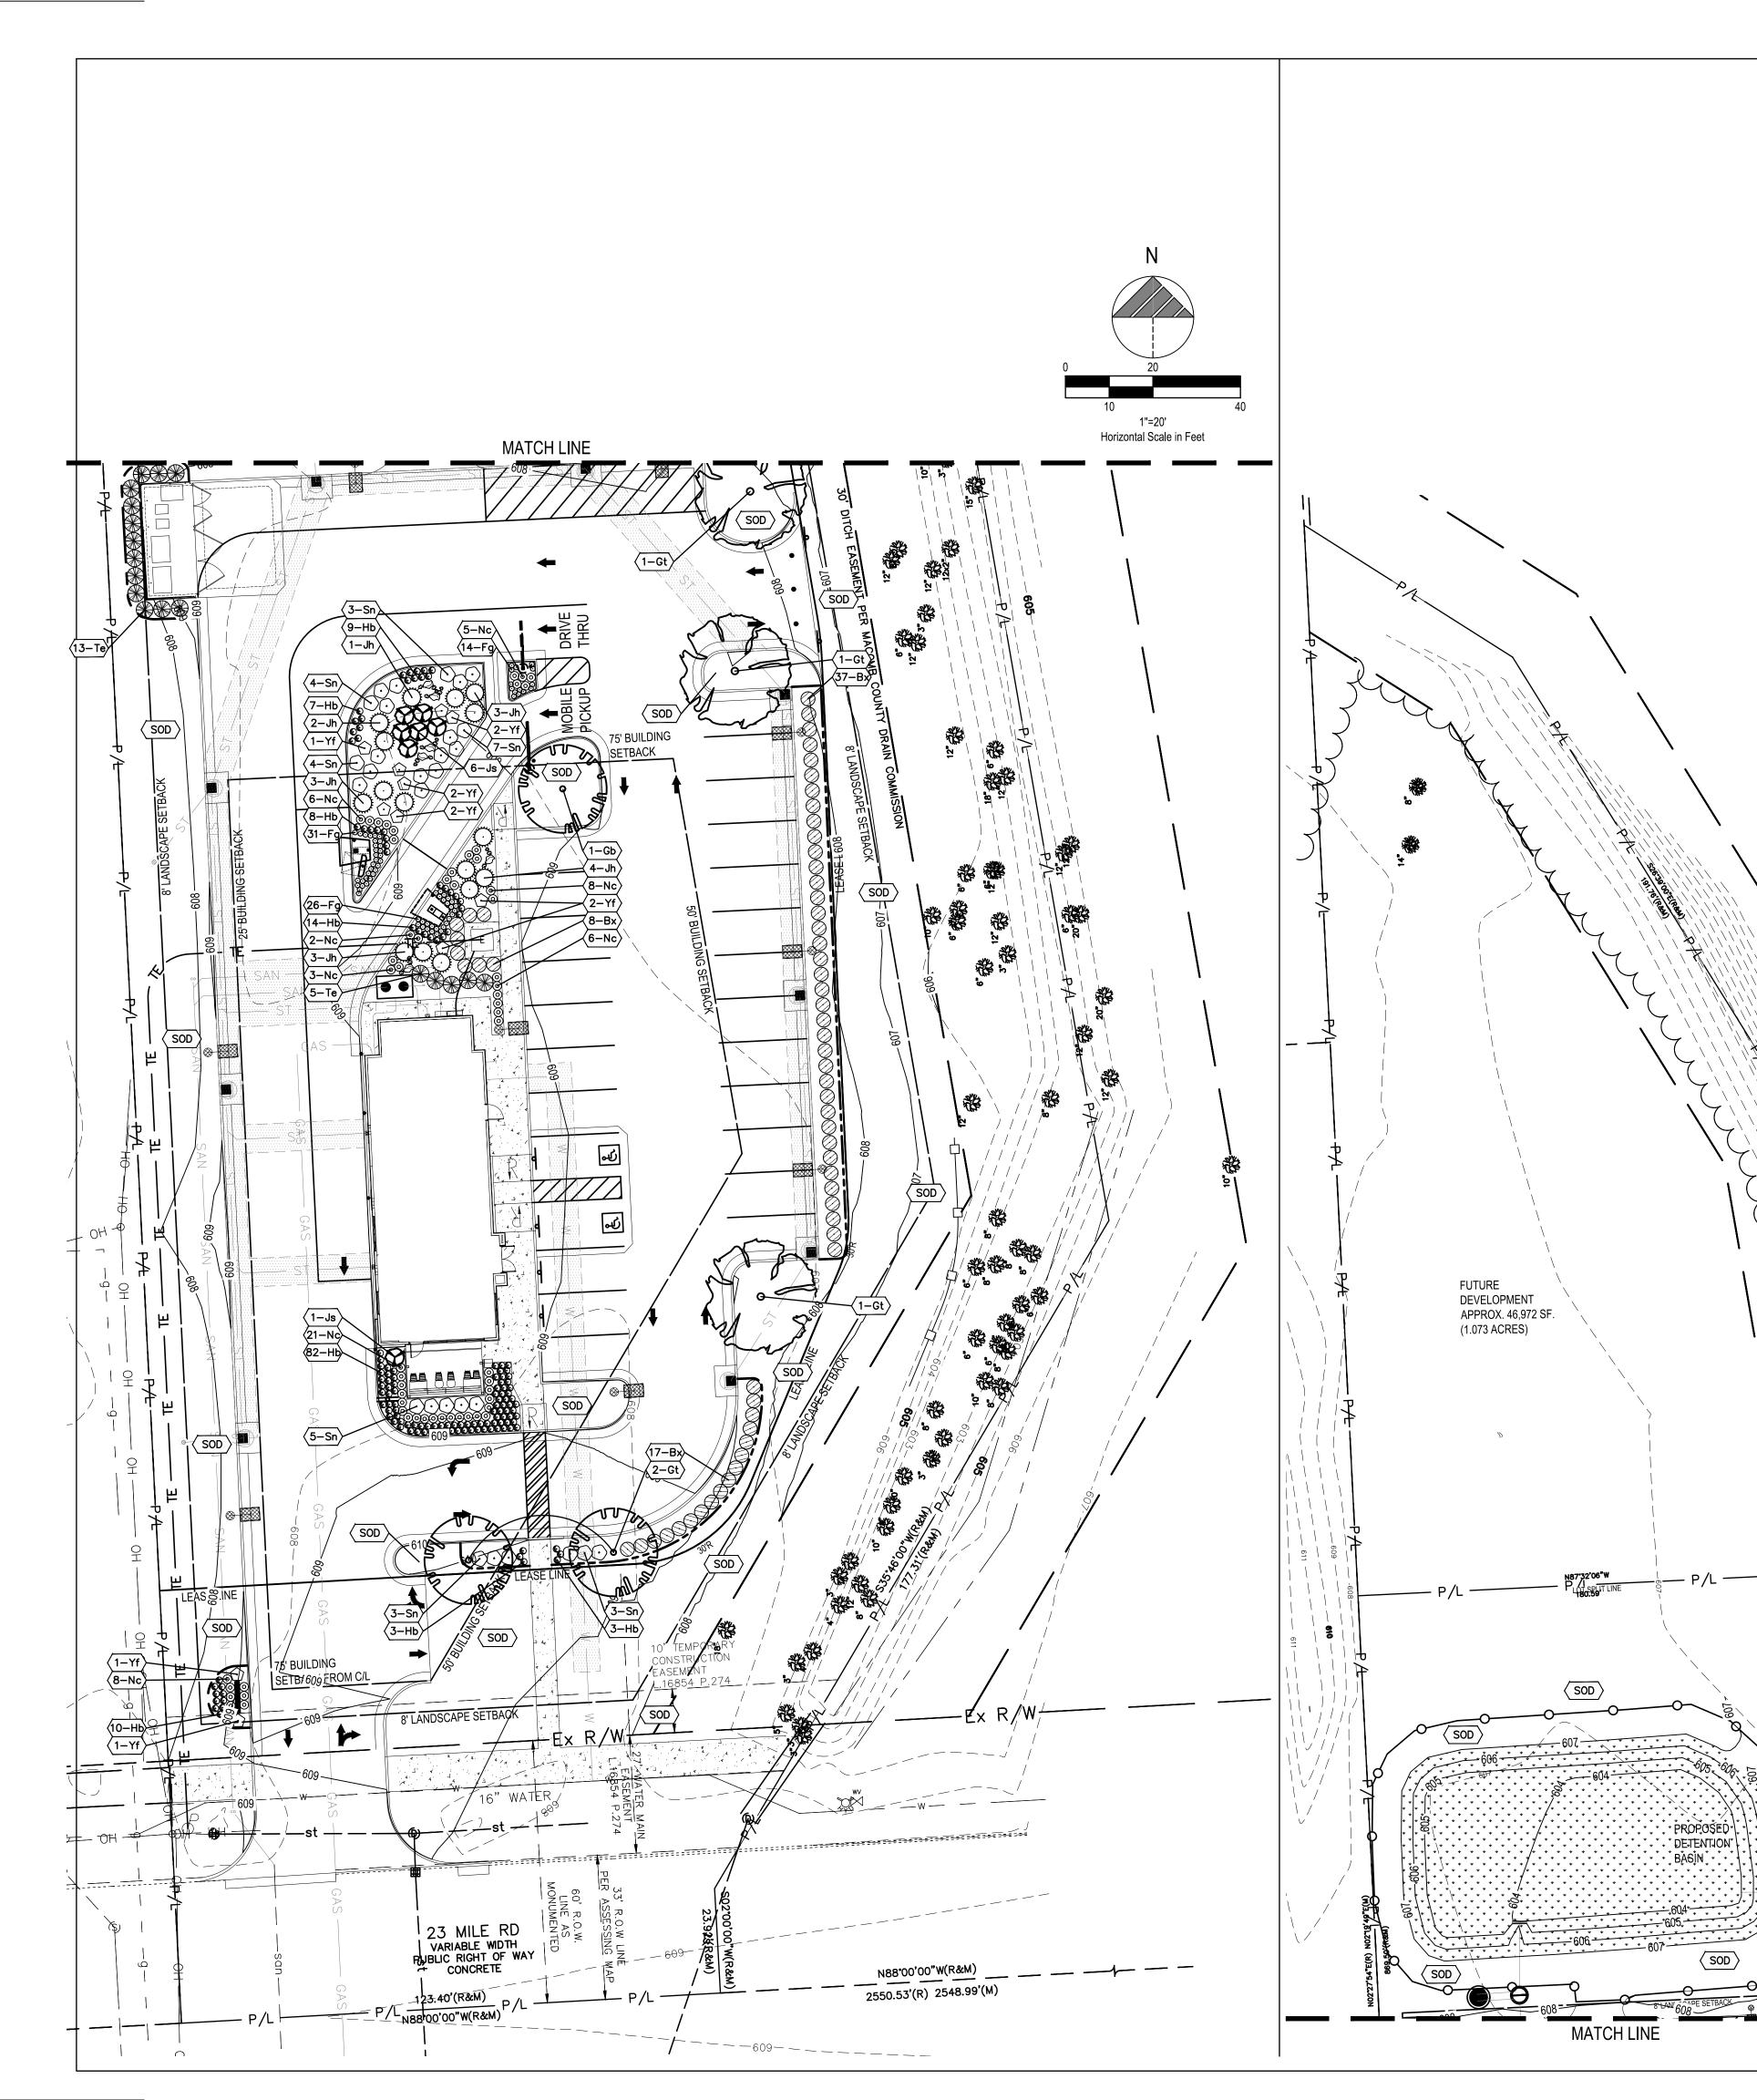


| Symbol | Botanical Name                             | Common Name                   | Qty. | Min. Size       | Condition | Remarks  |
|--------|--------------------------------------------|-------------------------------|------|-----------------|-----------|----------|
| Bx     | Buxus 'Green Velvet'                       | Green Velvet Boxwood          | 62   | 24" H Min.      | B&B       | 3' o/c   |
| Gb     | Ginkgo biloba 'Princeton Sentry'           | Princeton Sentry Ginkgo       | 3    | 2.5" Cal.       | B&B       | Specimen |
| Gt     | Gleditsia triacanthos f. inermis 'Skycole' | Skyline Thornless Honeylocust | 3    | 2.5" Cal.       | B&B       | Specimen |
| Fg     | Festuca gluaca                             | Blue Fescue                   | 71   | No. 2           | Cont.     | Per Plan |
| Hb     | Hemerocallis 'Going Bananas'               | Going Bananas Daylily         | 137  | No. 1           | Cont.     | 1.5' o/c |
| Jh     | Juniperus horizontalis 'Blue Chip'         | Blue Chip Juniper             | 16   | 24" Spread, No. | 3 Cont.   | 4' o/c   |
| Js     | Juniperus scopulorum 'Wichita Blue'        | Wichita Blue Juniper          | 7    | 5' H            | B&B       | Specimen |
| Nc     | Nepeta x 'Cat's Pajamas'                   | Cat's Pajamas Catmint         | 59   | No. 2           | Cont.     | 2' o/c   |
| Sn     | Spiraea nipponica 'Wedding Cake'           | Wedding Cake Spirea           | 38   | 24" H Min.      | Cont.     | 3.5' o/c |
| Те     | Thuja occidentalis 'Smaragd'               | Emerald Arborvitae            | 18   | 5' H            | B&B       | 4' o/c   |
| Tr     | Thuja occidentalis 'Rheingold'             | Rheingold Arborvitae          | 0    | 24" H Min.      | B&B       | 3' o/c   |
| Yf     | Yucca filamentosa 'Color Guard'            | Color Guard Yucca             | 11   | No. 5           | Cont.     | Per Plan |



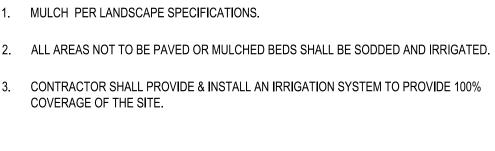


# LANDSCAPE LEGEND

LANDSCAPE NOTES

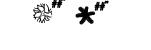

EXISTING TREE AND SIZE TO REMAIN

PROPOSED LANDSCAPE BED EDGE

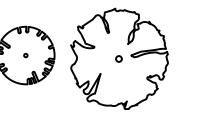

PROPOSED TREE



PROPOSED LIMESTONE BOULDER, DESERT SAND, 12"-36"

PROPOSED SHRUB / PERENNIAL



PROPOSED PLANT QUANTITY AND SYMBOL

SOD

PROPOSED LAWN AREA

SOD

MATCH LINE

ŗŖŎŖŎŠĔĎŀ\ . DELENLION. ∤ PROPOSED DETENTION BASIN SEEDING AREA

|   | DATE    | REMARKS           |
|---|---------|-------------------|
| 1 | 3/8/22  | Planning Comments |
| 2 | 3/21/22 | Planning Comments |
| 3 | 4/21/22 | Issued for Permit |
|   |         |                   |
|   |         |                   |
|   |         |                   |

11.15.21

IVAN VALENTIC

LANDSCAPE ARCHITECT

**BUILDING TYPE:** END. MED20 PLAN VERSION: MARCH 2021 BRAND DESIGNER: DICKSON SITE NUMBER: 315390 STORE NUMBER: 457226

PA/PM: DRAWN BY.:

CONTRACT DATE:


JOB NO.: 2021088.48 TACO BELL

17669 23 Mile Road Macomb, MI 48042




**ENDEAVOR 2.0** 


LANDSCAPE PLAN

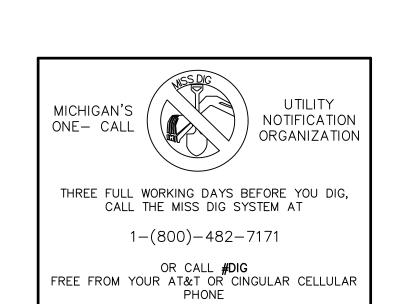



THE MISS DIG MEMBER UTILITIES WILL MARK THE APPROXIMATE LOCATION OF THEIR UNDERGROUND PUBLIC UTILITY LINES AT NO CHARGE.



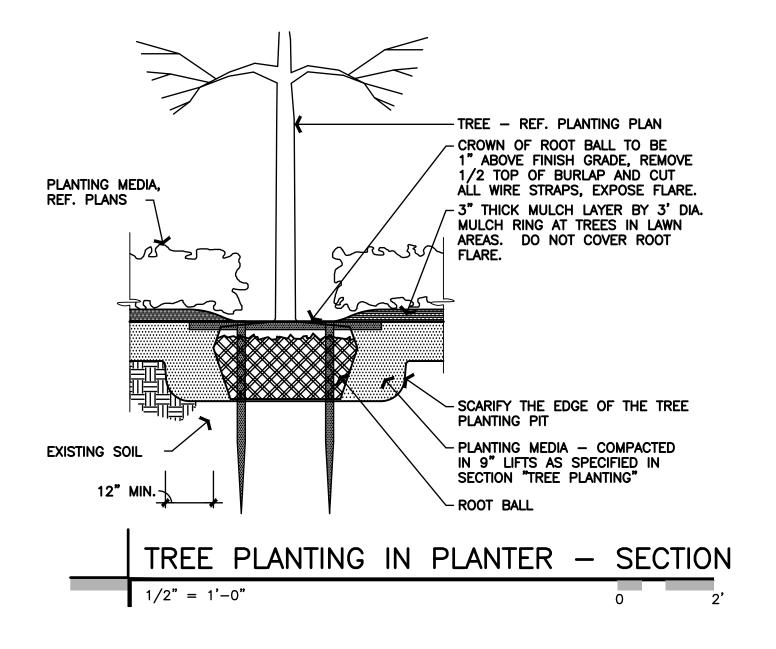


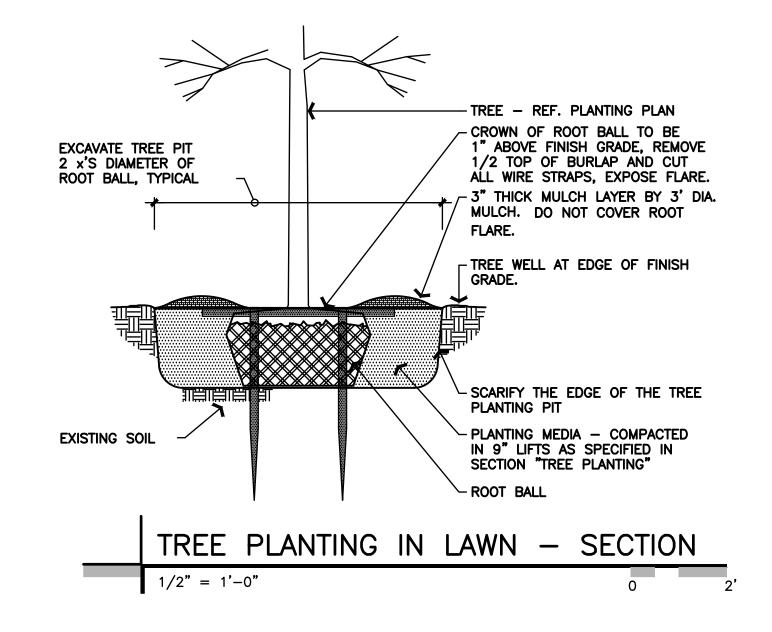


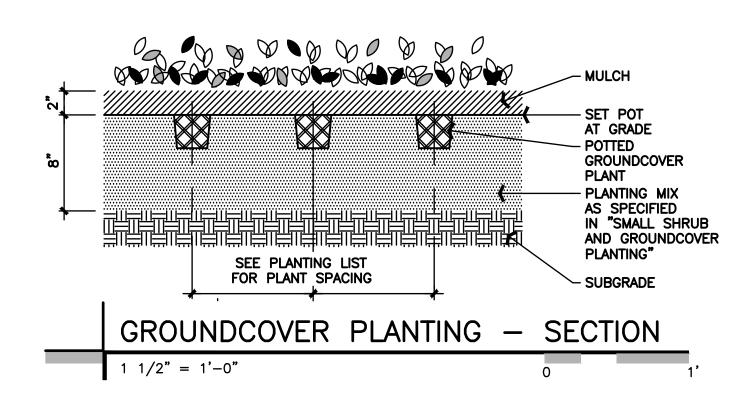

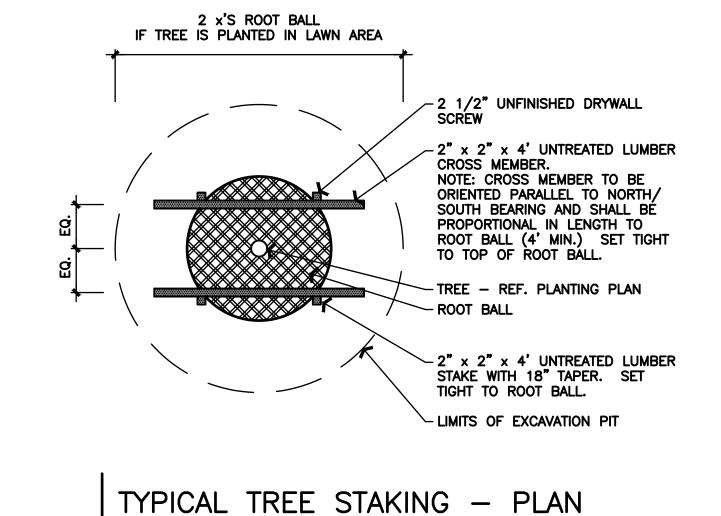

1/2" = 1'-0"

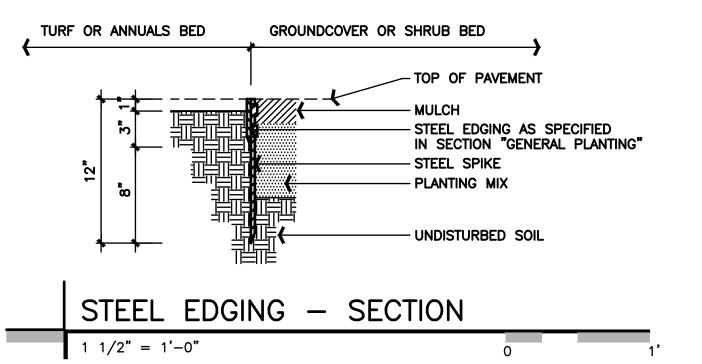

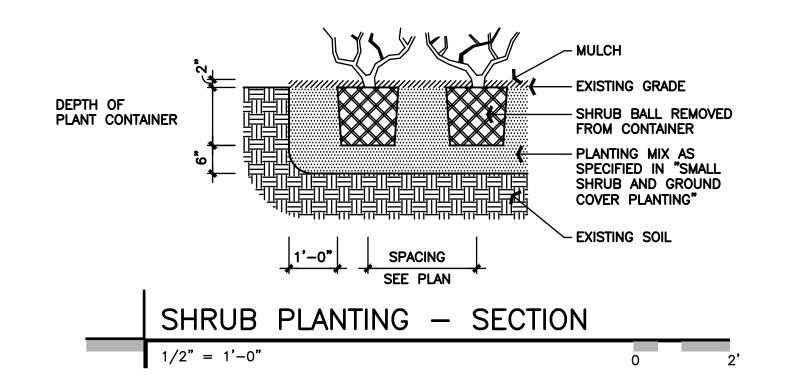



|  |   | DATE    | REMARKS           |
|--|---|---------|-------------------|
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|  |   |         |                   |
|  |   |         |                   |

11.15.21

2021088.48

CONTRACT DATE:

BUILDING TYPE: END. MED20
PLAN VERSION: MARCH 2021
BRAND DESIGNER: DICKSON
SITE NUMBER: 315390
STORE NUMBER: 457226
PA/PM: SM
DRAWN BY.: EA

TACO BELL

JOB NO.:

17669 23 Mile Road Macomb, MI 48042



**ENDEAVOR 2.0** 

LANDSCAPE DETAILS

L-501