


	REGULAR DUTY	HEAVY DUTY
A	1.5"	2"
B	3.5"	4"
C	8"	12"


NOTES:
1. PAVEMENT SECTIONS ARE PROVIDED BASED ON THE GEOTECHNICAL ENGINEERING REPORT PROVIDED BY CONVERSE CONSULTANTS ON 12/22/2021.

PAVING SECTION DETAIL
N.T.S.

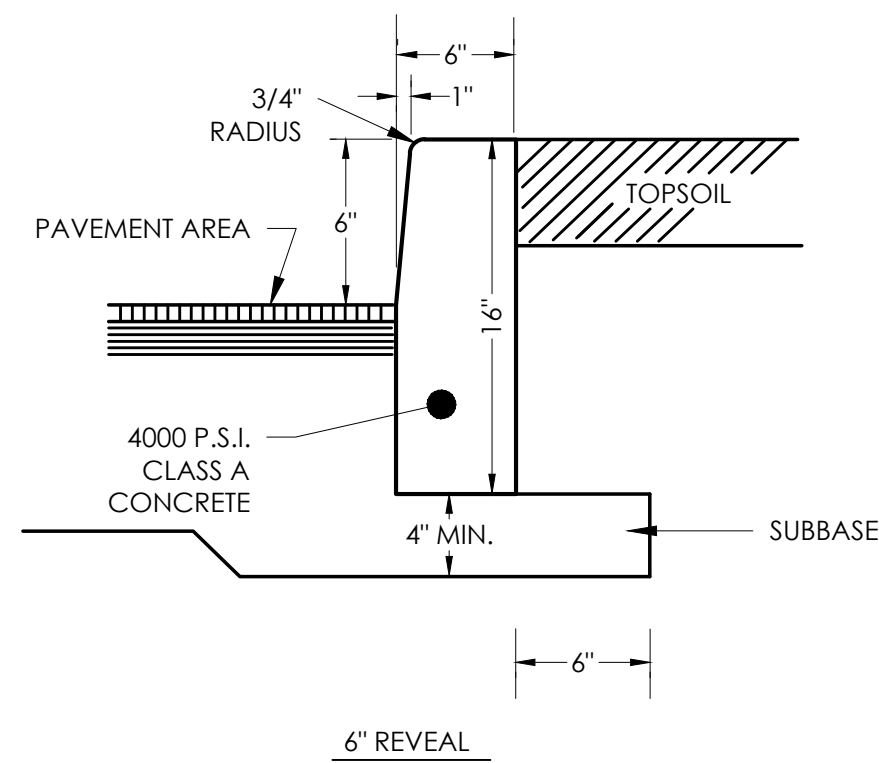


NOTES:
1. CONTROL JOINTS 10 FEET ON CENTER TO DEPTH OF 1/2 THE CURB THICKNESS
2. EXPANSION JOINTS WITH PREMOLDED FILLER 50 FEET ON CENTER

CONCRETE CURB DETAIL
N.T.S.

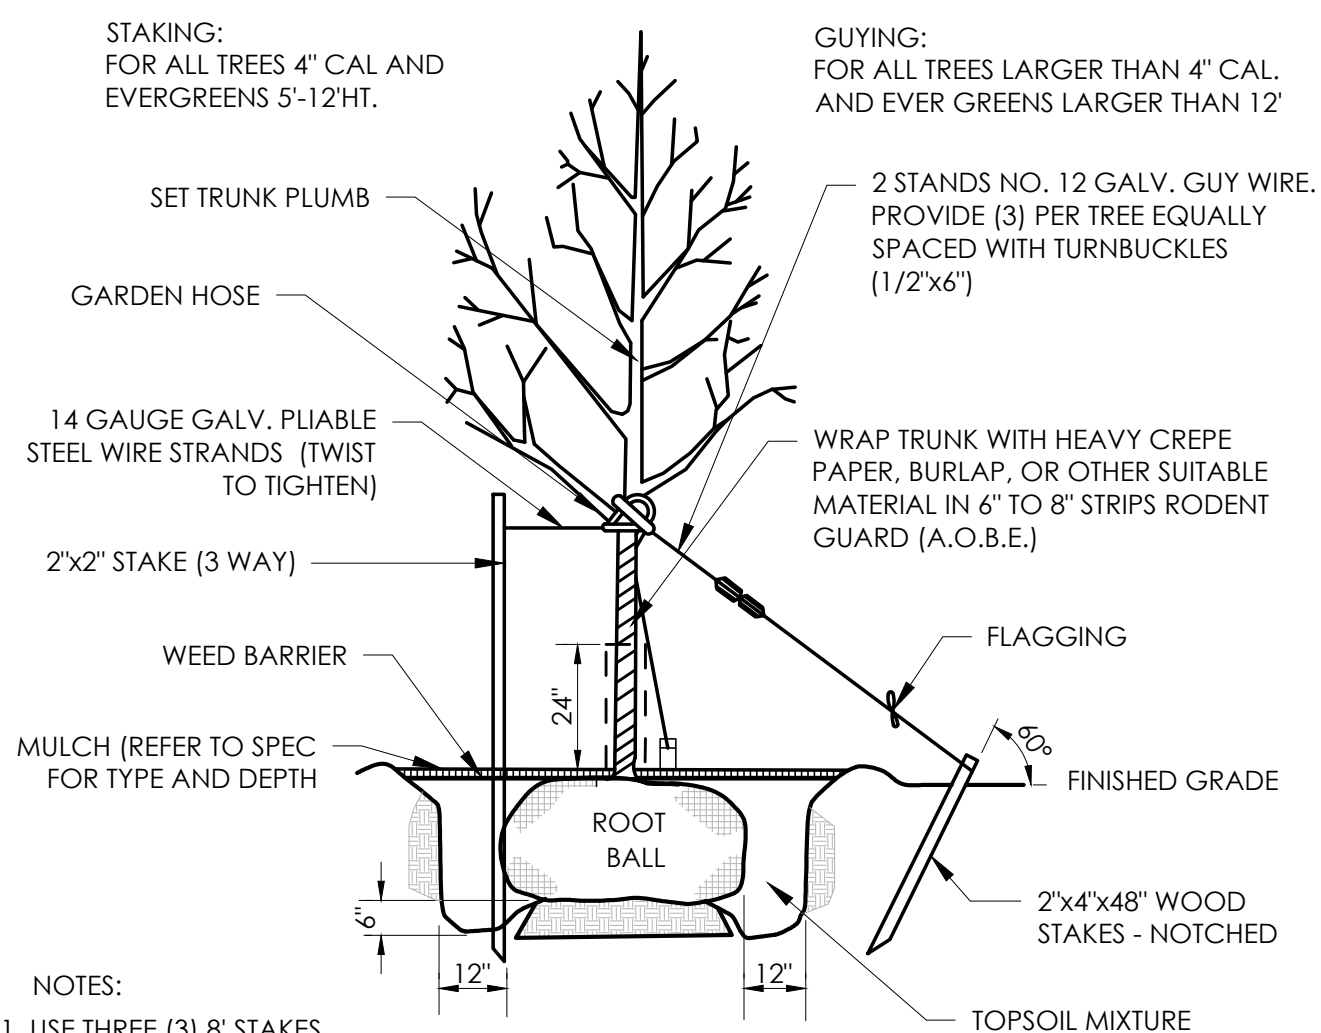


NOTES:
1. USE THREE (3) 8\"/>

TREE PLANTING DETAIL
N.T.S.

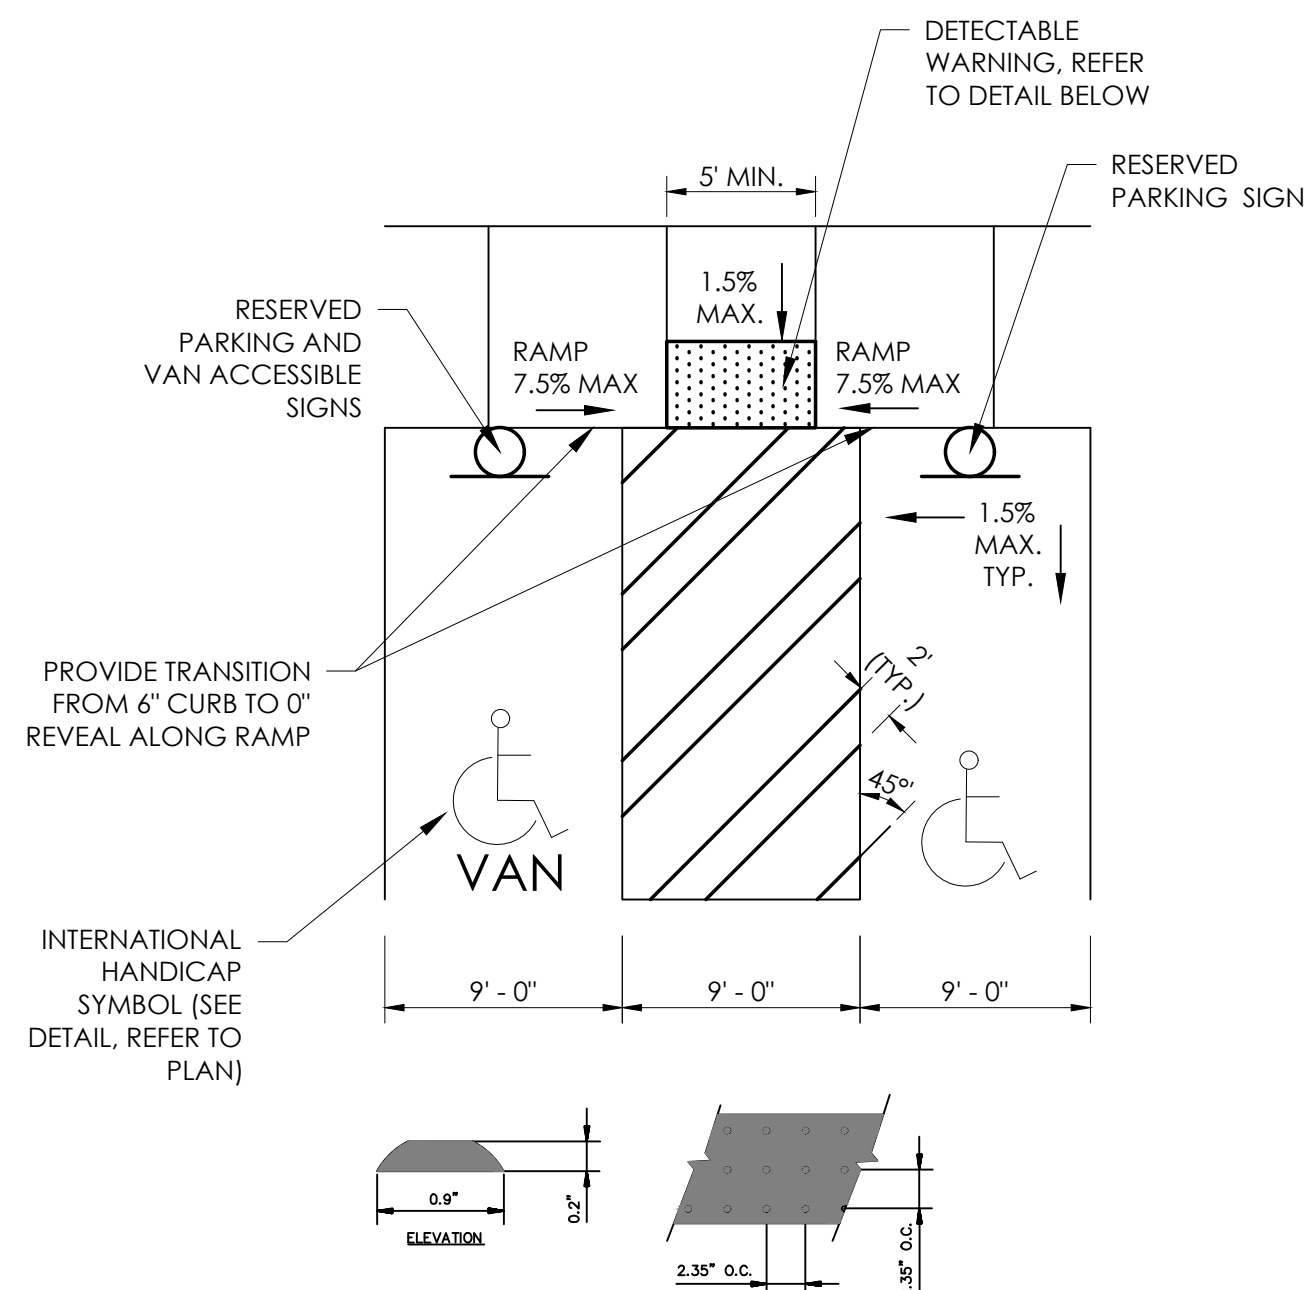


NOTES:
1. REFER TO SITE PLAN FOR ACCESSIBLE PARKING STRIPING LAYOUT.
2. ALL SIDEWALK, RAMPS, LANDING AREAS, DETECTABLE WARNING, ETC. ALONG THE ACCESSIBLE PATH SHALL BE CONSTRUCTED IN ACCORDANCE WITH ADA STANDARDS.
3. CONTRACTOR TO REFER TO THE GRADING AND DRAINAGE PLAN FOR SLOPES.
3.A. CROSS SLOPES FOR SIDEWALKS AND RAMPS SHALL BE 1.5% AT A MAXIMUM.
3.B. RUNNING SLOPES FOR SIDEWALKS SHALL BE 4.5% AT A MAXIMUM.
3.C. RUNNING SLOPES FOR RAMPS SHALL BE AT 7.5% MAXIMUM.
3.D. SLOPES FOR ADA PARKING STALLS AND UNLOADING BAYS SHALL BE 1.5% AT A MAXIMUM.
4. SIGNS TO BE PLACED IN CENTER OF PARKING STALL OR UNLOADING BAY (IF APPLICABLE) WHENEVER POSSIBLE. MAINTAIN THE MINIMUM OF 32\"/>


ACCESSIBLE PARKING DETAIL
N.T.S.

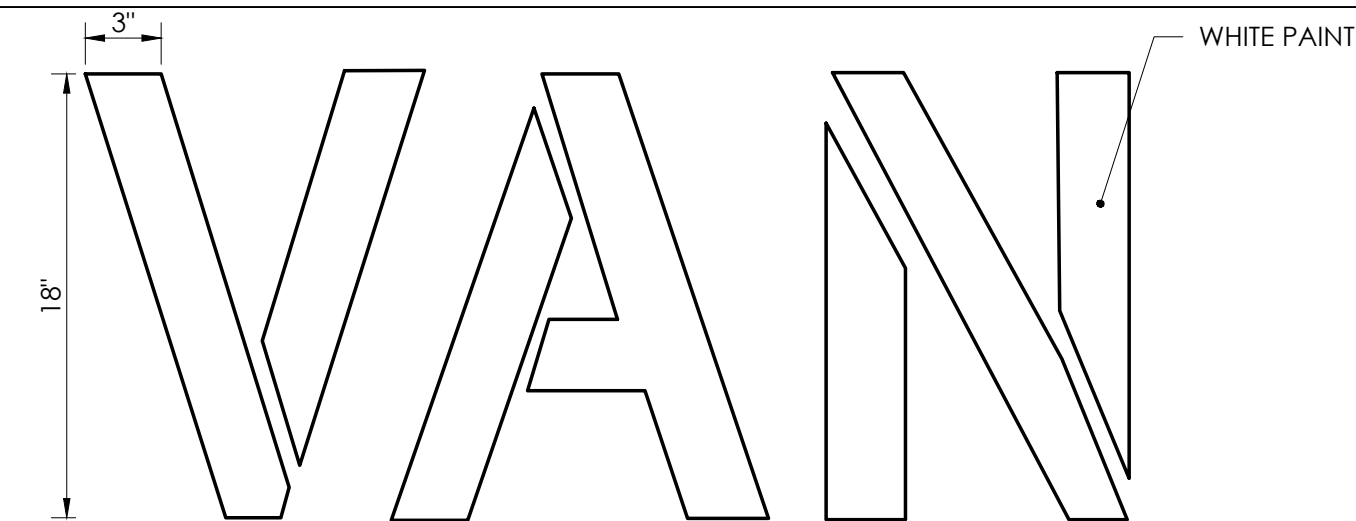


VAN ACCESSIBLE PARKING DETAIL
N.T.S.

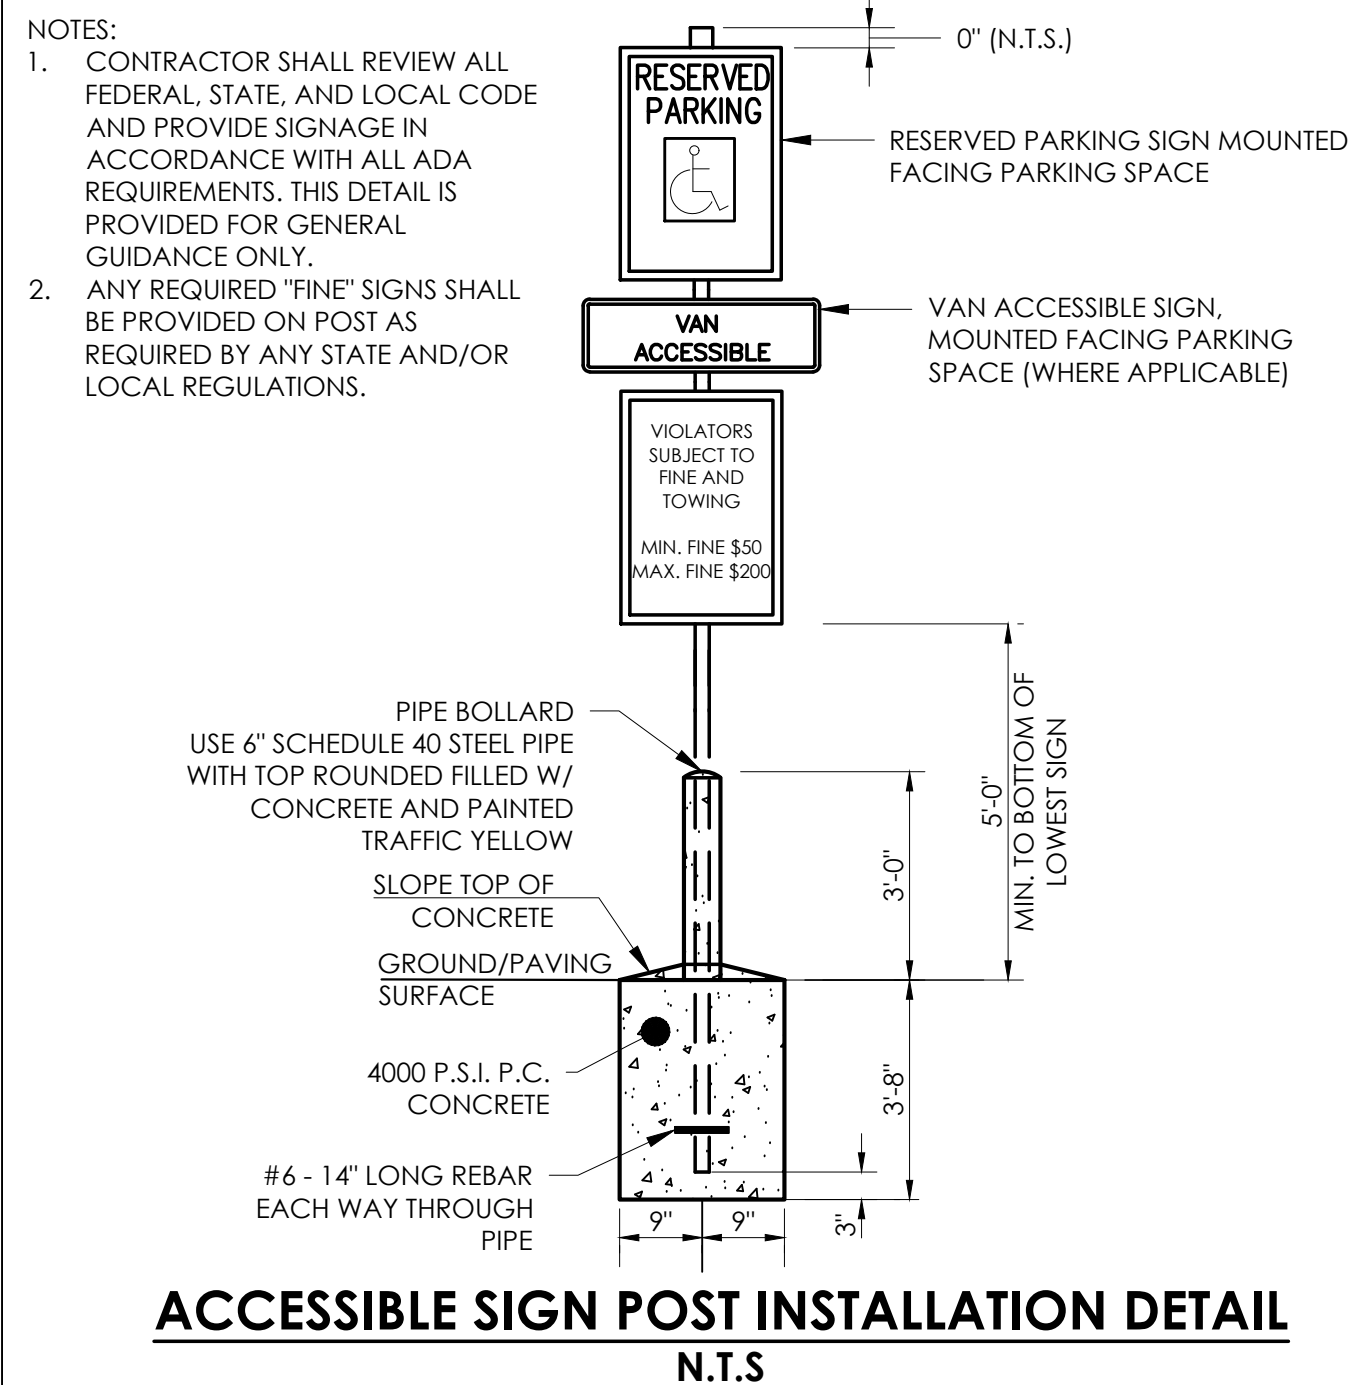


ACCESSIBLE SIGN POST INSTALLATION DETAIL
N.T.S.

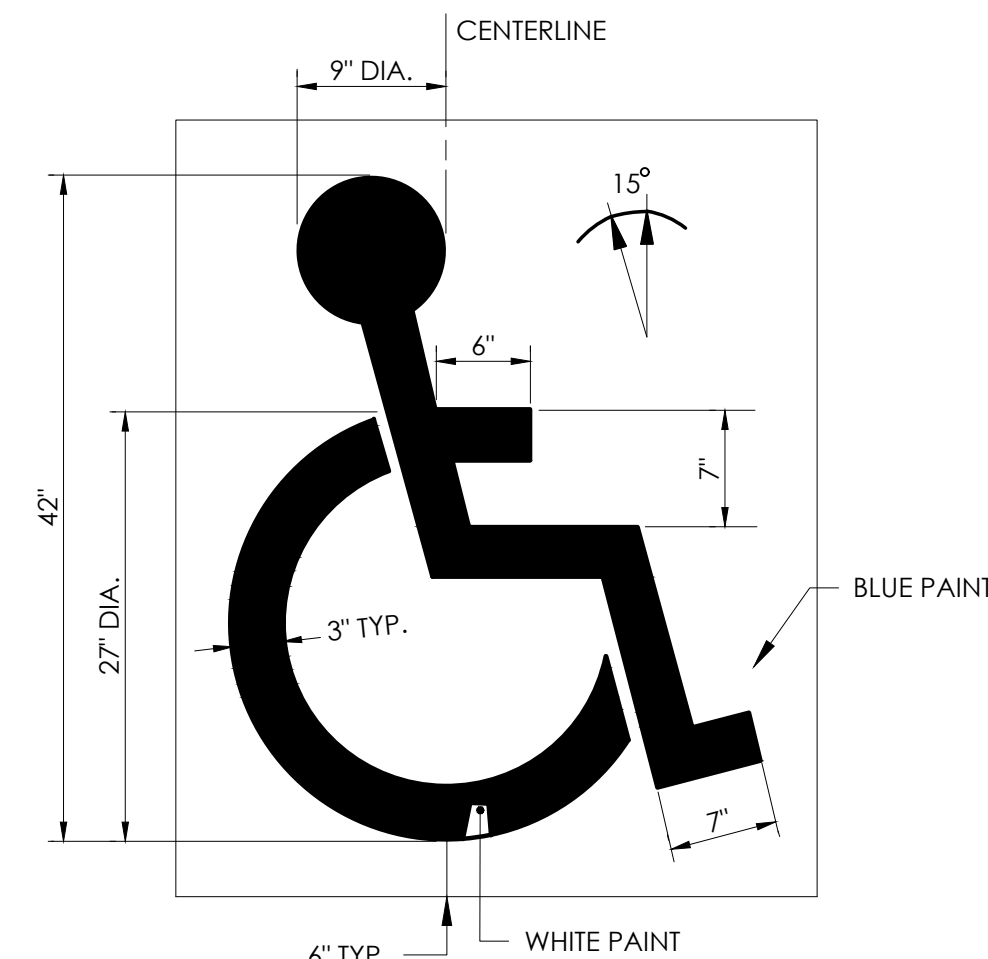

ACCESSIBLE PARKING STRIPING DETAIL
N.T.S.

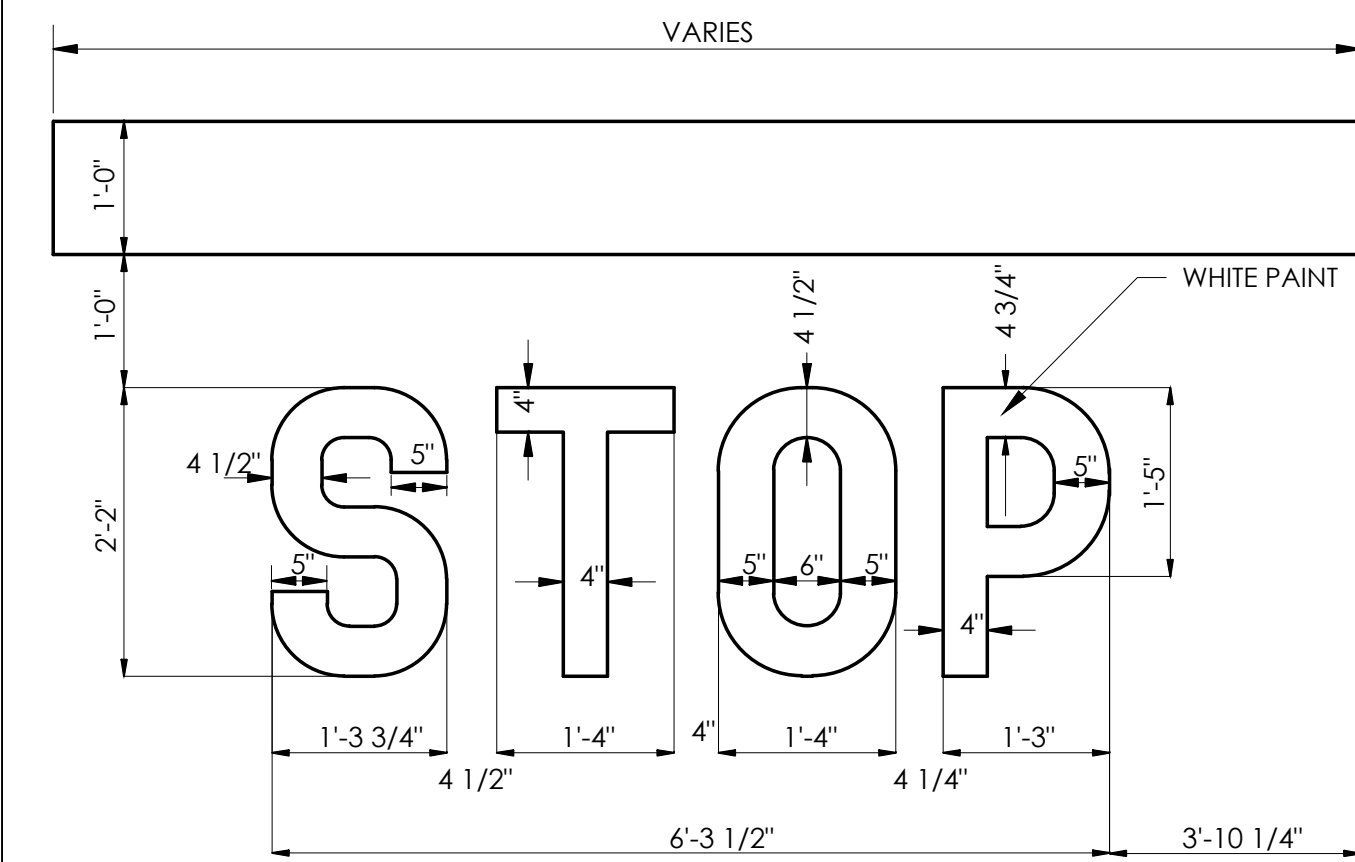


PARKING LOT DRIVE AISLE STOP BAR DETAIL
N.T.S.

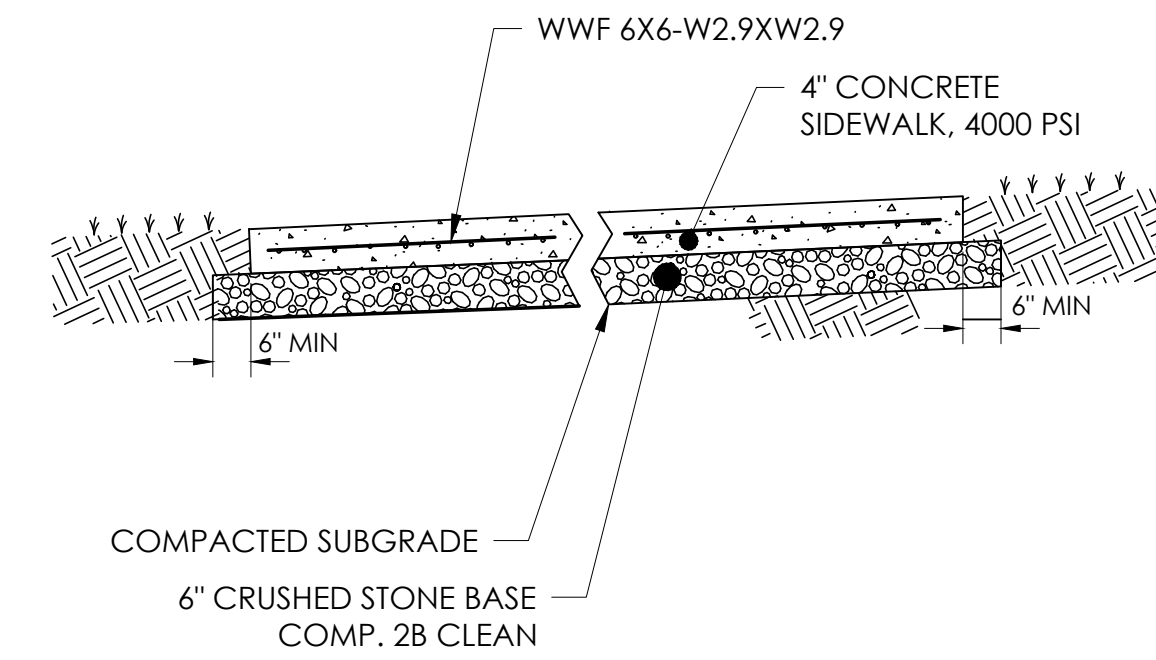


NOTES:
1. SEE SIDEWALK JOINTS DETAIL FOR JOINT SIZE AND SPACING
2. EXPOSED CONCRETE SURFACE TO HAVE LIGHT BROOM FINISH

CONCRETE SIDEWALK DETAIL
N.T.S.

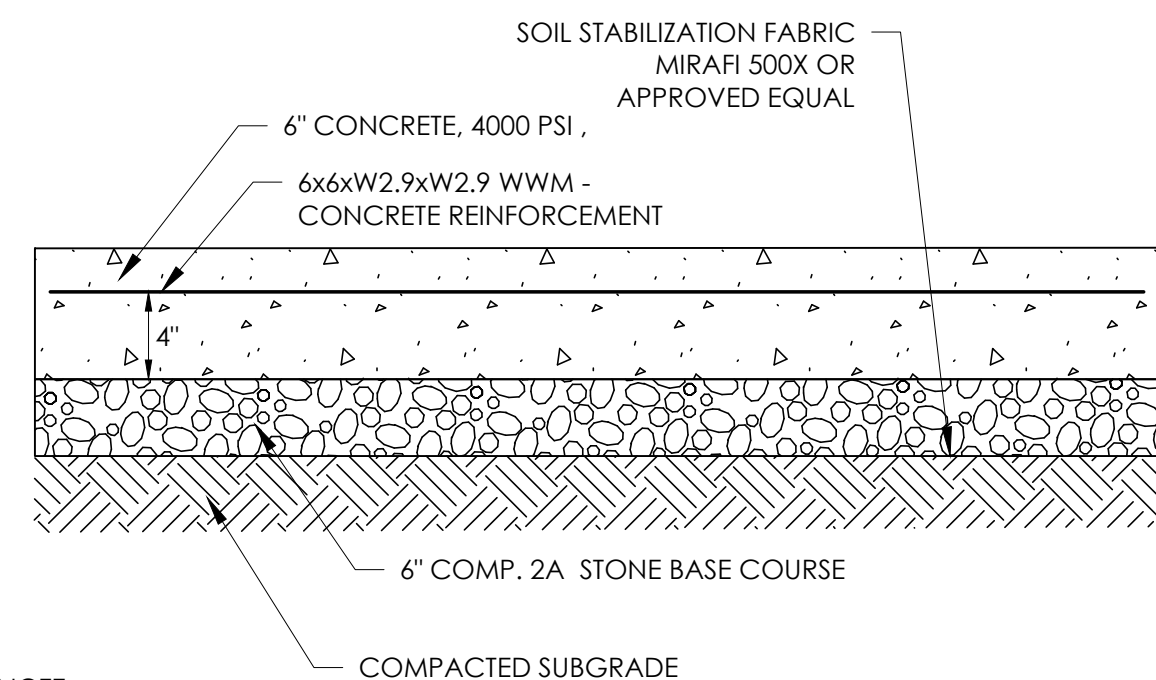

NOTE:
1. EXPOSED CONCRETE SURFACE TO HAVE A LIGHT BROOM FINISH. CONTRACTION JOINTS 20\"/>

HEAVY DUTY CONCRETE (DRIVE THRU & ADA PAD) DETAIL
N.T.S.

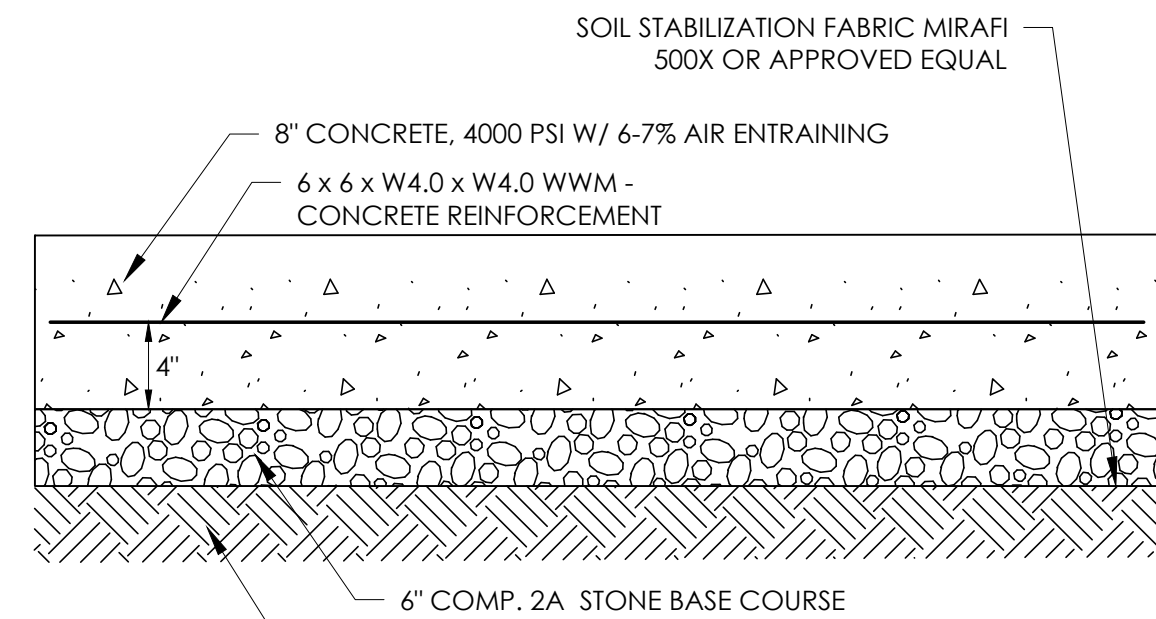

NOTE:
1. EXPOSED CONCRETE SURFACE TO HAVE A LIGHT BROOM FINISH. CONTRACTION JOINTS 20\"/>

DUMPSTER PAD CONCRETE DETAIL
N.T.S.

Issued: _____ Date: _____

A		
B		
C		
D		
E		
F		
G		
H		

Revisions: _____ Date: _____

1	Revised per Addendum # 1	02/08/22
2		
3		
4		
5		
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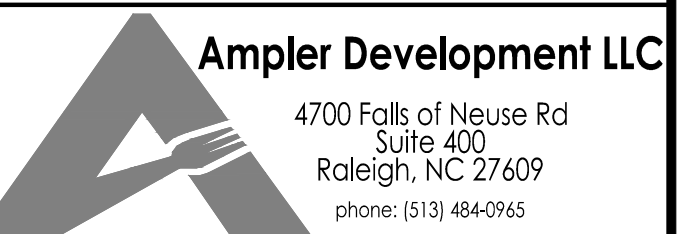


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3/11/22 Seal
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Firm Approval No.: 002215

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Burger King Store#:

322 Poltstown Ave.
Pensburg, PA 18073
Montgomery County (Pensburg Borough)
Project Name & Location:

Details Sheet

Drawing Name:

Date: 01/21/22

Type:

Drawn By: SAS

Scale: N.T.S.

Project No.
21-0327

C6

Drawing No.