


BURGER KING

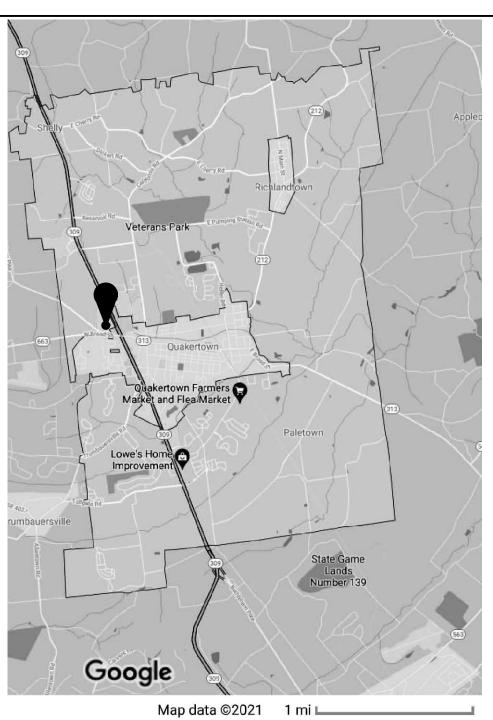

LOCATION MAP BURGER KING # 36234 100 N. West End Boulevard Quakertown, PA 18951 Richland Township, Bucks County



SCALE: N.T.S.

AB III, LLC

FRANCHISEE

CONTACT: GREG WINANS qwinans@amplergroup.com PHONE: 610-496-3379 (cell)

OCCUPANCY LOAD PLAN

SCF ARCHITECTURE, LLC C/O MANNING DESIGN, LLC PROJECT MANAGER AND OWNERS REPRESENTATIVE

ADDRESS: 233 MAIN STREET, #1 SCHWENKSVILLE, PA 19473 CONTACT: LEE ANN MILLER

PHONE: 610-287-0184

ARCHITECT

PROVIDENCE ENGINEERING CORPORATION

ADDRESS: 10 EISENHOWER BOULEVARD LANCASTER PA 17603 CONTACT: DANA ZIEGLER, PE PHONE: 610-360-6536

STRUCTURAL ENGINEER

ELECTRICAL/MECHANICAL **ENGINEER**

McCarthy Engineering

ADDRESS: 315 E SECOND ST. BOYERTOWN, PA 19512 CONTACT: NORM COFFEY PHONE: 610 369 3190

GENERAL CONTRACTOR

CONTACT: ADDRESS:

PHONE:

FURNITURE/MILLWORK CONTRACTOR

FCC COMMERCIAL FURNITURE ADDRESS: 8452 OLD HIGHWAY 99 NORTH

CONTACT: RANDY MOE 800-322-7328 541-673-3351 X270

WEB: www.fcc-create.com

144 occupants

ROSEBURG, OR 97470

MUNICIPALITY

Richland Township 1328 California Rd, Suite A Quakertown, PA 18951

PHONE: 215-536-4066 FAX: 215-538-3020

SITE ENGINEER

Bohler Engineering 74 WEST BROAD STREET

CONTACT: MATT CHARTRAND PE

PHONE: 610-709-9971

SUITE 500

BETHLEHEM, PA 18018

DRAWING INDEX

DRAV	AING INDEX				
ARCHITE	ECTURAL	CIVIL		PLUMBING	
A1.1	Cover Sheet	C-301	Site Plan	P1.0	General Schedules & Diagrams
A2.1	Floor Plan			P1.1	Demolition Floor Plan
A2.2	Demolition Plan	STRUCTU	RAL	P1.2	Demolition Roof Plan
A2.3	Roof Plan	50.0	Structural Notes/Details	P2.1	Drainage & Vent Piping Floor Plai
A2.4	Equipment Plan	S1.0	Foundation Plan	P2.2	Water & Gas Piping Floor Plan
A2.5	Toilet Rooms/Seating Plan	S2.0	Roof Framing Plan	P2.3	Piping Roof Plan
A2.6	Accessibility &Interior Details	S3.0	Sections	P3.1	Plumbing Specifications
A3.1	Elevations	S3.1	Sections		<i>3</i> ·
A3.2	Elevations	S4.0	Accessory Details	ELECTRICAL	<u>-</u>
A3.3	Exterior Finishes			E1.0	Single Line Diagram
A4.1	Sections	MECHAN	<u>ICAL</u>	E1.1	Demolitio Plan
A4.2	Sections	M1.1	Mechanical Demo. Floor Plan	E2.1	Lighting Plan
A5.1	Dumpster Enclosure	M1.2	Mechanical Demo. Roof Plan	E3.1	Power Plan
A6.1	Doors & Windows	M2.1	Mechanical Floor Plan	E3.2	Roof Plan
A7.1	Reflected Ceiling Plan	M2.2	Mechanical Roof Plan	E4.1	Technology Plan
	J	M3.1	Mechanical Specifications	E5.1	Panels & Risers

& Schedules

BUILDING CODE SUMMARY

2015

INTERNATIONAL EXISTING BUILDING CODE

ALTERATION LEVEL 2

ACCESSIBILITY:

2015 INTERNATIONAL BUILDING CODE

2015 INTERNATIONAL EXISTING BUILDING CODE

2009 ICC/ANSI A-117.1, 2010 ADA

2015 INTERNATIONAL PLUMBING CODE

2014 NATIONAL ELECTRIC CODE 2015 INTERNATIONAL MECHANICAL CODE

2015 INTERNATIONAL ENERGY CONSERVATION CODE

except: Section C104.2.6 (relating to final inspection);

and Section C408.2.4 (relating to preliminary commissioning report) 2015 INTERNATIONAL FIRE PREVENTION CODE

BOCA 1996 CH 14 & 15 ALSO CONSIDERED

JOB TYPE:

OCCUPANCY CLASSIFICATION:

Alterations **CONSTRUCTION TYPE:**

SPRINKLERS REQUIRED/PROVIDED: EXISTING TO REMAIN

ZONING:

PC PLANNED COMMERCIAL

75

GROSS BUILDING AREA: 5044 SF (EXISTING)

ACCESSIBLE PARKING:

PARKING PROVIDED: ACCESSIBLE SPACES PROVIDED:

OCCUPANCY

	OCCUPANCY COUNT:
Т	OTAL SEATING COLIN

144 occ. IUIAL SEATING COUNT: Existing 120 occ. Proposed 5 Net 16.0 occ. Standing Space: 80 s.f. 200 gross 4.61 occ. Kitchen 922 s.f. 792 s.f. 300 gross 2.64 occ. Storage

Total

OCCUPANCY

OCCUPANCY: 144 PEOPLE TOTAL

MIN. REQUIRED EGRESS WIDTH - SHALL NOT BE LESS THAN THE TOTAL OCCUPANT LOAD MULTIPLIED BY 0.2"

144 X 0.2" =28.8" OF EGRESS REQUIRED 3 DOOR LEAFS @ 32" PER DOOR = 128" OF EGRESS WIDTH PROVIDED

MIN. 2 MEANS OF EGRESS REQUIRED FOR BUILDING - 3 PROVIDED

144 OCCUPANTS /3 MEANS OF EGRESS = 48 OCCUPANTS PER EGRESS

GENERAL NOTES

1. In all cases, written dimensions shall take precedence over scaled dimensions. Due to the nature of the work, all dimensions in existing areas shall be considered approximate.

2. These drawings were prepared at the request of the owner and/or tenant for the purpose of illustrating desired improvements. Any contractor or subcontractor employed to carry out the work shown shall be responsible for verifying all dimensions, quantities and on-site conditions before performing the work. They shall also take all necessary steps to ensure the structural integrity of the work and compliance with all applicable building codes and regulations.

3. Existing wall thickness, construction type and structural conditions cannot be completely determined and indicated on plans. GC shall be responsible for adapting construction methods to achieve the design effect shown, as required. The Architect shall be notified of any variation from the conditions shown.

4. The General Contractor shall use extreme caution in demolition of existing construction. It shall be the contractor's responsibility to identify and verify structural items regardless of whether they are indicated on these drawings, and to contact the Architect in the event of a discrepancy

5. All new work shall comply with all applicable accessibility requirements. Work shall not diminish any existing accessibile features.

6. SCOPE OF WORK: Interior and exterior renovations to existing building including windows/doors, electrical, lighting, mechanical improvements as well as site improvements in accordance with an approved land development plan.

NEW RESTROOMS

Plumbing Fixtures Maximum building occupant load at one time:

Main Level 144 people 144/2 = 72 people

Women: req'd 1/75 -W closets: req'd 1/200 -Lavatories

req'd 1/75 -W closets: reg'd 1/200 -Lavatories

req'd/provided:1/1 req'd/provided:1/1

req'd/provided: 1/2

req'd/provided: 1/1

-Urinals

reg'd/provided: 0/1 Note: Per Section 419.2 of the plumbing code, a urinal may be provided to meet water closet requirement for no more than 67% of require water closets.

1 required / 1 provided Service sink

1. Restrooms are to be fully handicap accessible. G.C. is to supply/install all fixtures and components in full compliance with the 2010 ADA & 2009 ICC/ANSI A117.1 Accessibility Standards.

PORTABLE FIRE EXTINGUISHERS

Portable fire extinguishers shall be selected, installed and maintained in accordance with IBC/IFC Section 906 and NFPA 12. Requirements include, but are not limited to:

-Provide a minimum of one (1) type 2A:10B:C extinguisher for each 3000 s.f. of floor area. Travel distance to such an extinguisher shall not exceed 75 feet.

-A portable type "K" fire extinguisher shall be located within 30 feet of commercial cooking equipment. -Fire extinguishers provided for the protection of cooking grease fires shall be of an approved type compatible with the automatic fire-extinguishing system agent and in accordance with IFC section 904.11.5.

-Portable fire extinguisher types, sizes, quantities and locations are subject to approval of the fire -Location shall be unobstructed and unobscured, and firmly mounted in cabinet or on bracket supplied

-Mounting height not to exceed 42" to top, or bottom be closer than 4" to floor, and shall not protrude more than 4" from wall if on an accessible route. (IBC 2015 906.9.2/906.9.3)

PROPOSED LOCATIONS SHOWN ON 1/A2.1. FINAL LOCATIONS SHALL BE AS APPROVED BY LOCAL FIRE MARSHAL

$\mathbf{\alpha}$ URG

PERMIT DOCUMENTS

6-14-21

REV1: 1/12/22

ARCHITECT OF RECORD

AIA, LEED AP DRAWN BY: MSR

OWNER OF RECORD

TAXMAP SHEET #133

ABIII, LLC BLOCK 13303

LOT 2

REV2 1/26/2022

Samantha Ciotti Falcone




3515 Sunnyside Road Center Valley, PA 18034 T: 610-297-0140

E: sam@scf-arch.com

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> **PROJECT INFO** & COVER

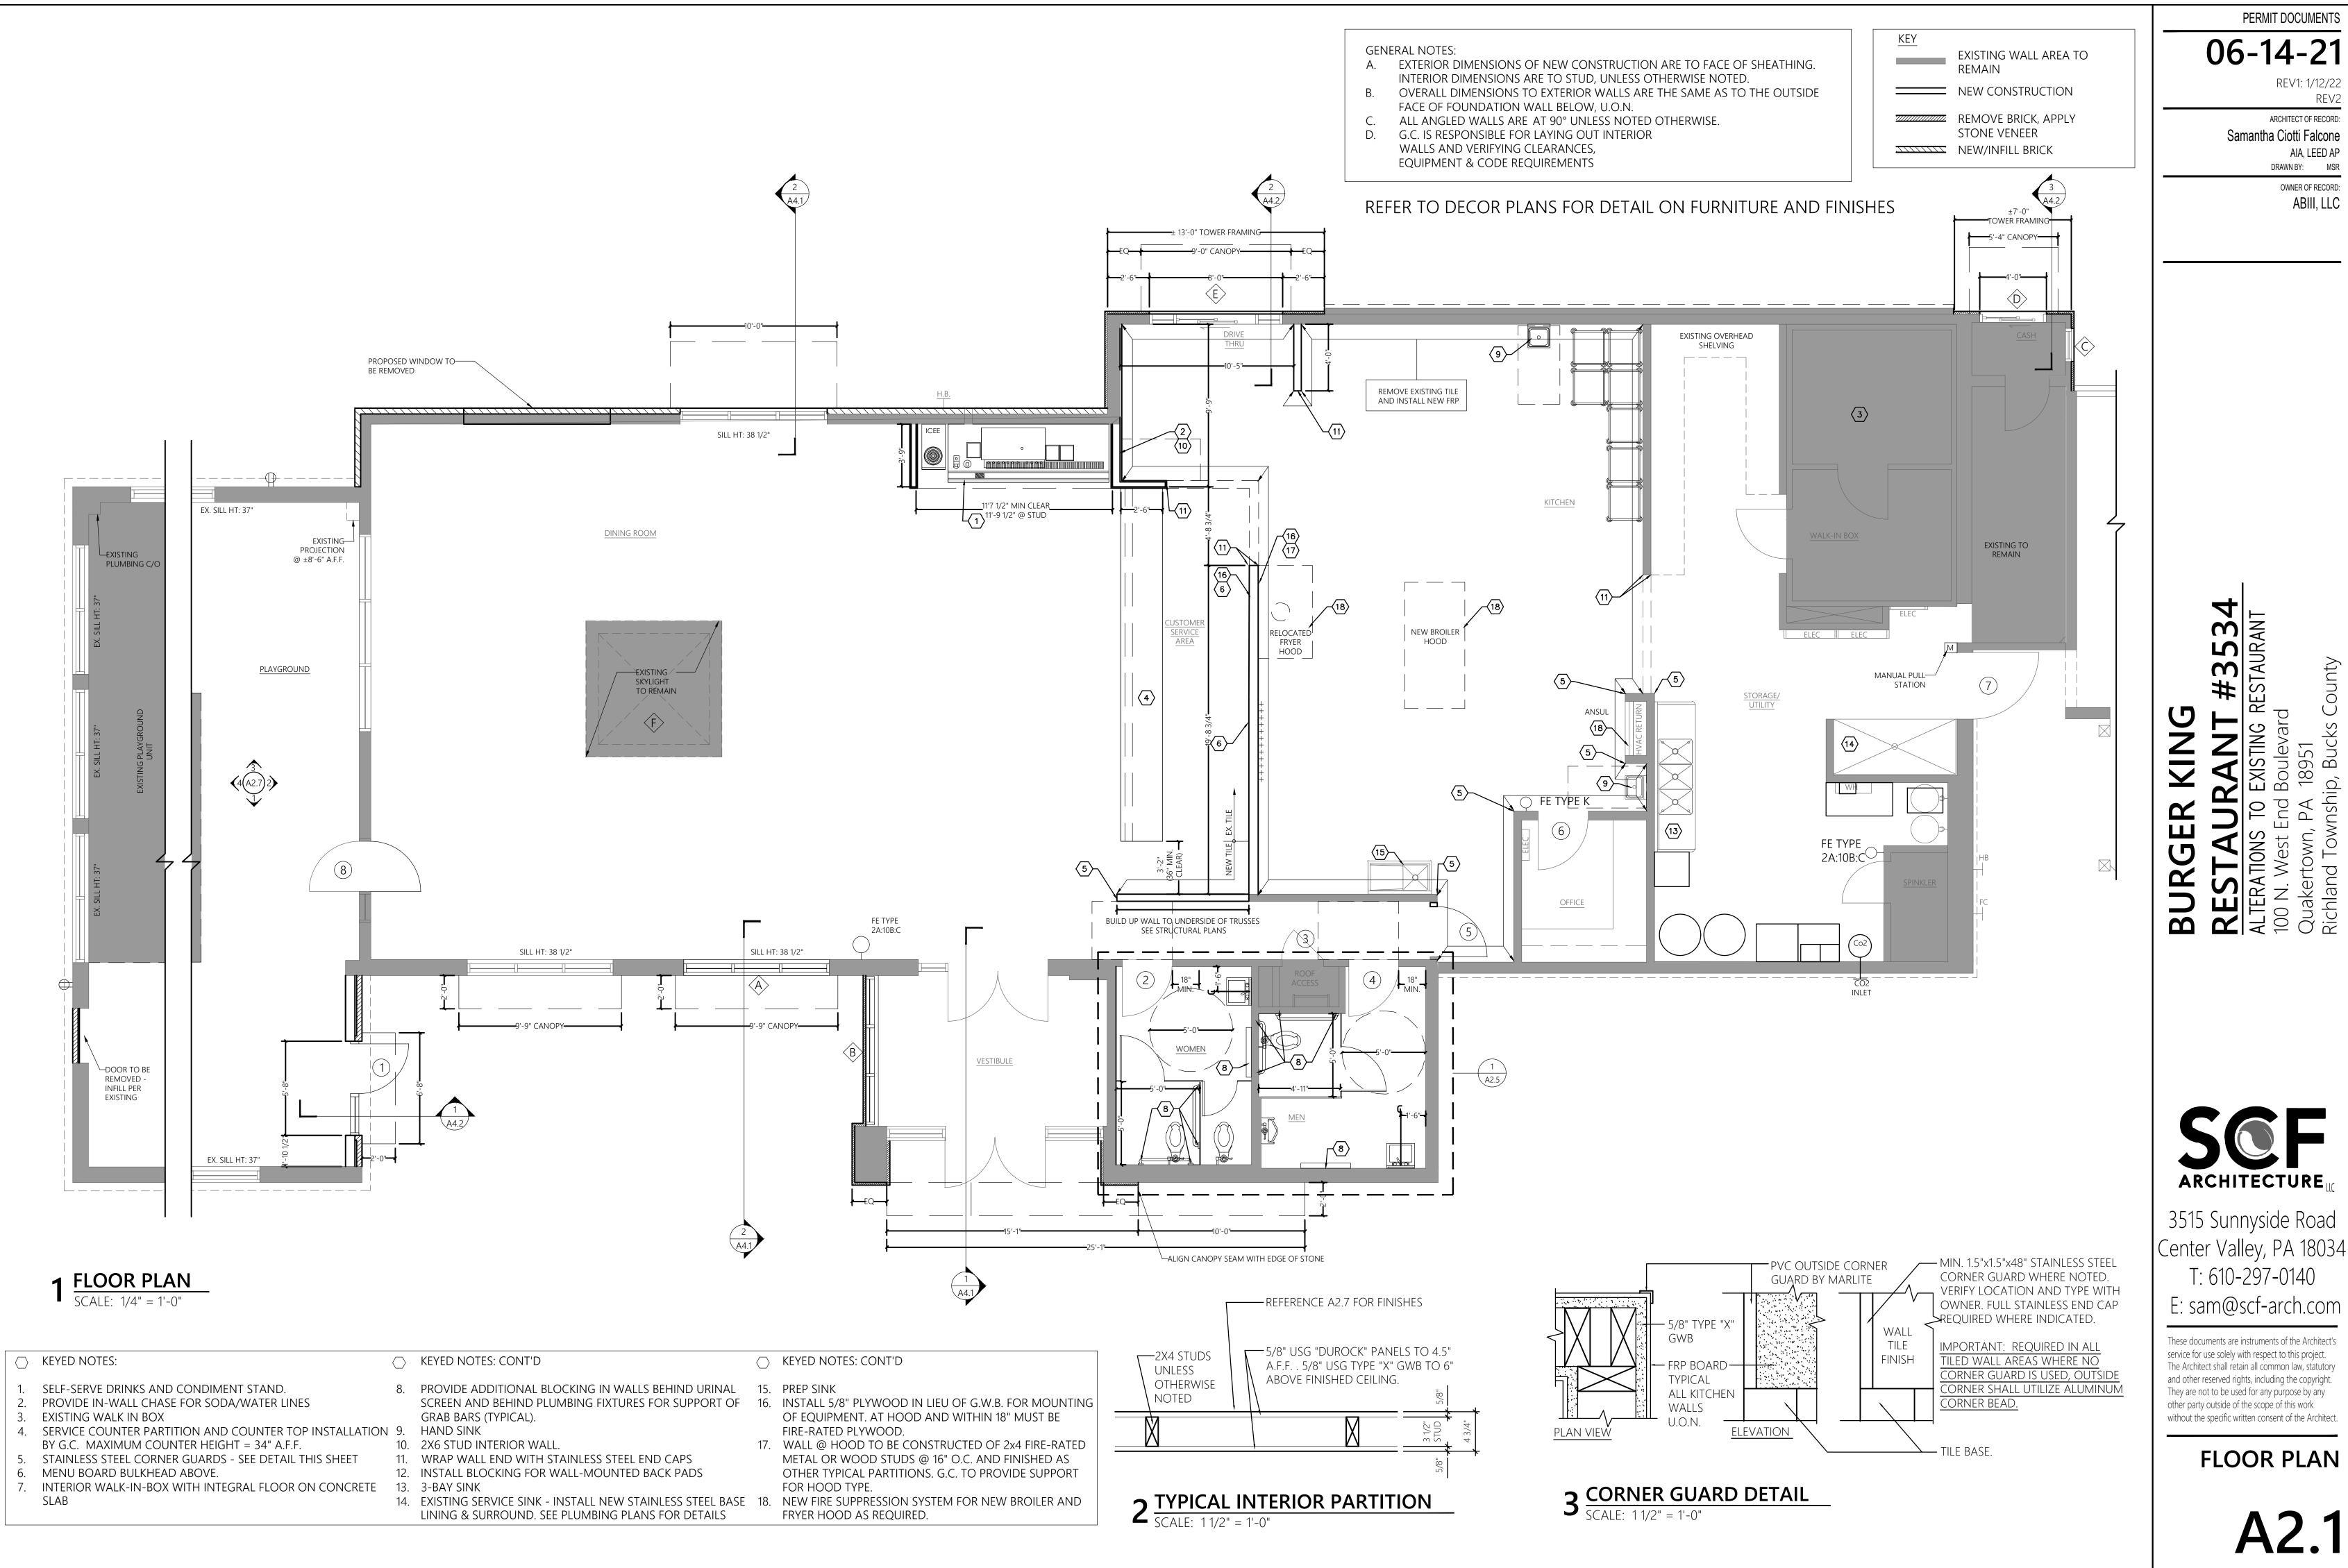

ARCHITECT OF RECORD:

DRAWN BY: MSR


OWNER OF RECORD: ABIII, LLC

AIA, LEED AP

Samantha Ciotti Falcone

FLOOR PLAN

06-14-21

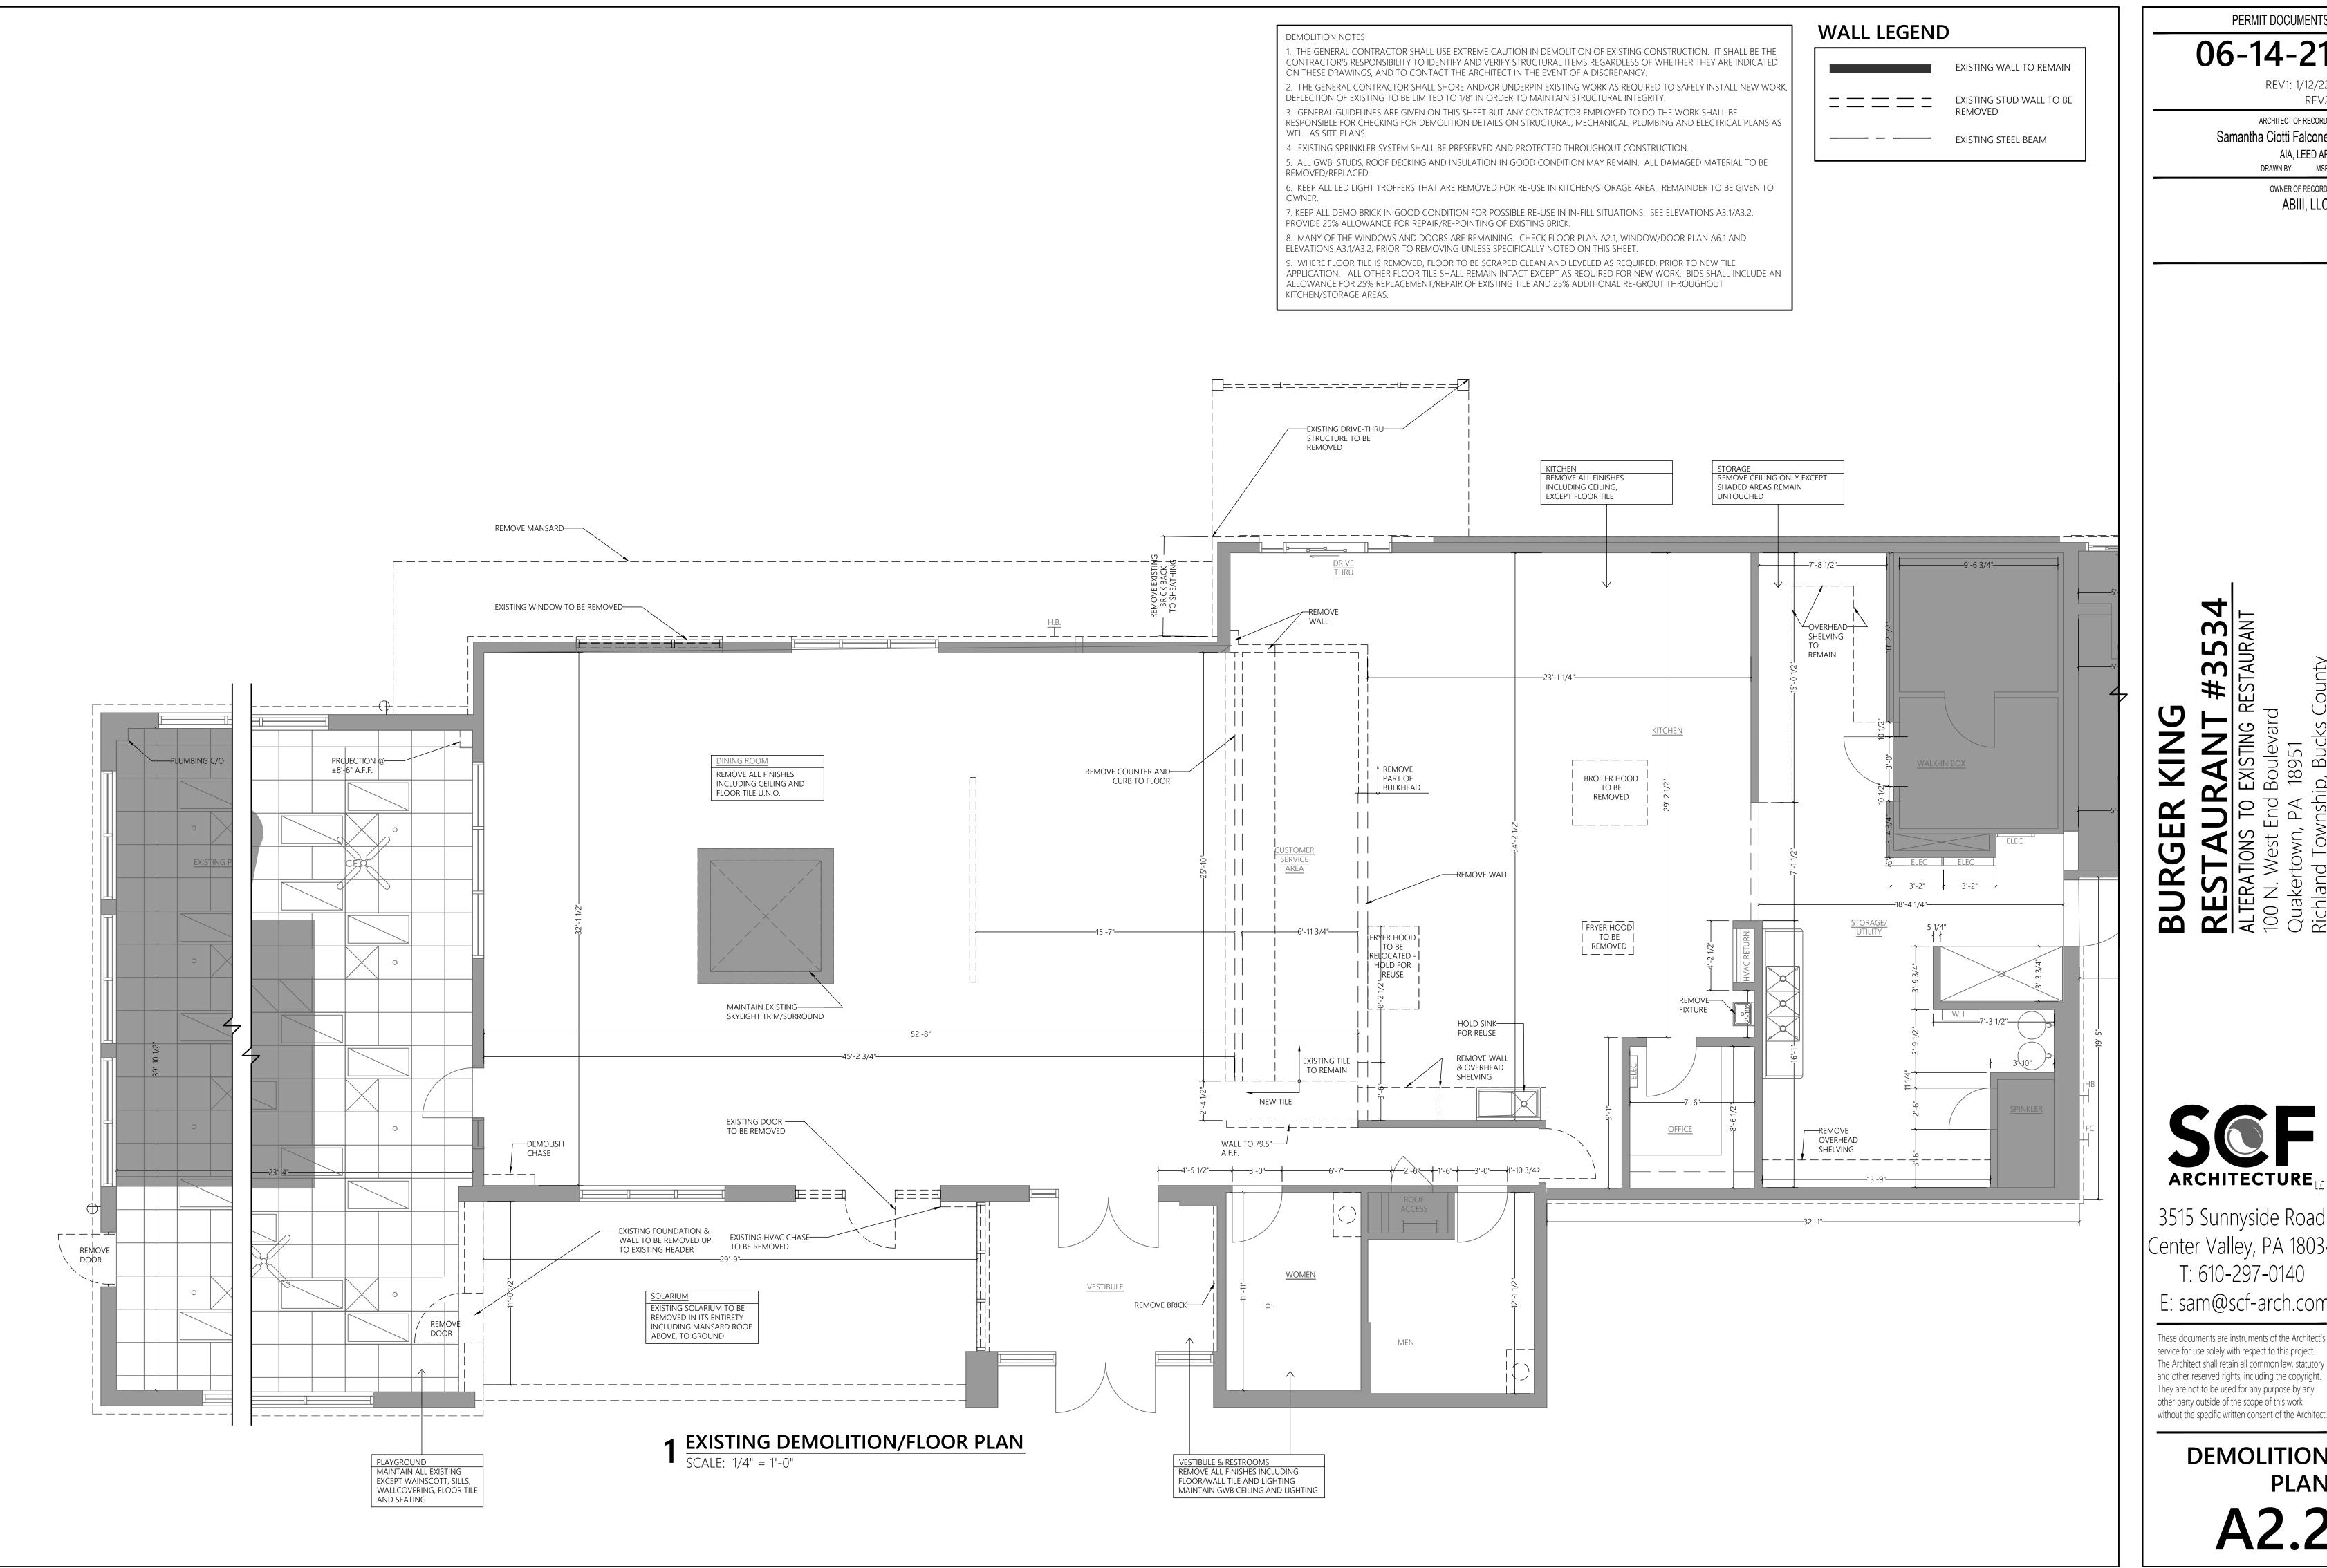

REV2

ARCHITECT OF RECORD: Samantha Ciotti Falcone


AIA, LEED AP DRAWN BY: MSR OWNER OF RECORD:

ARCHITECTURE LLC

3515 Sunnyside Road Center Valley, PA 18034 T: 610-297-0140 E: sam@scf-arch.com

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> **DEMOLITION** PLAN

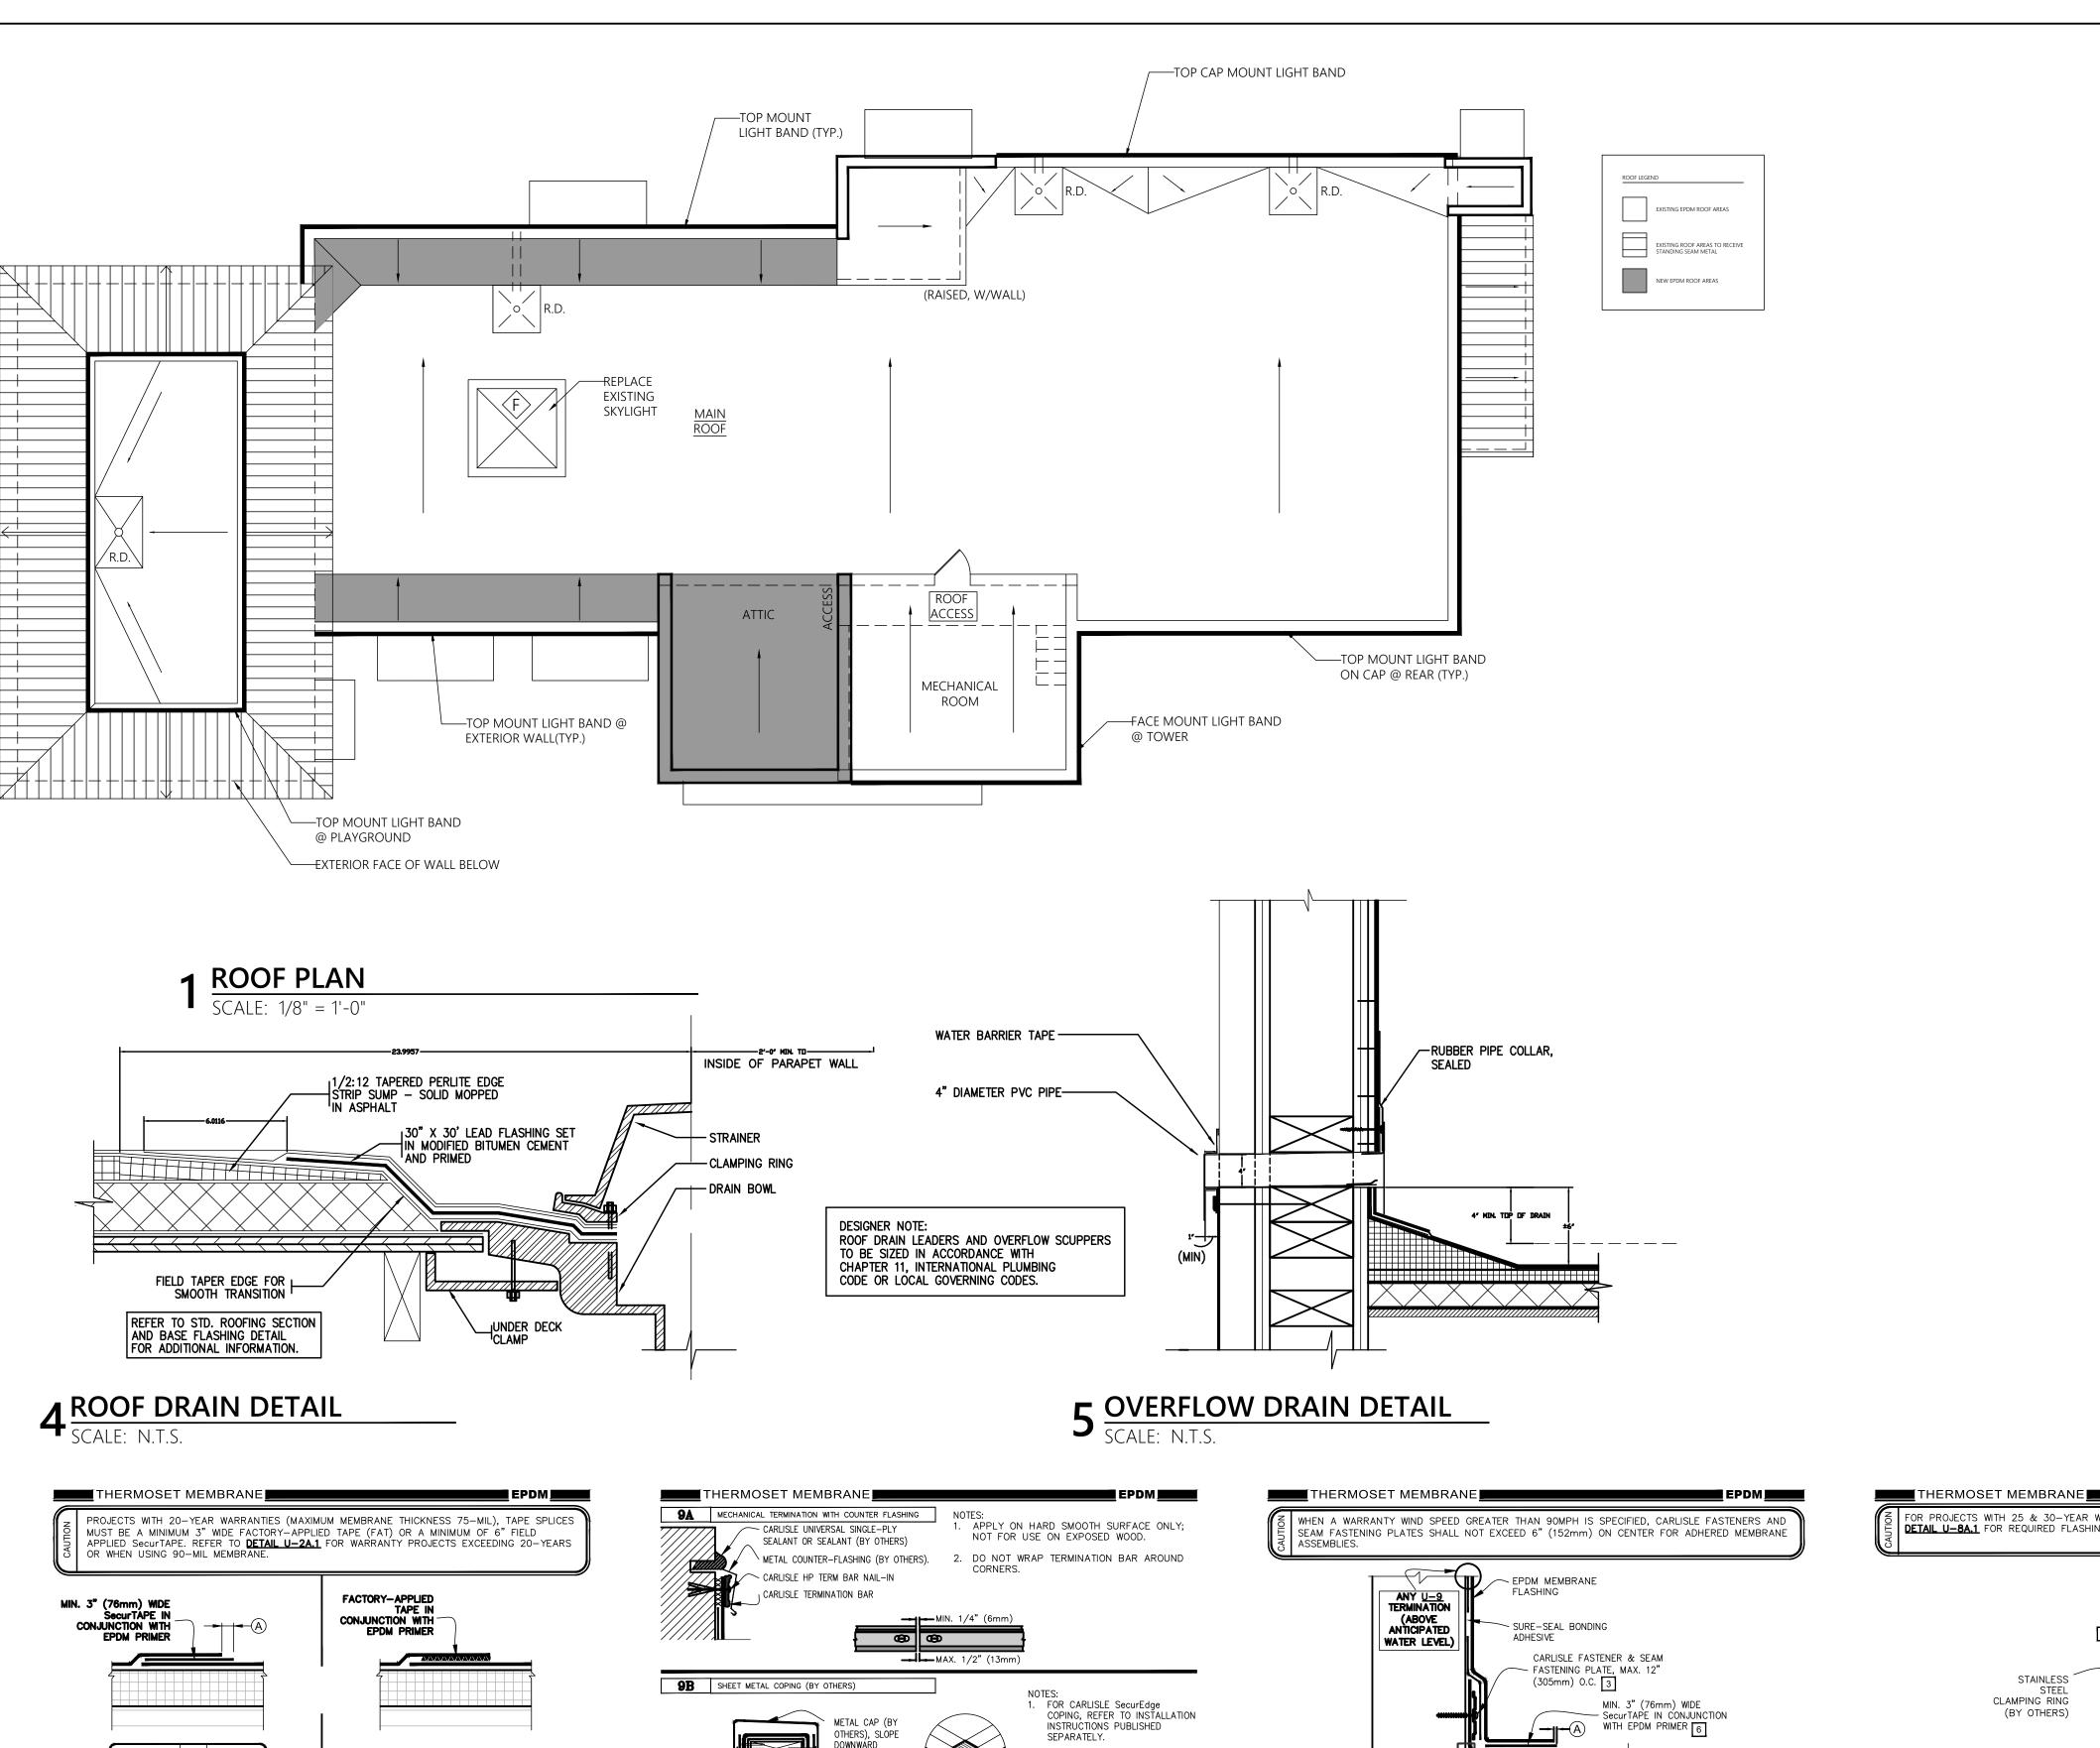

TOWARDS ROOF

CARLISLE UNIVERSAL SINGLE-PLY

- METAL COUNTER-FLASHING (BY

SEALANT OR SEALANT (BY OTHERS)

FASTEN MEMBRANE @ 12" (305mm)

- CARLISLE UNIVERSAL SINGLE-PLY

CARLISLE TERMINATION BAR

APPLICABLE BONDING ADHESIVE

SEE NOTE(S)

© 2011 Carilsie SynTec, a division of Carilsie Construction Materials incorporates

APPROVED SUBSTRATE PAGE 1 OF 2

SEALANT OR SEALANT (BY OTHERS)

MEMBRANE MUST BE EXTENDED

TO CORNERS TO PROVIDE COMPLETE COVERAGE OF THE

TOP WALL SURFACE.

WHEN MECHANICAL FASTENERS ARE

COUNTER-FLASHING OR CAULK THE

DETAIL NOT FOR USE ON WARRANTY PROJECTS EXCEEDING 10-YEARS.

APPLY ON HARD SMOOTH SURFACE ONLY;

NOT FOR USE ON EXPOSED WOOD.

3. <u>DETAIL NOT FOR USE ON WARRANTY PROJECTS EXCEEDING 20-YEARS.</u>

XXXXXXXXX WATER CUT-OFF MASTIC- MUST BE
HELD UNDER CONSTANT COMPRESSION.

BAR AROUND CORNERS.

MEMBRANE TERMINATIONS

For additional information, refer to Specifications

2. DO NOT WRAP COMPRESSION TERMINATION

USED TO PENETRATE THE METAL

COUNTER-FLASHING, USE EPDM WASHERS, APPLY WATER CUT-OFF

MASTIC UNDER THE

FASTENER HEADS.

IMENSIONS mm

(<u>see notes</u>)

EPDM

(a) | 1/8" | 3 | TO

1/2" | 13 | MAX.

DIRECTIONS FROM THE SPLICE INTERSECTION.

→ APPROVED SUBSTRA

2011 Carilsie SynTec, a division of Carilsie Construction Materials incorporated

1. FIELD APPLIED SecurTAPE IS TO BE OVERLAPPED A MINIMUM OF 1" (25mm) AT THE ENDS OF EACH

CUT PIECE. APPLY LAP SEALANT AT TAPE OVERLAPS 2" (51mm) IN ALL DIRECTIONS AS SHOWN.

(152mm X 152mm) T-JOINT COVER, COVERING THE EXPOSED SPLICE TAPE 2" (51mm) IN ALL

3. 6" (152mm) WIDE PRESSURE—SENSITIVE ELASTOFORM FLASHING, IN CONJUNCTION WITH EPDM PRIMER, MAY ALSO BE CENTERED OVER THE INTERSECTING POINT OF THE LEADING EDGES OF THE FIELD

For additional information, refer to Specifications

2. APPLY LAP SEALANT ALONG THE LEADING EDGE OF THE MEMBRANE SPLICE UNDER THE 6"X6"

4. LAP SEALANT IS REQUIRED ON CUT EDGES OF REINFORCED EPDM MEMBRANE.

DIMENSIONS | mm | () | 1/8" | з | то 1/2" 13 MAX. B) 3" 76 1. PRIOR TO THE INSTALLATION OF SecurTAPE AND PRESSURE-SENSITIVE FLASHING APPLY EPDM PRIMER TO SPLICE AREAS. REFER TO SPECIAL CONDITION SPEC. SUPPLEMENTS G-01-11 OR G-08-11: 2.1. TO BLOCK INDOOR AIR INFILTRATION AND HUMIDITY AT THE JUNCTION (G-01-11) 2.2. WHERE ROOF SYSTEM IS DESIGNED WITH A VAPOR RETARDER (G-08-11). APPLIED ALON PRESSURE-5. SEAM FASTENING PLATE/FASTENER MAY BE SENSITIVE INSTALLED INTO THE STRUCTURAL DECK. HP FASTENERS AND POLYMER SEAM PLATES ARE REQUIRED FOR MECHANICALLY-FASTENED ROOFING SYSTEMS OVER STEEL DECKS. PROJECTS WITH 25 AND 30-YEAR WARRANTIES OR WHEN USING 90-MIL MEMBRANE, ALL VERTICAL SPLICES AT THE BASE OF A WALL AND SPLICE INTERSECTIONS MUST BE OVERLAID WITH TWO LAYERS OF PRESSURE-SENSITIVE ELASTOFORM FLASHING. THE BOTTOM LAYER SHALL BE 6" (152mm) WIDE COVERED WITH A 12" (305mm) WIDE PRESSURE-SENSITIVE ELASTOFORM FLASHING PIECE. BOTH LAYERS SHALL BE CENTERED AND SEALED WITH CONTINUOUS LAP SEALANT. REFER TO DETAIL U-2C. 6. MEMBRANE SPLICES SHALL INCORPORATE 6" (152mm) WIDE FIELD APPLIED SecurTAPE FOR PROJECTS WITH 20, 25 and 30-YEAR WARRANTIES. 7. LAP SEALANT IS REQUIRED ON CUT EDGES OF REINFORCED MEMBRANE.


PARAPET / CURB WITH SEPARATE

For additional information, refer to Specifications

APPROVED SUBSTRATE MEMBRANE FLASHING

SEE NOTE(S)

2011 Carilsie SynTec, a division of Carilsie Construction Materials incorporated

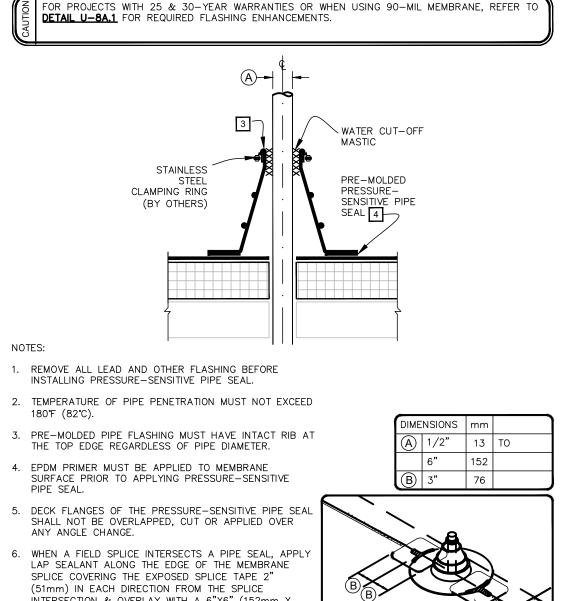

1. REMOVE ALL LEAD AND OTHER FLASHING BEFORE

- 6. WHEN A FIELD SPLICE INTERSECTS A PIPE SEAL, APPLY
- INTERSECTION & OVERLAY WITH A 6"X6" (152mm X

152mm) T-JOINT COVER. 7. ON MECHANICALLY-FASTENED ROOFING SYSTEMS, ADDITIONAL MEMBRANE SECUREMENT IS REQUIRED. REFER TO **DETAIL MF-8A.**

PRE-MOLDED PRESSURE-SENSITIVE → APPROVED SUBSTRATE PIPE SEAL → SEE NOTE(S) For additional information, refer to Specifications © 2011 Carilsie SynTec, a division of Carilsie Construction Materials incorporated

NOTE

ALL ROOFING DETAILS TO BE VERIFIED

SPECIFICATIONS AND WARRANTIES.

POSSIBLE. ROOF CURB IS REQUIRED.

REFER TO MECHANICAL PLANS.

ROOF NOTES:

CLEARANCES

MECHANICAL

NEW ROOF SECTIONS

RECOMMENDATIONS

EXISTING ROOF

ACHIEVE R-30 MIN.

EPDM ROOF COLOR

VISIBLE FROM GROUND)

ACCESS TO EACH RTU

WRAPPED WITH STONE VENEER.

FROM A/C UNIT-

NOTE:
PROVIDE DRAIN NUT
IN BOTTOM OF P-TRAP-

PIPE SUPPORT
PEDESTALS PLACED

5'-0" O.C. & ALL TURNS,
JUNCTION IN LINES.

(WOOD BLOCKING NOT ALLOWED)

PARAPET HEIGHT.

SHEATHING PER STRUCTURAL PLANS

INDICATED ON WALL SECTIONS)

PLANS.

AND COORDINATED WITH MANUFACTURERS

1. VERIFY CONDITION OF EXISTING ROOF DRAINS/LINES ON MAIN ROOF. INSTALL NEW EMERGENCY OVERFLOWS IN WALL AS SHOWN.

EXISTING FRYER FAN TO REMAIN AT EXISTING ROOF OPENING IF

NOTE THAT ONLY TWO HOOD/FAN LOCATIONS WILL BE REQUIRED.

AND OTHER CODE REQUIREMENTS PRIOR TO FRAMING. REFER TO

G.C. TO VERIFY & COORDINATE ALL NEW ROOF OPENINGS WITH HVAC

(2) LAYERS 2 1/2" MIN. POLYISOCYANURATE RIGID ROOF INSULATION

(R-30 MIN.) ON TOP OF SHEATHING (R-30 FIBERGLASS BATT AS

APPLY EPDM FOOFING IN ACCORCANCE WITH MANUFACTURER

G.C. TO INSPECT EXISTING ROOF DECKING & REPLACE ANY

APPLY NEW EPDM OR STANDING SEAM METAL ROOFING IN

ACCORDANCE WITH MANUFACTURE RECOMMENDATIONS

REPLACE ALL PARAPET CAPPING - REF. A3.1/A3.2 FOR COLOR.

G.C. TO INSPECT EXISTING INSULATION AND ADD AS NEEDED TO

GRAY ON HORIZONTAL AND VERTICAL SURFACES AT OR BELOW MAIN

BUFF/BEIGE ON REAR TOWERS ABOVE MAIN PARAPET HEIGHT (I.E.

TOWER FACES ARE STONE VENEER AND RETURN ENDS SHOULD BE

WALKWAY MEMBRANE ROOF MATS TO BE INSTALLED FROM ROOF

DETERIORATED AREAS TO ELIMINATE PONDING.

REF. A3.3 FOR EXTERIOR FINISH SCHEDULE

NEW BROILER HOOD/FAN TO USE EXISTING ROOF OPENING IF

POSSIBLE. STAINLESS STEEL ROOF CURB SUPPLIED WITH FAN

NEW HVAC UNITS MUST UTILIZE EXISTING TRUSS OPENINGS TO EXTENT

3 CONDENSATE LINE SUPPORT DETAIL
SCALE: N.T.S.

__ROOF___/

PERMIT DOCUMENTS

06-14-21

REV2: 1/26/22 ARCHITECT OF RECORD: Samantha Ciotti Falcone

> DRAWN BY: MSR OWNER OF RECORD: ABIII, LLC

18951 Bucks U

3515 Sunnyside Road

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ROOF PLAN

EQUIPMENT SCHEDULE


M NO.	QTY_	EXISTING/NEW	DESCRIPTION —	SUPPLIED BY	INSTALLED BY.	VOLTS/ PHASE	AMPS —	WATER_	DRAIN -	GAS BTU NOTES
.ivi ivo.	411					VOLIS/ PILASE	AWIFS	WAILK	_	
	1		QUAL SERV DRINK BAR-SS	OWNER (G)	GC				1 I.D.	DoorsStainless Steel
	LOT		METRO UNDERCOUNTER SHELVING	OWNER	GC			4/0.110.0	4.4/0	4404055
	0	NEW	TABCO DROP-IN HAND SINK	H&K	GC			1/2 H&C	1 1/2	14" WIDE
	2	NEW	CUSTOM SS DRIVE-THRU TABLE	GC	GC	120.4				SS WALL MOUNT COUNTER REF DETAI
	1		METRO DRIVE-THRU TABLE 30 X 48HEATED		GC	120-1				CORD & PLUG
	0		MOBILE D/T CART	H&K H&K	GC					POWER FROM MAIN BOARD
	0		CUP DISPENSER SS SHELVES /WATER	H&K	GC					HP LAMINATE: FOG GRAY
c	2		· · · · · · · · · · · · · · · · · · ·	H&K	OPS(S)	115-1	6.2			COPD AND BLUG
	1	NEW	BOOSTER/CARBONATOR LANCER/IDC PRO COKE DISPENSER	H&K	OPS(S)	120-1	6.2 8.5		3/41.D.	CORD AND PLUG CORD & PLUG, WATER THRU SODA LIN
	1	NEW	LANCER COKE DISPENSER (CREW)	OWNER	OPS(S)	120-1	5.3		3/41.D.	CORD & PLUG, WATER THRU SODA LIN
	<u></u>		SILVER KING REF. BEVERAGE STATION-27"	OWNER	GC	120-1	3.3		3/41.0.	CORD & PLUG, SS WORKTOP
	1	1	FBD FROZEN COKE MACHINE	OWNER (G)	OPS(S)	208-1	30			CORD & PLUG, OUTLET 18"H/18" IN UN
		LAISI	I BB I ROZEN CORE MACHINE	OWNER (G)	013(3)	200-1				DRINK BAR
	1	NEW	TAYLOR SHAKE/SOFT SERVE MACHINE	H&K	OPS(S)	208-3	24			CORD & PLUG
	1	NEW	HOSHIZAKI52" ICE BIN	H&K	GC GC	200 0			3/4 I.D.	00110 01 200
	1	NEW	HOSHIZAKI ICE CUBER ACTUAL		OPS(S)	208-1	10.7	1/2 C	3, 11121	CORD & PLUG, INSTALL 120V POWER (
			MAKE/MODEL OF EXISTING UNIT MAY VARY-							FROM UNIT TO ROOFTOP CONDENSER
			-EXISTING CONDENSER							CLEARANCE AT REAR
	1	NEW	SS SERVICE CHASE FOR REF. LINES	н&к	GC					
	1	EXIST	BUNN ITCB COFFEE/TEA BREWER	OWNER (G)	OPS(S)	120-1	15	1/2 C		CORD & PLUG
	2		FIRE SUPPRESSIONMANUAL PULL STATION	· · · · ·	GC					
	1		H/K MAIN PREP BOARD/SPECIALTY	H&K	GC	120/208-3, 115-1	150			CONTAINS 150 MLO LOAD CENTERPA
	1	NEW	BUN TABLE	H&K	GC					
	1		EXPEDITER STATION WITH REF	H&K	GC	120-1				CORD &PLUG
	1		MOBILE BREAKFAST CART	H&K	GC					
23	3 1	+	BROILER HOOD/EXHAUST FAN/ROOF	Н&К	GC	208-1	5			REFERENCE MECHANICAL PLANS FOR
			CURB/CORDS7'-7" WITH ANSUL	<u> </u>				<u></u>		IF NEW HOOD TO BE INSTALLED
	1		DUKE BROILER	OWNER (G)	GC	120-1	2			3/4 GAS 95,000
	1		SILVER KING MOBILE SPEC FREEZER 24 X 50		GC	120-1	6.9			CORD &PLUB
	1		SILVER KING MOBILE MEAT FREEZER-24 X 44		GC	120-1	6.9			CORD & PLUG
	LOT		MOBILE BUN RACK	STROEHMAN						
29	2		RTI SHORTENING STORAGE TANK			120-1	20			CORD AND PLUG, QUAD OUTLET @ 90
	1	EXIST	FRANKE FRY HOLDING STATION	OWNER	GC	120-2, 208-1	21			CORD & PLUG
	SET	+	PITCO FRYERS(1) 20" (2) 16"	OWNER (G)	GC	115-1	0.7 EACH			3/4 EACH 60,000 EA CORD & PLUG
	1		SILVER KING MOBILE FRY FREEZER 24 X 34	OWNER	GC	120-1	5.7			CORD & PLUG
	1		SILVER KING U/C REFRIGERATOR	H&K	GC	120-1	2.9			CORD& PLUG
33	3 1		FRYER HOOD/EXHAUST FAN/ROOF	OWNER	GC	208-1	2.0			REFERENCE MECHANICAL PLANS FOR
-		1	CURB/CORDS5'-7" WALL MOUNT							IF NEW HOOD TO BE INSTALLED
		1	W/ANSUL (TO BE RELOCATED)				3			II NEW HOOD TO BE INSTRUCED
	1		BLODGETT OVEN/MOBILE STAND	OWNER (G)	GC	208-3	27			OUTLET MOUNTED UNDER HOOD
	1		24 X 24 MOBILE WORK TABLE	OWNER (G)	GC	200 0	1			MOBILE, WITH BACKSPLASH
	1	EXIST	42 X 24 MOBILE WORK TABLE	OWNER (G)	GC					MODIEE, WITT BACKST BASIT
	1	EXIST	WALK-IN-BOX COOLER/FREEZER	OWINEIR	00	208/230-3			3" H.D.	CONFIRM MANUFACTURER REQUIREN
	-	LAIST	(COOLER REFRIGERATION TO BE REPLACED			(2)208/230-1 115	<u>.</u>		3 11.0.	CHECK LOCAL CODE REQUIREMENTS F
			BYOWNER)			1, 120-1	1			CONDENSATE LINE
	LOT	EXIST	METRO SHELVINGCOLD STORAGE			1, 120-1				CONDENSATE LINE
	LOT		METRO SHELVINGDRY STORAGE		GC					
	1201		METRO MOBILE SECURITY UNIT 48"		GC					
	LOT		METRO WALL SHELVING	OWNER (R)	GC					
	1		BREAKFAST TOASTER (NOT SHOWN)	H&K	GC					CORD & PLUG, ON PANEL D
	1		MICROWAVE OVEN (NOT SHOWN)	OWNER (G)	GC					CORD & PLUG, ON PANEL D
	2		PRINCE CASTLE PRODUCT HOLDING UNIT	OWNER (G)	GC					CORD & PLUG, ON PANEL D
	1	 	RAISE UP EGG STATION (NOT SHOWN)	OWNER (G)	GC					CORD & PLUG, ON PANEL D
	1		SILVER KING U/C REFRIGERATOR	OWNER (G)	GC	120-1	3			CORD & PLUG
	1		REF. CHICKEN BATTER STATION	H&K	GC	120-1	3			CORD & PLUG
	2		PRINCE CASTLE RAPID VERTICAL TOASTER	ł	GC	120-1	3			CORD & PLUG, ON PANEL D
	1	EXIST	QUAL SERVE 3-COMPARTMENT SINK	OWNER (G)				(2)1/2	2" I.D.	2 EACH, HOT & COLD WATER & PROVI
	1	LVISI	QUAL SERVE S-COIVIPAR LIVIEN I SINK					(2)1/2 H&C	^{∠ 1.} D.	1/2"H HOSE BIB FOR ECOLAB MIXING
	1	EVICT	OLIAL SERVE 1 COMPARATATAT PRED CINIC	+			1		2" I.D.	1/2 IL LOSE BIR LOK ECOTAR MIXING
	1 ว	NEW	QUAL SERVE 1- COMPARTMENT PREP SINK	П8.И	GC	+	1	•		LIAND COAD CANUTIZED 9 DADED TOTAL
	٥	INEVV	TABCO SS HAND SINKPEDESTAL STYLE	H&K	lac lac			1/2 H&C	1 1/2"	HAND SOAP, SANITIZER & PAPER TOW DISPENSER TO BE PROVIDED
	1	NEW	W/FOOT PEDAL	GC	GC			1/2 H&C		
	1		CUSTOM SS MOP SINKWRAP EXISTING	اعد	lac lac			1/ZH&C		CONSULT OWNER FOR FAUCET & PRO
	1		BASE AND 72"AFF WALL SURROUND	OWNED (C)			1			1/2"H HOSE BIB FOR ECOLAB MIXING
	1		PRINCE CASTLE SABER KING MULTI-SLICER	OWNER (G)			1	2/4110.0		1/2 CAS CHAPTA 4/2H DEGID CHIATION TO THE STATE OF THE ST
	1	EXIST	NAVIEN TANKLESS WATER HEATER					3/4 H&C		1/2 GAS 2" VENT, 1/2" RECIRCULATION LINE FI
	1	EVICT	OFFICE FILE CARINET	OMANIES	-	1	1			W/H TO LAST HAND SINK BY DRIVE-TH
68	1 1		OFFICE CARINETS	OWNER	-	1	1			UDIAMINATE EGG OFTI
	LOT		OFFICE CABINETS	OWNER		1	1			HP LAMINATE: FOG GRAY
	1	+	OFFICE SAFE	OWNER (B)	00		1			
				OWNER (R)	GC ODS(S)					STACK ON TOP (2) HIGH, 48" MAX HT E
	1		BAG-IN-BOX SYRUP RACK	OWNER	OPS(S)			2/40		FEEDS WATER ROOSTER COOK STORE
	1		WATER FILTER SYSTEMSET OF 3	H&K	OPS(S)	-	1	3/4 C		FEEDS WATER BOOSTER @ SODA SYST
	1		BULK CO2	OWNED	66					
	17		48 X 18 METRO DUNNAGE RACK	OWNER	GC					
	4		2A:10B:C FIRE EXTINGUISHER	GC	GC	1	1			
	1	NEW	TYPE K FIRE EXTINGUISHER W/PLACARD	GC	GC ODS(T)	115.4	1 2			
	6	1	SICOM POS DEVICE	OWNER (T)	OPS(T)	115-1	1.2			+ + + + + + + + + + + + + + + + + + + +
	LOT		SICOM POS PRINTER (NOT SHOWN)	OWNER (T)	OPS(T)	115-1	1.2			
	4		SICOM CASH DRAWER (NOT SHOWN)	OWNER (T)	OPS(T)					
	1		SICOM SOS TIMER (NOT SHOWN)	OWNER (T)	OPS(T)	115-1	1.2			
	1		OFFICE COUNTERTOPLAMINATE	1		1	1			HP LAMINATE: FOG GRAY
	1		KAY DISHWASHER			120-1	11.4		2"	CORD & PLUG
	1	NEW	SICOM CREW LINK DISPLAY	OWNER (T)	OPS(T)	115-1	1.2			
	4	EXIST	DIGITAL MENU BOARD	OWNER (T)	OPS(T)	115-1	7.8			
	2		OUTDOOR TRASH CONTAINERS	OWNER (G)						
	1		POU 10 GAL. WATER HEATER FOR D/W	· <i>,</i> .		208-1	28.8	3/4 H	3/4 I.D.	DIRECT WIRE W/DISCONNECT
	1		DRIVE-THRU COUNTERTOPSS					-		,
	1 1		SECURITY MONITOR	OWNER (T)	OPS(T)	115-1				
	.1			 	1 '	1	1		 	
	1		WATER SOFTENER							
	1		WATER SOFTENER TRASH COMPACTORMARATHON							

NOTE: EQUIPMENT USED WILL BE BOTH NEW AND EXISTING. REFER TO H&K KITCHEN SUPPLIER PLAN FOR NEW EQUIPMENT ORDERED. NOTE THAT KEY NUMBERS MAY BE IN DECIMAL FORM ON SOME PLANS, BUT IN MOST CASES THE BASE NUMBER WILL INDICATE THE SAME PIECE OF EQUIPMENT, OR PART OF AN EQUIPMENT GROUP, IF IT HAS THE SAME BASE NUMBER.

REMOTE POWER CONTROL

verify all new equipment connections w/equipment supplier order prior to installation

PAK'NTAINER MPT-6RL

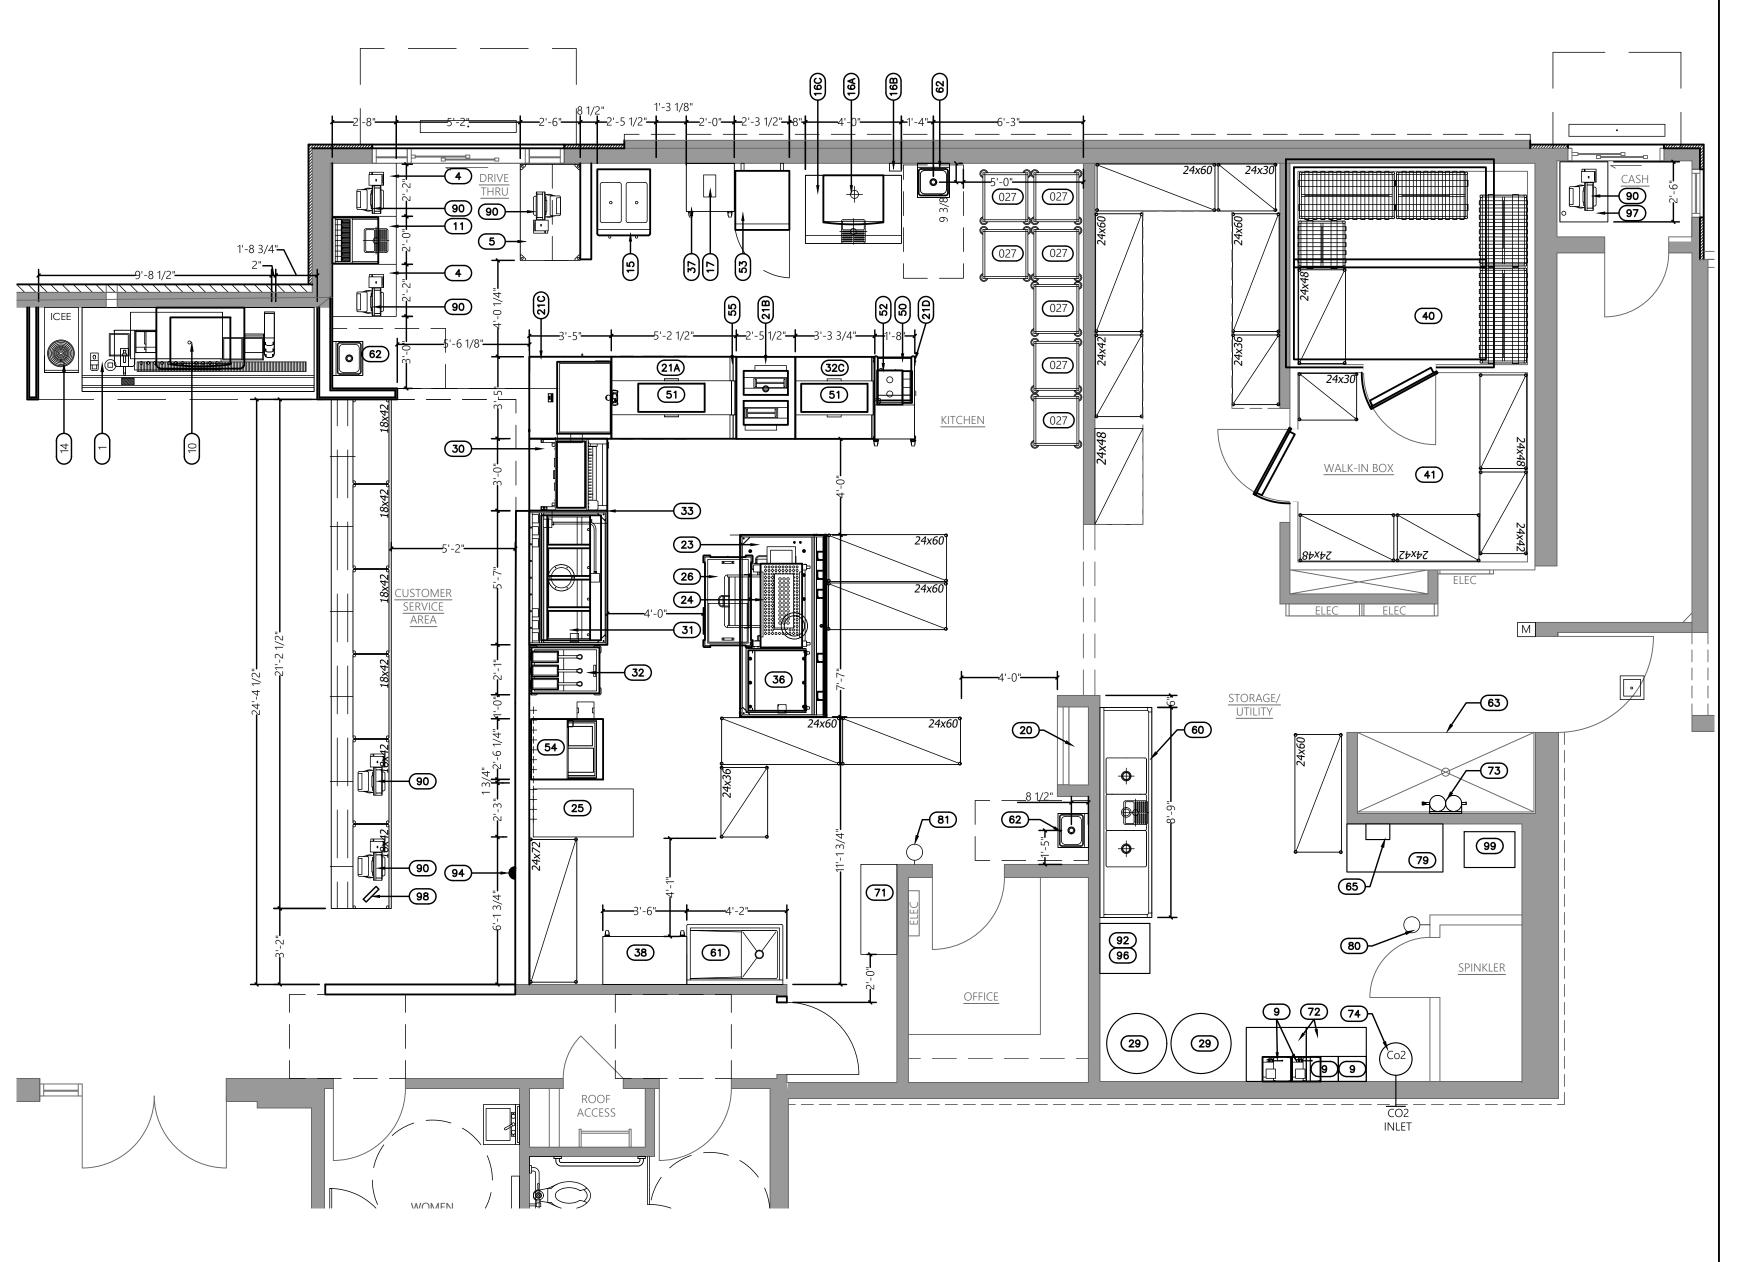

1 EQUIPMENT PLAN

SCALE: 1/4" = 1'-0"

PERMIT DOCUMENTS

06-14-21

REV1: 1/12/22 REV2: 1/26/22

ARCHITECT OF RECORD:
Samantha Ciotti Falcone
AIA, LEED AP

OWNER OF RECORD:

ABIII, LLC

RESTAUF
ALTERATIONS TO
100 N. West End

SEF ARCHITECTURE

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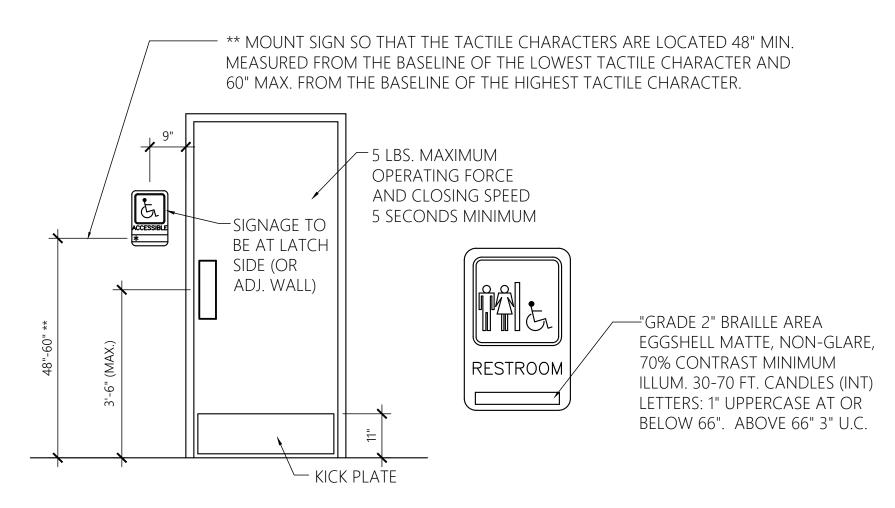
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EQUIPMENT PLAN

A2.4

1 TOILET ROOM PLAN DETAIL

SCALE: 1/2" = 1'-0"



2 TYPICAL RESTROOM SIGN DETAIL SCALE: 1/2" = 1'-0"

RESTROOM/KITCHEN ACCESSORIES

- GRAB BAR: BOBRICK 250 LBF. MINIMUM 33" MIN. TO 36" MAX. HEIGHT TO THE TOP OF THE GRIPPING SURFACE FOR HORIZONTAL GRAB BARS. A VERTICAL GRAB BAR 18" MIN IN LENGTH SHALL BE MOUNTED WITH THE BOTTOM OF THE BAR LOCATED 39 INCHES MIN AND 41 INCHES MAX ABOVE FLOOR, AND WITH THE CENTER LINE OF THE BAR LOCATED 39 INCHES MIN AND 41 INCHES MAX FROM REAR WALL.
- PROVIDE THE REQUIRED QUANTITY AND LENGTH AS INDICATED ON THE DRAWINGS OR AS REQUIRED BY THE GOVERNING CODE. THE BAR SHALL BE 1-1/2" IN DIAMETER AND MOUNTED WITH 1-1/2" CLEARANCE FROM THE WALL.
- -GRAB BARS, AND ANY WALL OR OTHER SURFACE ADJACENT TO GRAB BARS, SHALL BE FREE OF SHARP OR ABRASIVE ELEMENTS. EDGES SHALL BE ROUNDED.
 -GRAB BARS SHALL NOT ROTATE IN THEIR FITTINGS.
- -STRUCTURAL STRENGTH: ALLOWABLE STRESSES SHALL NOT BE EXCEEDED FOR MATERIALS USED WHERE A VERTICAL OR HORIZONTAL FORCE OF 250 POUNDS IS APPLIED AT ANY POINT ON THE GRAB BAR, FASTER, MOUNTING DEVICE, OR SUPPORTING STRUCTURE.
- -WITHIN STUDS WALLS TO WHICH GRAB BARS WILL BE MOUNTED, PROVIDE SOLID WOOD BLOCKING FOR ATTACHMENT OF GRAB BARS, SECURELY ANCHORED TO FRAMING AND OF SUFFICIENT SIZE AND STRENGTH TO ACHIEVE THE STRUCTURAL STRENGTH REQUIREMENTS FOR GRAB BARS SPECIFIED HEREIN.
- WALL MOUNTED SOAP DISPENSER AND HAND SANITIZER DISPENSER SUPPLIED BY PRODUCT SUPPLIER NOTE: SOAP AND HAND SANITIZER DISPENSERS TO BE PROVIDED AT EACH KITCHEN HANDSINK.
- (C) MIRROR: (BOTTOM OF REFLECTIVE SURFACE AT 40" MAXIMUM HEIGHT) MODEL B-165-1836 (18"x36") STAINLESS STEEL CHANNEL FRAME MIRROR WITH THEFT RESISTANT SCREWS BY BOBRICK OR APPROVED EQUIVALENT.
- (D) TOILET PAPER HOLDER: 9" TWIN JUMBO MODEL. SUPPLIED BY PRODUCT SUPPLIER.
- (E) HANDS FREE PAPER TOWEL DISPENSER WITH FREESTANDING WASTE RECEPTACLE SUPPLIED BY PRODUCT SUPPLIER, WASTE RECEPTACLE BY OWNER.


 NOTE: PROVIDE PAPER TOWEL DISPENSER AT EACH HAND SINK IN KITCHEN.
- (F) BABY CHANGING STATION: KOALA KARE #KB208-01 (HORIZONTAL, 34"W X 21 "H X 4"D) OR #KB101-01 (VERTICAL, 22"W X 35.5"H X 4"D) WALL MOUNTED WITH MICORBAN GREY. SANITARY BED LINERS FOR BABY CHANGING STATION: KOALA KARE #KB150-99
 NOTE: CHANGING STATION OPTION TO COMPLY WITH ALL ACCESSIBILITY REQUIREMENTS.
- **G** URINAL SCREEN
- (H) Sanitary napkin wast disposal, freestanding, with lid. Supplied by Owner.
- COAT HOOK: BOBRICK MODEL B-6717 TO BE MOUNTED ON INSIDE OF EACH RESTROOM DOOR FOR SINGLE OCCUPANCE RESTROOMS AND EACH RESTROOM STALL DOOR FOR MULTIPLE OCCUPANCY RESTROOMS.

 MOUNT AT 38"-40" A.F.F. FOR ADA ACCESSIBLE LOCATIONS AND AT 48" A.F.F. MAXIMUM FOR NON-ADA ACCESSIBLE LOCATIONS.
- TOILET STALL PARTITIONS: BOBRICK 1080/1180 DURALINE SERIES #EO-09 COLOR: EVENING TIGRIS 4674-60

 NOTE: THE HC STALL DOOR SHALL BE SELF-CLOSING, AND A DOOR PULL COMPLYING WITH ANSI A117.1 SECTION 404.2.6 SHALL BE PLACED ON BOTH SIDES OF DOOR NEAR LATCH.
- (L) BABY CHANGING STATION RECESSED KOALA KARE BABY CHANGING STATION #KB100-ST. ROUGH OPENING DIMS 35 1/2"x20 1/2"x4 1/4" D RECESS

GENERAL NOTES

- A. FOR INTERIOR FINISHES REFER TO DECOR PLANS.
- B. PLUMBING FIXTURES TO BE PROVIDED
- BY THE GENERAL CONTRACTOR, EXCEPT AS NOTED.
- C. ALL PLUMBING FIXTURES, FAUCETS AND
- ACCESSORIES TO BE ADA COMPLIANT
- D. ALL EXPOSED PIPING UNDER LAVATORIES
 TO BE INSULATED TO PROTECT FROM CONTACT.
 THERE SHALL BE NO SHARP OR ABRASIVE
 SURFACES UNDER LAVATORIES.

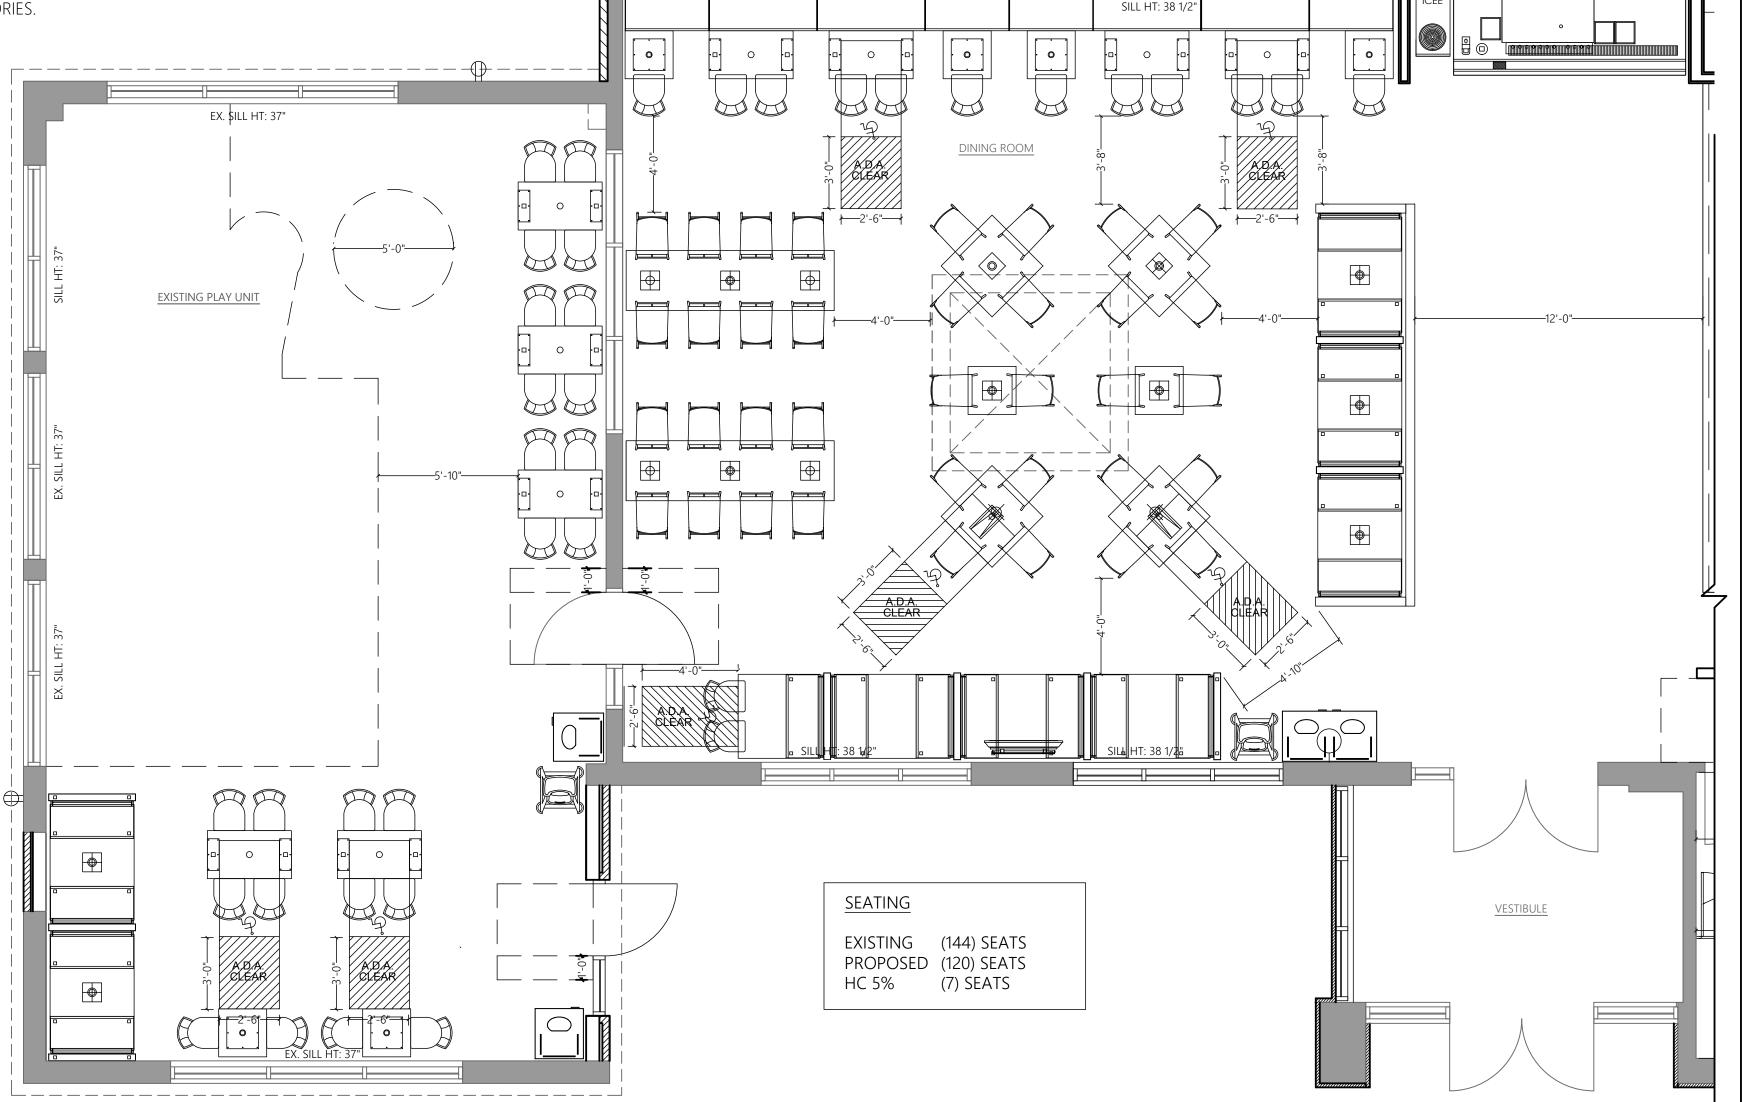

3 SEATING PLAN
SCALE: 1/4" = 1'-0"

PERMIT DOCUMENTS

REFER TO DECOR PLANS FOR DETAIL ON FURNITURE AND FINISHES

06-14-21 REV1: 1/12/22

RE'

ARCHITECT OF RECORD:

Samantha Ciotti Falcone

AIA, LEED AP

DRAWN BY: MSR

OWNER OF RECORD:

BUKGEK KING
RESTAURANT #3534
ALTERATIONS TO EXISTING RESTAURANT
100 N. West End Boulevard


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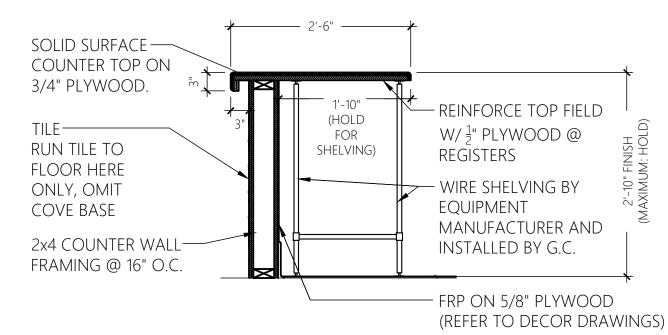
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SEATING PLAN TOILET ROOMS
A2.5




REFER TO DECOR PACKAGE FOR FINISH SCHEDULE



■ SERVICE COUNTER SECTION DETAIL $\frac{1}{\text{SCALE: } 3/4" = 1'-0"}$

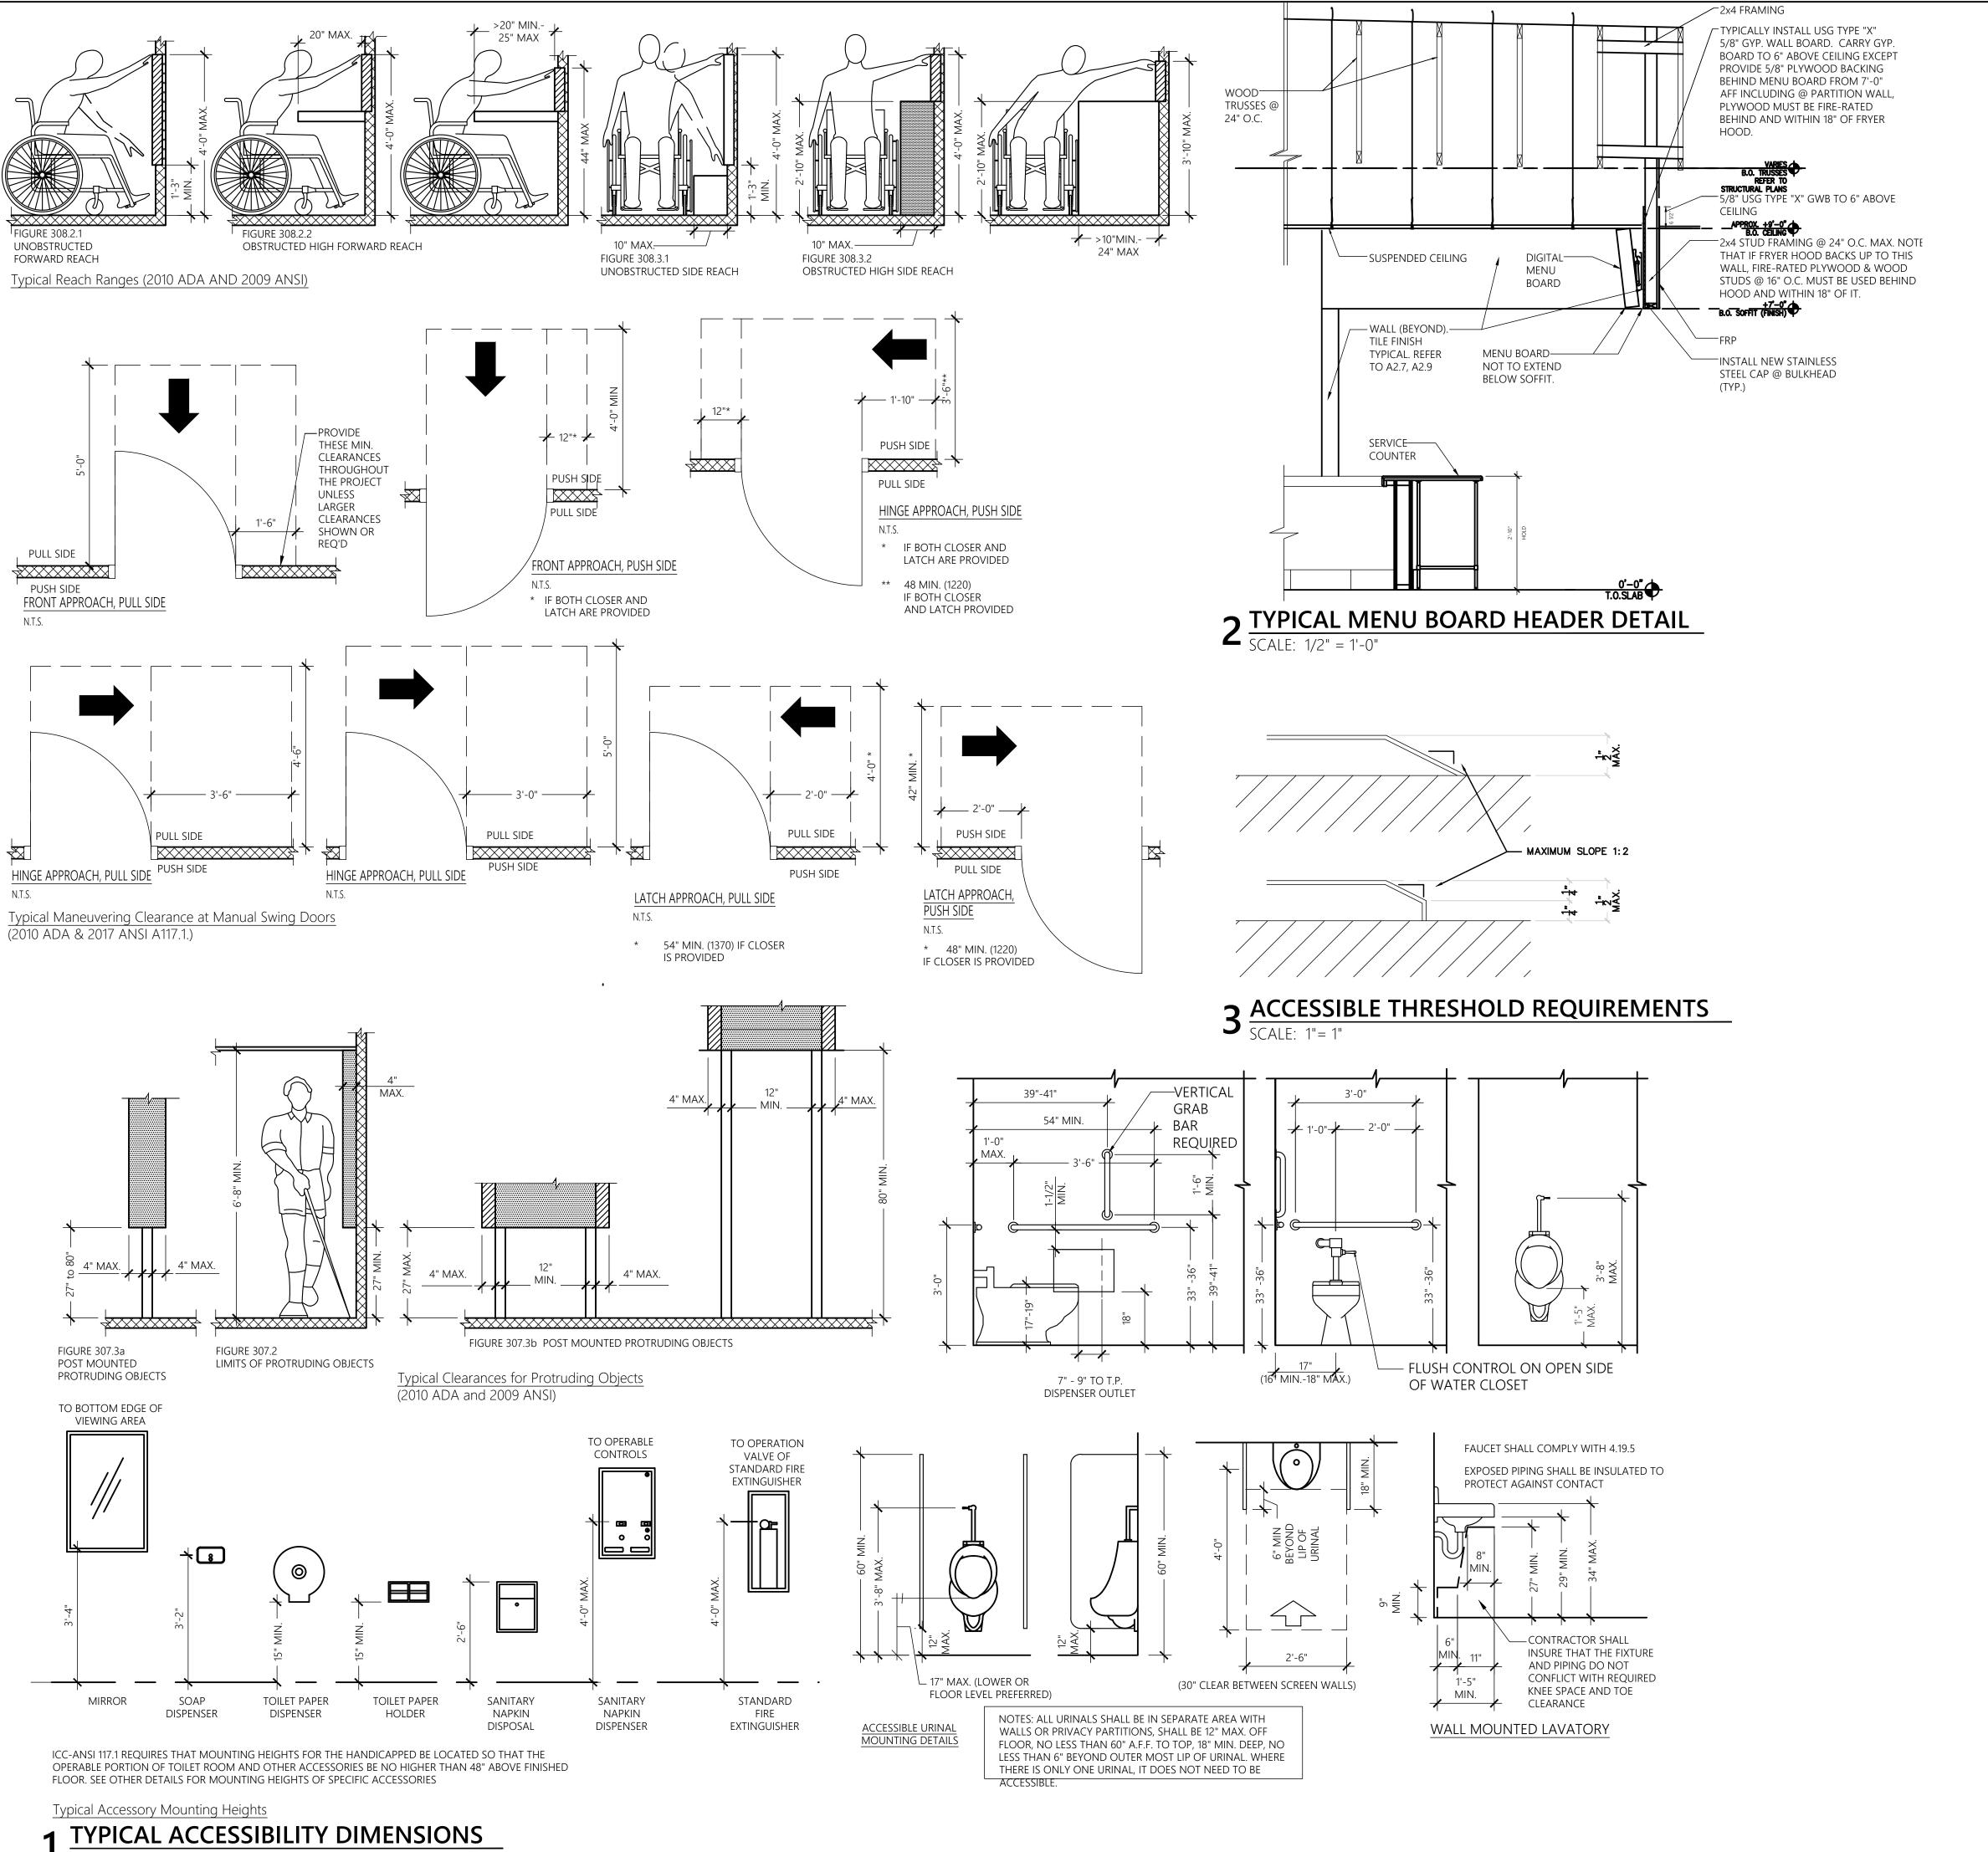REFER TO DECOR PLANS FOR COUNTER TOP DESIGN

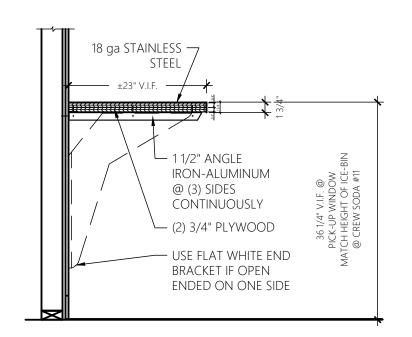

COUTNERS ADJACENT TO #11 CREW SODA MUST MATCH HEIGHT AND DEPTH OF ICE BIN 2. BLUNT SIDE EDGES OF STAINLESS STEEL WHERE BUTT TO WALL OR EQUIPMENT. IF OPEN EN, ROLL DOWN TO CAP 3. SCREW SECURELY TO STUDS OR ICE BIN AS REQUIRED

I. AT PICK-UP WINDOW,

5 COUNTER SECTION DETAIL
SCALE: 3/4" = 1'-0"

PERMIT DOCUMENTS

06-14-21

REV1: 1/12/22 REV2: 1/26/2022

ARCHITECT OF RECORD: Samantha Ciotti Falcone

AIA, LEED AP DRAWN BY: MSR OWNER OF RECORD: ABIII, LLC

#

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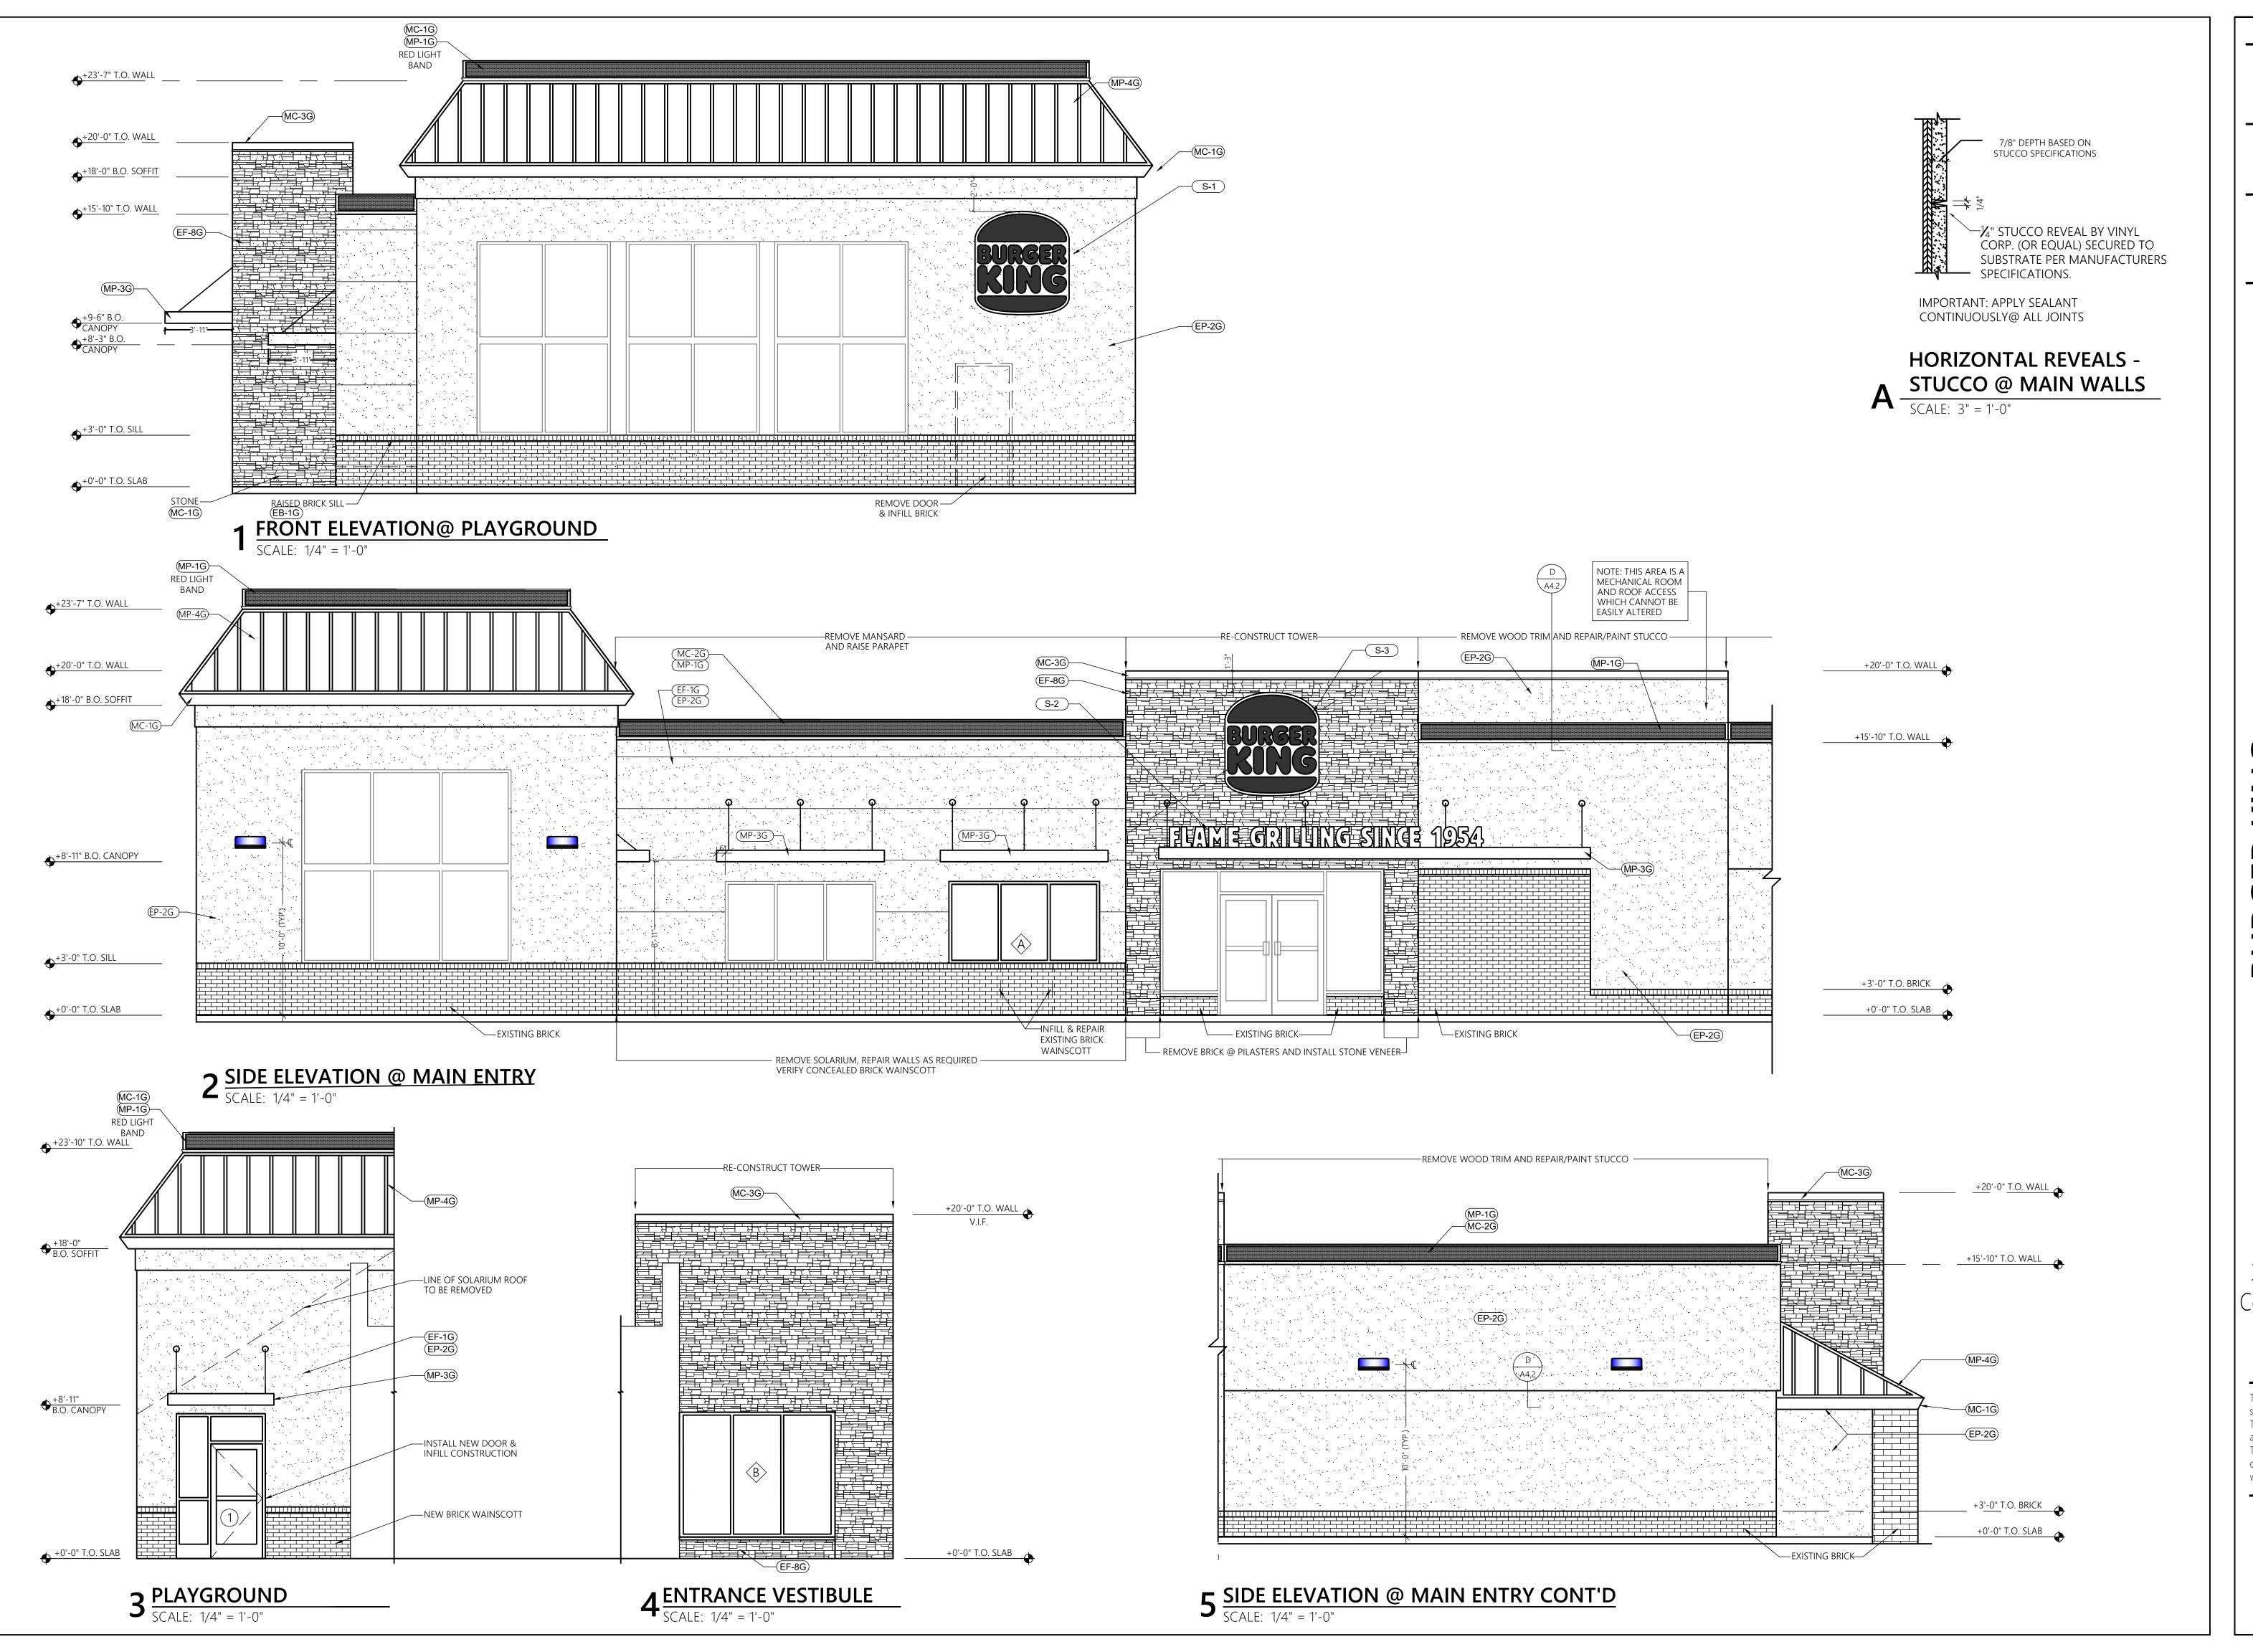
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ACCESSIBILITY

SCALE: N.T.S.



06-14-21 REV1: 1/12/22

> REV2 ARCHITECT OF RECORD: Samantha Ciotti Falcone

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ABIII, LLC


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ELEVATIONS



06-14-21

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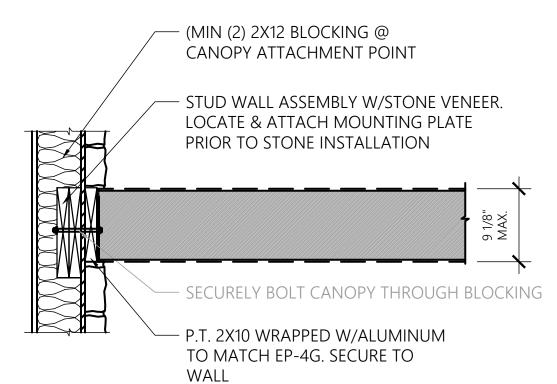
without the specific written consent of the Architect. **ELEVATIONS**

Δ32

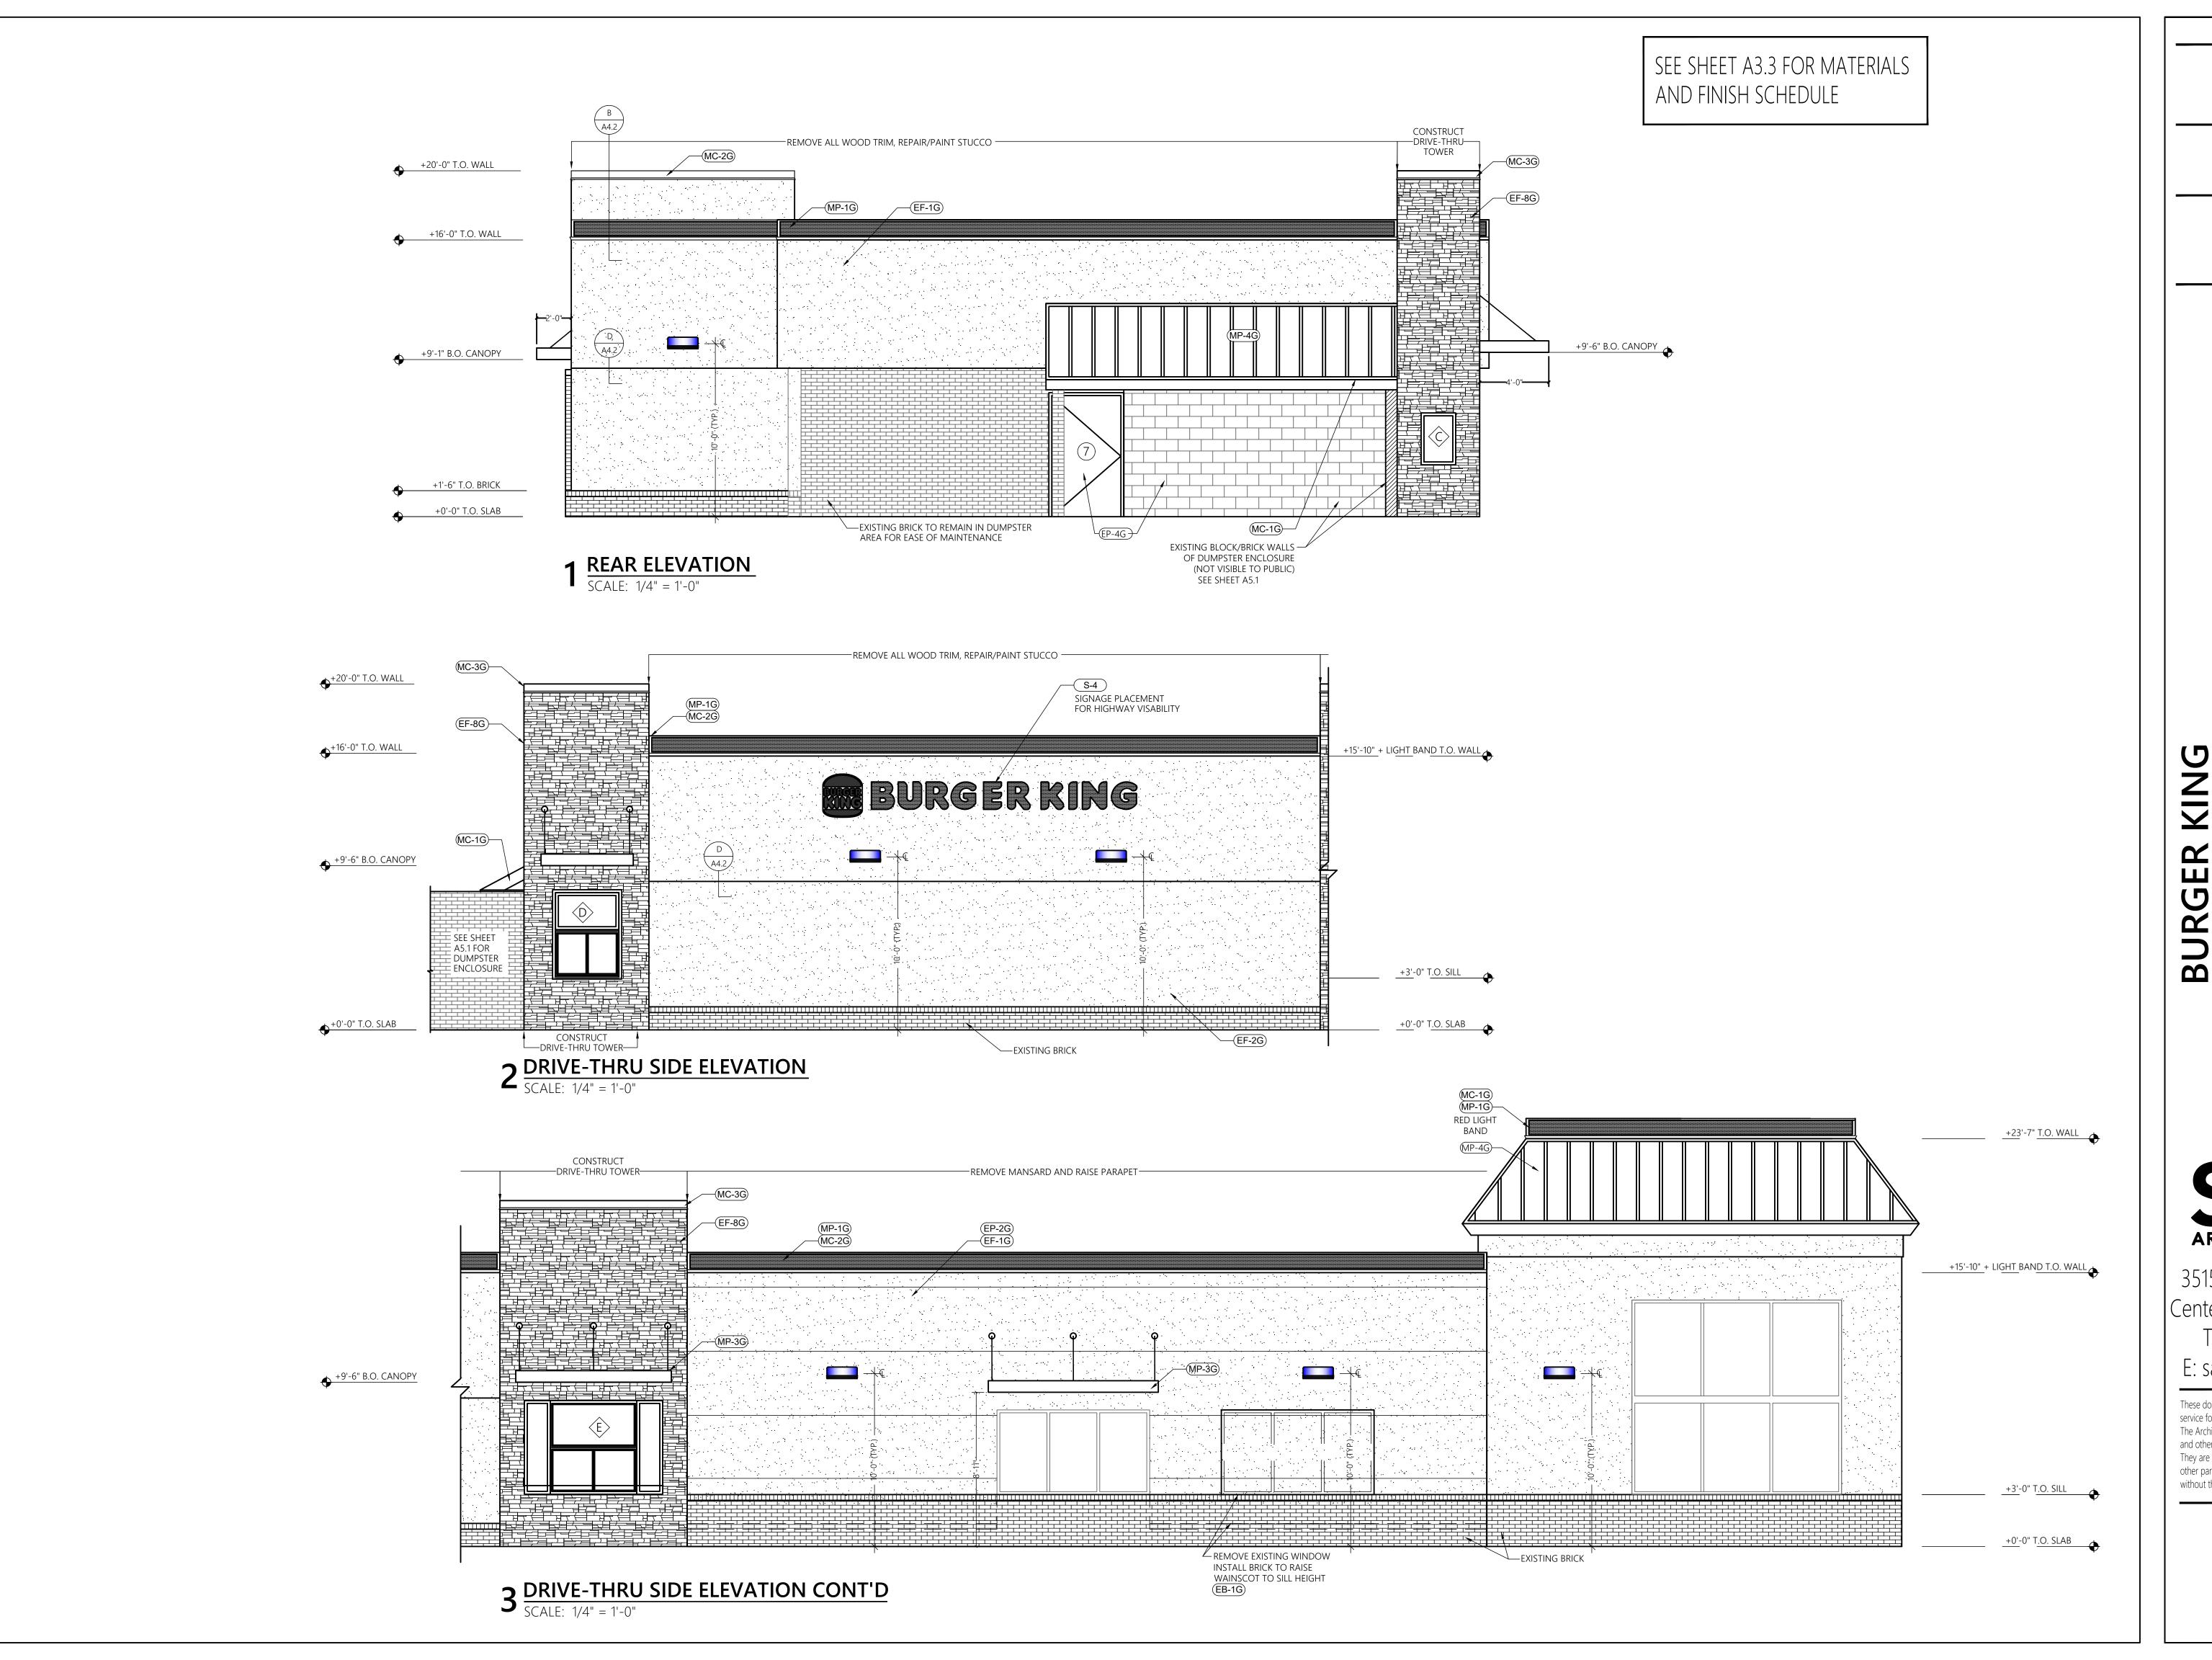EXTERIOR FINISH SCHEDULE

CODE	MATERIAL	LOCATION	MANUFACTURER	PRODUCT	SIZE	NOTES
EB-1G	BRICK	WAINSCOT	ANY	FACE BRICK TO MATCH		SAVE DEMO BRICK FOR RE-USE
				EXISTING		TO INFILL AT SMALLER
				FOR LARGER AREAS		OPENINGS
EF-1G	STUCCO	GENERAL	APPROVED STUCCO	COLOR TO MATCH		FOR NEW STUCCO WALL AREAS
		WALL	SYSTEM	EP-2G		PAINT EP-2G FOR COLOR
				"TAUPE TONE"		UNIFORMITY
EF-8G	STONE VENEER	TOWERS	ENVIRONMENTAL	LEDGESTONE		USE EGR-3G, MATCHING SILL
			STONE WORKS	(NOT SOUTHERN)		CAP AND FLAT WALL CAP
				"BUCKS COUNTY"		14" W X 1.75" TH X 48" L
						WHERE APPLICABLE
EGR-3G	GROUT	MASONRY	ANY	STANDARD BUFF		BLEND WITH EP-2G AND
						STONE
EP-2G	EXTERIOR	GENERAL	SHERWIN WILLIAMS	SW7633		PAINT ALL NEW AND EXISTING
	PAINT	WALL		"TAUPE TONE"		STUCCO WALLS
EP-4G	EXTERIOR	GENERAL	SHERWIN WILLIAMS	SW 7515		USE APPROPRIATE PAINT TYPE
	PAINT	ACCENT		"HOMESTEAD BROWN"		FOR SUBSTRATE
MC-1G	METAL COPING	TOWER	ANY	CONTRACTOR TO		MATCH SSM ROOF
		WALLS		MATCH MP-4G		
				SILVER METALLIC		
MC-2G	METAL COPING	PARAPET	ANY	CONTRACTOR TO		FOR STUCCO WALLS
		WALLS		MATCH EP-2G		
				"TAUPE TONE"		
MC-3G	METAL COPING	PARAPET	ANY	CONTRACTOR TO		FOR STONE WALLS
		WALLS		MATCH EP-4G		
				"HOMESTEAD BROWN"		
MP-1G	LIGHT BAND	PARAPET	LEKTRON	Bk-2020	15"	TOP MOUNT EXCEPT AT FRONT
			THROUGH	191-1016		ENTRY TOWER—SEE A2.3 AND
			ALLEN INDUSTRIES	LIGHT BAND 15" ROC		ELEVATIONS A3.1, A3.2
MP-3G	METAL CANOPY	GENERAL	ALLEN INDUSTRIES	CUSTOM PER BK SPECS,	VARY	CONTACT: ALAN BRYANT,
				REFER TO		ALLEN INDUSTRIES
				MANUFACTURER		1-800-967-2553
				PLANS FOR SPEC'S		IN-WALL BLOCKING REQUIRED

- 1. PAINTING CONTRACTOR SHALL BE RESPONSIBLE FOR FINAL PRIMER/PAINT CHOICE AND METHOD OF APPLICATION ACCORDING TO SUBSTRATE
- MASONRY/TILE CONTRACTOR SHALL BE RESPONSIBLE FOR FINAL GROUT CHOICE AND TYPE ACCORDING TO APPLICATION
- ALL MISC. EQUIPMENT (EXCEPT SIGN POLES) SUCH AS ELECTRICAL BOXES, GAS METER, DUMPSTER POLES, ETC. TO BE PAINTED EP-4G
- SIGN POLES AND CABINETS TO BE BLACK, EXCEPT ROUND LOGO CANS TO BE SILVER (IF APPLICABLE)
- ALL BOLLARDS EXCEPT THOSE IN DUMPSTER AREA TO BE CAPPED WITH STANDARD YELLOW BOLLARD COVER
- BK CORPORATE NOW REQUIRES BLACK CONCRETE IN DRIVE THRU LANE DRIVE SURFACE. REFER TO SITE PLANS FOR DETAILS.
- SUBSTITUTIONS TO SPECIFIED PRODUCTS REQUIRE SAMPLE SUBMISSION AND PRIOR APPROVAL
- NOT ALL MATERIALS WILL BE USED ON EVERY PROJECT



5 CANOPY MOUNTING PLATE @ STONE SCALE: 1" = 1'-0"

CANOPY NOTES

- 1. CANOPIES ARE SHIPPED WITH BULK OF ASSEMBLY COMPLETED.
- 2. ALL CANOPIES ARE LIGHTED. LIGHTING IS SUPPLIED WITH CANOPY AND INSTALLED ON-SITE. REFER TO SIGN PACKAGE (ALLEN INDUSTRIES) AND ELECTRICAL PLANS.
 - BLOCKING (MIN. 2-2X12) FOR CANOPIES DOES NOT HAVE TO BE CONTINUOUS BUT MUST BE INSTALLED IN OPEN FRAMING AT BOTH CANOPY AND CANOPY SUPPORTS AT PROPER HEIGHT AND ATTACHMENT LOCATIONS. IT IS BEST IF CANOPIES ARE AVAILABLE TO VERIFY ATTACHMENT, BUT ATTACHMENT POINTS MAY BE DETERMINED IN ACCORDANCE TO GUIDELINES ON THE SPECIFICATIONS ABOVE, ACCORDING TO THE LENGTH OF EACH CANOPY. ACTUAL CONSTRUCTION MAY VARY BETWEEN MANUFACTURERS.

PERMIT DOCUMENTS

06-14-21

Samantha Ciotti Falcone

BURGE





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> **EXTERIOR FINISHES**





CANOPIES PER APPROVED SUPPLIER. PROVIDE BLOCKING AS REQUIRED PER LOCAL CODES. COORDINATE LOCATION WITH MANUFACTURERS, APPLY SEALANT BEHIND CANOPY AT WALL
TO PREVENT LEAKS
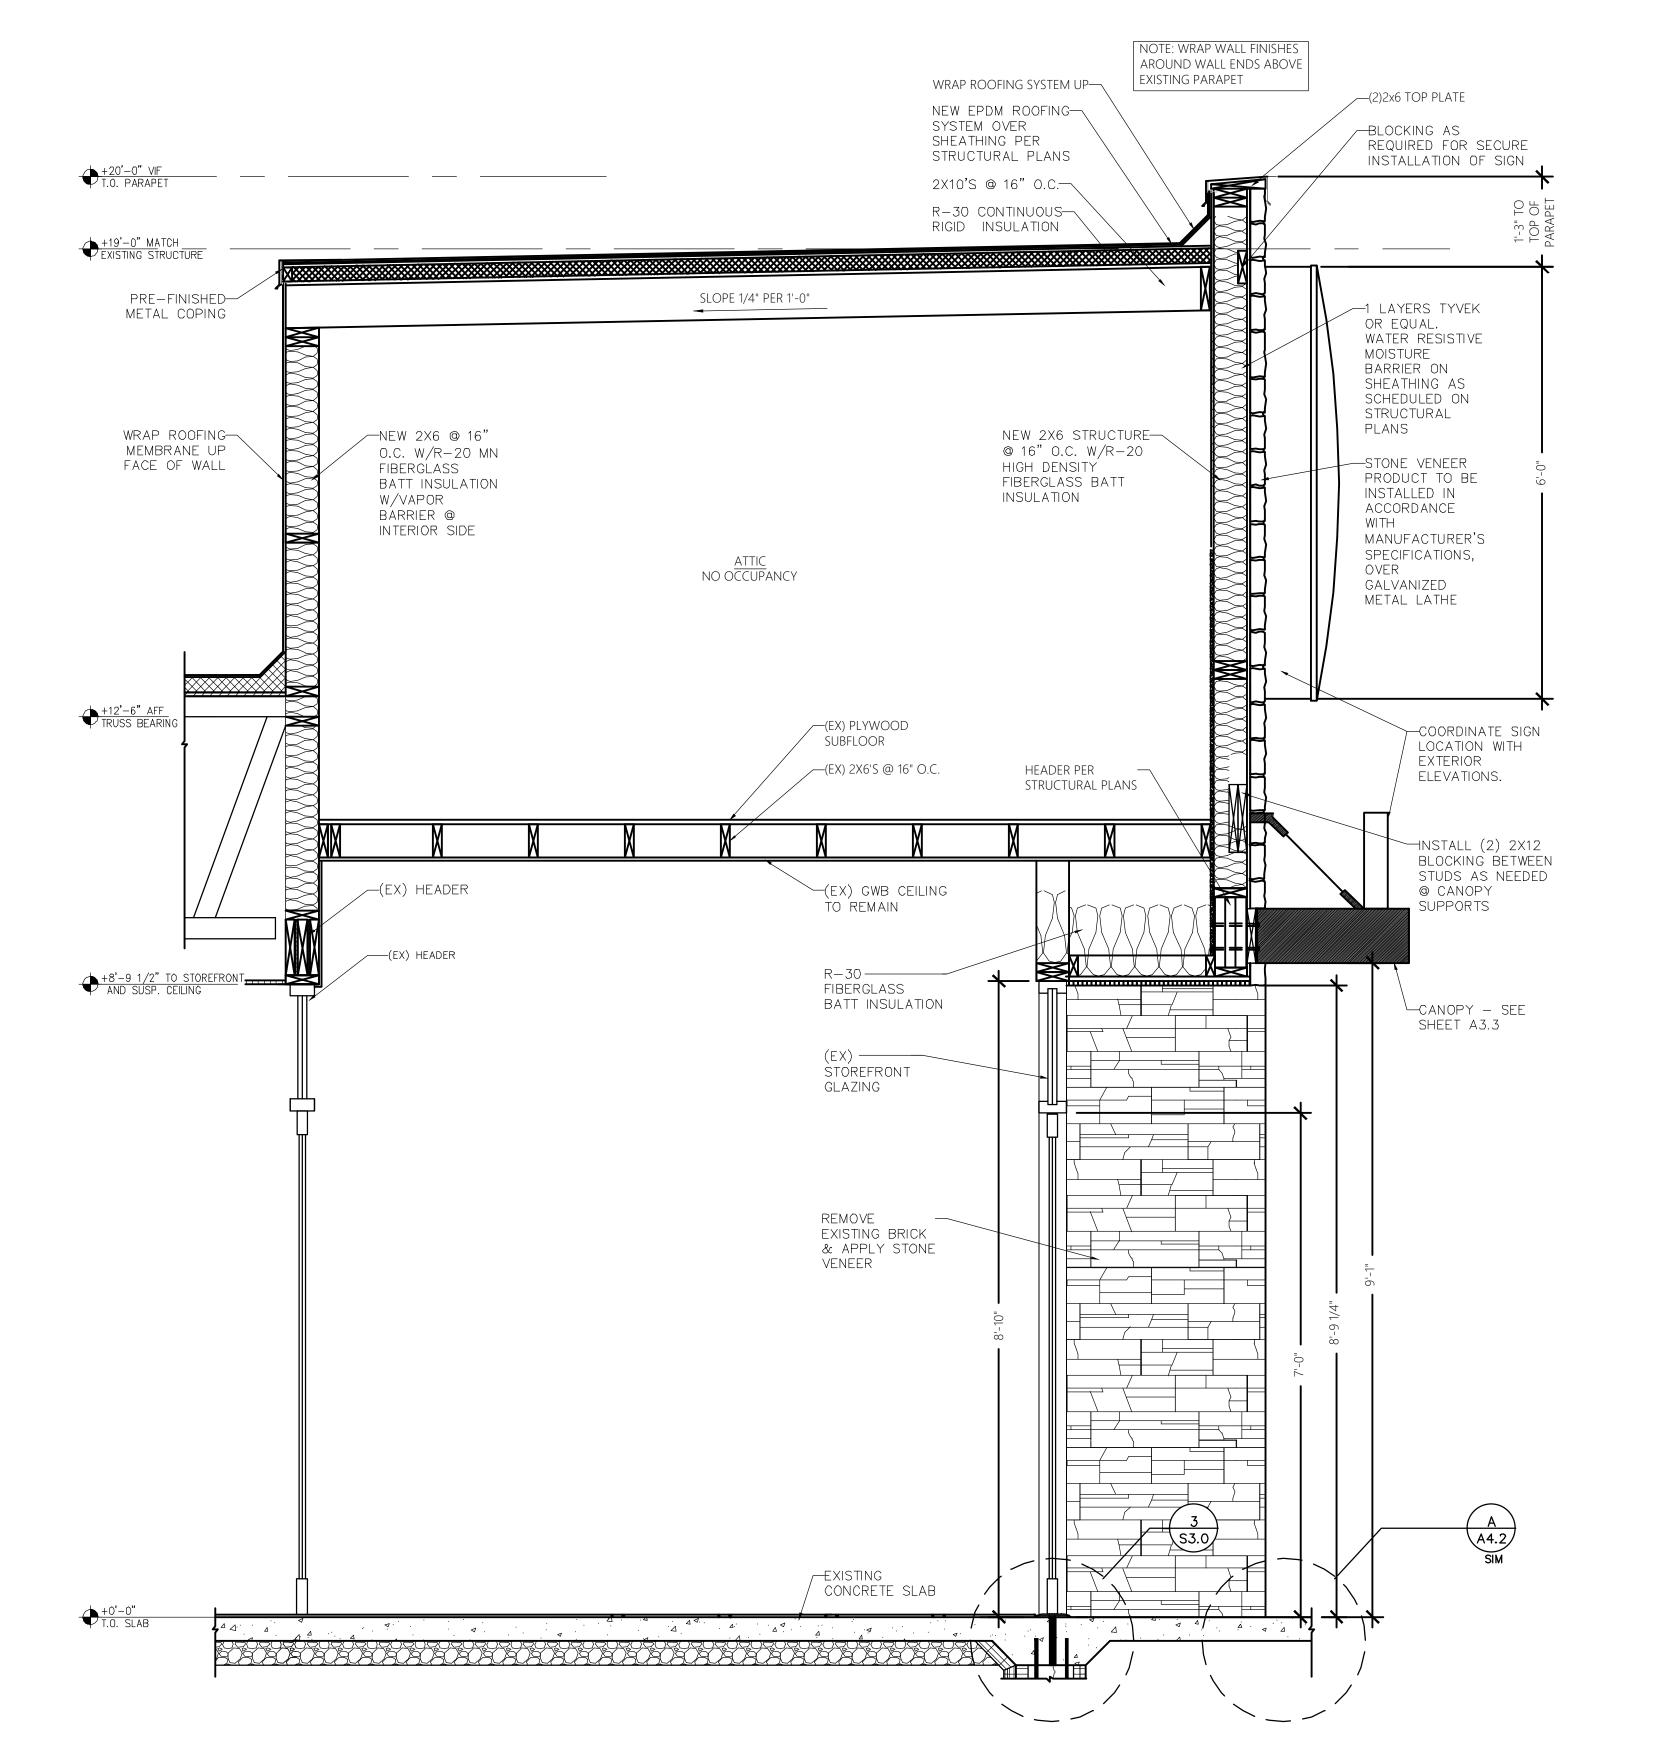
> WINDOW NOTES
>
> (TYPICAL FOR ALL WINDOWS):
>
> 1. SHIM AS REQUIRED, PACK VOIDS WITH INSULATION 2. APPLY SEALANT WITH BACKER ROD AT 2. APPLY SEALANT WITH BACKER ROD AT ALL PERIMETER EDGES
> 3. RETURN ALL INTERIOR AND EXTERIOR FINISHES TO WINDOW FRAME
> 4. PROVIDE CONTINUOUS EXT. ALUMINUM HEAD AND SILL FLASHING, INSTALL IN ACCORDANCE WITH WINDOW MANUFACTURERS RECOMMENDATION

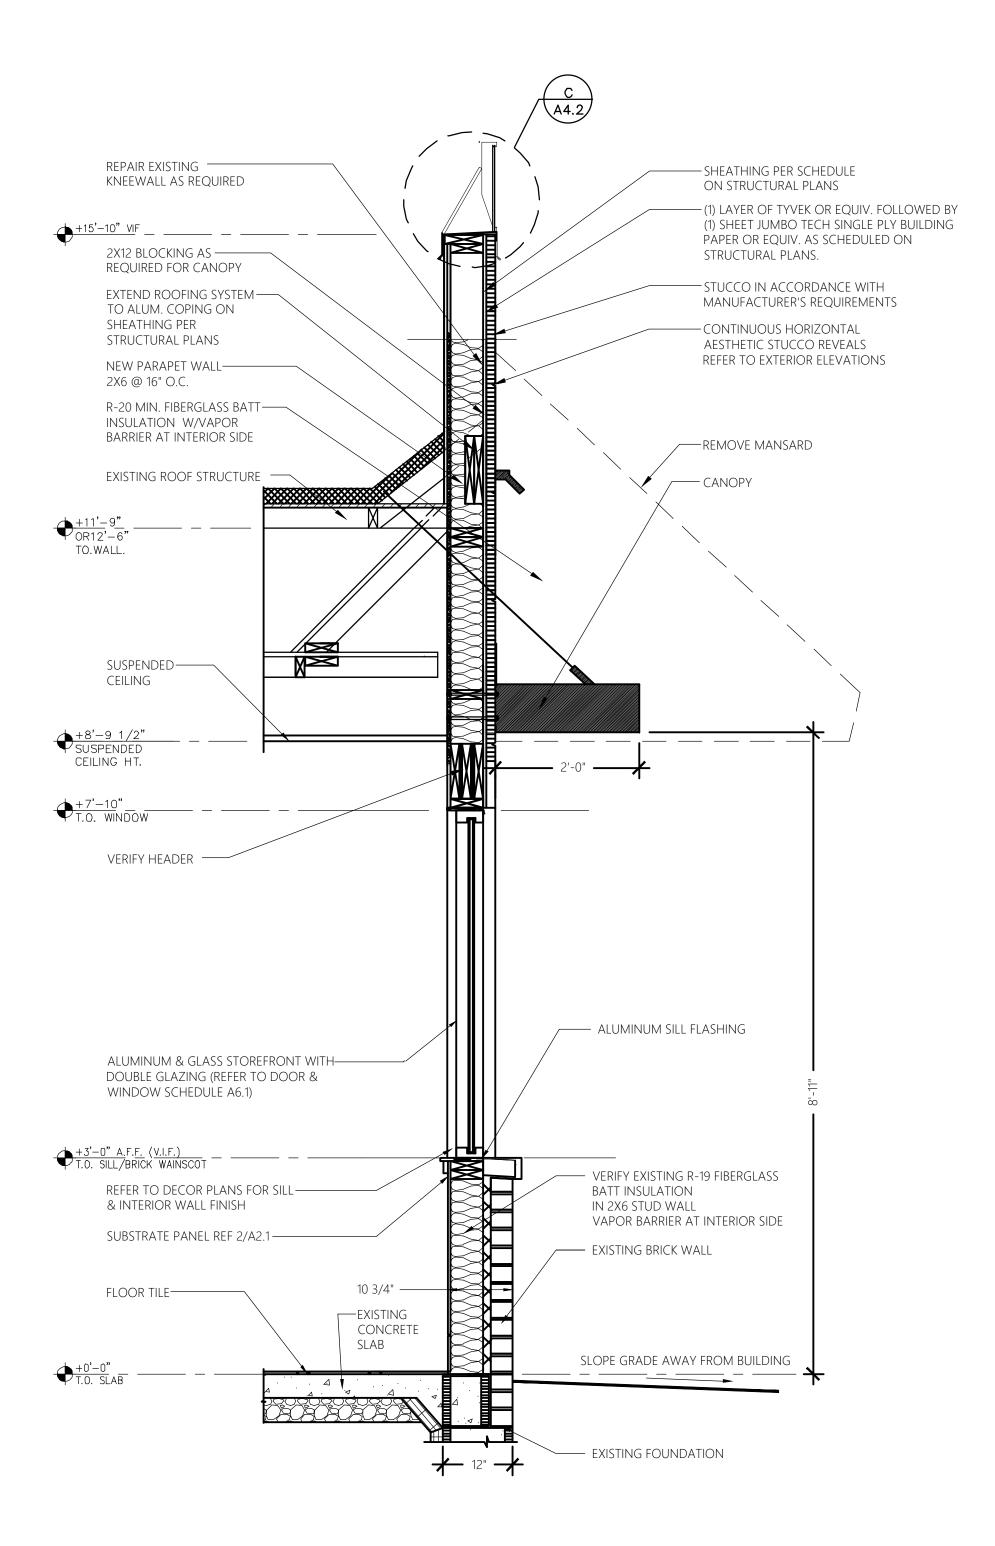TYPICAL ALL SECTIONS:

1. PROVIDE R-20 MINIMUM INSULATION
FROM FLOOR TO ROOF DECK IN ALL EXTERIOR WALLS.

- 2. PROVIDE GYPSUM WALL BOARD SUBSTRATE FROM FLOOR TO ROOF DECK AT ALL WALLS WITH EXPOSED
- ROOF TRUSSES.

 REFER TO INTERIOR DECOR
 PACKAGE FOR FINISH SCHEDULE REFER TO EXTERIOR DECOR SCHEDULE FOR ALL EXTERIOR FINISHES SHEET A3.3.
 G.C. TO VERIFY ALL STRUCTURAL DETAILS WITH STRUCTURAL
- ENGINEERS PLAN SHEET & TRUSS MFGR'S SHOP DRAWINGS. G.C. TO EVALUATE SITE CONDITIONS AND ADJUST CONSTRUCTION
- METHODS AS REQUIRED. . EXISTING CEILING HEIGHT MAY VARY (SLOPE) IN DINING ROOM AND KITCHEN G.C. TO ESTABLISH UNIFORM CEILING HEIGHT FROM 8'-10" TO 9'-0" IN EACH SPACE PER EXISTING CONDITIONS.
- 8. G.C. TO VERIFY ALL NEW & EXISTING FOOTING DEPTHS TO 36" MIN. BELOW GRADE.

TO EXI End Bo PA 18 nship, BURGE

3oulevard 18951 p, Bucks

PERMIT DOCUMENTS

REV2 1/26/2022

Samantha Ciotti Falcone

ARCHITECT OF RECORD:

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OWNER OF RECORD:

ABIII, LLC

ARCHITECTURE LLC


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> WALL **SECTIONS**

2 DINING ROOM SIDE WALL
SCALE: 3/4" = 1'-0"



06-14-21

REV1 1/12/2022 REV2 1/26/2022

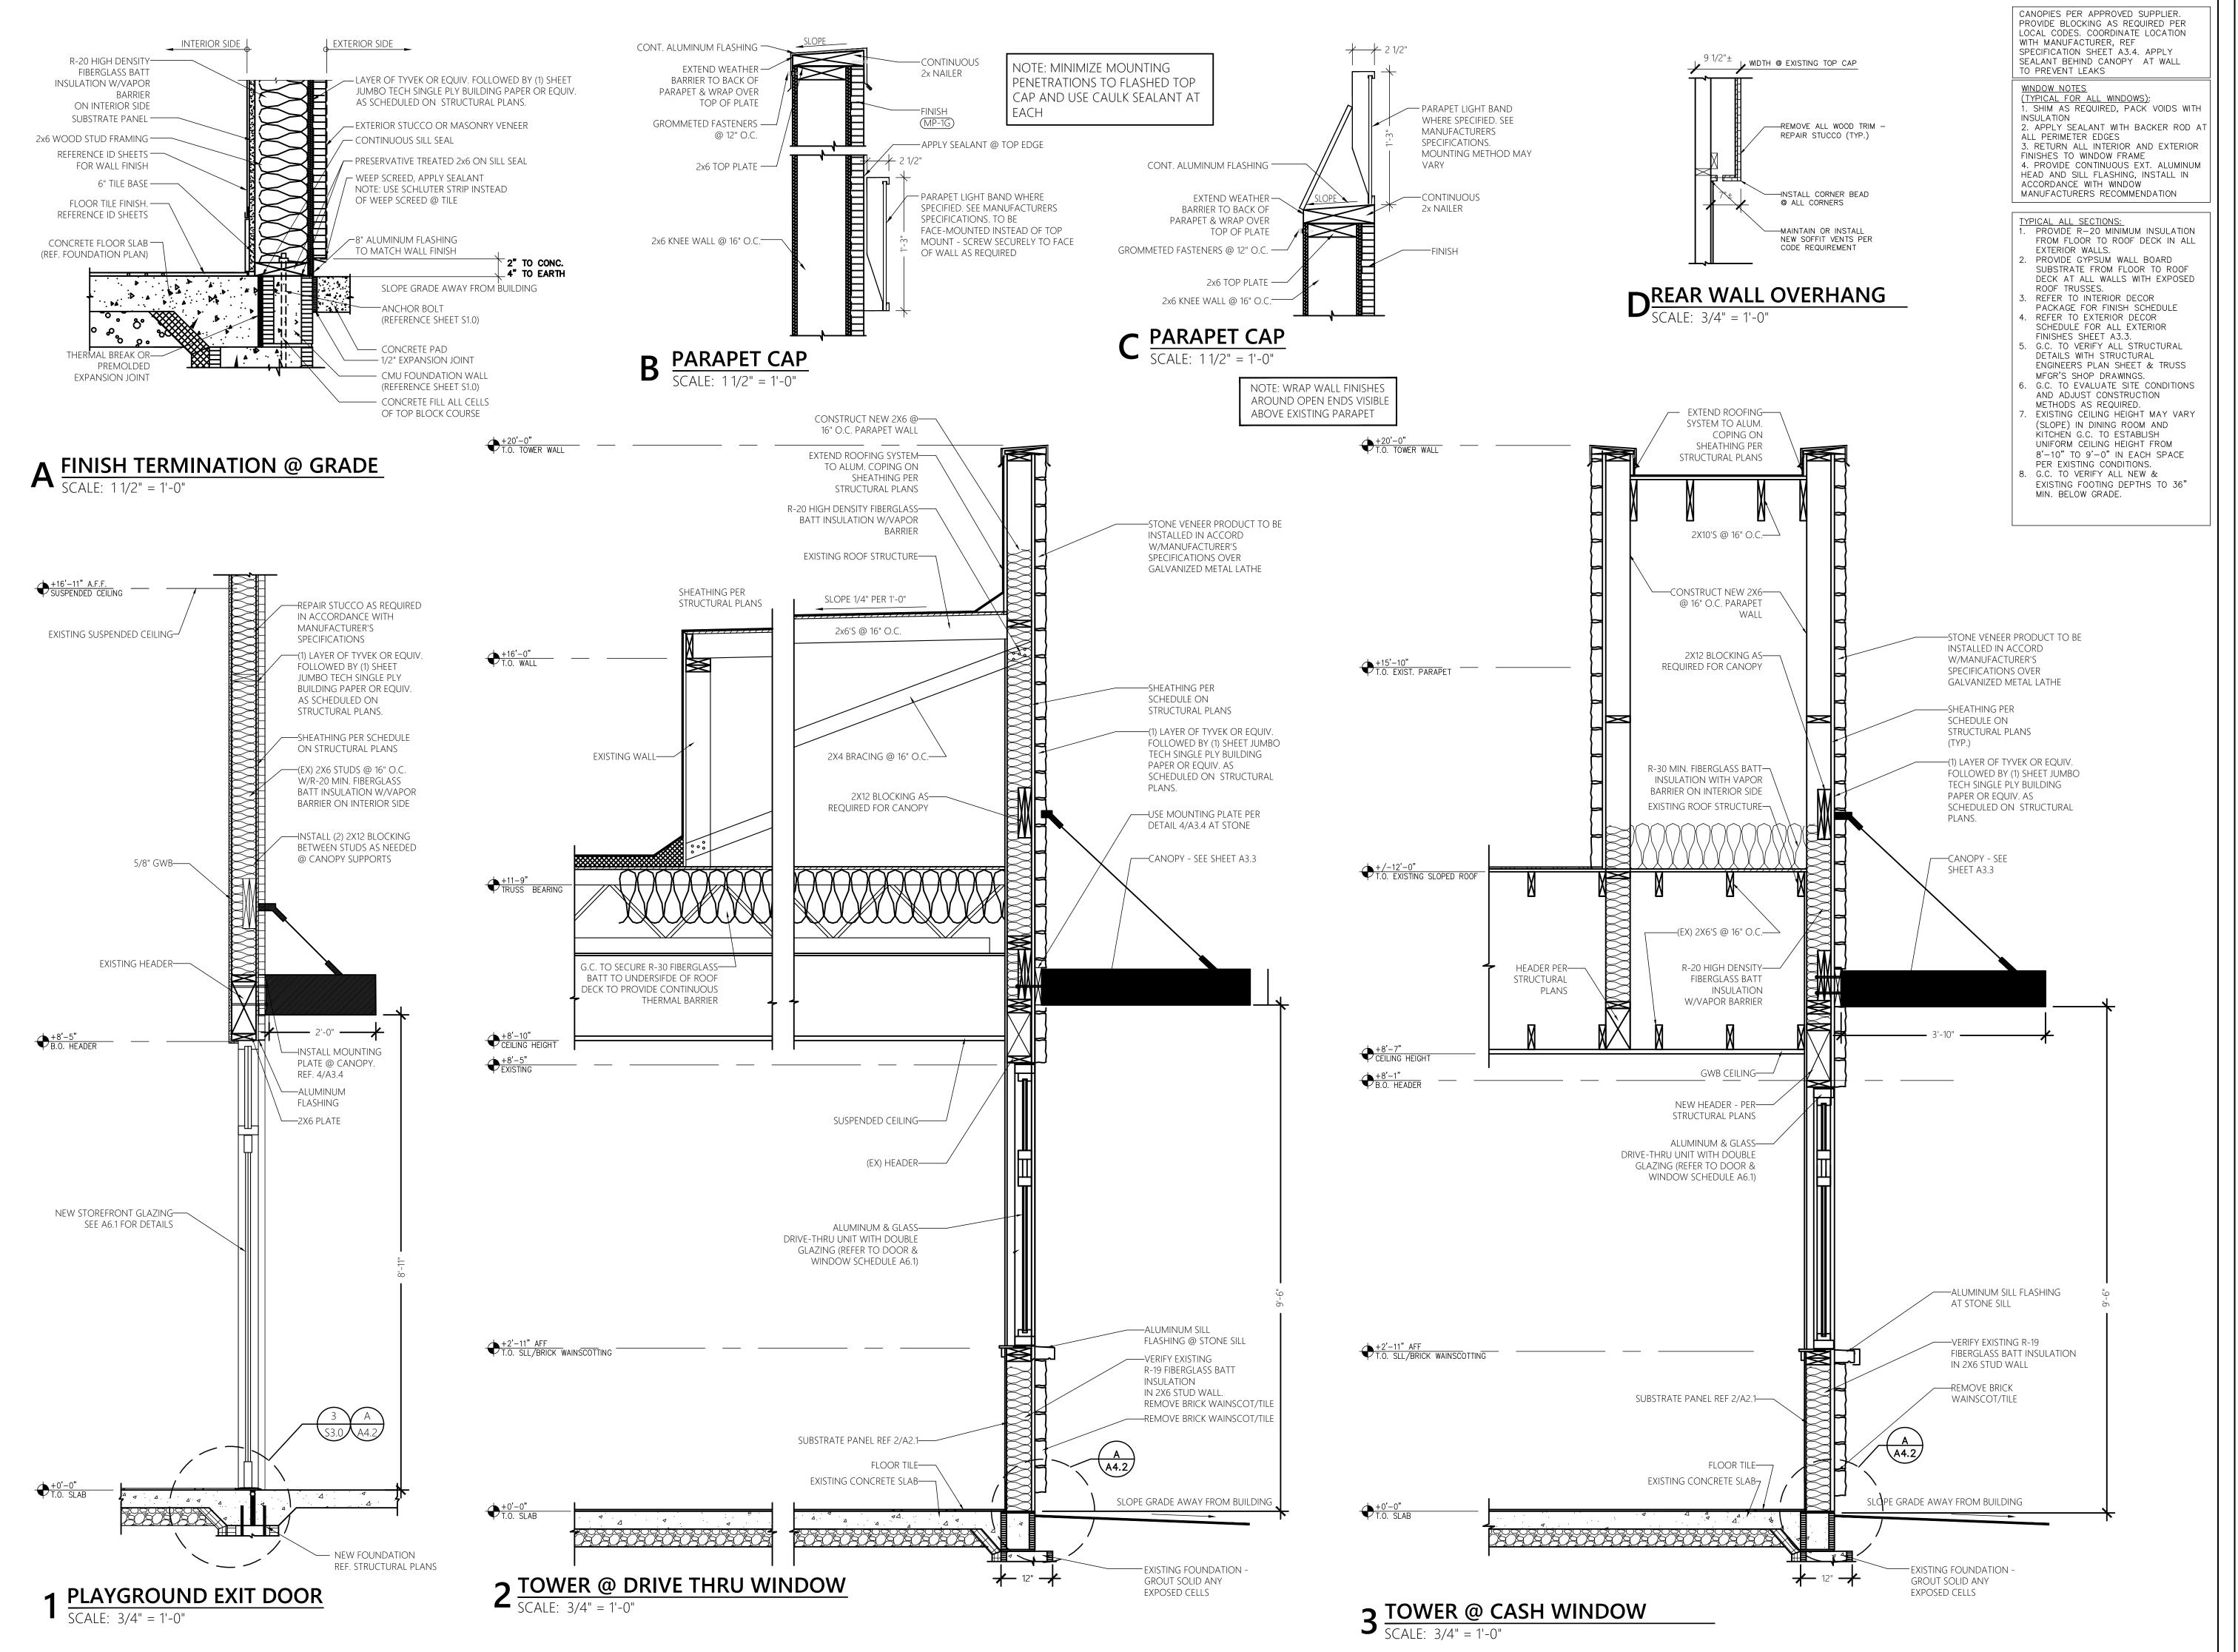ARCHITECT OF RECORD: Samantha Ciotti Falcone AIA, LEED AP DRAWN BY: MSR

OWNER OF RECORD: ABIII, LLC

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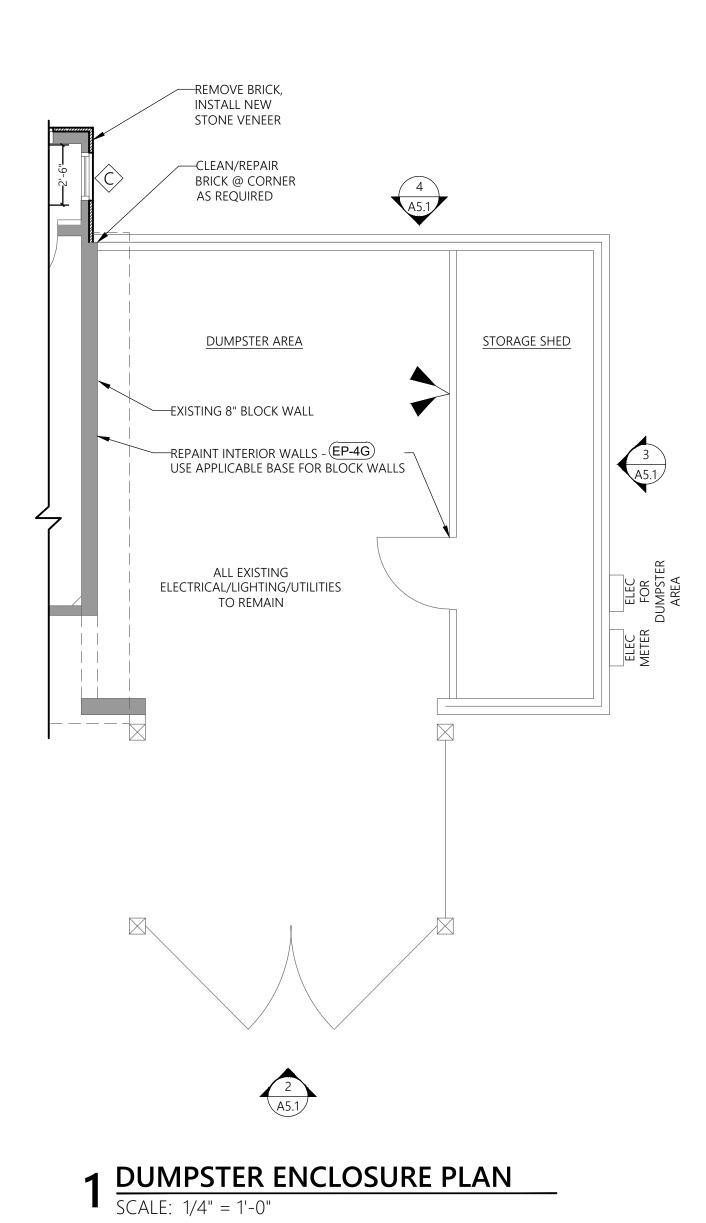
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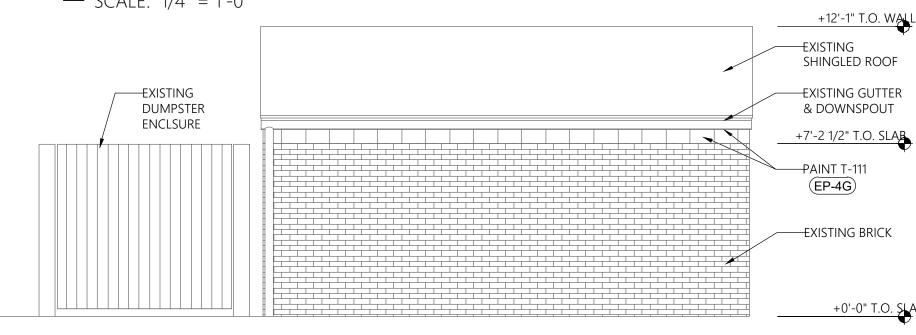
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> WALL **SECTIONS**




+12'-1" T.O. WALL EXISTING SHINGLED ROOF —PAINT T-111 EP-4G EXISTING DUMPSTER
GATES TO REMAIN +7'-2 1/2" T.O. SLAB —EXISTING BRICK +0'-0" T.O. SLAB


2 DUMPSTER ENCLOSURE - SIDE ELEVATION SCALE: 1/4" = 1'-0"



3 DUMPSTER ENCLOSURE - REAR ELEVATION SCALE: 1/4" = 1'-0"

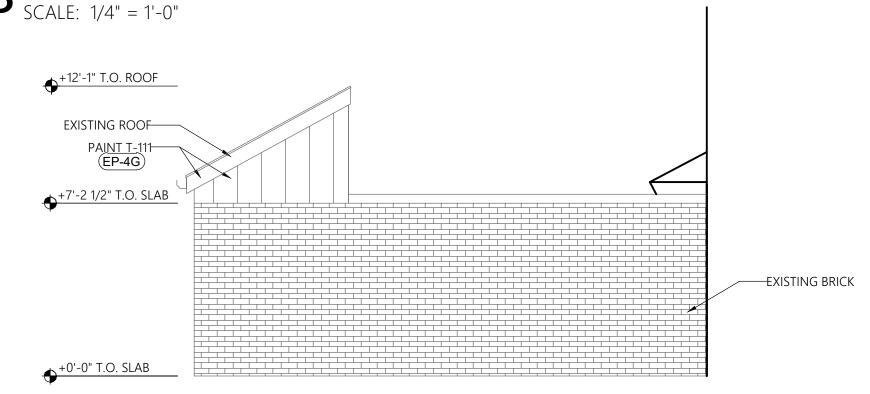

4 DUMPSTER ENCLOSURE - DRIVE- THROUGH ELEVATION SCALE: 1/4" = 1'-0"

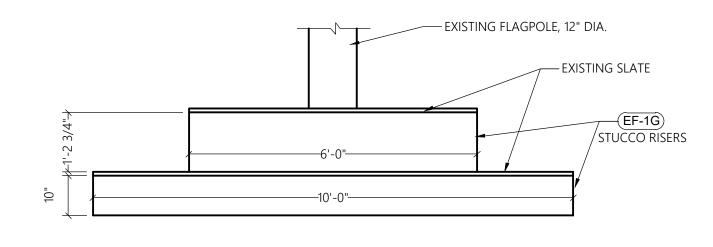

5 FLAG POLE BASE
SCALE: 1/2" = 1'-0"

06-14-21

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ARCHITECT OF RECORD: Samantha Ciotti Falcone AIA, LEED AP

DRAWN BY: MSR OWNER OF RECORD:




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> **DUMPSTER ENCLOSURE**



NOTES:

G.C. TO CUSTOMIZE FRAME ORDER AS REQUIRED FOR EXISTING WALLS/FIELD CONDITIONS

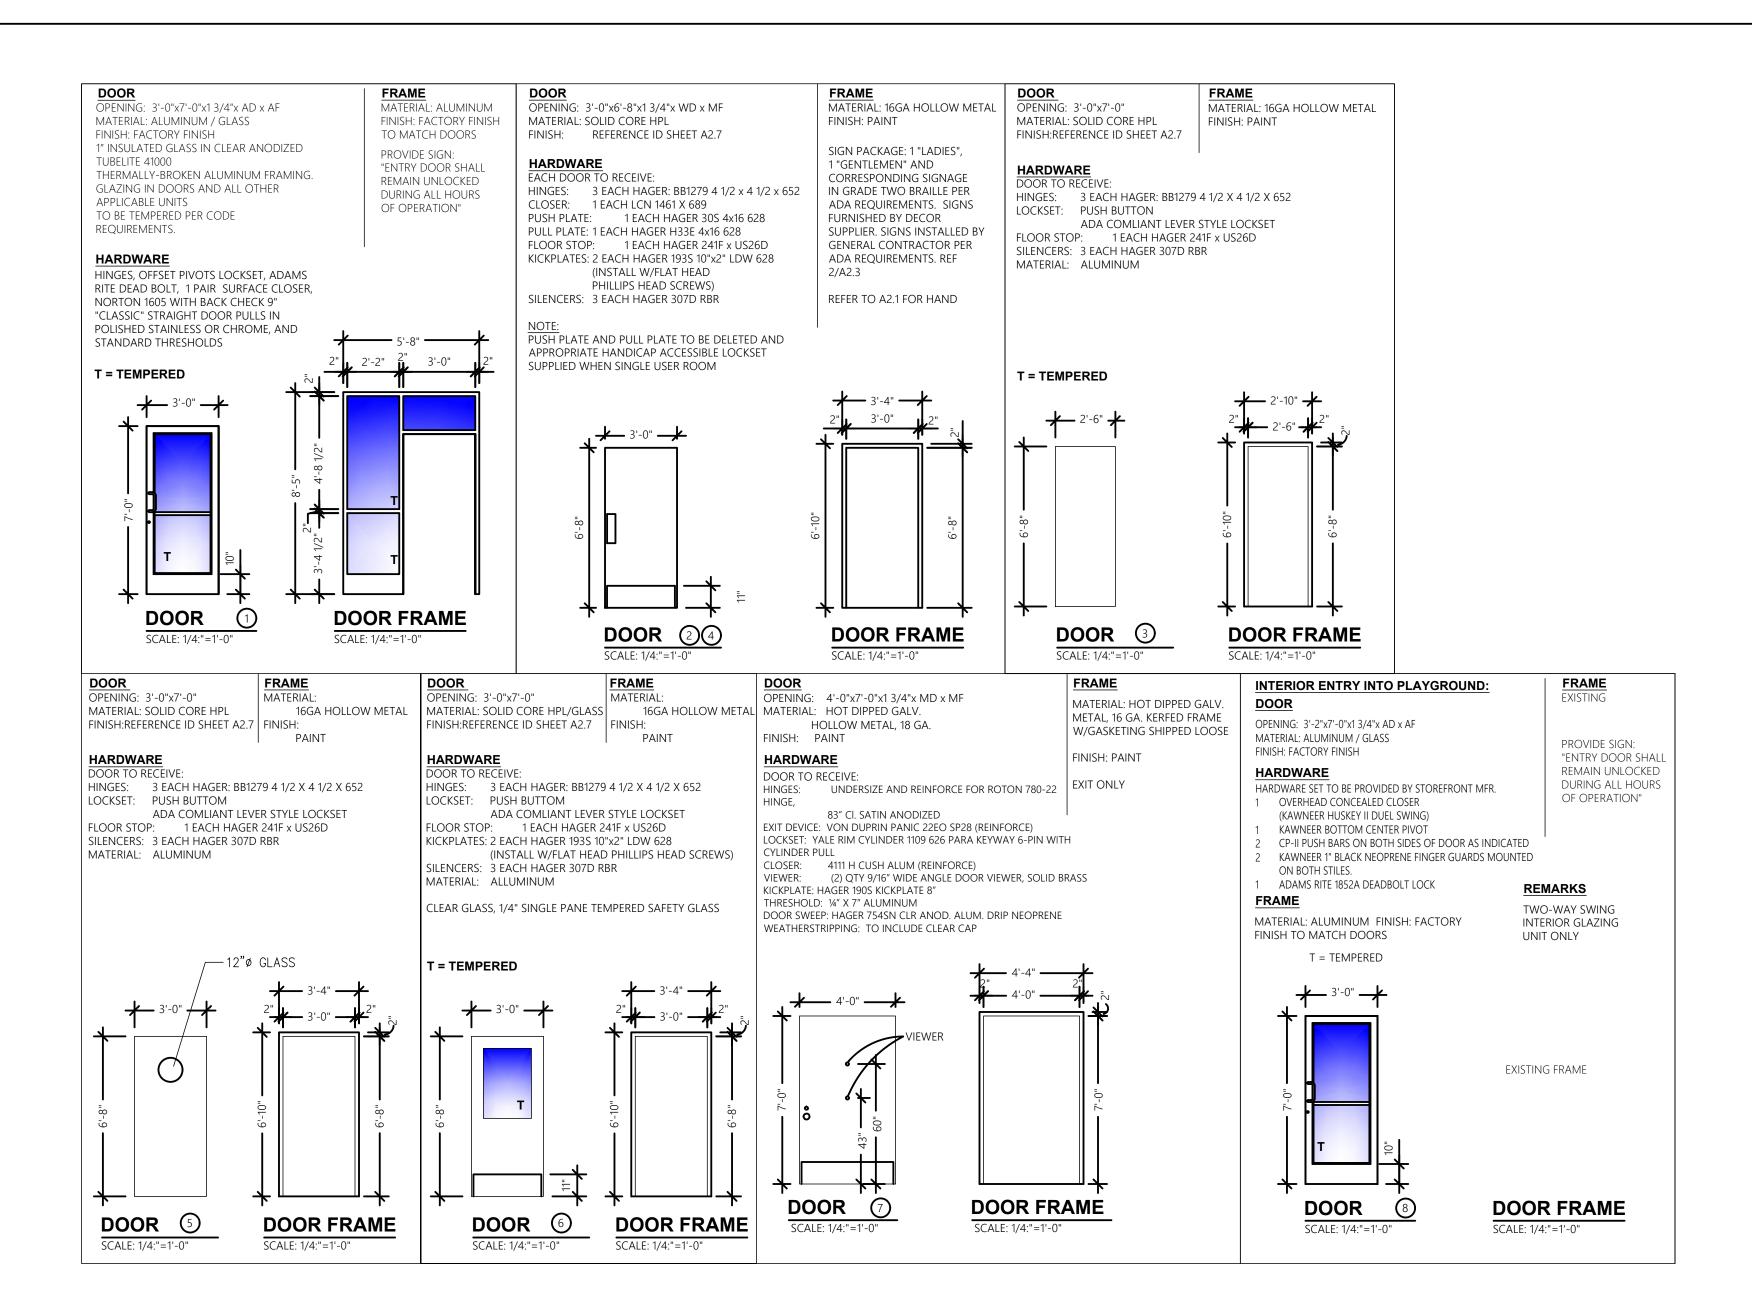
ALL STOREFRONT GLAZING TO BE BRONZED ALUMINUM FRAMES AND HARDWARE TO MATCH EXISTING UNITS - NOT AS SHOWN


ALL WINDOWS WITHIN 24" OF VERTICAL EDGE OF DOOR SHALL BE TEMPERED GLASS


DRIVE-THRU WINDOWS:

SELF-CLOSING WINDOW TO BE SUPPLIED BY GC W/SEPARATE TRANSOM TO MATCH STOREFRONT GLAZING. SEE WINDOWS "H" AND "J" BELOW. QUIK-SERVE UNIT IFSC-4030C WITH HANDING AS INDICATED, 4'-0" W X

UNIT TO HAVE 5/8" INSULATED CLEAR GLASS, BRONZED ALUMINUM

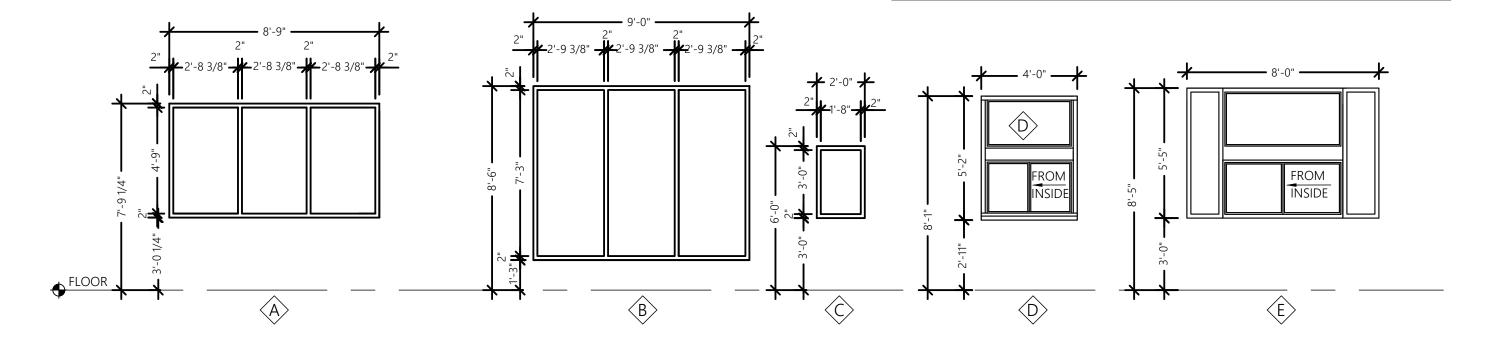

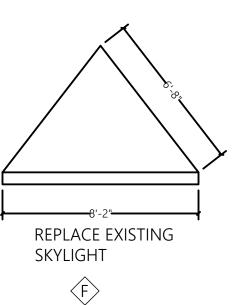

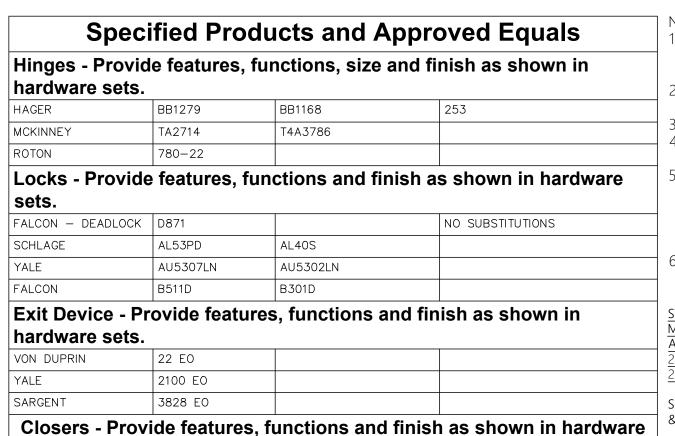

Push/Pull, KP, Stops, Etc. - Provide features, functins, size and finish as shown in hardware sets.

8916 DST / 8956 DST

4115 H-CUSH 4425T / 4421T

- 1							
	HAGER	KICKPLT 190S	PULL PLT H33G	PUSH PL 30S	FL STOP 243F	WALL STOP 236W	VIEWER 1756
	ROCKWOOD	K1050 B3E	BF106 X 70C	70C	441CU	409	622
	TRIMCO	K0050	1017-3x2 ½ PROJ.	1001-3	1211	1270WV	976U

Weatherstripping, Thresholds, Etc. - provide features, functions, size and finish as shown in hardware sets

and misi as	SHOWH III Haruv	vaie sels.	
NATIONAL GUARD	THRESHOLD 325A	SWEEP 200NA	WEATHERSTRIP 160SA
РЕМКО	229A	315CN	303AS
ZERO	1675A	39A	99A

CONTRACTOR IS RESPONSIBLE FOR VERIFYING ALL DIMENSIONS, HARDWARE AND THE DIRECTION OF SWING FOR EACH DOOR BEFORE ORDERING THE DOORS & WINDOWS. ALL ENTRY DOORS SHALL BE KEPT UNLOCKED DURING HOURS

OF OPERATION. ALL OPERABLE HARDWARE TO BE MOUNTED 34"-48" A.F.F. G.C. TO PROVIDE WALL OR FLOOR STOPS APPROPRIATE

FOR DOOR LOCATION CONSULT LOCAL INSPECTOR REGARDING REQUIRED DOOR SIGNAGE. IF REQUIRED, SIGN LETTERING SHALL BE 1" HIGH ON CONTRASTING BACKGROUND, ON EGRESS SIDE OR ADJACENT TO DOOR STATING "THIS DOOR TO REMAIN UNLOCKED

WHEN BUILDING IS OCCUPIED." CONSULT OWNER REGARDING SUPPLY AND KEYING OF

STOREFRONT UNITS TO FALL WITHIN THE MINIMUMS AND MAXIMUMS AS LAID OUT BY THE

5 INTERNATIONAL BUILDING CODE AND 015 INTERNATIONAL EXISTING BUILDING CODE

SEE CHART BELOW FOR MAX. U-FACTOR, MAX.SHGC, & MAX.AIR LEAKAGE


		5 ENVELOPE FENESTRATION ACTOR AND SHGC REQUIRE	
_	IVIANIIVIUIVI U-FF	ACTOR AND SHIEL REQUIRE	IVILIVI
	CLIMATE ZONE	4	
_	U-FACTOR		
	FIXED FENESTRATION	0.38	
	OPERABLE FENESTRATION	0.45	
	ENTRANCE DOORS	0.77	•

Sł	HGC	
ORIENTATION	S-E-W	N
PF < 2	0.4	0.53
0.2 <pf<0.5< th=""><th>0.48</th><th>0.58</th></pf<0.5<>	0.48	0.58
PF> 0.5	0.64	0.64

DRIVE-THRU WINDOWS:

SELF-CLOSING WINDOW TO BE SUPPLIED BY GC WITH SEPARATE TRANSOM TO MATCH STOREFRONT GLAZING. SEE WINDOWS "H" AND "J" QUIK-SERVE UNIT IFSC-4030C WITH HANDING AS INDICATED, 4'-0" W X 3'-0"

UNIT TO HAVE 5/8" INSULATED CLEAR GLASS, CLEAR ALUMINUM FRAME.

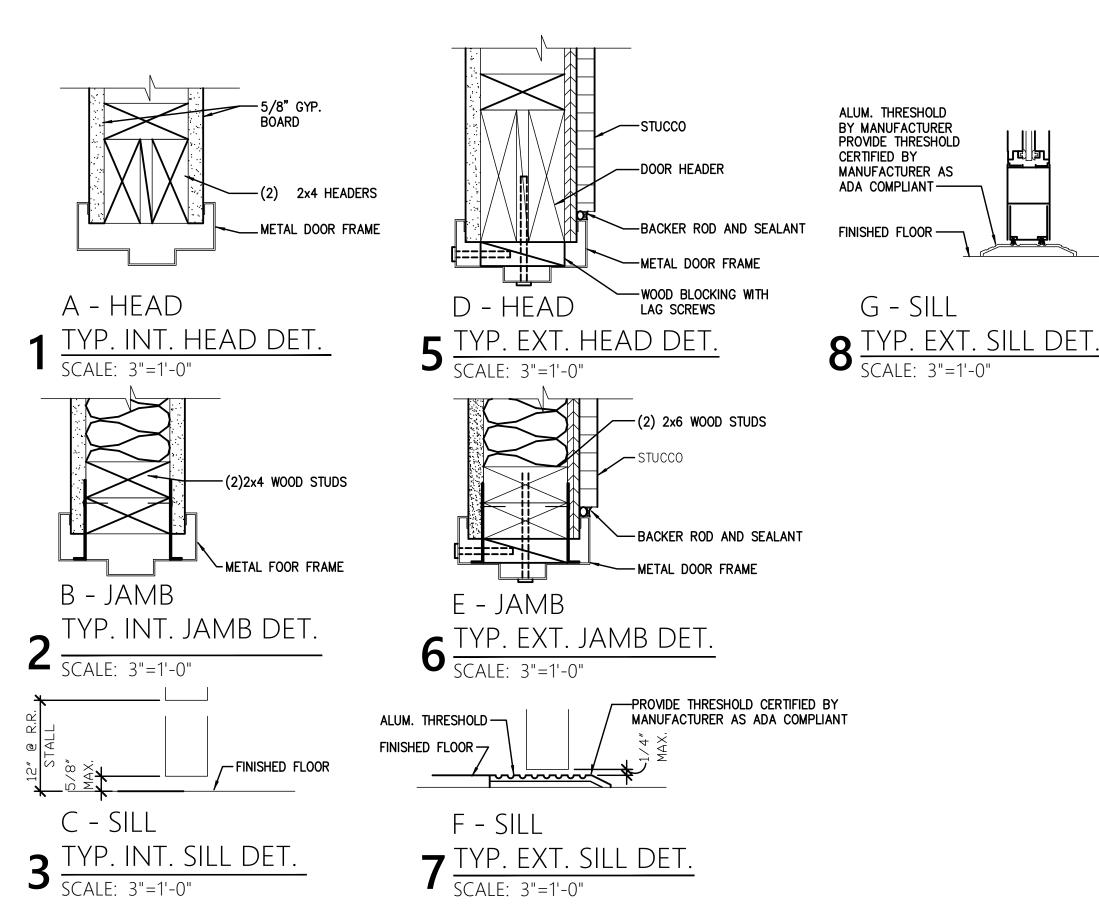

PERMIT DOCUMENTS

ARCHITECT OF RECORD:

Samantha Ciotti Falcone

DRAWN BY: MSR OWNER OF RECORD

BURGE


ARCHITECTURE

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DOOR & **WINDOWS**



<u>KEY</u>		KEY - CONTINUED		KEY - CONTINUED		KEY - CONTINUED	KEY - CONTINUED		
SYMBOL	DESCRIPTION	SYMBOL		SYMBOL	DESCRIPTION	SYMBOL	DESCRIPTION		
A —	SINGLE PENDANT. COORDINATE LOCATION AND QUANTITY WITH DECOR PLAN. BOTTOM OF FIXTURE @ 6'-6" A.F.F. NOTE: TABLES ARE FIXED	F	2x4 RECESSED LED (NIGHT LIGHT WHEN SHOWN HATCHED)	N 🗆	WALL MOUNTED SECURITY LIGHT		EMERGENCY LIGHT		
B ☆	SINGLE PENDANT. COORDINATE LOCATION AND QUANTITY WITH DECOR PLAN. BOTTOM OF FIXTURE @ 6'-8" A.F.F. MIN./STAGGERED WALL SCONCE — COORDINATE LOCATION AND	G «	2" DIAMETER DOWNLIGHT, SATIN NICKEL FINISH IN PRE-FABRICATED TRELLIS	P	2X2 RECESSED LED		EXIT LIGHT		
B1	QUANTITY W/DECOR PLAN. BOTTOM OF FIXTURE @ 6'-8"	G1 &	2" DIAMETER WALLWASH, SATIN NICKEL FINISH IN PRE-FINISHED TRELLIS	CF CF	CEILING FAN		DOUBLE EMERGENCY LIGHT REMOTE HEAD (EXTERIOR WEATHERPROOF)		
C1 O	4" DIAMETER, WHITE, RECESSED DOWN LIGHT IN DRYWALL SOFFITS & SUSPENDED CEILING	K	12x12 RECESSED SOFFIT LIGHT	TV —	CABLE/OUTLET FOR TV	EM	EXIT SIGN (W/ DIRECTIONAL ARROW		
C2 •	4" DIAMETER, BLACK, RECESSED DOWN LIGHT IN DRYWALL SOFFITS & SUSPENDED CEILING	L	SURFACE MOUNTED EXTERIOR WALL SCONCE UPLIGHT/DOWNLIGHT	J —	JUNCTION BOX FOR SIGNAGE		WHERE APPLICABLE), CEILING MOUNT SINGLE EMERGENCY LIGHT REMOTE		
D1	4" DIA. WHITE RECESSED DOWNLIGHT W/WALLWASHER	LD	SURFACE MOUNTED EXTERIOR WALL SCONCE DOWNLIGHT ONLY	T 0	ADJUSTABLE TRACK LIGHTING FIXTURE,		HEAD (EXTERIOR WEATHERPROOF)		
E .	1x4 RECESSED LED	M .	4'-0" LED SURFACE MOUNTED, FIXTURE SUPPLIED WITH CANOPY		4" DIAMETER MAX., SATIN NICKEL FINISH	0	EXISTING SPRIKLER HEADS		

REV2: 1/26/22

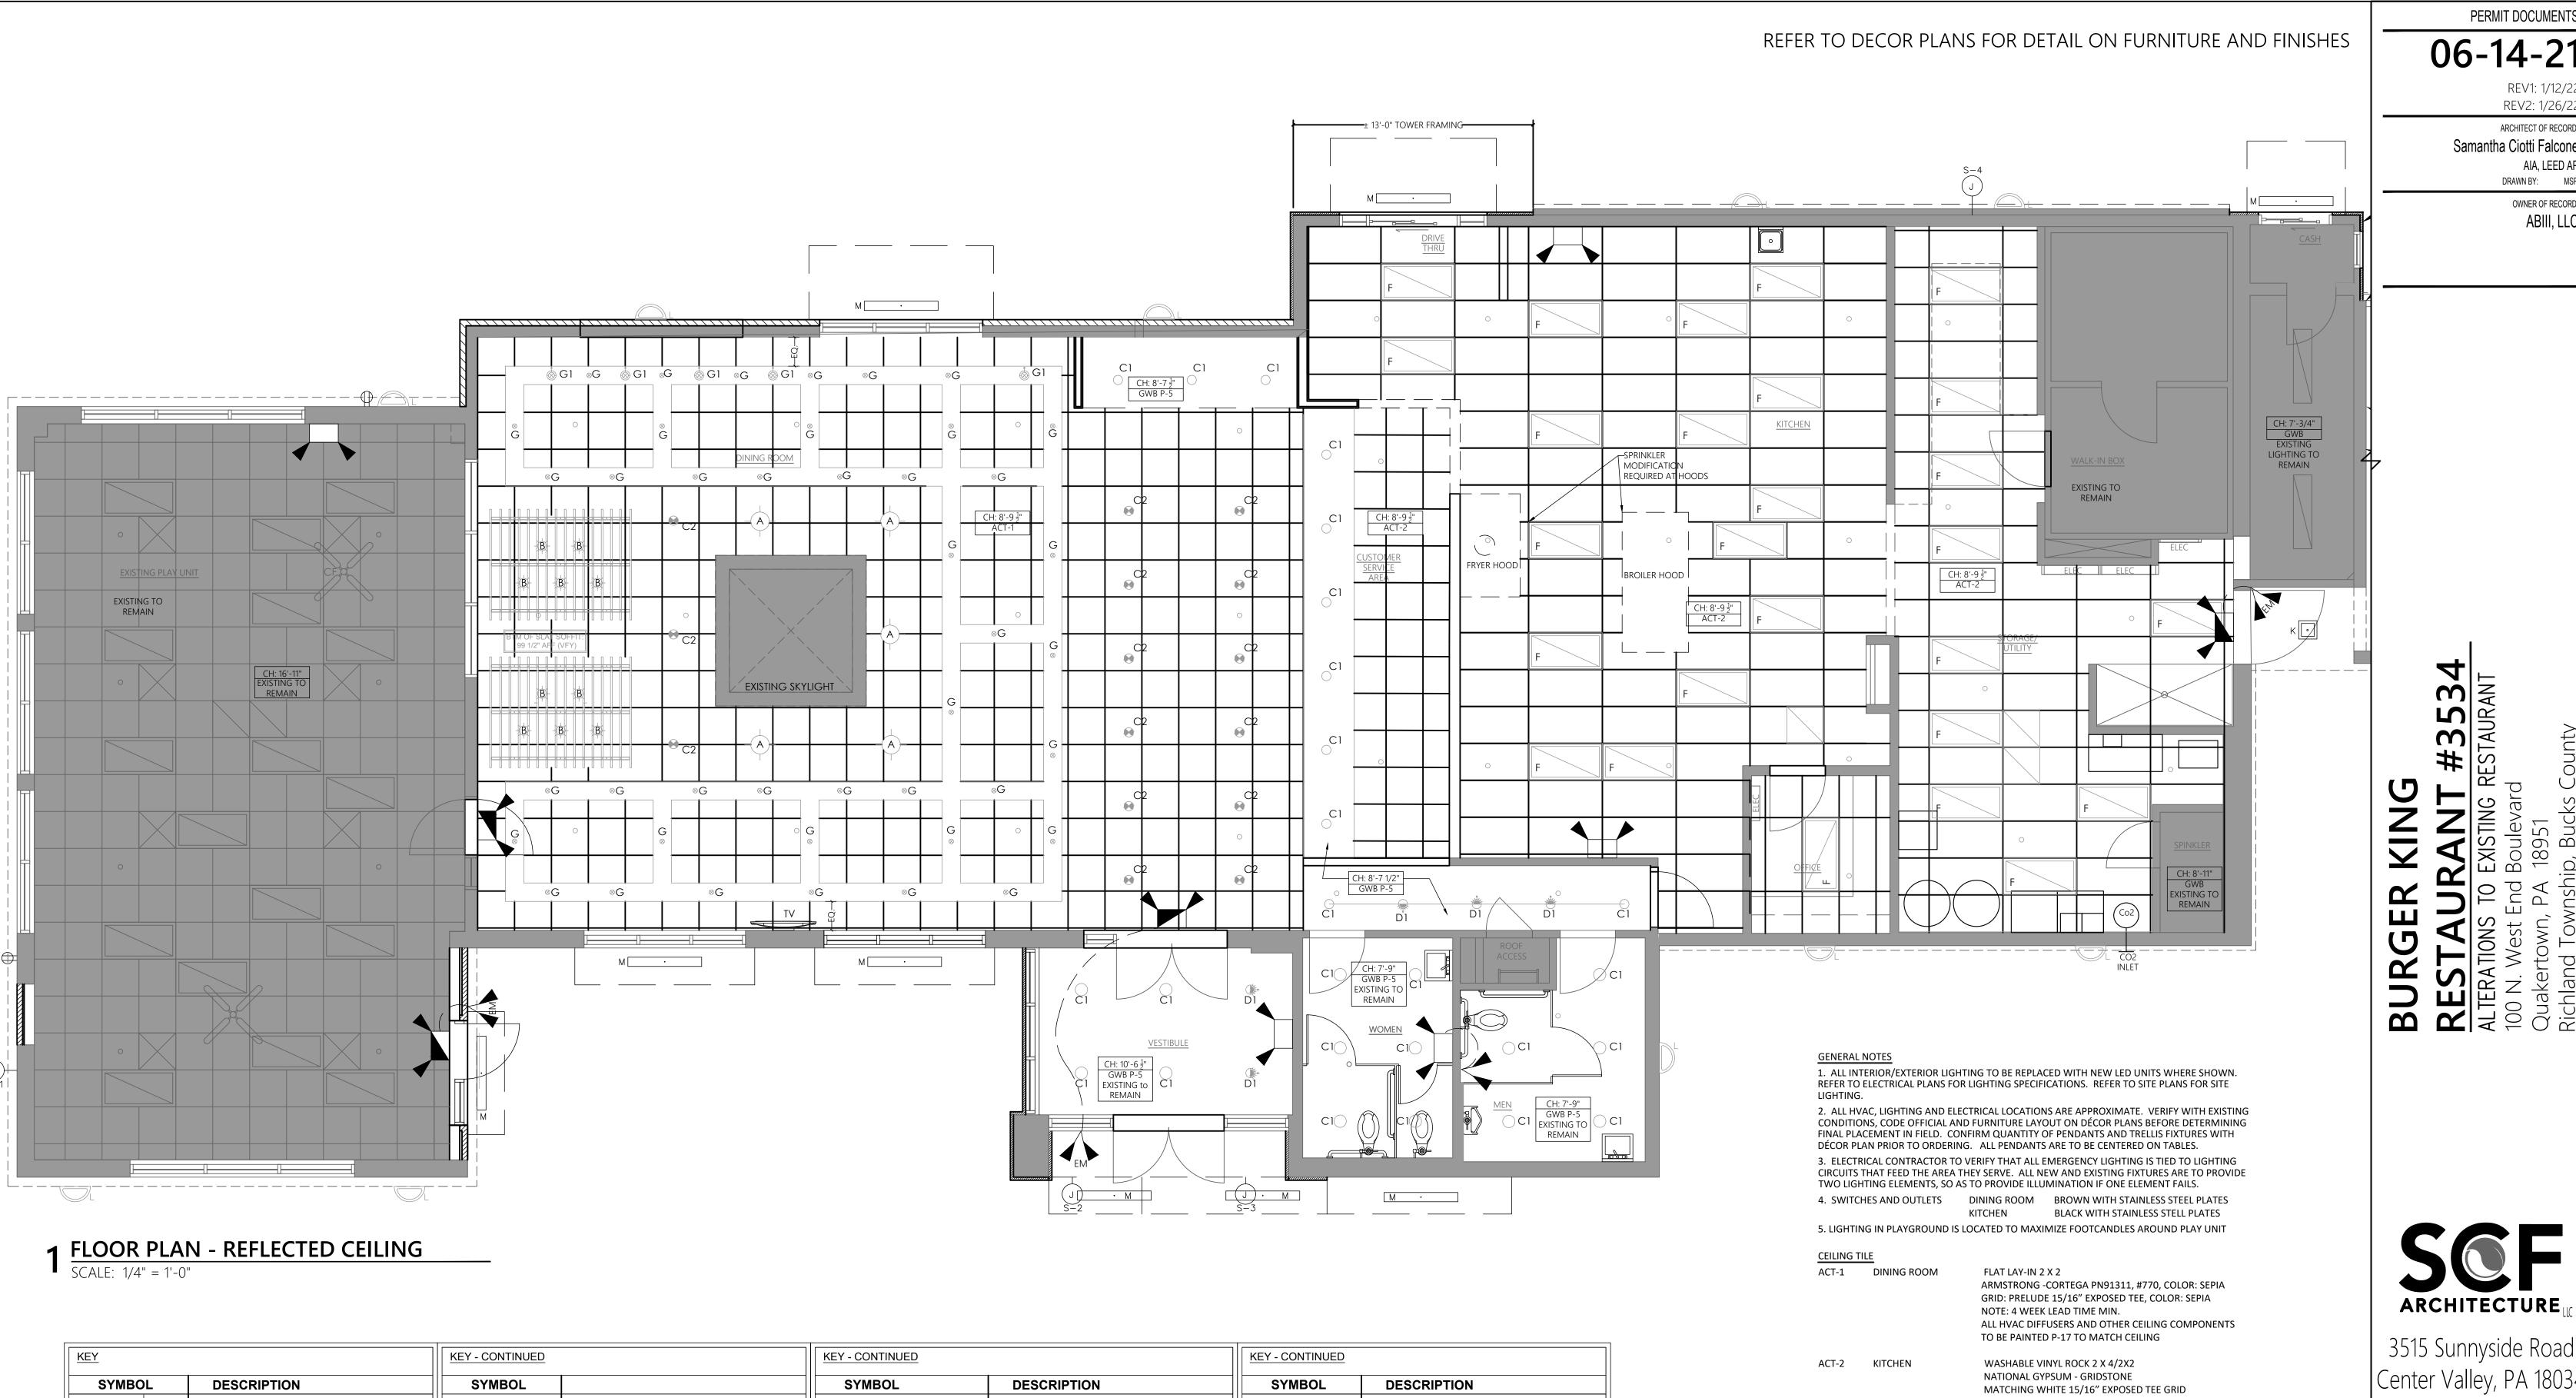ARCHITECT OF RECORD:

OWNER OF RECORD: ABIII, LLC

06-14-21

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> REFLECTED **CEILING PLAN**

3. LED LIGHT BAND TO BE INSTALLED AT PARAPET. SEE ROOF PLAN SHEET A2.3 AND EXTERIOR ELEVATONS SHEETS A3.1/A3.2.

1. ALL MP-3 CANOPIES WILL BE LIGHTED. CANOPY LIGHTING IS BEING SUPPLIED W/ CANOPIES &

2. INTERNALLY ILLUMINATED SIGNAGE AS SHOWN ON EXTERIOR ELEVATIONS SHEETS A3.1/A3.2.

EXTERIOR LIGHTING & SIGNAGE

S-1 6'-0" H. BUN LOGO

S-3 6' H. BUN LOGO

S-2 FG1954 (WHITE) CHANNEL LETTERING

S-4 BK CHANNEL LETTERING W/BUN LOGO (RED)

FIELD MOUNTED.

4. EXISTING FREESTANDING SIGNAGE (PYLON) TO RECEIVE NEW CABINETS, G.C. TO PAINT PYLON