


BURGER KING

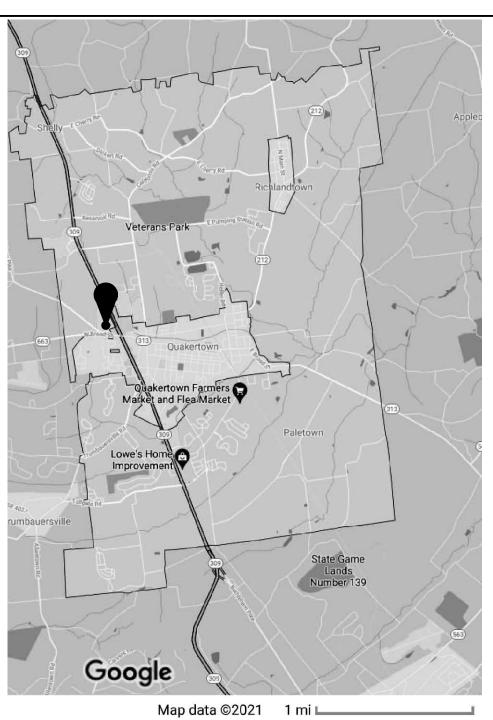

LOCATION MAP BURGER KING # 36234 100 N. West End Boulevard Quakertown, PA 18951 Richland Township, Bucks County



OCCUPANCY LOAD PLAN

FRANCHISEE

AB III, LLC

SCALE: N.T.S.

CONTACT: GREG WINANS gwinans@amplergroup.com PHONE: 610-496-3379 (cell)

SCF ARCHITECTURE, LLC C/O MANNING DESIGN, LLC PROJECT MANAGER AND OWNERS REPRESENTATIVE

ADDRESS: 233 MAIN STREET, #1 SCHWENKSVILLE, PA 19473 CONTACT: LEE ANN MILLER

PHONE: 610-287-0184

ARCHITECT

PROVIDENCE ENGINEERING CORPORATION

STRUCTURAL ENGINEER

ADDRESS: 10 EISENHOWER BOULEVARD LANCASTER PA 17603 CONTACT: DANA ZIEGLER, PE PHONE: 610-360-6536

ELECTRICAL/MECHANICAL **ENGINEER**

ADDRESS: 315 E SECOND ST. CONTACT: NORM COFFEY PHONE: 610 369 3190

McCarthy Engineering

BOYERTOWN, PA 19512

GENERAL CONTRACTOR

CONTACT: ADDRESS:

PHONE:

FURNITURE/MILLWORK CONTRACTOR

FCC COMMERCIAL FURNITURE ADDRESS: 8452 OLD HIGHWAY 99 NORTH

CONTACT: RANDY MOE 800-322-7328 541-673-3351 X270

WEB: www.fcc-create.com

ROSEBURG, OR 97470

FAX: 215-538-3020

SITE ENGINEER

MUNICIPALITY

Richland Township

1328 California Rd, Suite A

Quakertown, PA 18951

PHONE: 215-536-4066

Bohler Engineering 74 WEST BROAD STREET SUITE 500

CONTACT: MATT CHARTRAND PE PHONE: 610-709-9971

BETHLEHEM, PA 18018

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BUILDING CODE SUMMARY

2015

INTERNATIONAL EXISTING BUILDING CODE ALTERATION LEVEL 2

ACCESSIBILITY:

2015 INTERNATIONAL BUILDING CODE

2015 INTERNATIONAL EXISTING BUILDING CODE

2009 ICC/ANSI A-117.1, 2010 ADA

2015 INTERNATIONAL PLUMBING CODE

2014 NATIONAL ELECTRIC CODE 2015 INTERNATIONAL MECHANICAL CODE

2015 INTERNATIONAL ENERGY CONSERVATION CODE

except: Section C104.2.6 (relating to final inspection);

and Section C408.2.4 (relating to preliminary commissioning report) 2015 INTERNATIONAL FIRE PREVENTION CODE

BOCA 1996 CH 14 & 15 ALSO CONSIDERED

JOB TYPE:

OCCUPANCY CLASSIFICATION:

Alterations **CONSTRUCTION TYPE:**

SPRINKLERS REQUIRED/PROVIDED: existing to remain

ZONING:

PC PLANNED COMMERCIAL

75

GROSS BUILDING AREA: 5044 SF (EXISTING)

ACCESSIBLE PARKING:

PARKING PROVIDED: ACCESSIBLE SPACES PROVIDED:

OCCUPANCY

OCCUPANCY COUNT:
TOTAL SEATING COLL

144 occ. ioial seating count: Existing 120 occ. Proposed 5 Net 16.0 occ. Standing Space: 80 s.f. 200 gross 4.61 occ. Kitchen 922 s.f. Storage

Total

792 s.f. 300 gross 2.64 occ.

144 occupants

OCCUPANCY

OCCUPANCY: 144 PEOPLE TOTAL

MIN. REQUIRED EGRESS WIDTH - SHALL NOT BE LESS THAN THE TOTAL OCCUPANT LOAD MULTIPLIED BY 0.2"

144 X 0.2" =28.8" OF EGRESS REQUIRED 3 DOOR LEAFS @ 32" PER DOOR = 128" OF EGRESS WIDTH PROVIDED

MIN. 2 MEANS OF EGRESS REQUIRED FOR BUILDING - 3 PROVIDED

144 OCCUPANTS /3 MEANS OF EGRESS = 48 OCCUPANTS PER EGRESS

GENERAL NOTES

1. In all cases, written dimensions shall take precedence over scaled dimensions. Due to the nature of the work, all dimensions in existing areas shall be considered approximate.

2. These drawings were prepared at the request of the owner and/or tenant for the purpose of illustrating desired improvements. Any contractor or subcontractor employed to carry out the work shown shall be responsible for verifying all dimensions, quantities and on—site conditions before performing the work. They shall also take all necessary steps to ensure the structural integrity of the work and compliance with all applicable building codes and regulations.

3. Existing wall thickness, construction type and structural conditions cannot be completely determined and indicated on plans. GC shall be responsible for adapting construction methods to achieve the design effect shown, as required. The Architect shall be notified of any variation from the conditions shown.

4. The General Contractor shall use extreme caution in demolition of existing construction. It shall be the contractor's responsibility to identify and verify structural items regardless of whether they are indicated on these drawings, and to contact the Architect in the event of a discrepancy

5. All new work shall comply with all applicable accessibility requirements. Work shall not diminish any existing accessibile features.

6. SCOPE OF WORK: Interior and exterior renovations to existing building including windows/doors, electrical, lighting, mechanical improvements as well as site improvements in accordance with an approved land development plan.

NEW RESTROOMS

144/2 = 72 people

Plumbing Fixtures Maximum building occupant load at one time: Main Level 144 people

Women:

req'd 1/75 -W closets:

req'd 1/200 -Lavatories

Service sink

req'd 1/75 -W closets: reg'd 1/200 req'd/provided:1/1

req'd/provided: 1/2

req'd/provided: 1/1

req'd/provided:1/1 -Lavatories reg'd/provided: 0/1 -Urinals Note: Per Section 419.2 of the plumbing code, a urinal may be provided to meet water closet

requirement for no more than 67% of require water closets.

1 required / 1 provided

1. Restrooms are to be fully handicap accessible. G.C. is to supply/install all fixtures and components in full compliance with the 2010 ADA & 2009 ICC/ANSI A117.1 Accessibility Standards.

PORTABLE FIRE EXTINGUISHERS

Portable fire extinguishers shall be selected, installed and maintained in accordance with IBC/IFC Section 906 and NFPA 12. Requirements include, but are not limited to:

-Provide a minimum of one (1) type 2A:10B:C extinguisher for each 3000 s.f. of floor area. Travel distance to such an extinguisher shall not exceed 75 feet.

-A portable type "K" fire extinguisher shall be located within 30 feet of commercial cooking equipment. -Fire extinguishers provided for the protection of cooking grease fires shall be of an approved type compatible with the automatic fire-extinguishing system agent and in accordance with IFC section 904.11.5.

-Portable fire extinguisher types, sizes, quantities and locations are subject to approval of the fire -Location shall be unobstructed and unobscured, and firmly mounted in cabinet or on bracket supplied

-Mounting height not to exceed 42" to top, or bottom be closer than 4" to floor, and shall not protrude more than 4" from wall if on an accessible route. (IBC 2015 906.9.2/906.9.3)

PROPOSED LOCATIONS SHOWN ON 1/A2.1. FINAL LOCATIONS SHALL BE AS APPROVED BY LOCAL FIRE MARSHAL

ERATIONS | N. West Er

~

URG

3515 Sunnyside Road Center Valley, PA 18034

ARCHITECTURE_{IIC}

T: 610-297-0140 E: sam@scf-arch.com

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PROJECT INFO & COVER

without the specific written consent of the Architect.


ARCHITECT OF RECORD Samantha Ciotti Falcone AIA, LEED AP DRAWN BY: MSR

OWNER OF RECORD ABIII, LLC BLOCK 13303 LOT 2 TAXMAP SHEET #133

PERMIT DOCUMENTS

6-14-21

REV1: 1/12/22

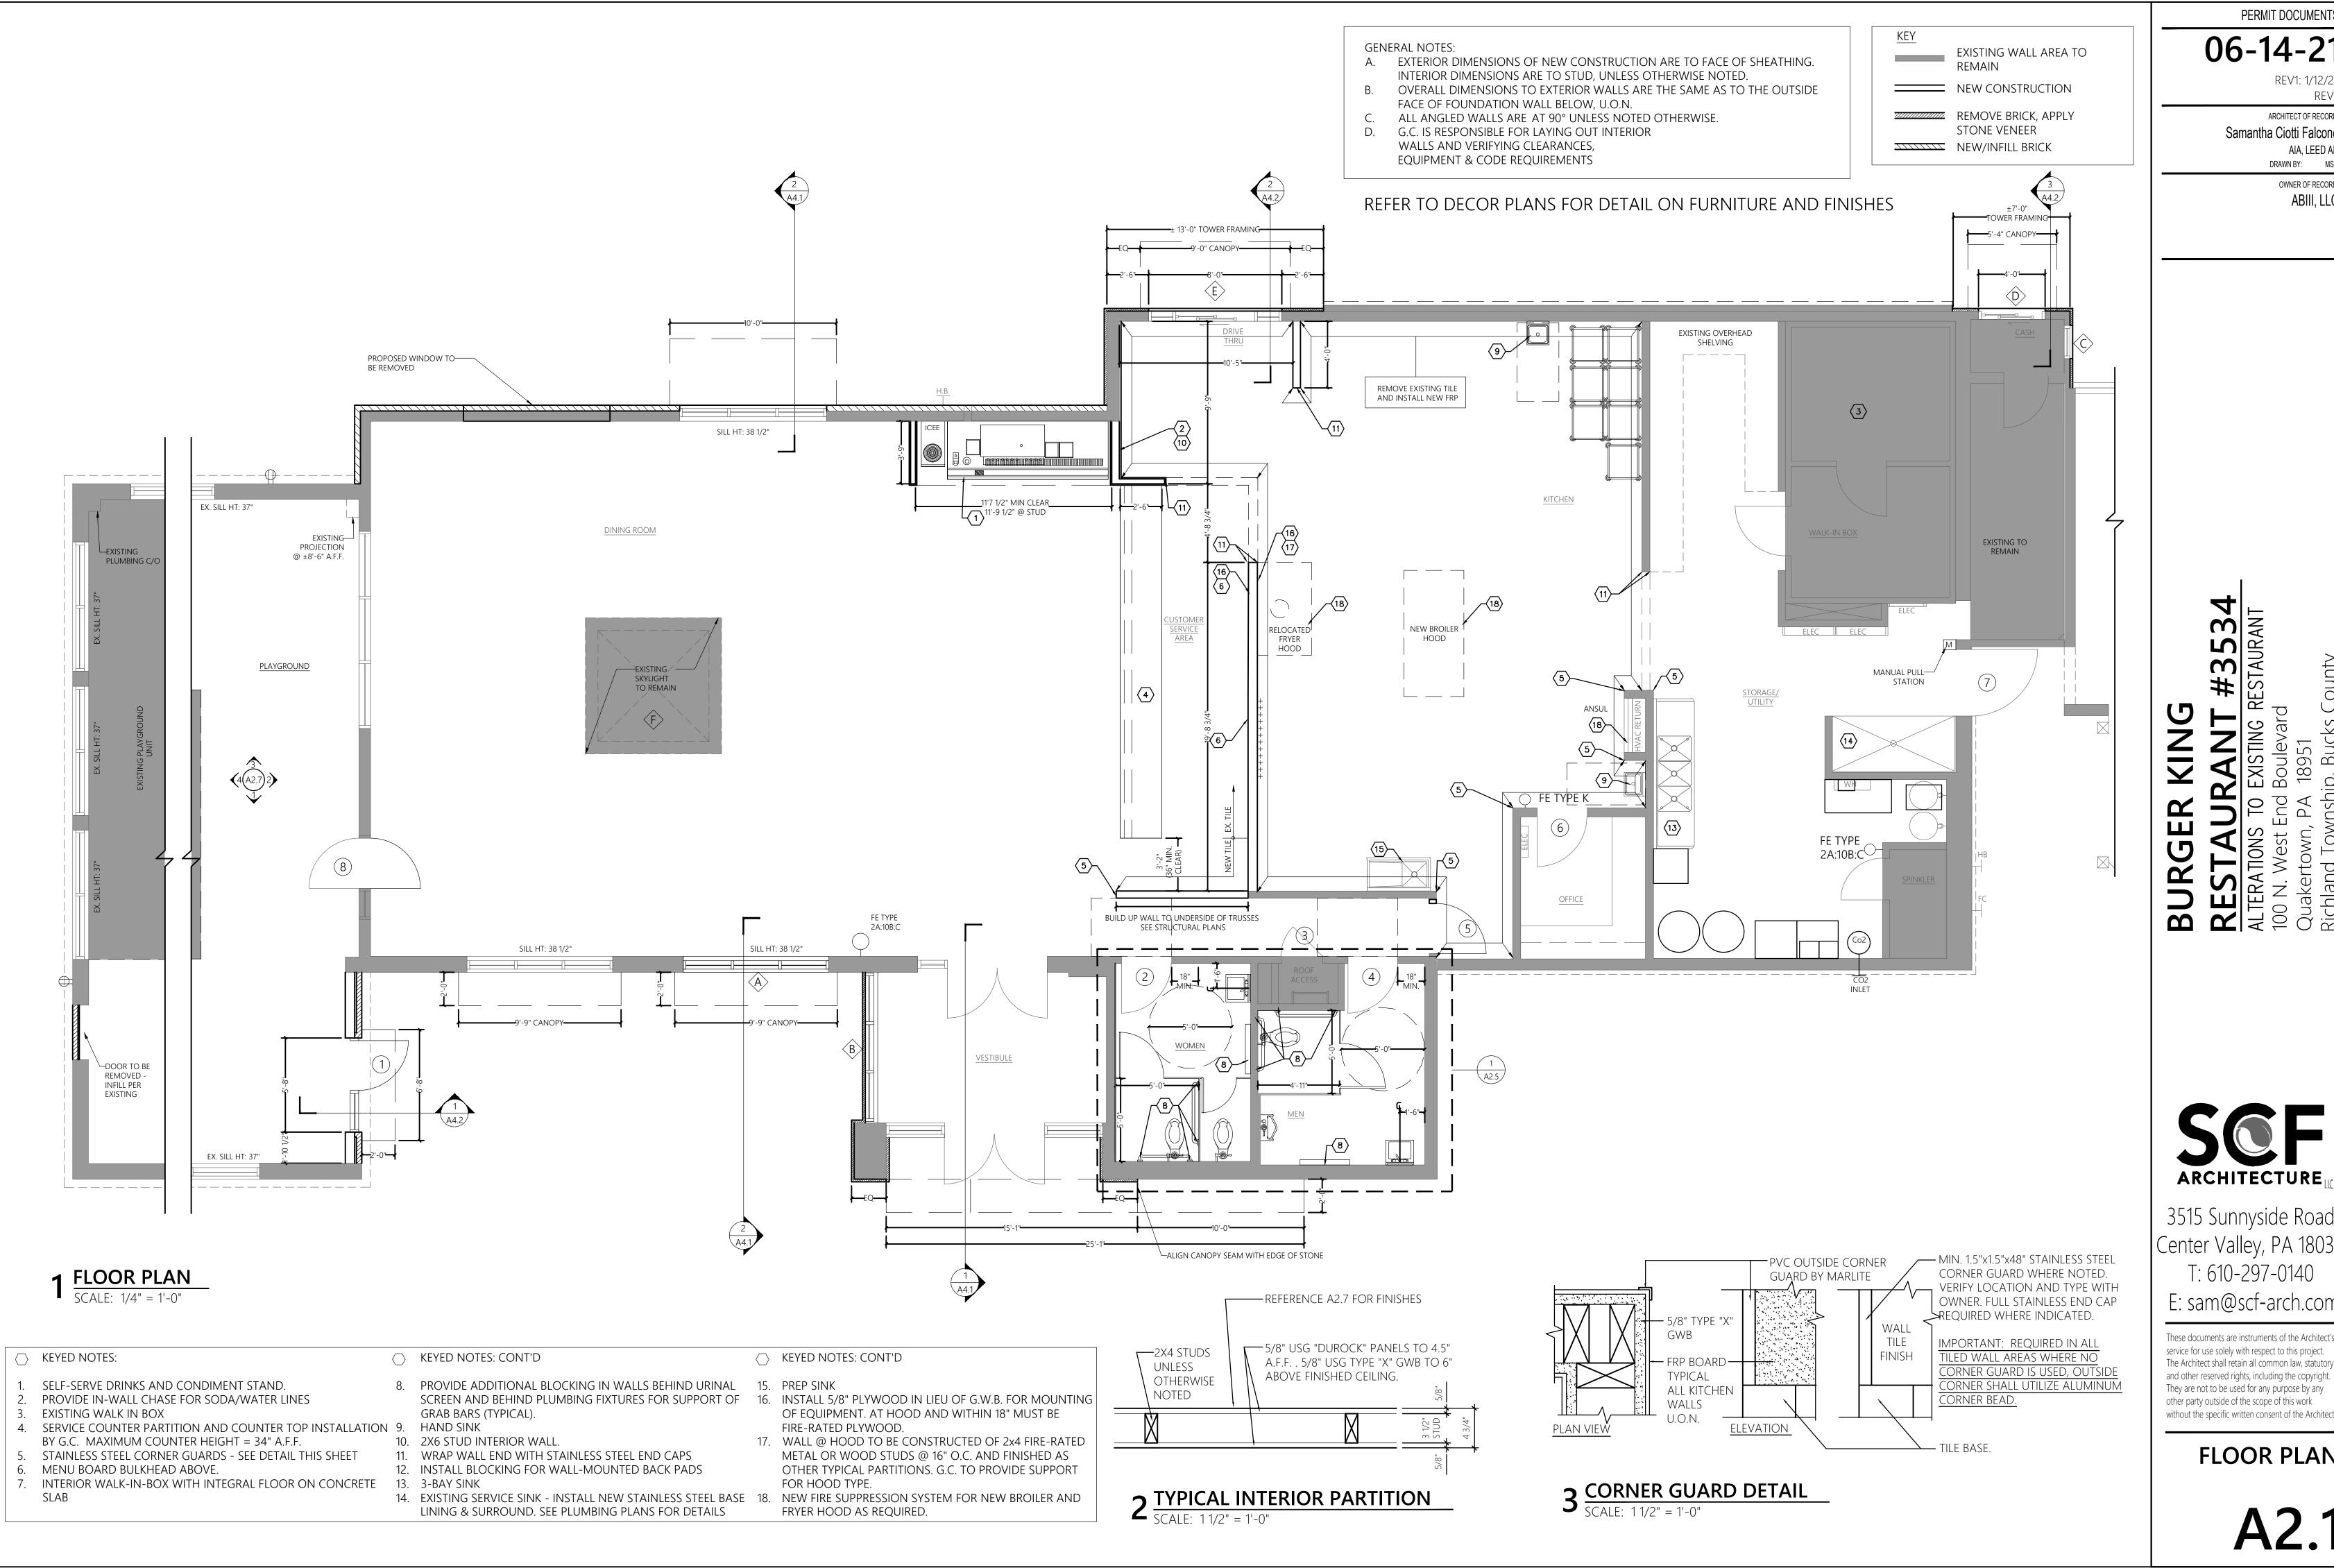

06-14-21

ARCHITECT OF RECORD: Samantha Ciotti Falcone AIA, LEED AP DRAWN BY: MSR


> OWNER OF RECORD: ABIII, LLC

3515 Sunnyside Road Center Valley, PA 18034 T: 610-297-0140

E: sam@scf-arch.com

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FLOOR PLAN

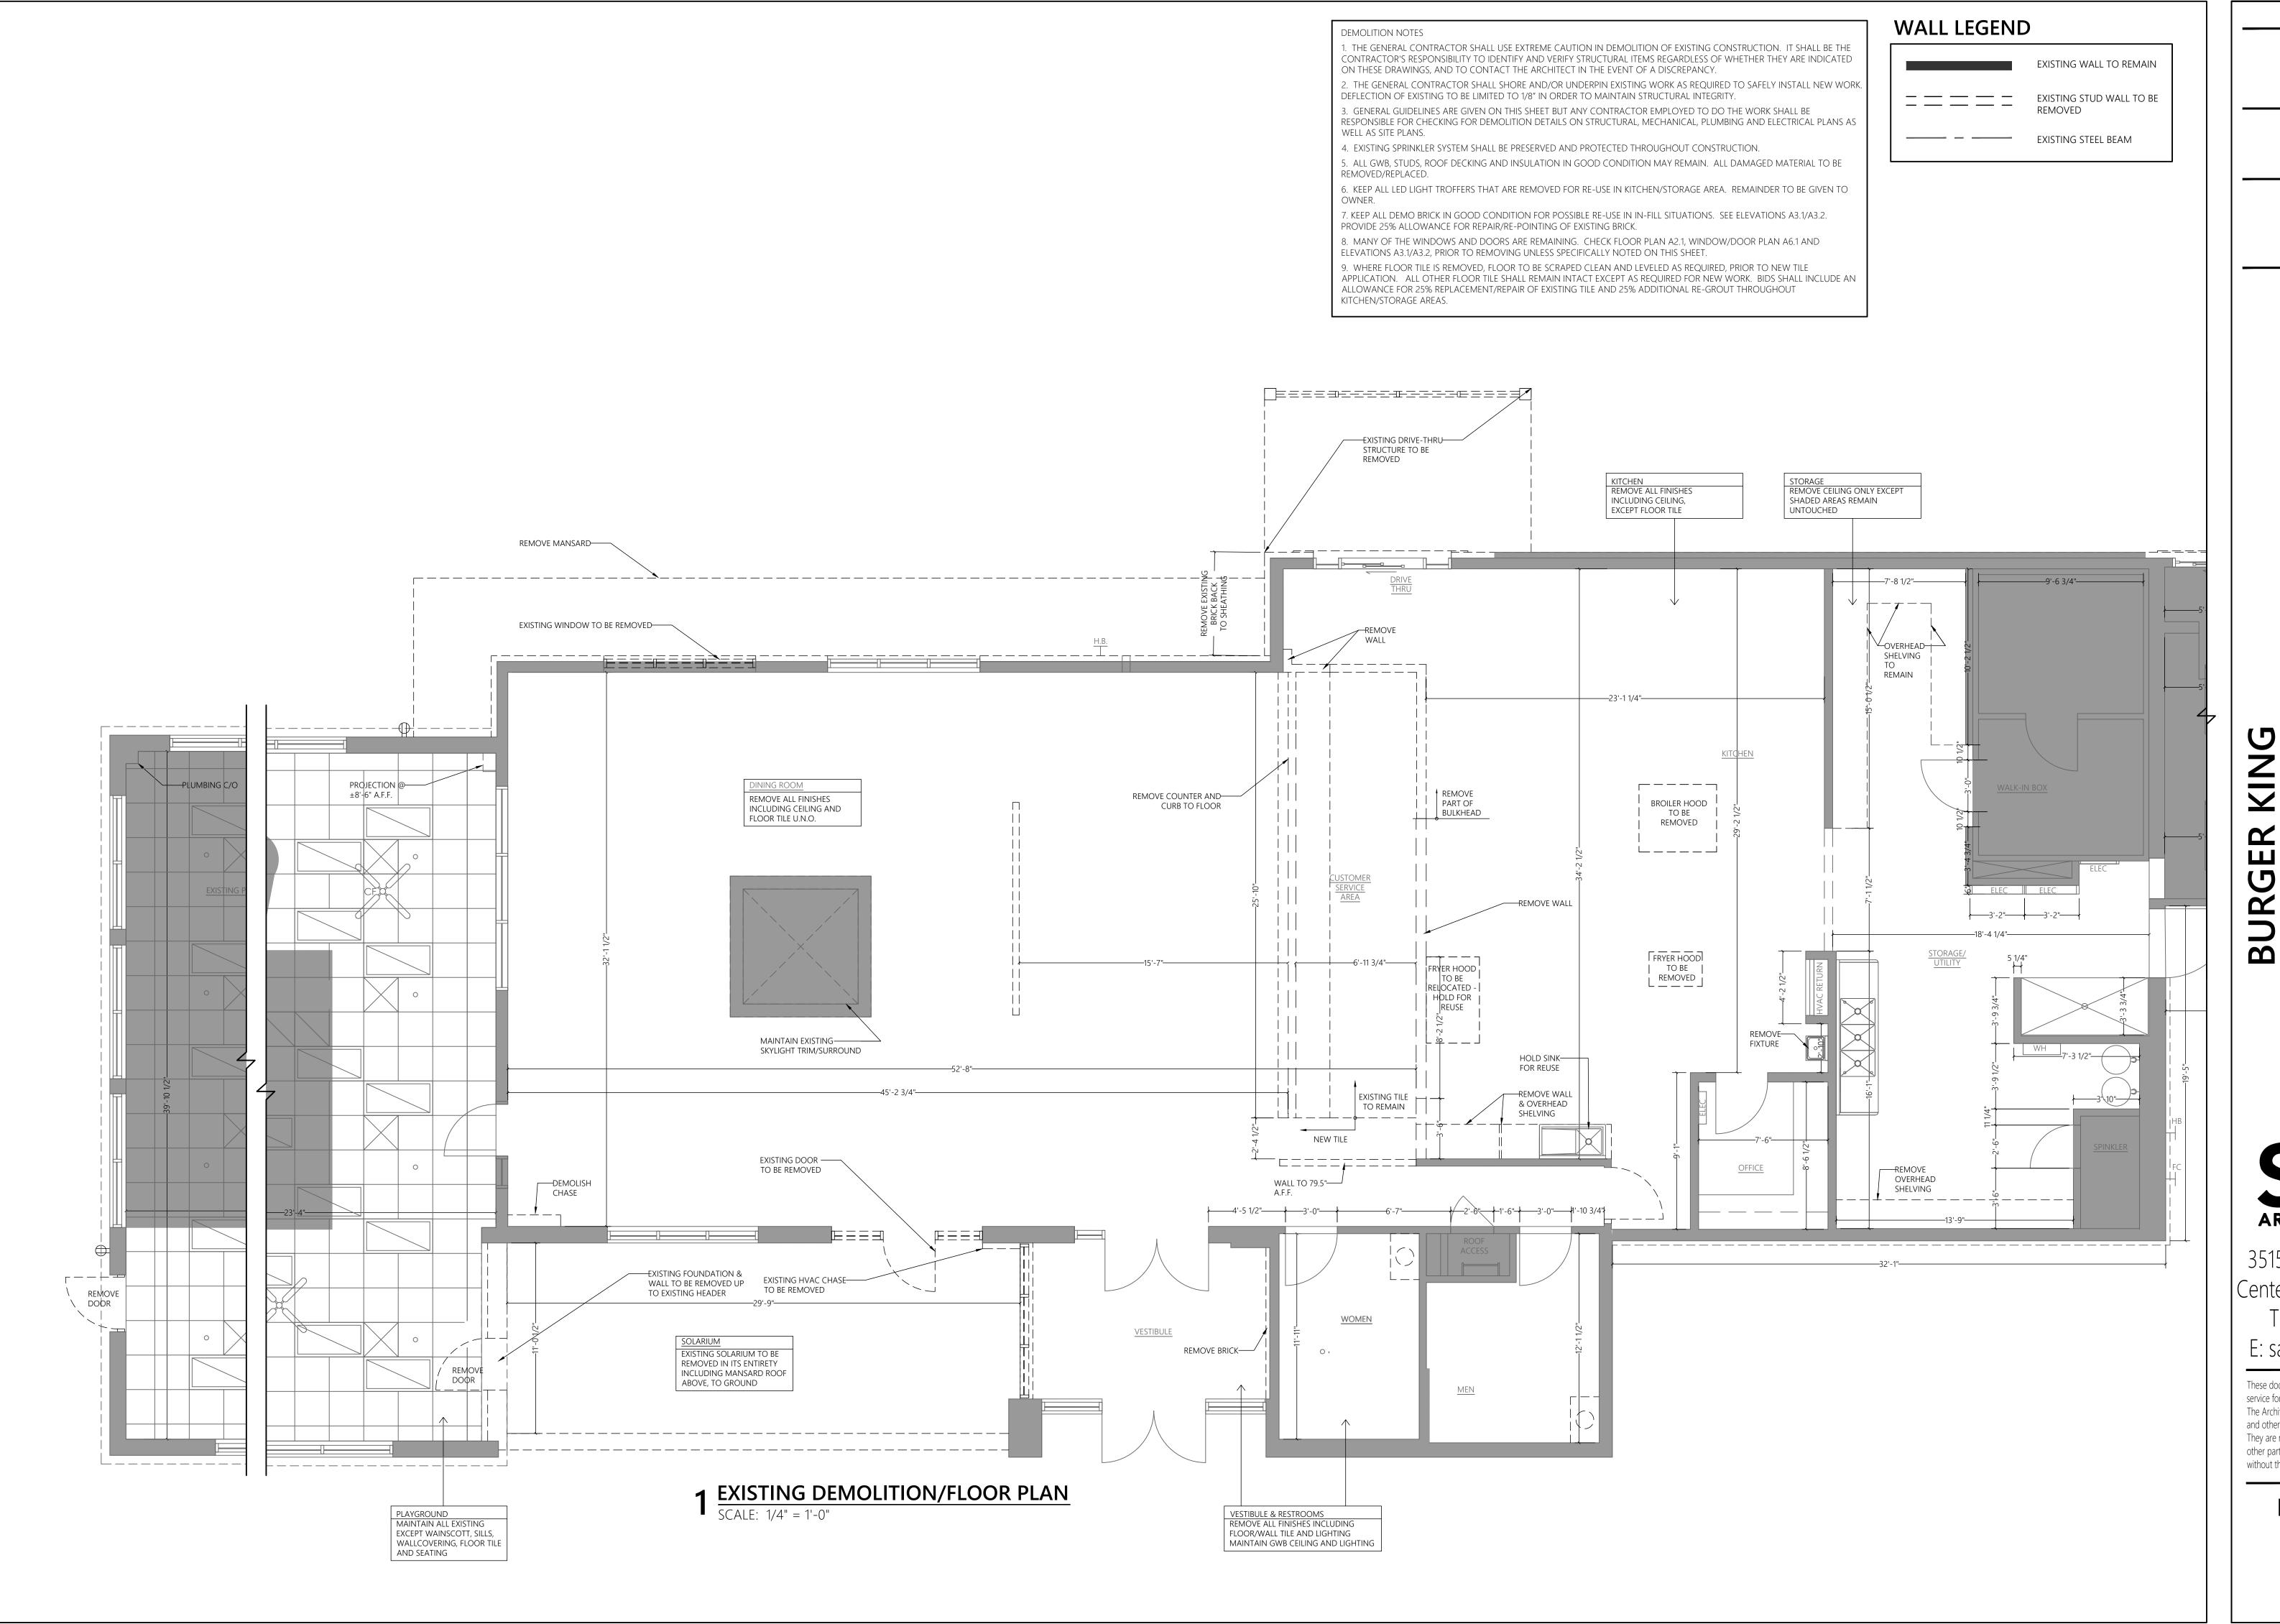

06-14-

REV1: 1/12/22 REV2

ARCHITECT OF RECORD:

Samantha Ciotti Falcone


AIA, LEED AP
DRAWN BY: MSR
OWNER OF RECORD:

SEF ARCHITECTURE

3515 Sunnyside Road Center Valley, PA 18034 T: 610-297-0140 E: sam@scf-arch.com

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DEMOLITION PLAN

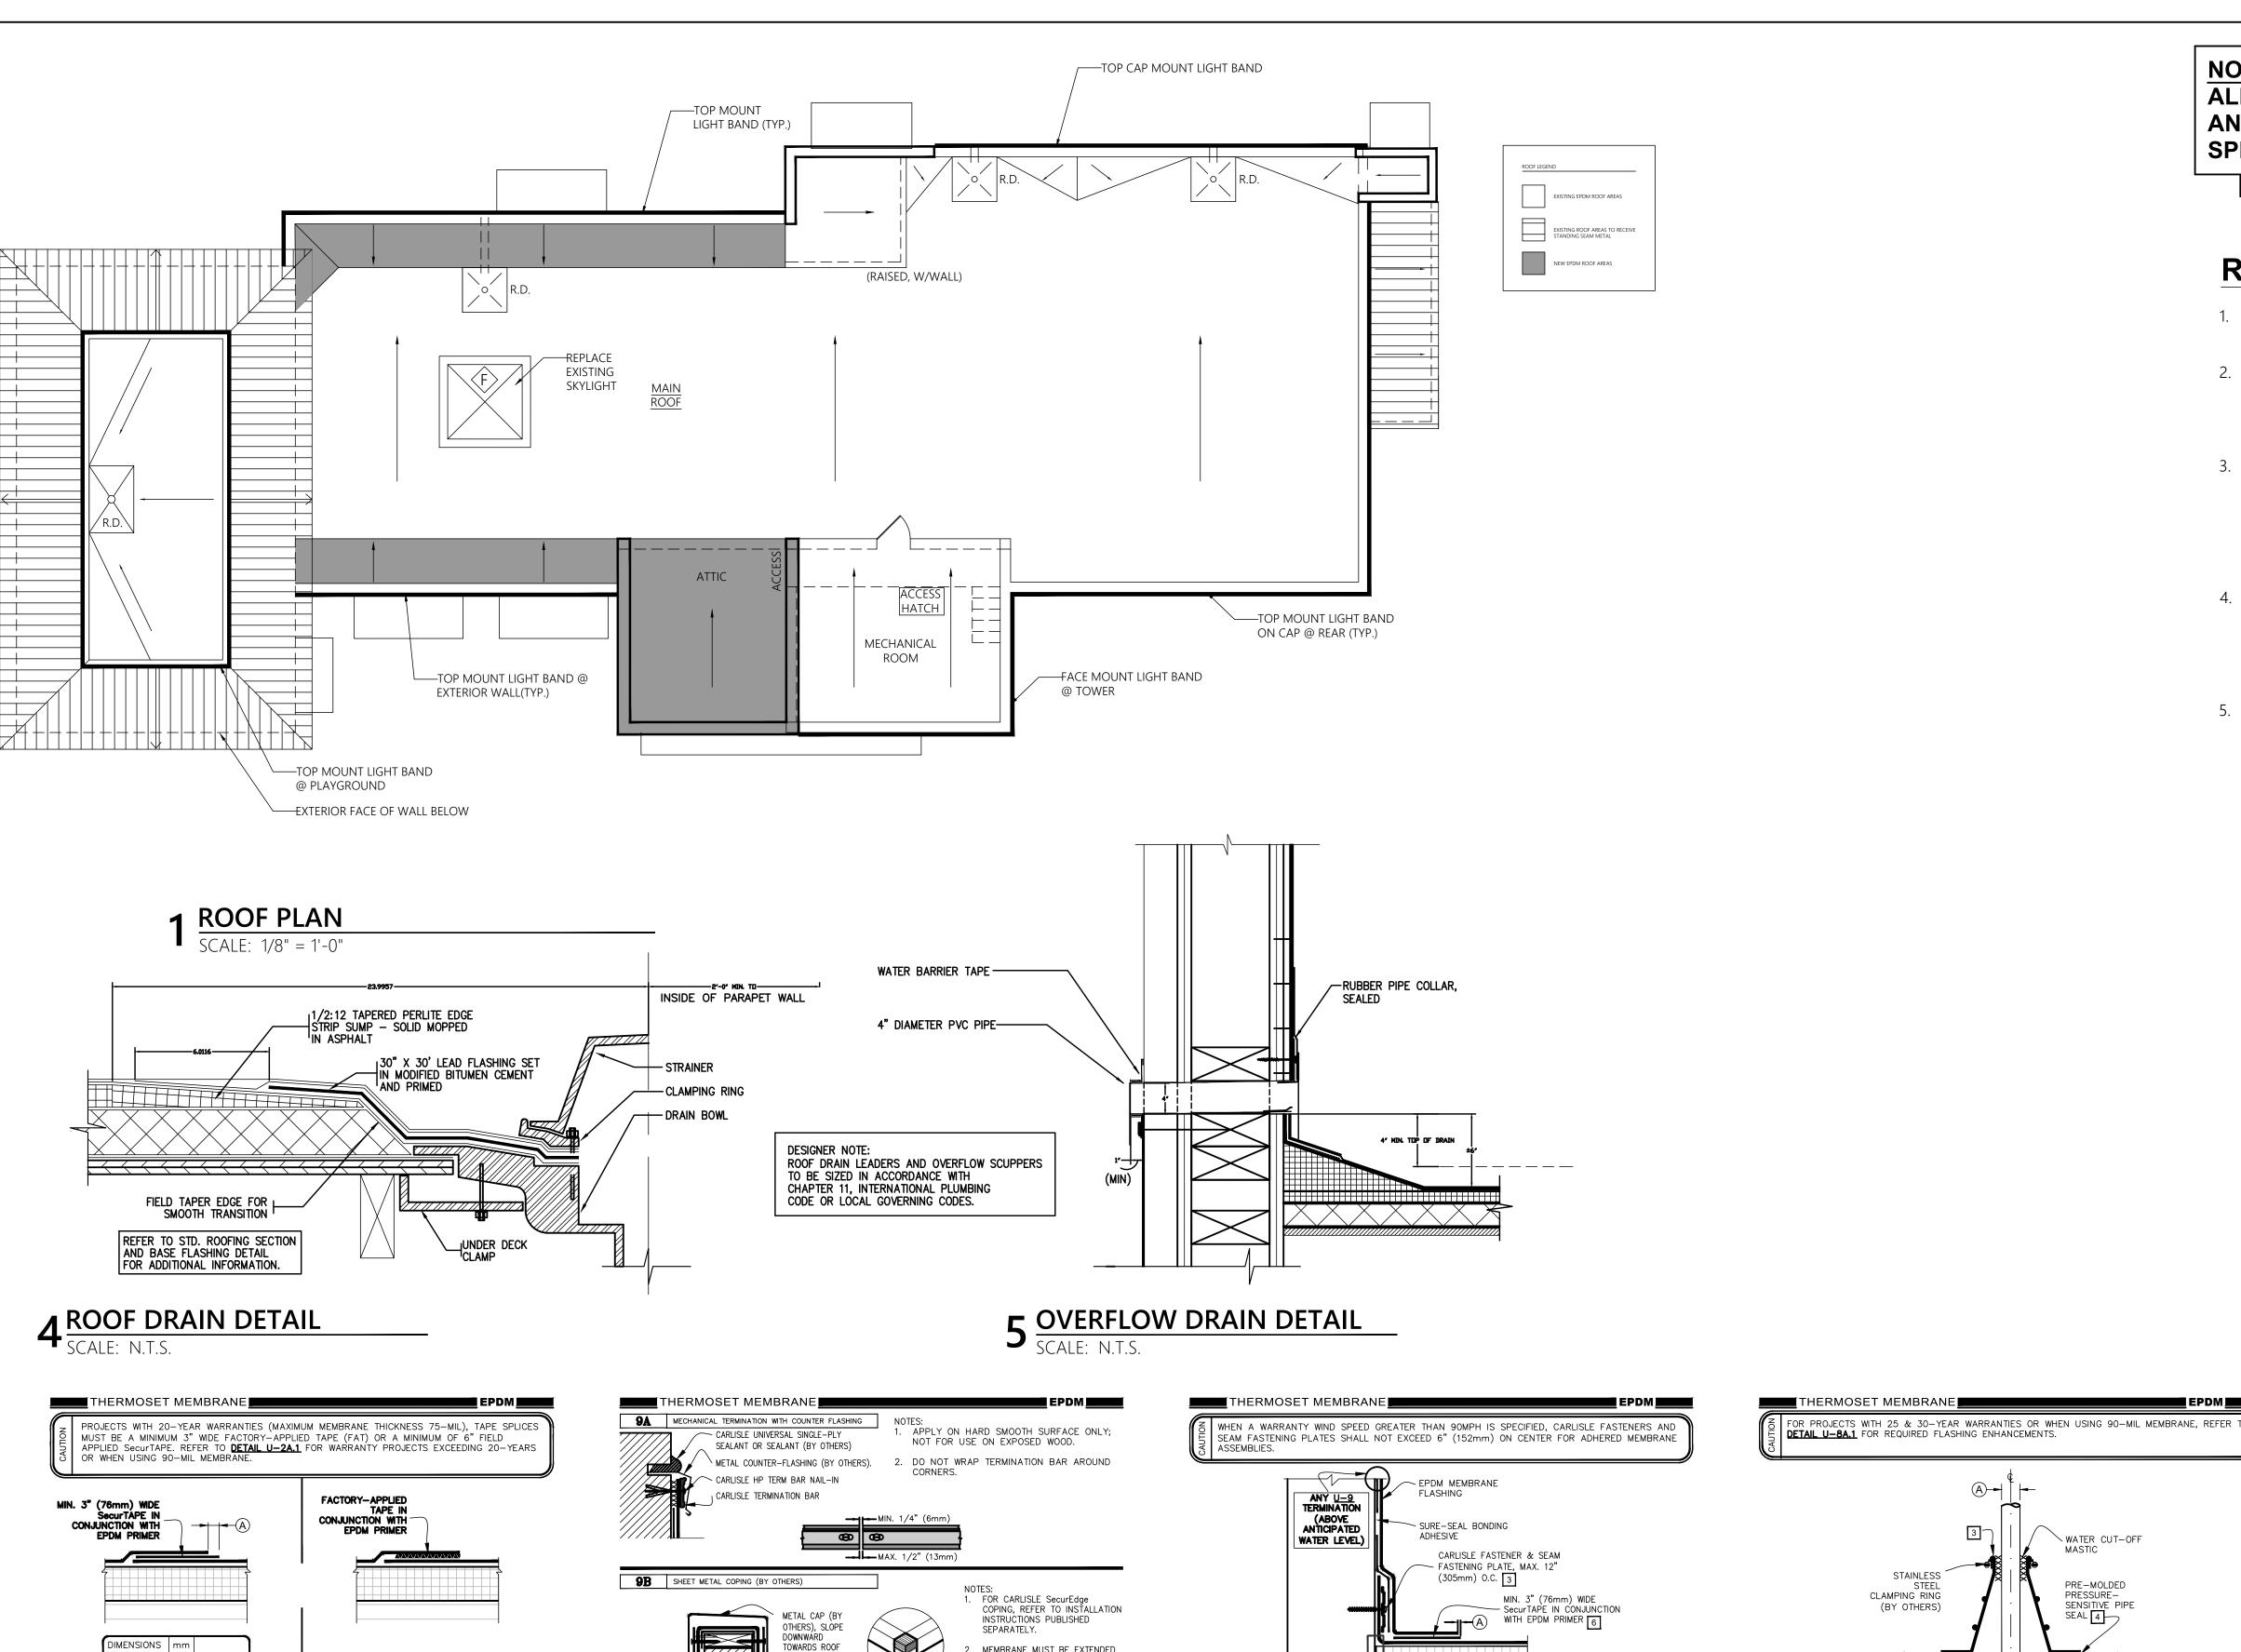

CARLISLE UNIVERSAL SINGLE-PLY

- METAL COUNTER-FLASHING (BY

SEALANT OR SEALANT (BY OTHERS)

FASTEN MEMBRANE @ 12" (305mm)

- CARLISLE UNIVERSAL SINGLE-PLY

/ CARLISLE TERMINATION BAR

APPLICABLE BONDING ADHESIVE

SEE NOTE(S)

2011 Carilsie SynTec, a division of Carilsie Construction Materials incorporates

APPROVED SUBSTRATE PAGE 1 OF 2

SEALANT OR SEALANT (BY OTHERS)

MASTIC UNDER THE

FASTENER HEADS.

BAR AROUND CORNERS.

MEMBRANE TERMINATIONS

For additional information, refer to Specifications

(A) 1/8" 3 TO

(<u>see notes</u>)

EPDM

1/2" | 13 | MAX.

DIRECTIONS FROM THE SPLICE INTERSECTION.

2011 Carilsie SynTec, a division of Carilsie Construction Materials incorporated

1. FIELD APPLIED SecurTAPE IS TO BE OVERLAPPED A MINIMUM OF 1" (25mm) AT THE ENDS OF EACH

CUT PIECE. APPLY LAP SEALANT AT TAPE OVERLAPS 2" (51mm) IN ALL DIRECTIONS AS SHOWN.


(152mm X 152mm) T-JOINT COVER, COVERING THE EXPOSED SPLICE TAPE 2" (51mm) IN ALL


3. 6" (152mm) WIDE PRESSURE—SENSITIVE ELASTOFORM FLASHING, IN CONJUNCTION WITH EPDM PRIMER, MAY ALSO BE CENTERED OVER THE INTERSECTING POINT OF THE LEADING EDGES OF THE FIELD

For additional information, refer to Specifications

2. APPLY LAP SEALANT ALONG THE LEADING EDGE OF THE MEMBRANE SPLICE UNDER THE 6"X6"

4. LAP SEALANT IS REQUIRED ON CUT EDGES OF REINFORCED EPDM MEMBRANE.

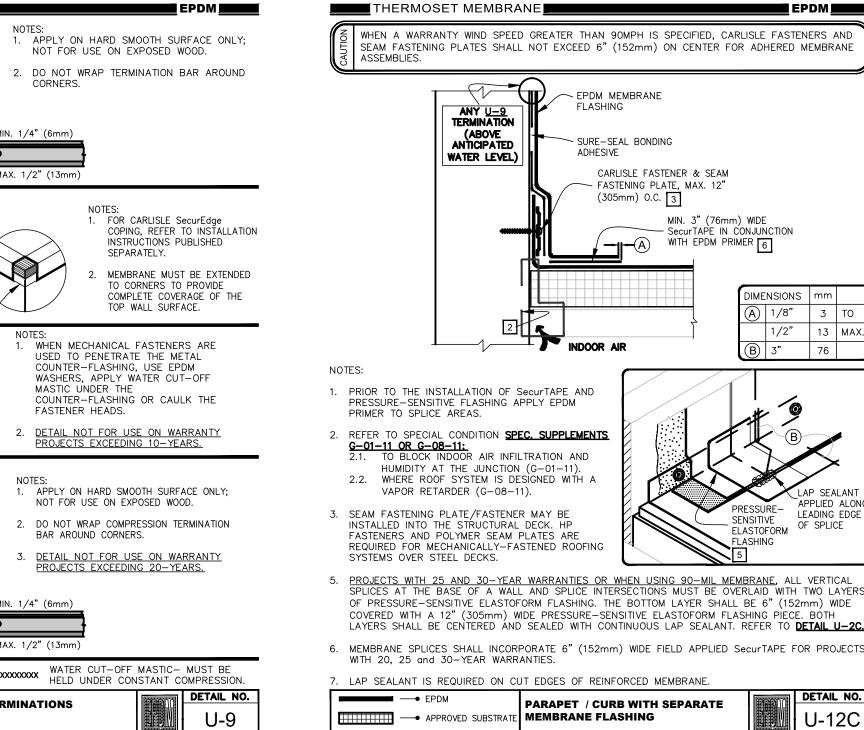


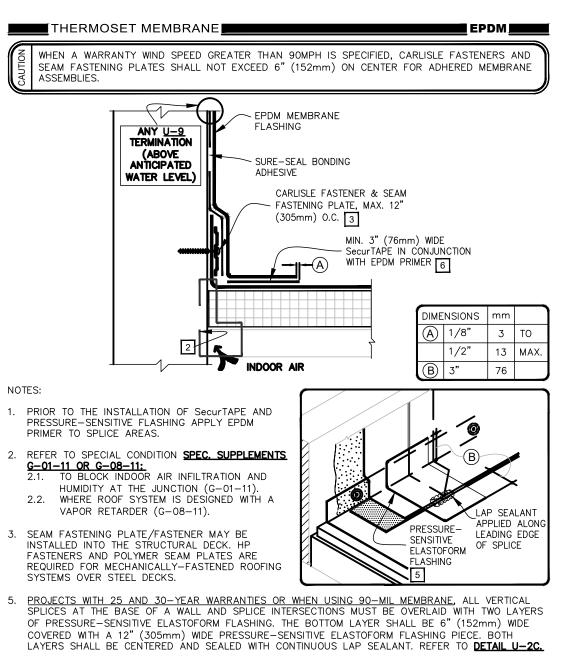

PARAPET / CURB WITH SEPARATE

For additional information, refer to Specifications

2011 Carilsie SynTec, a division of Carilsie Construction Materials incorporated

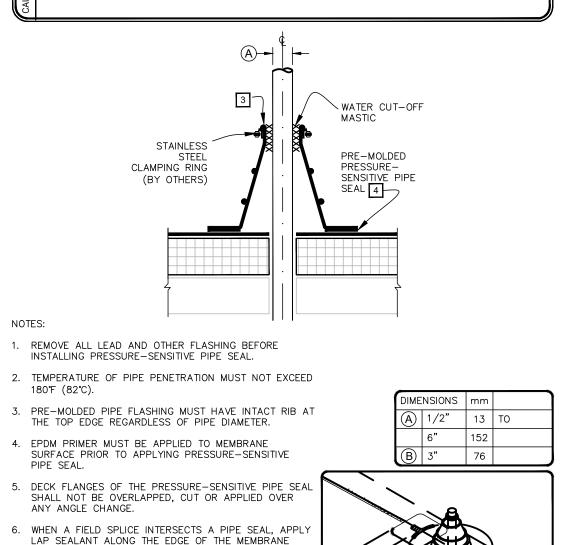

PRE-MOLDED PRESSURE-SENSITIVE

For additional information, refer to Specifications

SPLICE COVERING THE EXPOSED SPLICE TAPE 2"

INTERSECTION & OVERLAY WITH A 6"X6" (152mm X

(51mm) IN EACH DIRECTION FROM THE SPLICE

7. ON MECHANICALLY-FASTENED ROOFING SYSTEMS.

→ APPROVED SUBSTRATE PIPE SEAL

© 2011 Carilsie SynTec, a division of Carilsie Construction Materials incorporated

ADDITIONAL MEMBRANE SECUREMENT IS REQUIRED.

152mm) T-JOINT COVER.

REFER TO **DETAIL MF-8A.**

NOTE

ALL ROOFING DETAILS TO BE VERIFIED

SPECIFICATIONS AND WARRANTIES.

POSSIBLE. ROOF CURB IS REQUIRED.

REFER TO MECHANICAL PLANS.

ROOF NOTES:

CLEARANCES

MECHANICAL

NEW ROOF SECTIONS

RECOMMENDATIONS

ACHIEVE R-30 MIN.

EXISTING ROOF

SHEATHING PER STRUCTURAL PLANS

INDICATED ON WALL SECTIONS)

PLANS.

AND COORDINATED WITH MANUFACTURERS

1. VERIFY CONDITION OF EXISTING ROOF DRAINS/LINES ON MAIN ROOF. INSTALL NEW EMERGENCY OVERFLOWS IN WALL AS SHOWN.

EXISTING FRYER FAN TO REMAIN AT EXISTING ROOF OPENING IF

NOTE THAT ONLY TWO HOOD/FAN LOCATIONS WILL BE REQUIRED.

AND OTHER CODE REQUIREMENTS PRIOR TO FRAMING. REFER TO

G.C. TO VERIFY & COORDINATE ALL NEW ROOF OPENINGS WITH HVAC

(2) LAYERS 2 1/2" MIN. POLYISOCYANURATE RIGID ROOF INSULATION

(R-30 MIN.) ON TOP OF SHEATHING (R-30 FIBERGLASS BATT AS

APPLY EPDM FOOFING IN ACCORCANCE WITH MANUFACTURER

G.C. TO INSPECT EXISTING ROOF DECKING & REPLACE ANY

APPLY NEW EPDM OR STANDING SEAM METAL ROOFING IN

ACCORDANCE WITH MANUFACTURE RECOMMENDATIONS

REPLACE ALL PARAPET CAPPING - REF. A3.1/A3.2 FOR COLOR.

G.C. TO INSPECT EXISTING INSULATION AND ADD AS NEEDED TO

DETERIORATED AREAS TO ELIMINATE PONDING.

REF. A3.3 FOR EXTERIOR FINISH SCHEDULE

NEW BROILER HOOD/FAN TO USE EXISTING ROOF OPENING IF POSSIBLE. STAINLESS STEEL ROOF CURB SUPPLIED WITH FAN

NEW HVAC UNITS MUST UTILIZE EXISTING TRUSS OPENINGS TO EXTENT

FROM A/C UNIT-NOTE:
PROVIDE DRAIN NUT
IN BOTTOM OF P-TRAP-PIPE SUPPORT
PEDESTALS PLACED

5'-0" O.C. & ALL TURNS,
JUNCTION IN LINES.

3 CONDENSATE LINE SUPPORT DETAIL
SCALE: N.T.S.

06-14-21 REV1: 1/12/22

REV2

PERMIT DOCUMENTS

ARCHITECT OF RECORD: Samantha Ciotti Falcone AIA, LEED AP

> DRAWN BY: MSR OWNER OF RECORD: ABIII, LLC

U

18951 Bucks

ARCHITECTURE_{III}

3515 Sunnyside Road

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ROOF PLAN


ITEM NO	оту_	FXISTING /NEW	DESCRIPTION	SUPPLIED BY	INSTALLED BY	VOLTS/ PHASE	AMPS —	WATER.	DRAIN —	GAS —	BTU NOTES
4	4	EXISTING/NEW		_		VOLTS/ PHASE	AIVIFS	VVAIER		GAS 7	
2	LOT	NEW EXIST		OWNER (G) OWNER	GC GC				11.D.		DoorsStainless Steel
3	1	NEW		H&K	GC			1/2 H&C	1 1/2		14" WIDE
4	3	NEW		H&K	GC						STAINLESS STEELWALL MOUNT
5	1	NEW	METRO DRIVE-THRU TABLE 30 X 48HEATED	н&к	GC	120-1					CORD & PLUG
6	0		•	H&K	GC						POWER FROM MAIN BOARD
8	0			H&K	GC				-		HP LAMINATE: FOG GRAY
	9 2	NEW	SS SHELVES /WATER BOOSTER/CARBONATOR	H&K	OPS(S)	115-1	6.2				CORD AND PLUG
10	1	NEW	•	H&K	OPS(S)	120-1	8.5		3/41.D.		CORD & PLUG, WATER THRU SODA LINES
11	1	NEW		OWNER	OPS(S)	120-1	5.3		3/41.D.		CORD & PLUG, WATER THRU SODA LINES
12	0		SILVER KING REF. BEVERAGE STATION-27"	OWNER	GC	120-1	3				CORD & PLUG, SS WORKTOP
14	1	EXIST	FBD FROZEN COKE MACHINE	OWNER (G)	OPS(S)	208-1	30				CORD & PLUG, OUTLET 18"H/18" IN UNDER
15	1	NIESA/	TAVIOD CHAKE/COET CEDVE MAA CHINE	1101/	ODC(C)	200.2	24		-		DRINK BAR
15 16A	1	NEW NEW	•	H&K H&K	OPS(S) GC	208-3	24		3/41.D.		CORD & PLUG
16B	1	NEW	HOSHIZAKI ICE CUBER ACTUAL		OPS(S)	208-1	10.7	1/2 C	3/41.0.		CORD & PLUG, INSTALL 120V POWER CABLE
			MAKE/MODEL OF EXISTING UNIT MAY VARY-					'			FROM UNIT TO ROOFTOP CONDENSER, 6'
			-EXISTING CONDENSER								CLEARANCE AT REAR
16C	1	NEW		H&K	GC						
17	1	EXIST		OWNER (G)	OPS(S)	120-1	15	1/2 C	-		CORD & PLUG
20 21A	2	NEW NEW	FIRE SUPPRESSIONMANUAL PULL STATION H/K MAIN PREP BOARD/SPECIALTY	H&K H&K	GC GC	120/208-3, 115-1	150		+		CONTAINS 150 MLO LOAD CENTERPANEL [
21A 21B	1	NEW	<u> </u>	H&K	GC	120/208-3, 113-1	150				CONTAINS 150 WILD LOAD CENTERPANEL L
21C	1	NEW		H&K	GC	120-1		<u> </u>	†		CORD &PLUG
21D	1	NEW		H&K	GC						
	23 1	NEW		H&K	GC	208-1	5				REFERENCE MECHANICAL PLANS FOR SPECS
			CURB/CORDS7'-7" WITH ANSUL								IF NEW HOOD TO BE INSTALLED
24	1	EXIST		OWNER (G)	GC	120-1	2		1	3/4 GAS	
25 26	1	EXIST		OWNER OWNER	GC GC	120-1 120-1	5.7 6.9		+		CORD &PLUB CORD & PLUG
20 27	LOT	EXIST		STROEHMAN		120-1	0.5		1	1	COND & LOU
28	1	EXIST		OWNER	GC	120-1	6.9				CORD & PLUG
	29 2	EXIST	RTI SHORTENING STORAGE TANK			120-1	20				CORD AND PLUG, QUAD OUTLET @ 90" AFF
	30 1	EXIST		OWNER	GC	120-2, 208-1	21				CORD & PLUG
31	SET	EXIST		OWNER (G)	GC	115-1	0.7 EACH		1	3/4 EACH	60,000 EA CORD & PLUG
32	33 1	NEW EXIST	•	H&K OWNER	GC GC	120-1 208-1	3		1		REFERENCE MECHANICAL PLANS FOR SPECS
	33 1	EXIST	CURB/CORDS5'-7" WALL MOUNT	OWNER	GC	208-1					IF NEW HOOD TO BE INSTALLED
			W/ANSUL (TO BE RELOCATED)				3				II NEW HOOD TO BE INSTALLED
36	1	EXIST		OWNER (G)	GC	208-3	27				OUTLET MOUNTED UNDER HOOD
37	1	EXIST	24 X 24 MOBILE WORK TABLE	OWNER (G)	GC						MOBILE, WITH BACKSPLASH
38	1	EXIST		OWNER	GC				1		
40	1	EXIST	WALK-IN-BOX COOLER/FREEZER			208/230-3			3" H.D.		CONFIRM MANUFACTURER REQUIREMENTS
			(COOLER REFRIGERATION TO BE REPLACED BYOWNER)			(2)208/230-1 115 1, 120-1	1				CHECK LOCAL CODE REQUIREMENTS FOR CONDENSATE LINE
41	LOT	EXIST	METRO SHELVINGCOLD STORAGE			1, 120-1					CONDENSATE LINE
42	LOT	EXIST	METRO SHELVINGDRY STORAGE		GC				†		
43	(METRO MOBILE SECURITY UNIT 48"		GC						
44	LOT	EXIST	METRO WALL SHELVING	OWNER (R)	GC						
49	1	NEW	,	H&K	GC						CORD & PLUG, ON PANEL D
50	1	EXIST		OWNER (G)	GC						CORD & PLUG, ON PANEL D
51 52	1	EXIST		OWNER (G) OWNER (G)	GC GC				1		CORD & PLUG, ON PANEL D CORD & PLUG, ON PANEL D
53	1	EXIST		OWNER (G)	GC	120-1	3		1		CORD & PLUG
54	1	NEW		H&K	GC	120-1	3				CORD & PLUG
55	2	EXIST	PRINCE CASTLE RAPID VERTICAL TOASTER	OWNER (G)	GC						CORD & PLUG, ON PANEL D
60	1	EXIST	QUAL SERVE 3-COMPARTMENT SINK					(2)1/2	2" I.D.		2 EACH, HOT & COLD WATER & PROVIDE
								H&C			1/2"H HOSE BIB FOR ECOLAB MIXING VALVE
61	1	EXIST	QUAL SERVE 1- COMPARTMENT PREP SINK	11014	66			1/2 H&C	2" I.D.		HAND COAD CANUTIZED & DADED TOWER
62	2	NEW	TABCO SS HAND SINKPEDESTAL STYLE W/FOOT PEDAL	H&K	GC			1/2 H&C	1 1/2"		HAND SOAP, SANITIZER & PAPER TOWEL DISPENSER TO BE PROVIDED
 63	1	NEW	<u> </u>	GC	GC			1/2 H&C			CONSULT OWNER FOR FAUCET & PROVIDE
		<u>L</u>	BASE AND 72"AFF WALL SURROUND					L_	<u></u>		1/2"H HOSE BIB FOR ECOLAB MIXING VALVI
64	1	EXIST	PRINCE CASTLE SABER KING MULTI-SLICER	OWNER (G)							
65	1	EXIST	NAVIEN TANKLESS WATER HEATER					3/4 H&C		1/2 GAS	2" VENT, 1/2" RECIRCULATION LINE FROM
	60 4	EVICT	OFFICE FILE CARINET	OWNED				1	1	1	W/H TO LAST HAND SINK BY DRIVE-THRU
	68 1 LOT	EXIST		OWNER							LID I AMINIATE: FOG GRAV
69 70	1	EXIST		OWNER OWNER				1	+		HP LAMINATE: FOG GRAY
70 71	2	EXIST		OWNER (R)	GC				1		STACK ON TOP (2) HIGH, 48" MAX HT BAR
72	2	NEW	BAG-IN-BOX SYRUP RACK	OWNER	OPS(S)						
73	1	NEW		H&K	OPS(S)			3/4 C			FEEDS WATER BOOSTER @ SODA SYSTEM
74	1	EXIST	BULK CO2	014/11/22	66					1	
79 Rn	1	EXIST NEW		OWNER GC	GC GC				1		
80 81	1	NEW		GC	GC			 	+	 	
90	6	1127		OWNER (T)	OPS(T)	115-1	1.2				
90A	LOT			OWNER (T)	OPS(T)	115-1	1.2	<u>L</u>			
90B	4		SICOM CASH DRAWER (NOT SHOWN)	OWNER (T)	OPS(T)						
90C	1	<u> </u>	· · · · · · · · · · · · · · · · · · ·	OWNER (T)	OPS(T)	115-1	1.2		1	1	
91	1	EXIST	OFFICE COUNTERTOPLAMINATE			420.4	44.			1	HP LAMINATE: FOG GRAY
92 93	1	EXIST NEW	KAY DISHWASHER SICOM CREW LINK DISPLAY	OWNER (T)	ODSITY	120-1 115-1	11.4	-	2"		CORD & PLUG
93 94	1	EXIST		OWNER (T)	OPS(T)	115-1	7.8	 	+	 	
95	12	NEW		OWNER (I)	0.5(1)	1101	7.0		1		
96	1	EXIST	POU 10 GAL. WATER HEATER FOR D/W			208-1	28.8	3/4 H	3/41.D.	L_	DIRECT WIRE W/DISCONNECT
97	1	EXIST	DRIVE-THRU COUNTERTOPSS								
98		EXIST		OWNER (T)	OPS(T)	115-1					
99	1	EXIST	WATER SOFTENER					<u> </u>	1		
ı	1	EXIST	TRASH COMPACTORMARATHON							1	

NOTE: EQUIPMENT USED WILL BE BOTH NEW AND EXISTING. REFER TO H&K KITCHEN SUPPLIER PLAN FOR NEW EQUIPMENT ORDERED. NOTE THAT KEY NUMBERS MAY BE IN DECIMAL FORM ON SOME PLANS, BUT IN MOST CASES THE BASE NUMBER WILL INDICATE THE SAME PIECE OF EQUIPMENT, OR PART OF AN EQUIPMENT GROUP, IF IT HAS THE SAME BASE NUMBER.

REMOTE POWER CONTROL

VERIFY ALL NEW EQUIPMENT CONNECTIONS W/EQUIPMENT SUPPLIER ORDER PRIOR TO INSTALLATION

PAK'NTAINER MPT-6RL

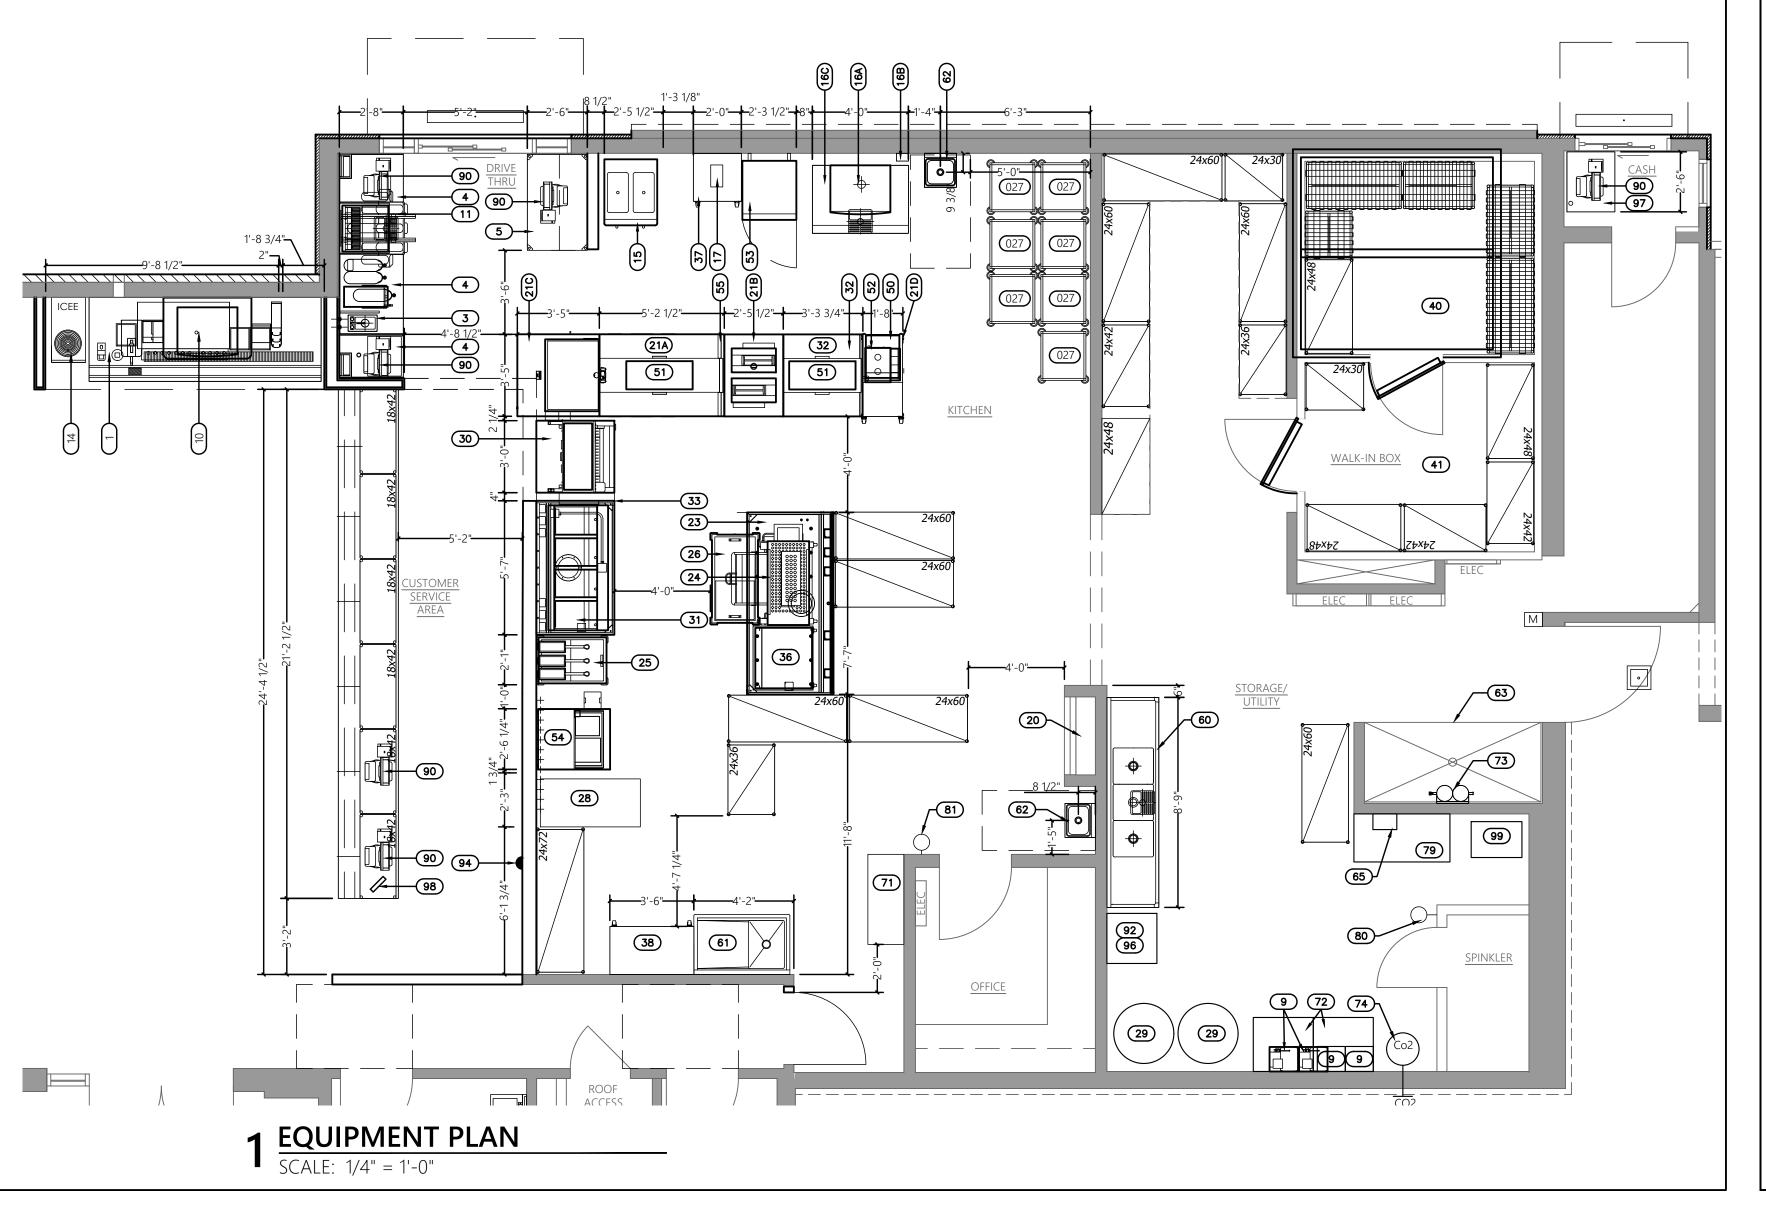

PERMIT DOCUMENTS

06-14-21

REV1: 1/12/22 REV2

ARCHITECT OF RECORD: Samantha Ciotti Falcone

OWNER OF RECORD:

ABIII, LLC

ARCHITECTURE LLC

3515 Sunnyside Road Center Valley, PA 18034 T: 610-297-0140 E: sam@scf-arch.com

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> **EQUIPMENT** PLAN

MEASURED FROM THE BASELINE OF THE LOWEST TACTILE CHARACTER AND 60" MAX. FROM THE BASELINE OF THE HIGHEST TACTILE CHARACTER. 5 LBS. MAXIMUM OPERATING FORCE AND CLOSING SPEED 5 SECONDS MINIMUM -SIGNAGE TO BE AT LATCH SIDE (OR ADJ. WALL) -"GRADE 2" BRAILLE AREA EGGSHELL MATTE, NON-GLARE, 70% CONTRAST MINIMUM RESTROOM ILLUM. 30-70 FT. CANDLES (INT) LETTERS: 1" UPPERCASE AT OR BELOW 66". ABOVE 66" 3" U.C.

2 TYPICAL RESTROOM SIGN DETAIL
SCALE: 1/2" = 1'-0"

RESTROOM/KITCHEN ACCESSORIES


NOTE: SOAP AND HAND SANITIZER DISPENSERS TO BE PROVIDED AT EACH KITCHEN HANDSINK.

- (A) GRAB BAR: BOBRICK 250 LBF. MINIMUM 33" MIN. TO 36" MAX. HEIGHT TO THE TOP OF THE GRIPPING SURFACE FOR HORIZONTAL GRAB BARS. A VERTICAL GRAB BAR 18" MIN IN LENGTH SHALL BE MOUNTED WITH THE BOTTOM OF THE BAR LOCATED 39 INCHES MIN AND 41 INCHES MAX ABOVE FLOOR, AND WITH THE CENTER LINE OF THE BAR LOCATED 39 INCHES MIN AND 41 INCHES MAX FROM REAR WALL.
- PROVIDE THE REQUIRED QUANTITY AND LENGTH AS INDICATED ON THE DRAWINGS OR AS REQUIRED BY THE GOVERNING CODE. THE BAR SHALL BE 1-1/2" IN DIAMETER AND MOUNTED WITH 1-1/2" CLEARANCE FROM THE WALL.
- -GRAB BARS, AND ANY WALL OR OTHER SURFACE ADJACENT TO GRAB BARS, SHALL BE FREE OF SHARP OR ABRASIVE ELEMENTS. EDGES SHALL BE ROUNDED. -GRAB BARS SHALL NOT ROTATE IN THEIR FITTINGS
- -STRUCTURAL STRENGTH: ALLOWABLE STRESSES SHALL NOT BE EXCEEDED FOR MATERIALS USED WHERE A VERTICAL OR HORIZONTAL FORCE OF 250 POUNDS IS APPLIED AT ANY POINT ON THE GRAB BAR, FASTER, MOUNTING DEVICE, OR SUPPORTING STRUCTURE.
- -WITHIN STUDS WALLS TO WHICH GRAB BARS WILL BE MOUNTED, PROVIDE SOLID WOOD BLOCKING FOR ATTACHMENT OF GRAB BARS, SECURELY ANCHORED TO FRAMING AND OF SUFFICIENT SIZE AND STRENGTH TO ACHIEVE THE STRUCTURAL STRENGTH REQUIREMENTS FOR GRAB BARS SPECIFIED HEREIN.
- (B) WALL MOUNTED SOAP DISPENSER AND HAND SANITIZER DISPENSER SUPPLIED BY PRODUCT SUPPLIER
- (C) MIRROR: (BOTTOM OF REFLECTIVE SURFACE AT 40" MAXIMUM HEIGHT) MODEL B-165-1836 (18"x36") STAINLESS STEEL CHANNEL FRAME MIRROR WITH THEFT RESISTANT SCREWS BY BOBRICK OR APPROVED EQUIVALENT.
- (D) TOILET PAPER HOLDER: 9" TWIN JUMBO MODEL. SUPPLIED BY PRODUCT SUPPLIER.
- (E) HANDS FREE PAPER TOWEL DISPENSER WITH FREESTANDING WASTE RECEPTACLE SUPPLIED BY PRODUCT SUPPLIER, WASTE RECEPTACLE BY OWNER.

 NOTE: PROVIDE PAPER TOWEL DISPENSER AT EACH HAND SINK IN KITCHEN.
- F BABY CHANGING STATION: KOALA KARE #KB208-01 (HORIZONTAL, 34"W X 21 "H X 4"D) OR #KB101-01 (VERTICAL, 22"W X 35.5"H X 4"D) WALL MOUNTED WITH MICORBAN GREY. SANITARY BED LINERS FOR BABY CHANGING STATION: KOALA KARE #KB150-99 NOTE: CHANGING STATION OPTION TO COMPLY WITH ALL ACCESSIBILITY REQUIREMENTS.
- **G** URINAL SCREEN
- (H) SANITARY NAPKIN WAST DISPOSAL, FREESTANDING, WITH LID. SUPPLIED BY OWNER.
- (J) COAT HOOK: BOBRICK MODEL B-6717 TO BE MOUNTED ON INSIDE OF EACH RESTROOM DOOR FOR SINGLE OCCUPANCE RESTROOMS AND EACH RESTROOM STALL DOOR FOR MULTIPLE OCCUPANCY RESTROOMS. MOUNT AT 38"-40" A.F.F. FOR ADA ACCESSIBLE LOCATIONS AND AT 48" A.F.F. MAXIMUM FOR NON-ADA ACCESSIBLE LOCATIONS.
- K TOILET STALL PARTITIONS: BOBRICK 1080/1180 DURALINE SERIES #EO-09 COLOR: EVENING TIGRIS 4674-60 NOTE: THE HC STALL DOOR SHALL BE SELF-CLOSING, AND A DOOR PULL COMPLYING WITH ANSI A117.1 SECTION 404.2.6 SHALL BE PLACED ON BOTH SIDES OF DOOR NEAR LATCH.
- (L) BABY CHANGING STATION RECESSED KOALA KARE BABY CHANGING STATION #KB100-ST. ROUGH OPENING DIMS 35 1/2"x20 1/2"x4 1/4" D RECESS

GENERAL NOTES

- FOR INTERIOR FINISHES REFER TO DECOR PLANS.
- PLUMBING FIXTURES TO BE PROVIDED
- BY THE GENERAL CONTRACTOR, EXCEPT AS NOTED.
- ALL PLUMBING FIXTURES, FAUCETS AND
- ACCESSORIES TO BE ADA COMPLIANT
- ALL EXPOSED PIPING UNDER LAVATORIES TO BE INSULATED TO PROTECT FROM CONTACT. THERE SHALL BE NO SHARP OR ABRASIVE SURFACES UNDER LAVATORIES.

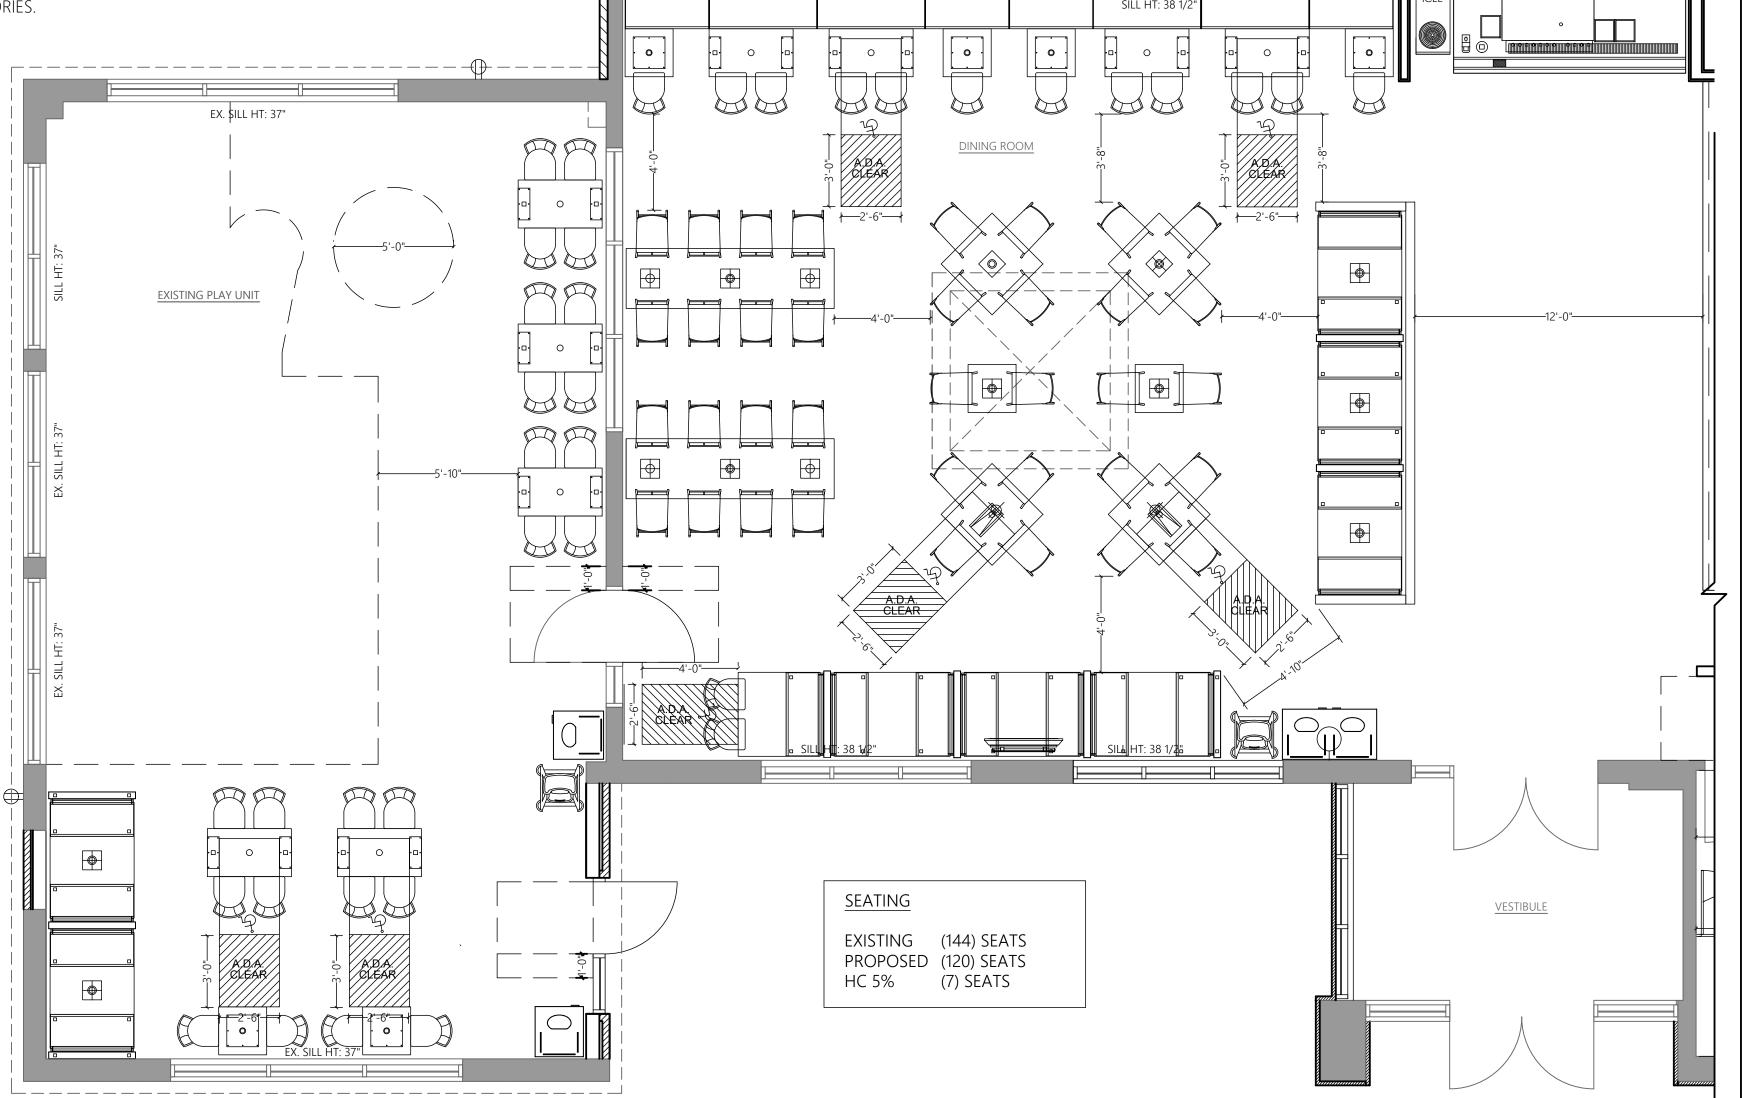

3 SEATING PLAN
SCALE: 1/4" = 1'-0"

PERMIT DOCUMENTS

REFER TO DECOR PLANS FOR DETAIL ON FURNITURE AND FINISHES

06-14-21

REV1: 1/12/22

ARCHITECT OF RECORD: Samantha Ciotti Falcone AIA, LEED AP DRAWN BY: MSF

OWNER OF RECORD:


ABIII, LLC

ARCHITECTURE


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SEATING PLAN TOILET ROOMS A2.5



REFER TO DECOR PACKAGE FOR FINISH SCHEDULE

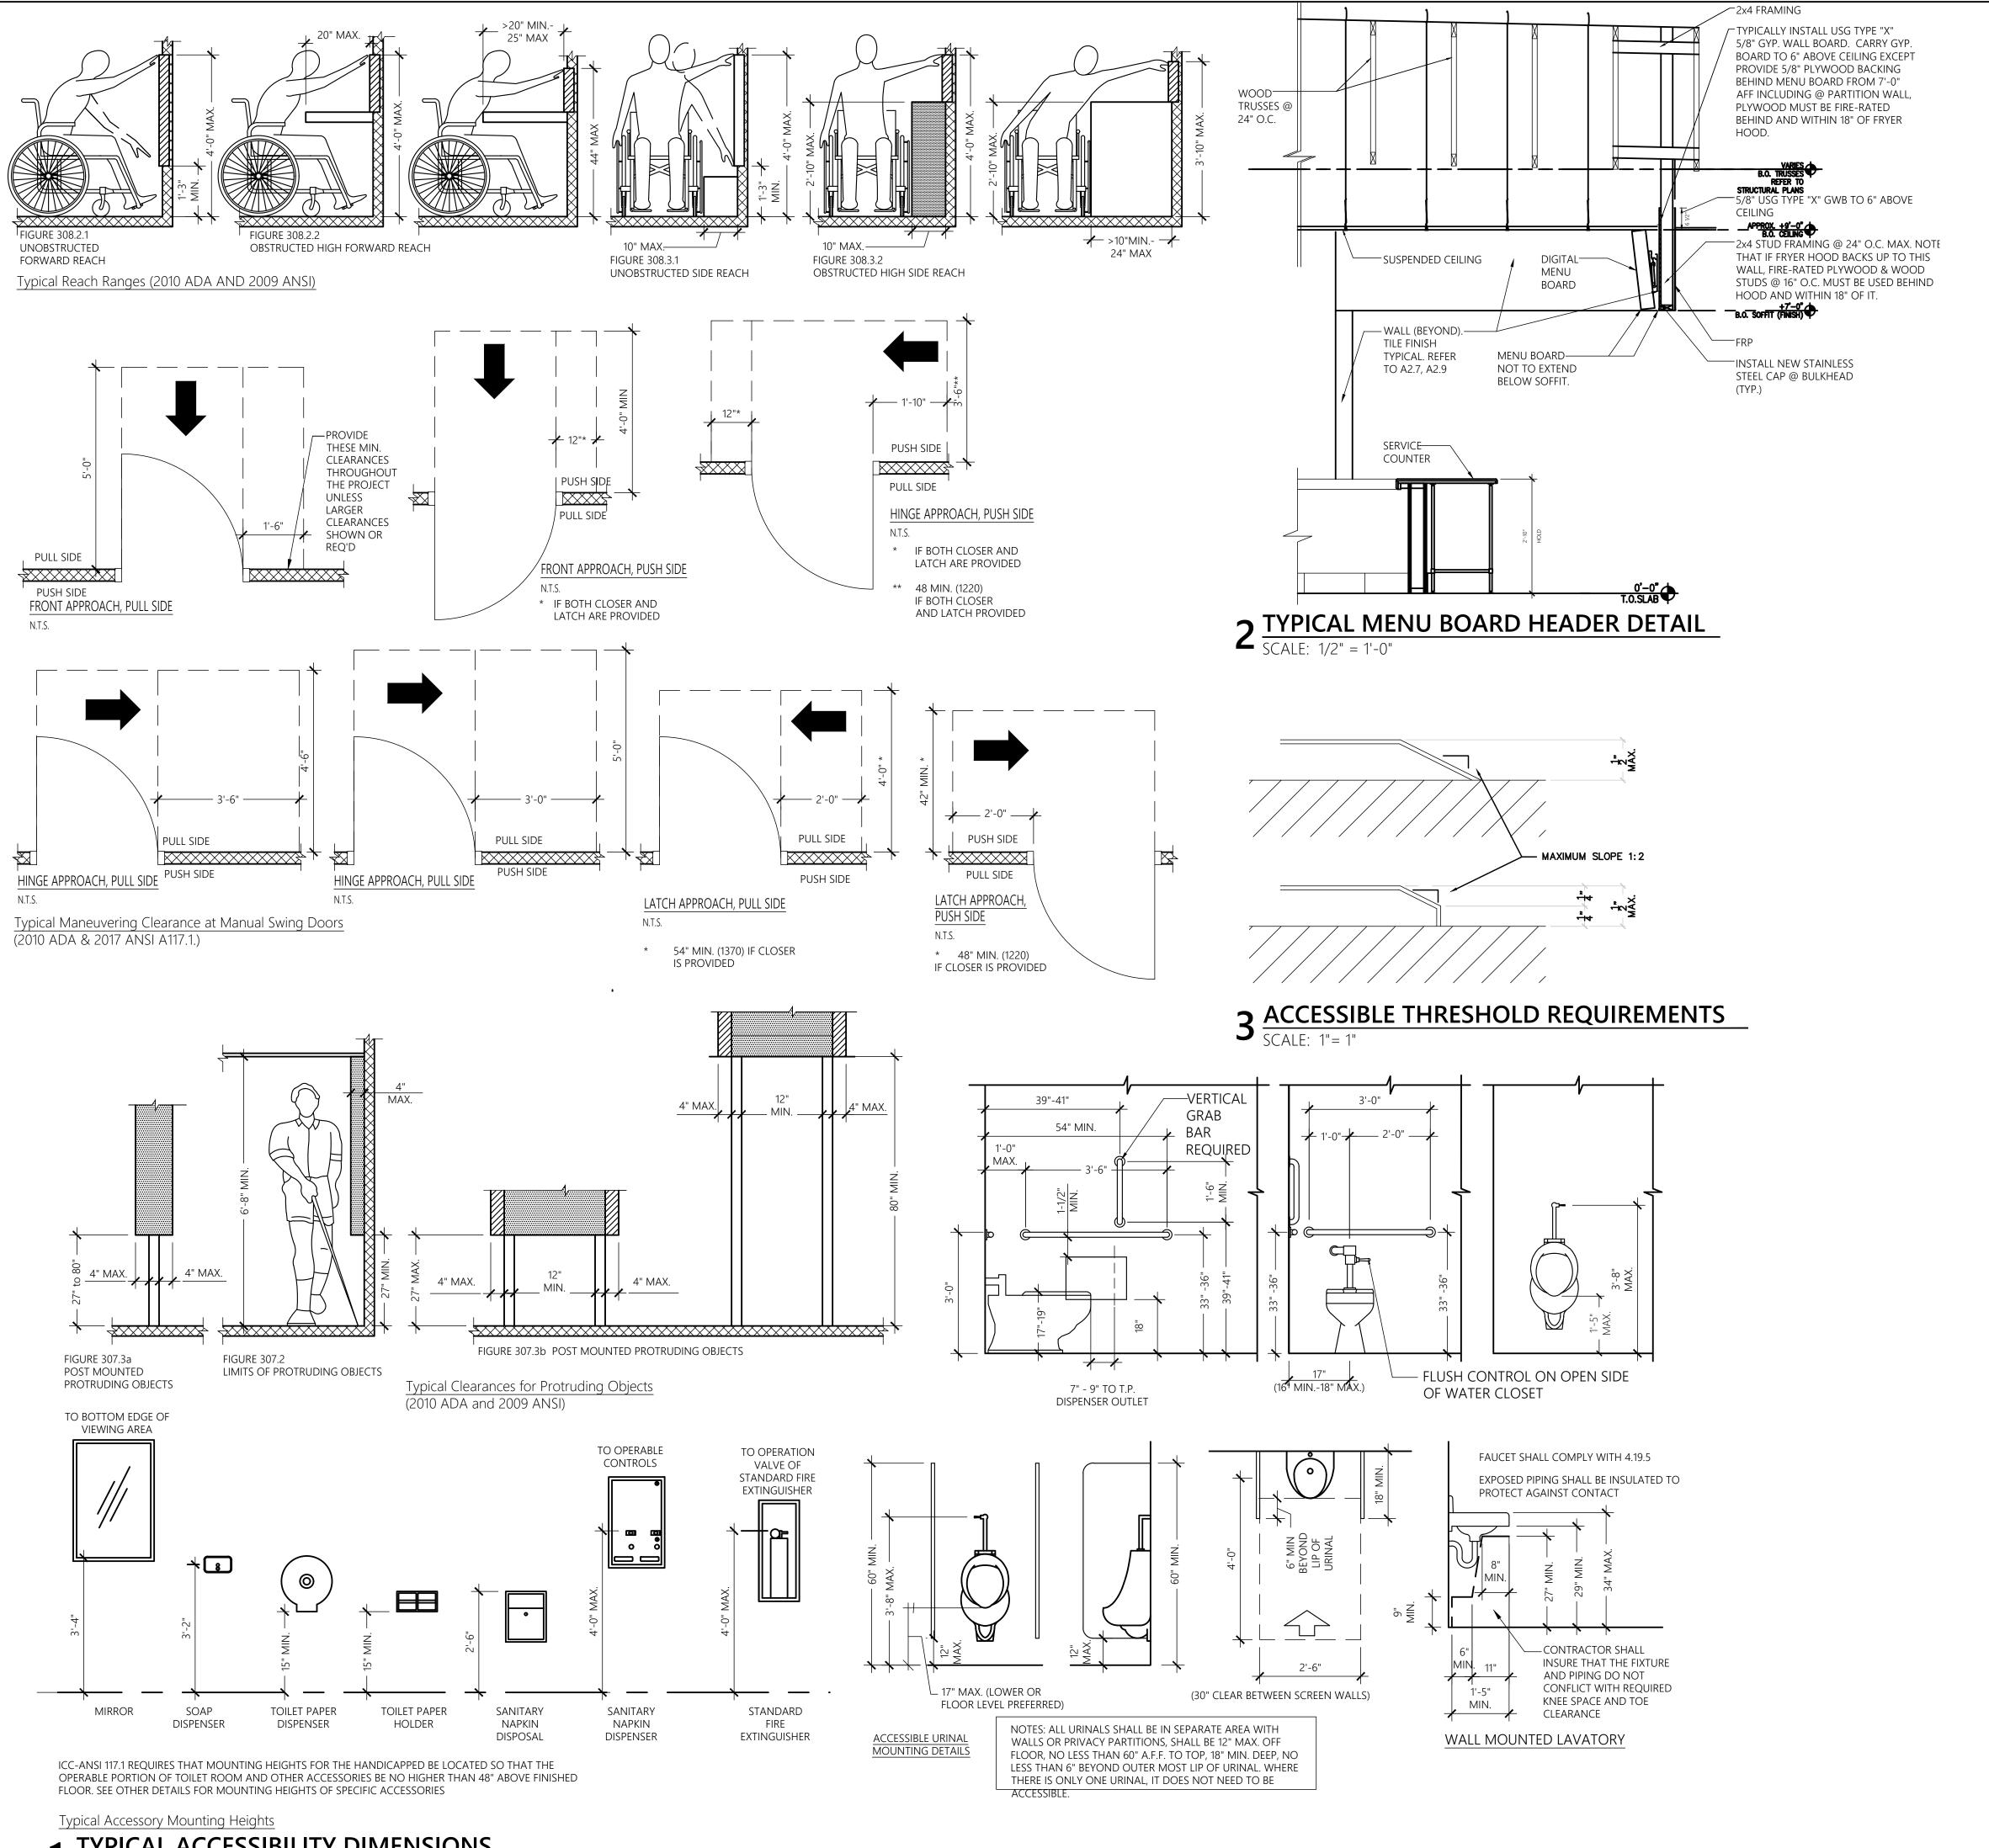

4 SERVICE COUNTER SECTION DETAIL SCALE: 3/4" = 1'-0"

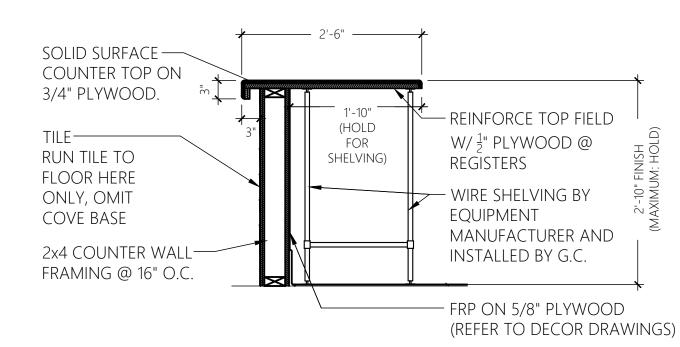REFER TO DECOR PLANS FOR COUNTER TOP DESIGN

PERMIT DOCUMENTS

06-14-21

REV1: 1/12/22 REV2

ARCHITECT OF RECORD:

Samantha Ciotti Falcone

OWNER OF RECORD:

ABIII, LLC

AIA, LEED AP

RESTAURANT #35

ALTERATIONS TO EXISTING RESTAURA
100 N. West End Boulevard
Quakertown, PA 18951
Richland Township, Bucks County

SEF ARCHITECTURE


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ACCESSIBILITY

A2.6



06-14-21

REV1: 1/12/22 REV2

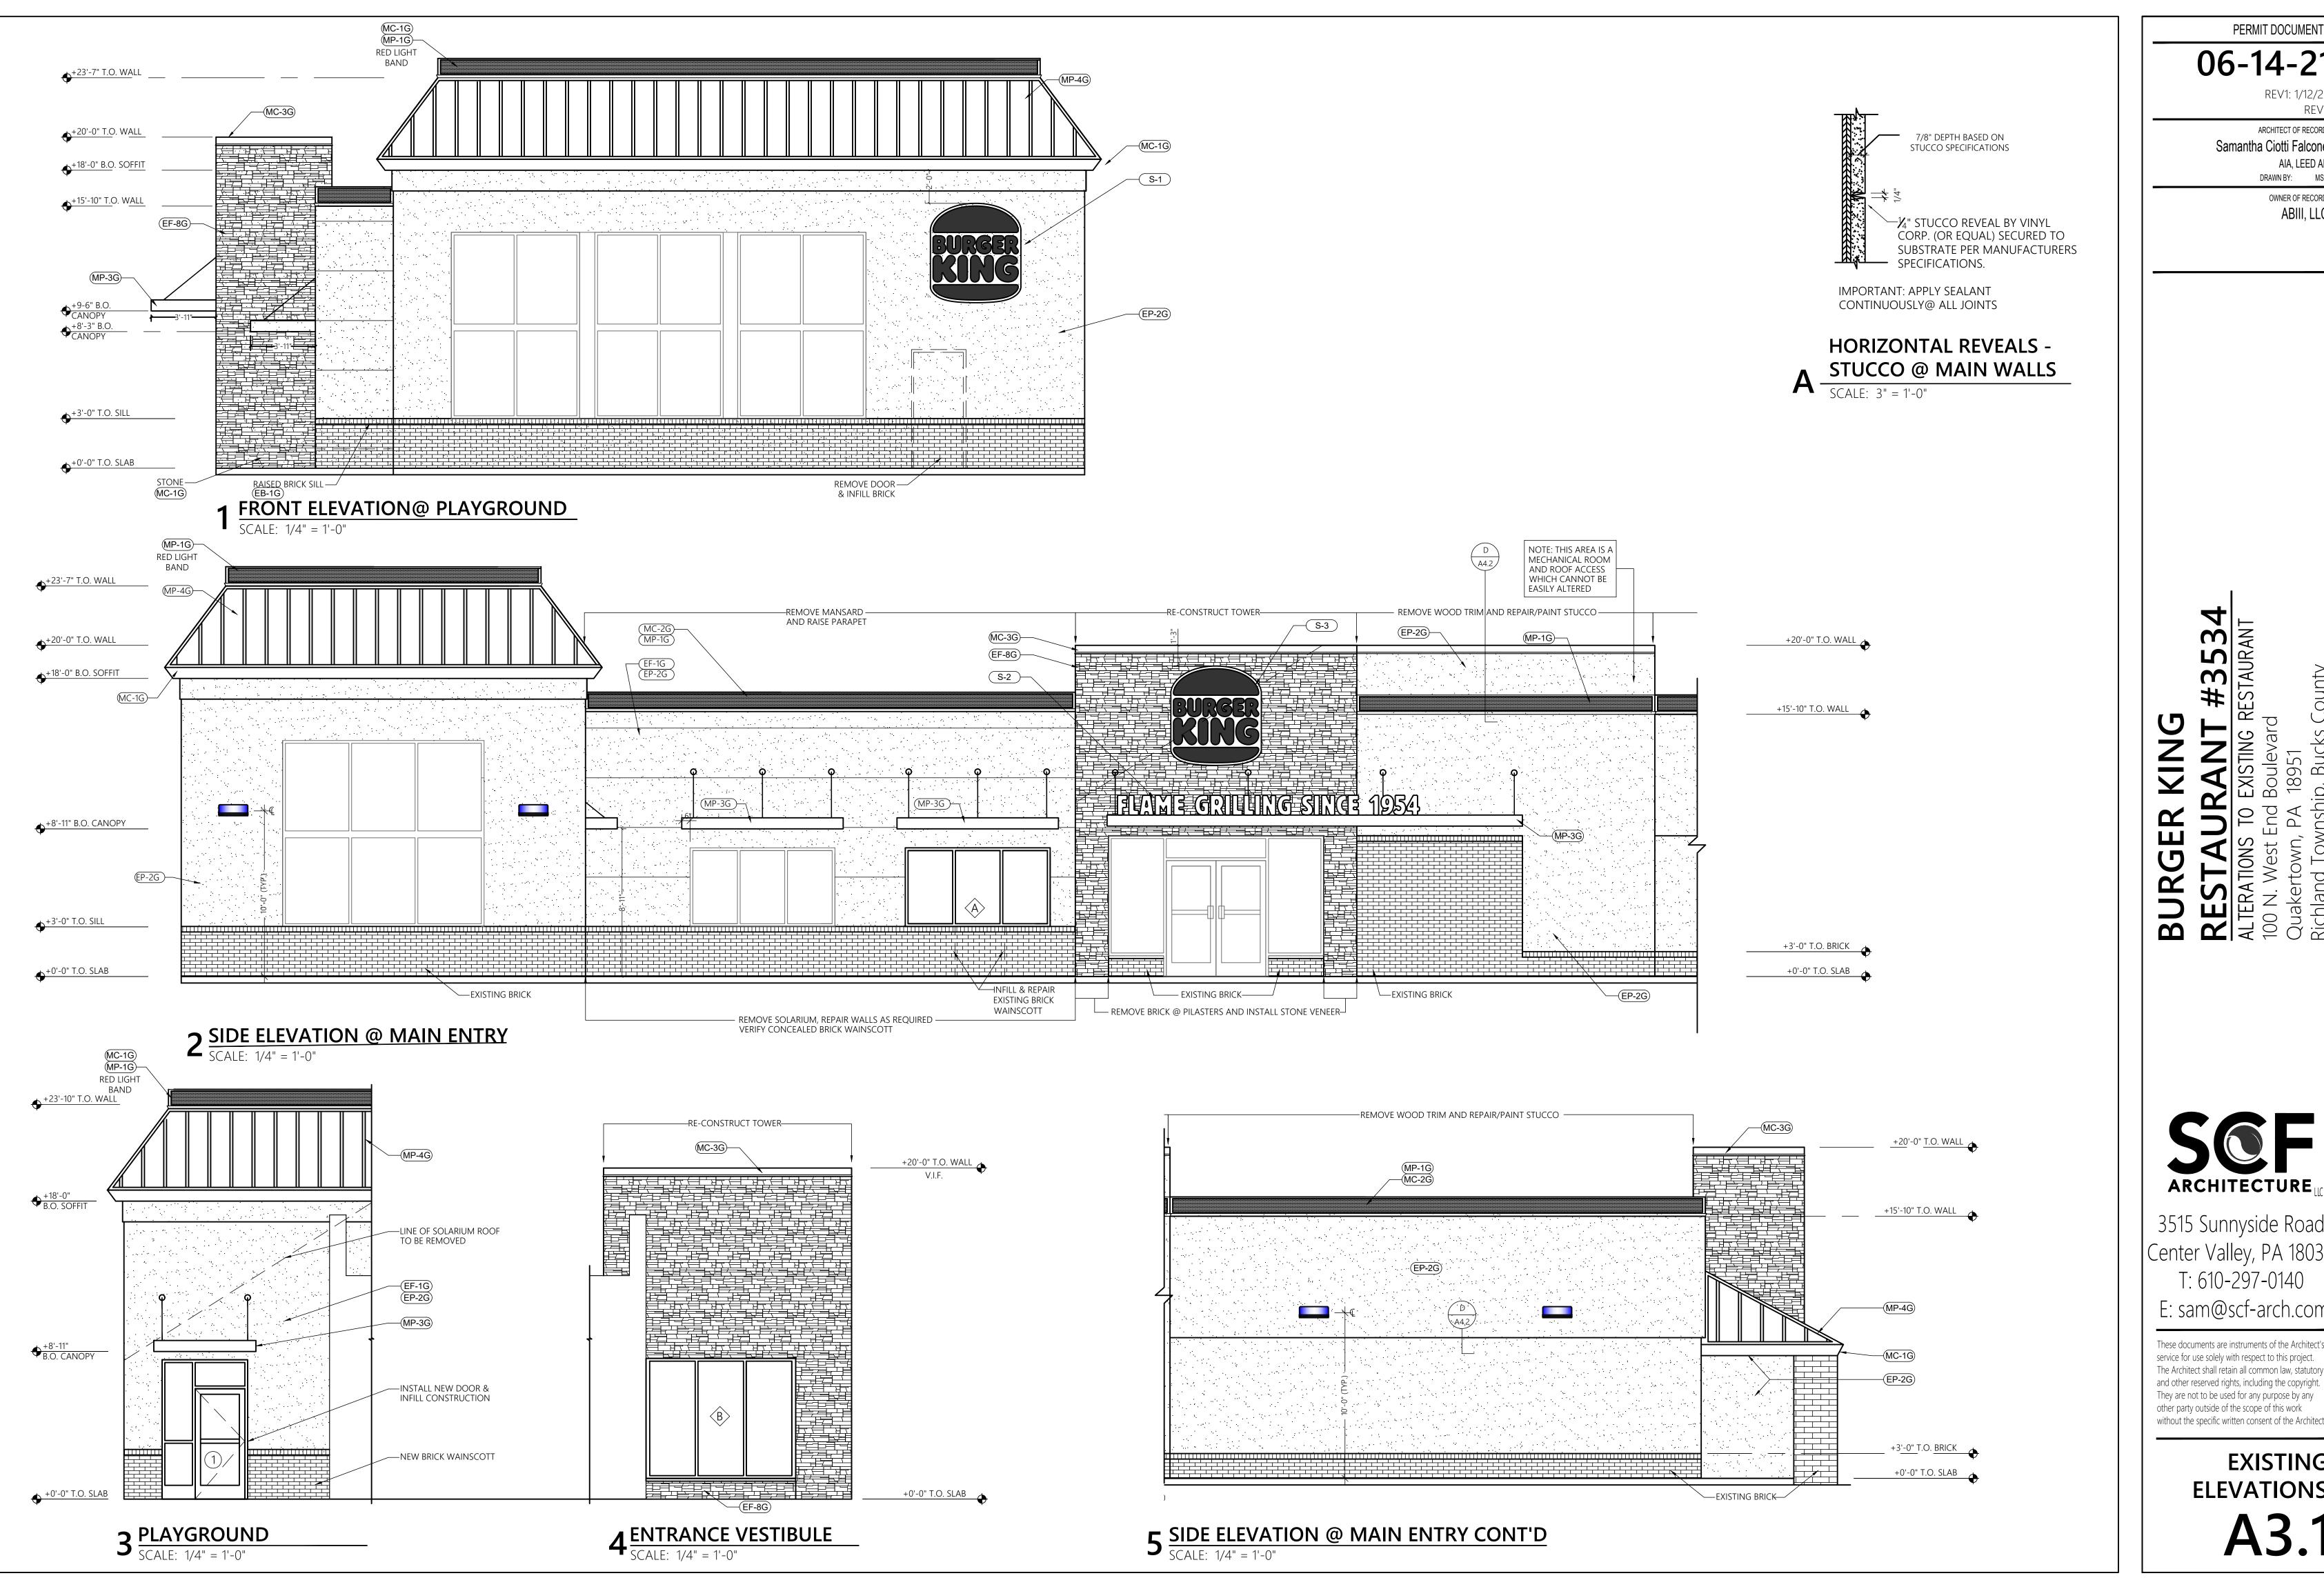ARCHITECT OF RECORD: Samantha Ciotti Falcone AIA, LEED AP

> DRAWN BY: MSR OWNER OF RECORD: ABIII, LLC


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> **EXISTING ELEVATIONS**



06-14-21

REV1: 1/12, RE

ARCHITECT OF RECORD:
Samantha Ciotti Falcone

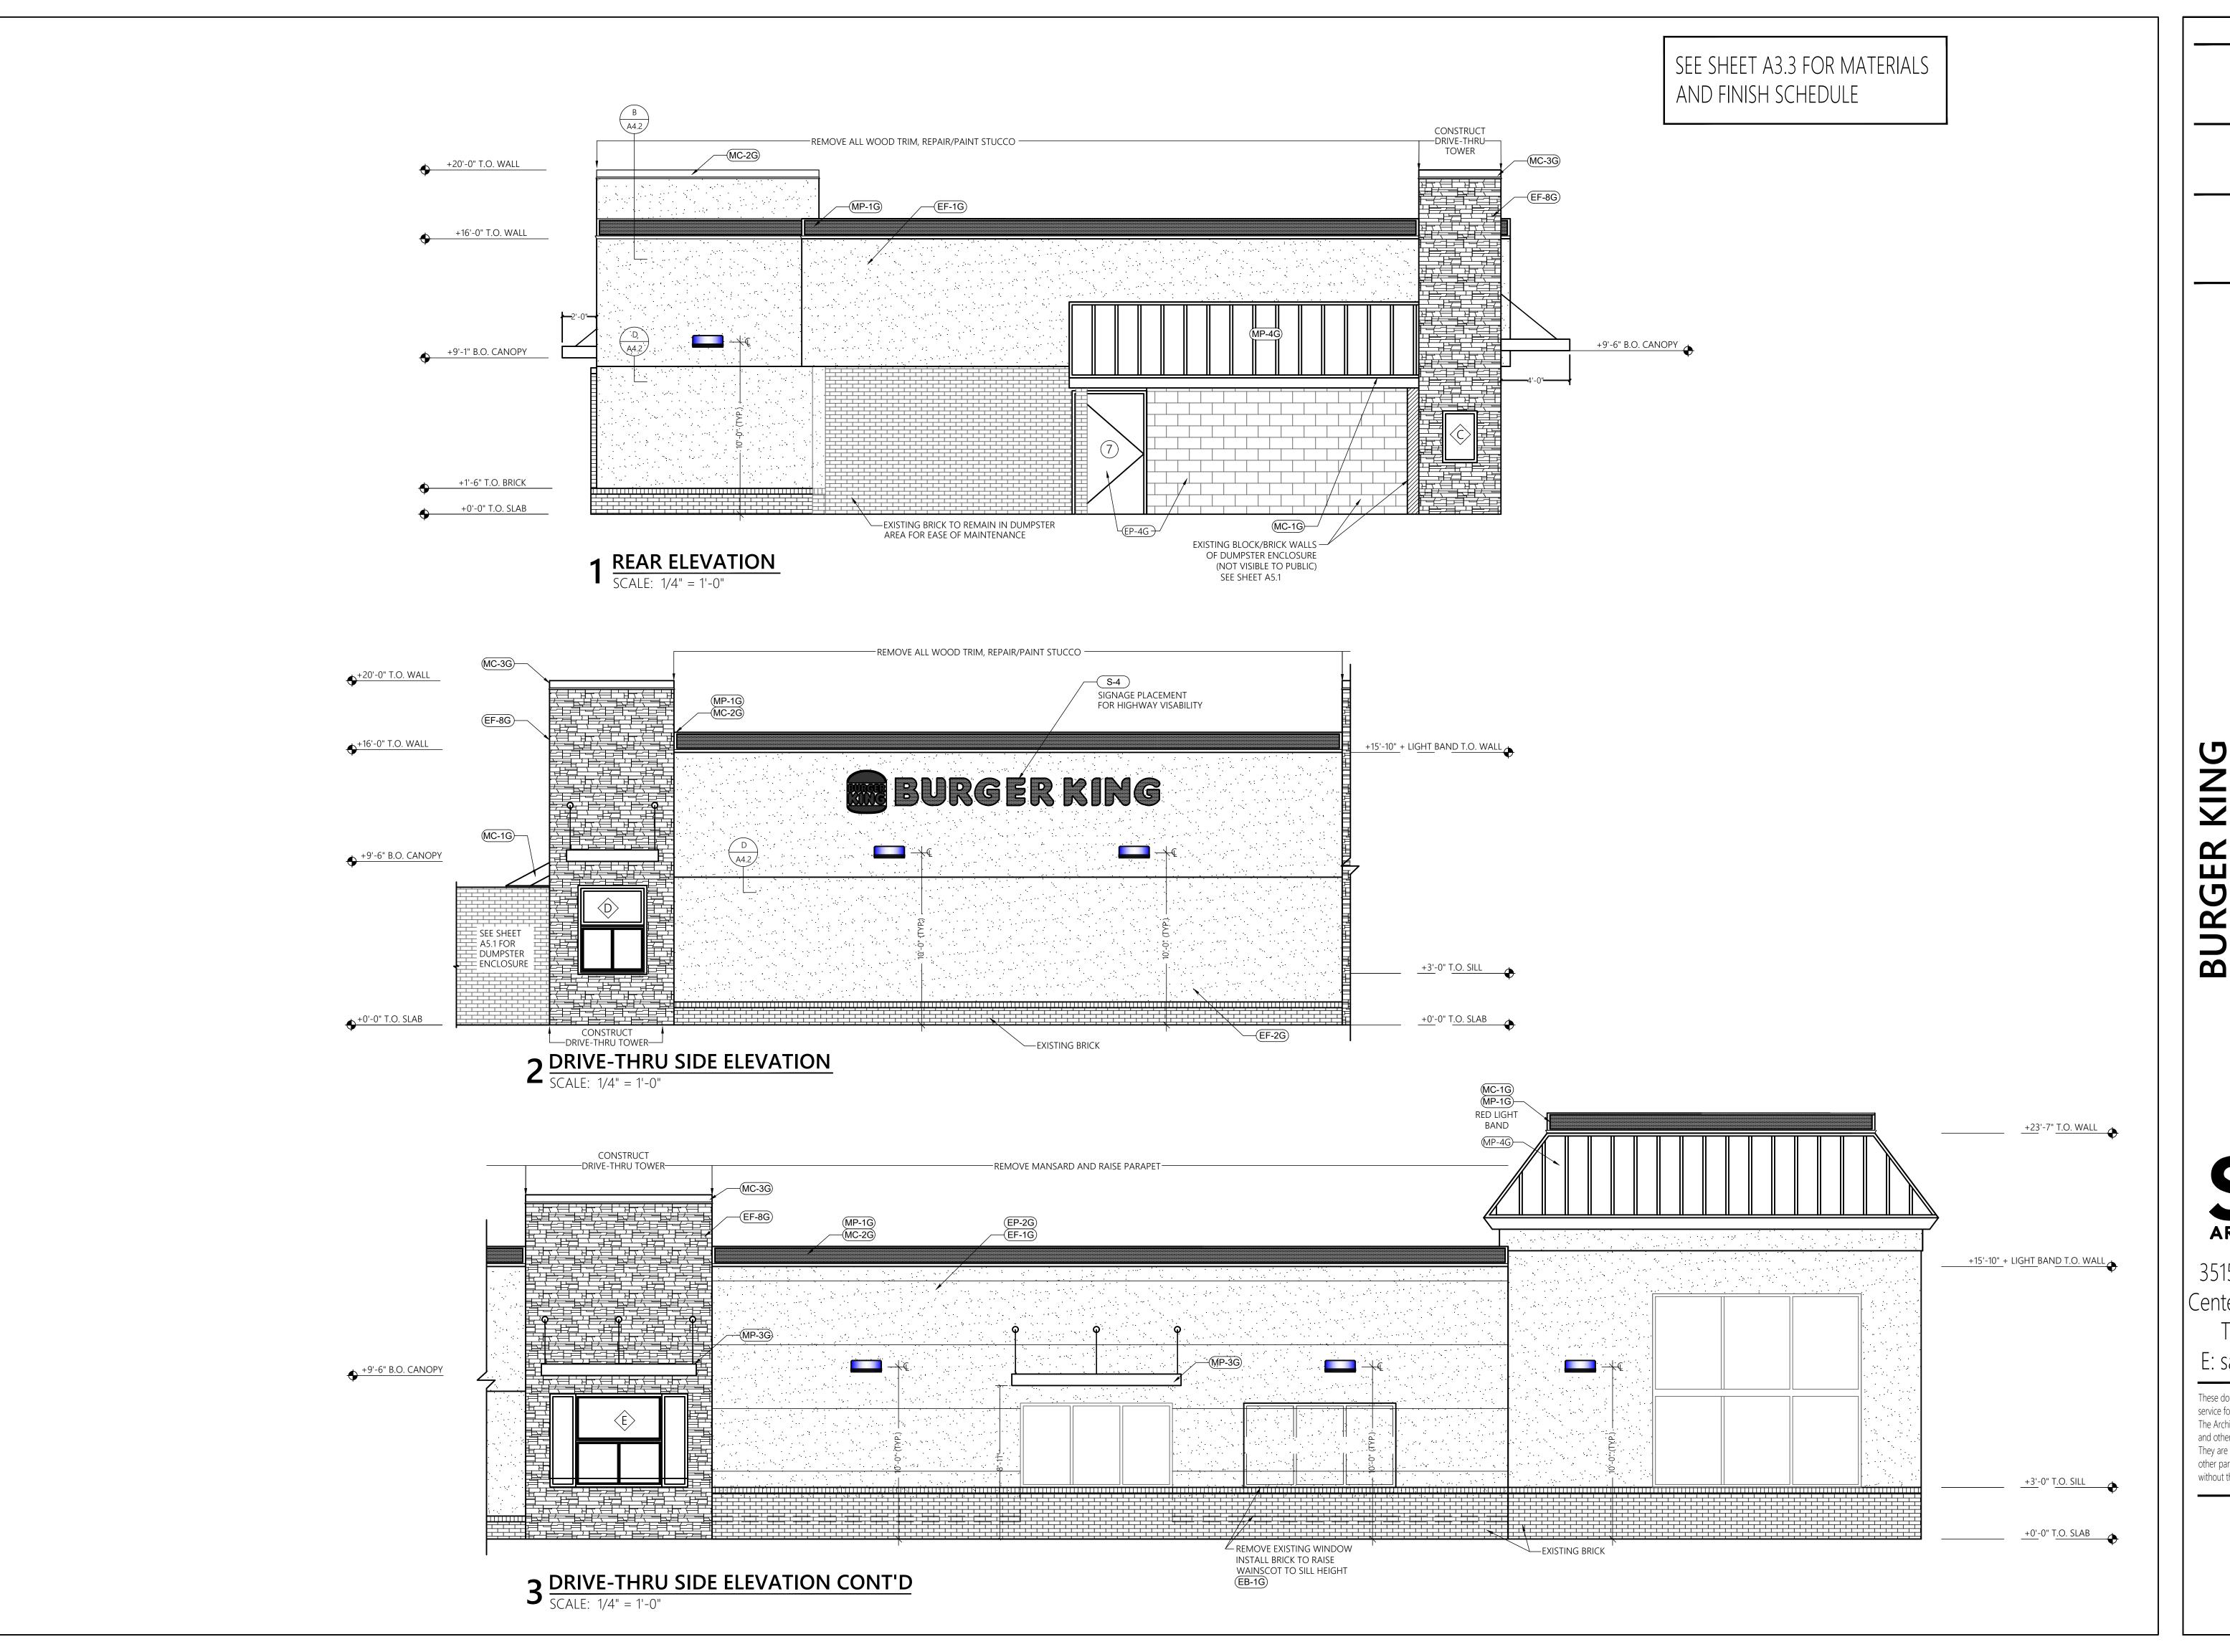OWNER OF RECORD:

DRAWN BY: MSR

SEF ARCHITECTURE

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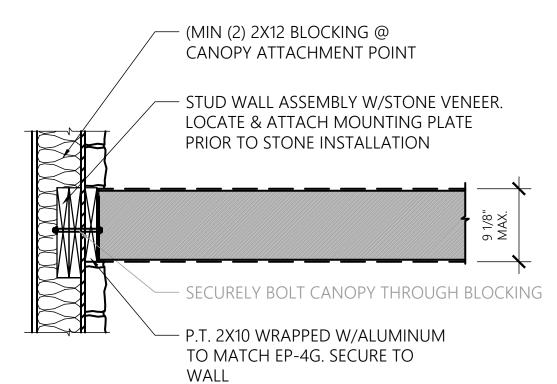
EXISTING ELEVATIONS

A3.2

EXTERIOR FINISH SCHEDULE

CODE	MATERIAL	LOCATION	MANUFACTURER	PRODUCT	SIZE	NOTES
EB-1G	BRICK	WAINSCOT	ANY	FACE BRICK TO MATCH		SAVE DEMO BRICK FOR RE-USE
				EXISTING		TO INFILL AT SMALLER
				FOR LARGER AREAS		OPENINGS
EF-1G	STUCCO	GENERAL	APPROVED STUCCO	COLOR TO MATCH		FOR NEW STUCCO WALL AREAS
		WALL	SYSTEM	EP-2G		PAINT EP-2G FOR COLOR
				"TAUPE TONE"		UNIFORMITY
EF-8G	STONE VENEER	TOWERS	ENVIRONMENTAL	LEDGESTONE		USE EGR-3G, MATCHING SILL
			STONE WORKS	(NOT SOUTHERN)		CAP AND FLAT WALL CAP
				"BUCKS COUNTY"		14" W X 1.75" TH X 48" L
						WHERE APPLICABLE
EGR-3G	GROUT	MASONRY	ANY	STANDARD BUFF		BLEND WITH EP-2G AND
						STONE
EP-2G	EXTERIOR	GENERAL	SHERWIN WILLIAMS	SW7633		PAINT ALL NEW AND EXISTING
	PAINT	WALL		"TAUPE TONE"		STUCCO WALLS
EP-4G	EXTERIOR	GENERAL	SHERWIN WILLIAMS	SW 7515		USE APPROPRIATE PAINT TYPE
	PAINT	ACCENT		"HOMESTEAD BROWN"		FOR SUBSTRATE
MC-1G	METAL COPING	TOWER	ANY	CONTRACTOR TO		MATCH SSM ROOF
		WALLS		MATCH MP-4G		
				SILVER METALLIC		
MC-2G	METAL COPING	PARAPET	ANY	CONTRACTOR TO		FOR STUCCO WALLS
		WALLS		MATCH EP-2G		
				"TAUPE TONE"		
MC-3G	METAL COPING	PARAPET	ANY	CONTRACTOR TO		FOR STONE WALLS
		WALLS		MATCH EP-4G		
				"HOMESTEAD BROWN"		
MP-1G	LIGHT BAND	PARAPET	LEKTRON	Bk-2020	15"	TOP MOUNT EXCEPT AT FRONT
			THROUGH	191-1016		ENTRY TOWER—SEE A2.3 AND
			ALLEN INDUSTRIES	LIGHT BAND 15" ROC		ELEVATIONS A3.1, A3.2
MP-3G	METAL CANOPY	GENERAL	ALLEN INDUSTRIES	CUSTOM PER BK SPECS,	VARY	CONTACT: ALAN BRYANT,
				REFER TO		ALLEN INDUSTRIES
				MANUFACTURER		1-800-967-2553
				PLANS FOR SPEC'S		IN-WALL BLOCKING REQUIRED

- 1. PAINTING CONTRACTOR SHALL BE RESPONSIBLE FOR FINAL PRIMER/PAINT CHOICE AND METHOD OF APPLICATION ACCORDING TO SUBSTRATE
- MASONRY/TILE CONTRACTOR SHALL BE RESPONSIBLE FOR FINAL GROUT CHOICE AND TYPE ACCORDING TO APPLICATION
- ALL MISC. EQUIPMENT (EXCEPT SIGN POLES) SUCH AS ELECTRICAL BOXES, GAS METER, DUMPSTER POLES, ETC. TO BE PAINTED EP-4G
- SIGN POLES AND CABINETS TO BE BLACK, EXCEPT ROUND LOGO CANS TO BE SILVER (IF APPLICABLE)
- ALL BOLLARDS EXCEPT THOSE IN DUMPSTER AREA TO BE CAPPED WITH STANDARD YELLOW BOLLARD COVER
- BK CORPORATE NOW REQUIRES BLACK CONCRETE IN DRIVE THRU LANE DRIVE SURFACE. REFER TO SITE PLANS FOR DETAILS.
- SUBSTITUTIONS TO SPECIFIED PRODUCTS REQUIRE SAMPLE SUBMISSION AND PRIOR APPROVAL
- NOT ALL MATERIALS WILL BE USED ON EVERY PROJECT



5 CANOPY MOUNTING PLATE @ STONE SCALE: 1" = 1'-0"

CANOPY NOTES

- 1. CANOPIES ARE SHIPPED WITH BULK OF ASSEMBLY COMPLETED.
- 2. ALL CANOPIES ARE LIGHTED. LIGHTING IS SUPPLIED WITH CANOPY AND INSTALLED ON-SITE. REFER TO SIGN PACKAGE (ALLEN INDUSTRIES) AND ELECTRICAL PLANS.
 - BLOCKING (MIN. 2-2X12) FOR CANOPIES DOES NOT HAVE TO BE CONTINUOUS BUT MUST BE INSTALLED IN OPEN FRAMING AT BOTH CANOPY AND CANOPY SUPPORTS AT PROPER HEIGHT AND ATTACHMENT LOCATIONS. IT IS BEST IF CANOPIES ARE AVAILABLE TO VERIFY ATTACHMENT, BUT ATTACHMENT POINTS MAY BE DETERMINED IN ACCORDANCE TO GUIDELINES ON THE SPECIFICATIONS ABOVE, ACCORDING TO THE LENGTH OF EACH CANOPY. ACTUAL CONSTRUCTION MAY VARY BETWEEN MANUFACTURERS.

PERMIT DOCUMENTS

06-14-21

Samantha Ciotti Falcone

BURGE




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> **EXTERIOR FINISHES**



#12'-1" T.O. WALL

EXISTING SHINGLED ROOF

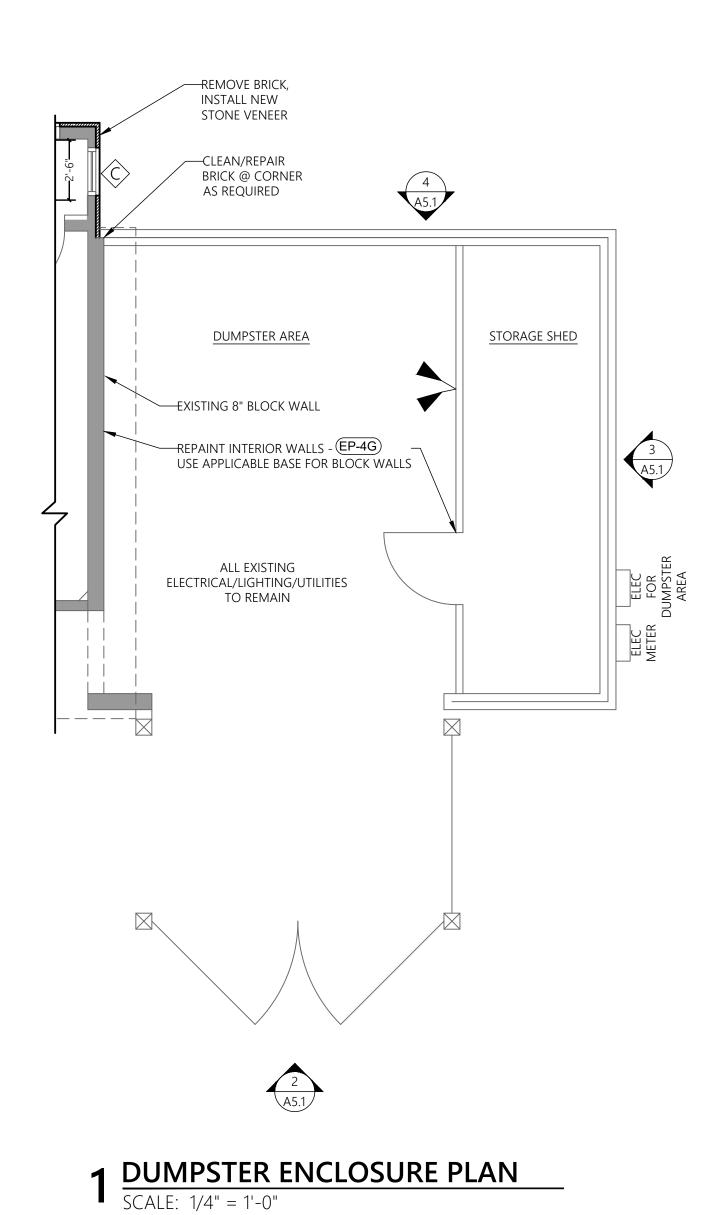
PAINT T-111

EP-4G


+7'-2 1/2" T.O. SLAB

FXISTING BRICK


2 DUMPSTER ENCLOSURE - SIDE ELEVATION
SCALE: 1/4" = 1'-0"

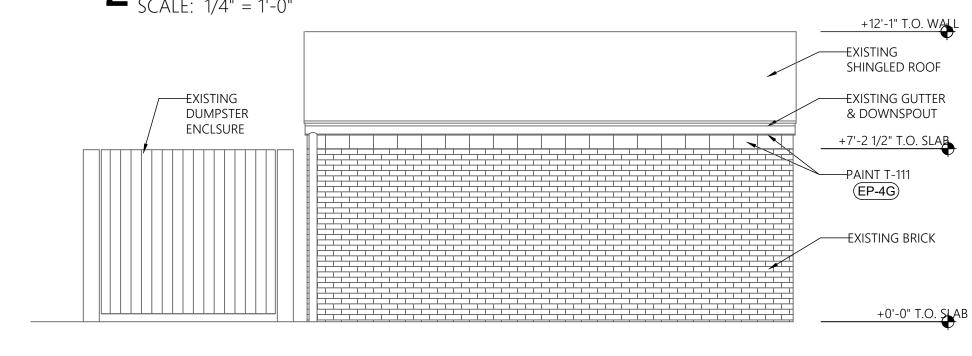

3 DUMPSTER ENCLOSURE - REAR ELEVATION SCALE: 1/4" = 1'-0"

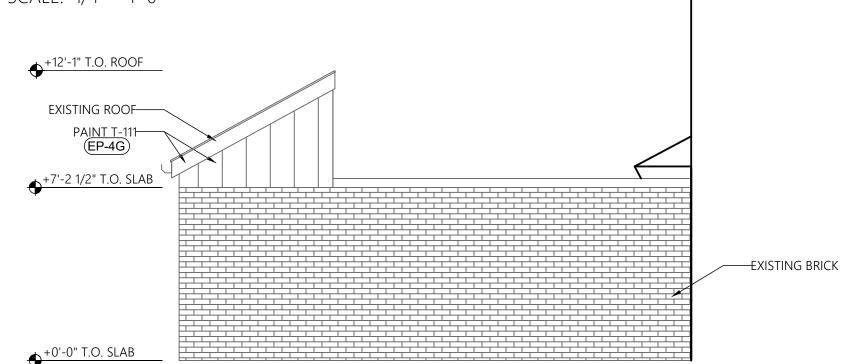

4 DUMPSTER ENCLOSURE - DRIVE- THROUGH ELEVATION SCALE: 1/4" = 1'-0"

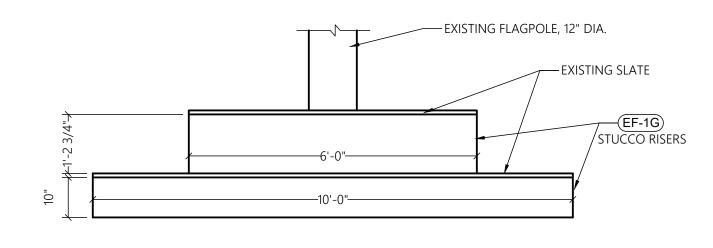

5 FLAG POLE BASE

SCALE: 1/2" = 1'-0"

06-14-21

REV1: 1/12/22

REV2

ARCHITECT OF RECORD:

Samantha Ciotti Falcone

PERMIT DOCUMENTS

DAMANUNA CIOUI FAICONE

AIA, LEED AP

DRAWN BY: MSR

OWNER OF RECORD:

ABIII, LLC

URANT #3534 TO EXISTING RESTAURANT End Boulevard



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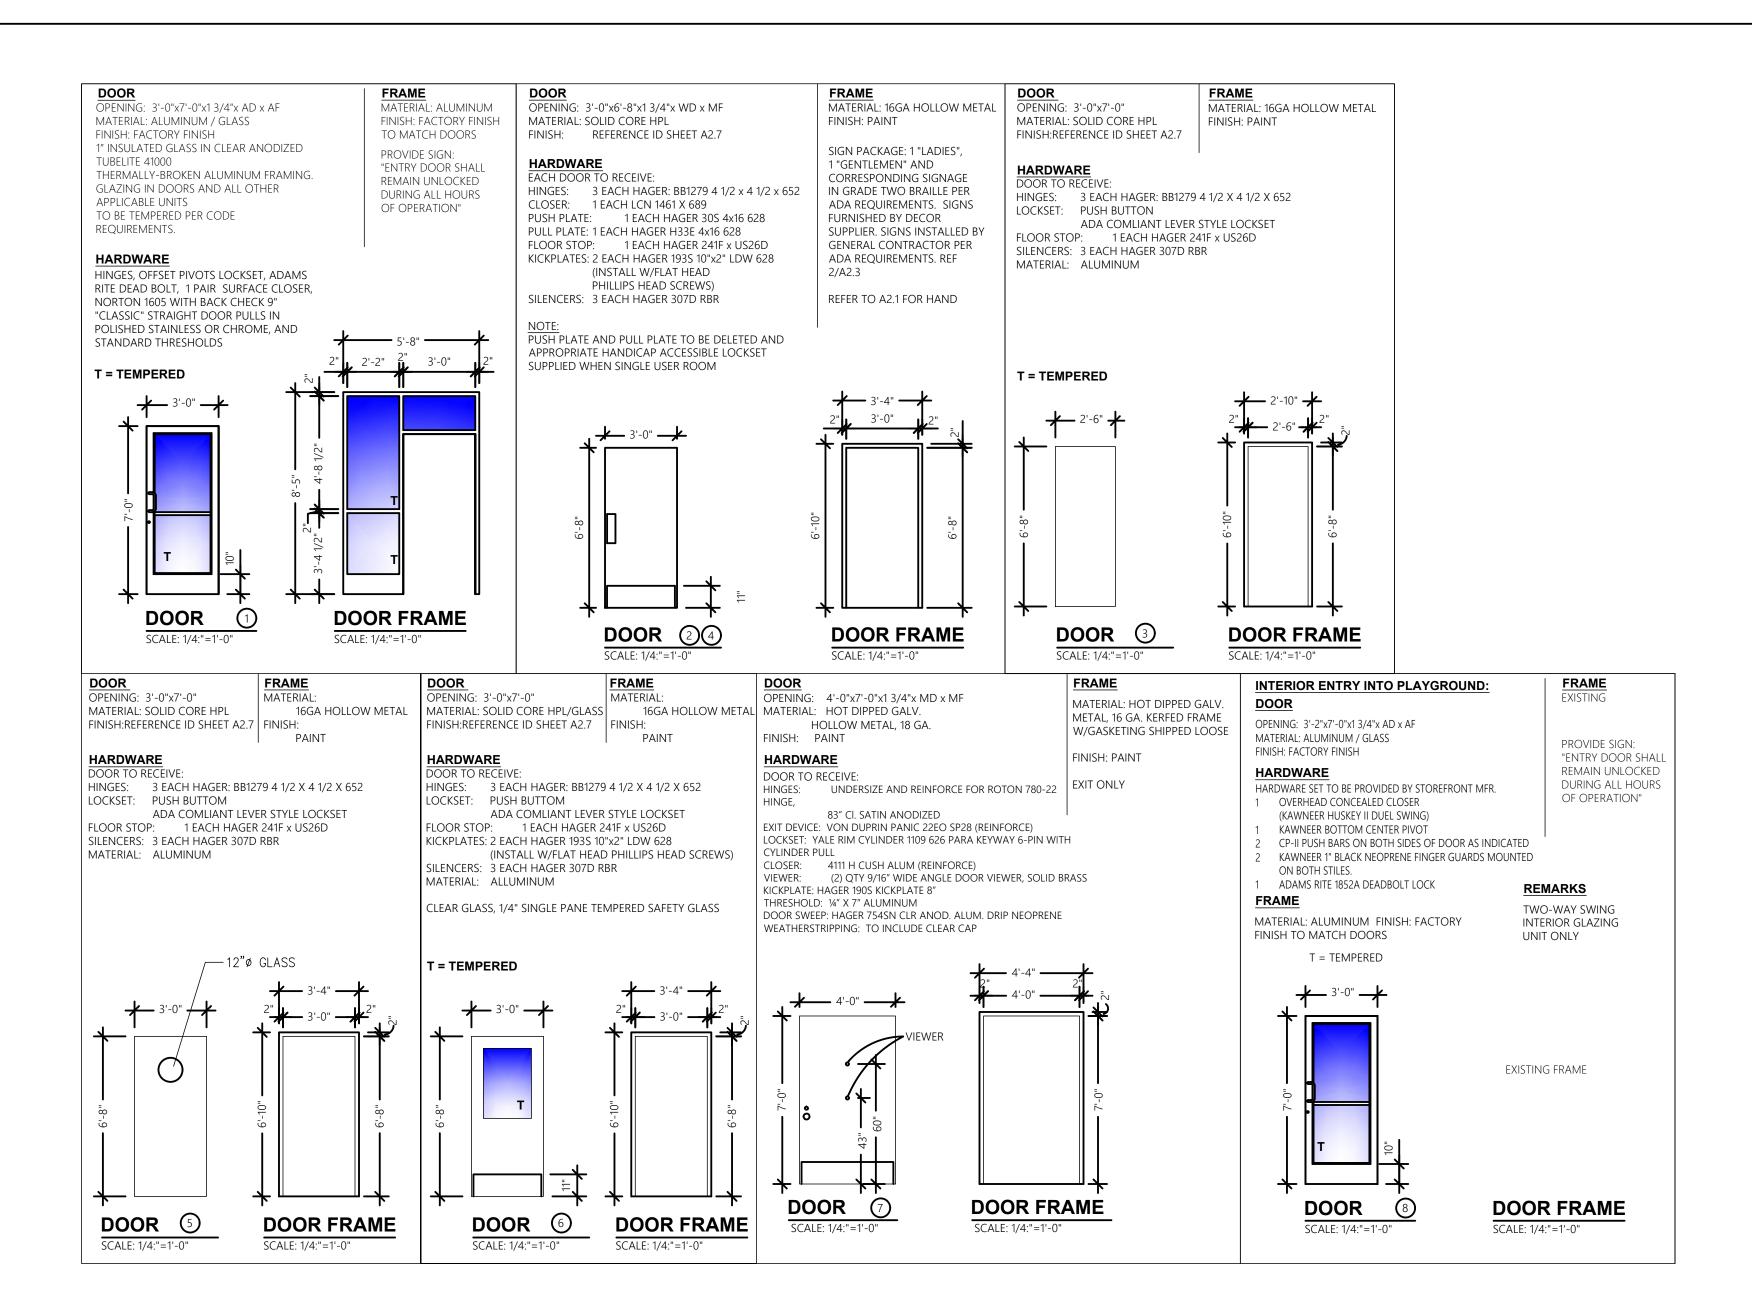
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DUMPSTER ENCLOSURE

A5.



NOTES:

G.C. TO CUSTOMIZE FRAME ORDER AS REQUIRED FOR EXISTING WALLS/FIELD CONDITIONS


ALL STOREFRONT GLAZING TO BE BRONZED ALUMINUM FRAMES AND HARDWARE TO MATCH EXISTING UNITS - NOT AS SHOWN


ALL WINDOWS WITHIN 24" OF VERTICAL EDGE OF DOOR SHALL BE TEMPERED GLASS


DRIVE-THRU WINDOWS:

SELF-CLOSING WINDOW TO BE SUPPLIED BY GC W/SEPARATE TRANSOM TO MATCH STOREFRONT GLAZING. SEE WINDOWS "H" AND "J" BELOW. QUIK-SERVE UNIT IFSC-4030C WITH HANDING AS INDICATED, 4'-0" W X

UNIT TO HAVE 5/8" INSULATED CLEAR GLASS, BRONZED ALUMINUM

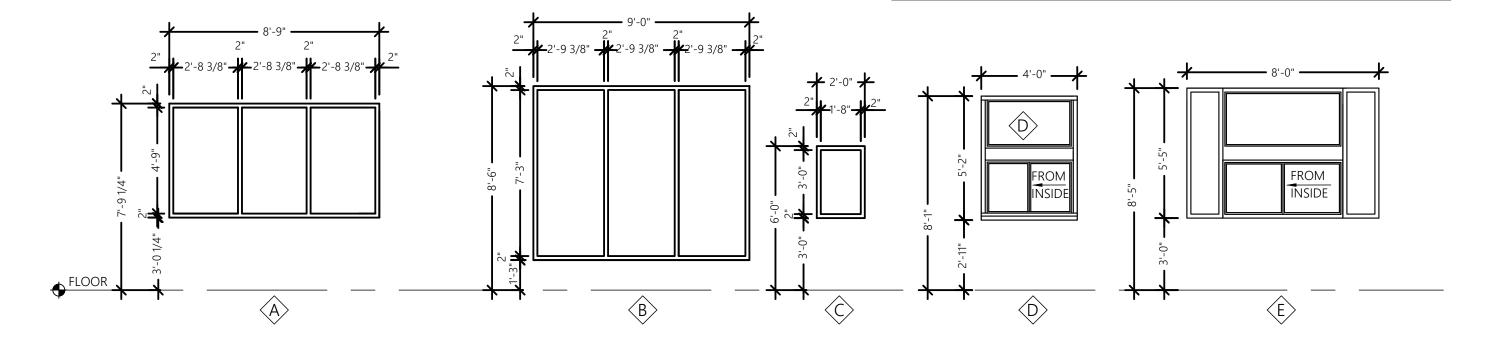

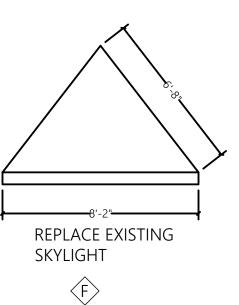

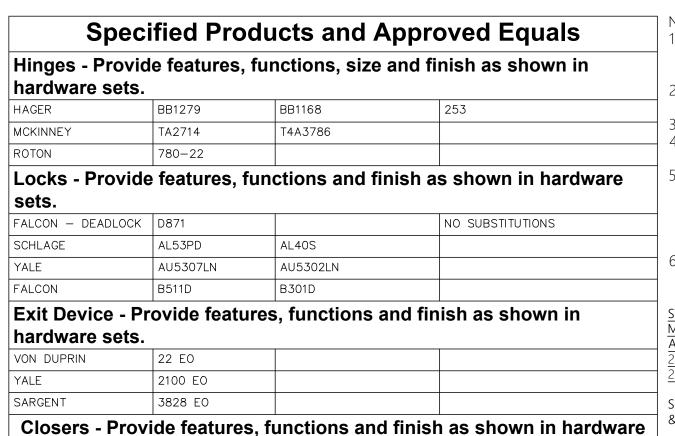

Push/Pull, KP, Stops, Etc. - Provide features, functins, size and finish as shown in hardware sets.

8916 DST / 8956 DST

4115 H-CUSH 4425T / 4421T

- 1							
	HAGER	KICKPLT 190S	PULL PLT H33G	PUSH PL 30S	FL STOP 243F	WALL STOP 236W	VIEWER 1756
	ROCKWOOD	K1050 B3E	BF106 X 70C	70C	441CU	409	622
	TRIMCO	K0050	1017-3x2 ½ PROJ.	1001-3	1211	1270WV	976U

Weatherstripping, Thresholds, Etc. - provide features, functions, size and finish as shown in hardware sets

and misi as	SHOWH III Haruv	vaie sels.	
NATIONAL GUARD	THRESHOLD 325A	SWEEP 200NA	WEATHERSTRIP 160SA
РЕМКО	229A	315CN	303AS
ZERO	1675A	39A	99A

CONTRACTOR IS RESPONSIBLE FOR VERIFYING ALL DIMENSIONS, HARDWARE AND THE DIRECTION OF SWING FOR EACH DOOR BEFORE ORDERING THE DOORS & WINDOWS. ALL ENTRY DOORS SHALL BE KEPT UNLOCKED DURING HOURS

OF OPERATION. ALL OPERABLE HARDWARE TO BE MOUNTED 34"-48" A.F.F. G.C. TO PROVIDE WALL OR FLOOR STOPS APPROPRIATE

FOR DOOR LOCATION CONSULT LOCAL INSPECTOR REGARDING REQUIRED DOOR SIGNAGE. IF REQUIRED, SIGN LETTERING SHALL BE 1" HIGH ON CONTRASTING BACKGROUND, ON EGRESS SIDE OR ADJACENT TO DOOR STATING "THIS DOOR TO REMAIN UNLOCKED

WHEN BUILDING IS OCCUPIED." CONSULT OWNER REGARDING SUPPLY AND KEYING OF

STOREFRONT UNITS TO FALL WITHIN THE MINIMUMS AND MAXIMUMS AS LAID OUT BY THE

5 INTERNATIONAL BUILDING CODE AND 015 INTERNATIONAL EXISTING BUILDING CODE

SEE CHART BELOW FOR MAX. U-FACTOR, MAX.SHGC, & MAX.AIR LEAKAGE


	BUILDING ENVELOPE FENESTRATION MAXIMUM U-FACTOR AND SHGC REQUIREMENT							
_	IVIANIIVIUIVI U-FF	ACTOR AND SHIEL REQUIRE	IVILIVI					
	CLIMATE ZONE	4						
_	U-FACTOR							
	FIXED FENESTRATION	0.38						
	OPERABLE FENESTRATION	0.45						
	ENTRANCE DOORS	0.77	•					

Sł	HGC	
ORIENTATION	S-E-W	N
PF < 2	0.4	0.53
0.2 <pf<0.5< th=""><th>0.48</th><th>0.58</th></pf<0.5<>	0.48	0.58
PF> 0.5	0.64	0.64

DRIVE-THRU WINDOWS:

SELF-CLOSING WINDOW TO BE SUPPLIED BY GC WITH SEPARATE TRANSOM TO MATCH STOREFRONT GLAZING. SEE WINDOWS "H" AND "J" QUIK-SERVE UNIT IFSC-4030C WITH HANDING AS INDICATED, 4'-0" W X 3'-0"

UNIT TO HAVE 5/8" INSULATED CLEAR GLASS, CLEAR ALUMINUM FRAME.

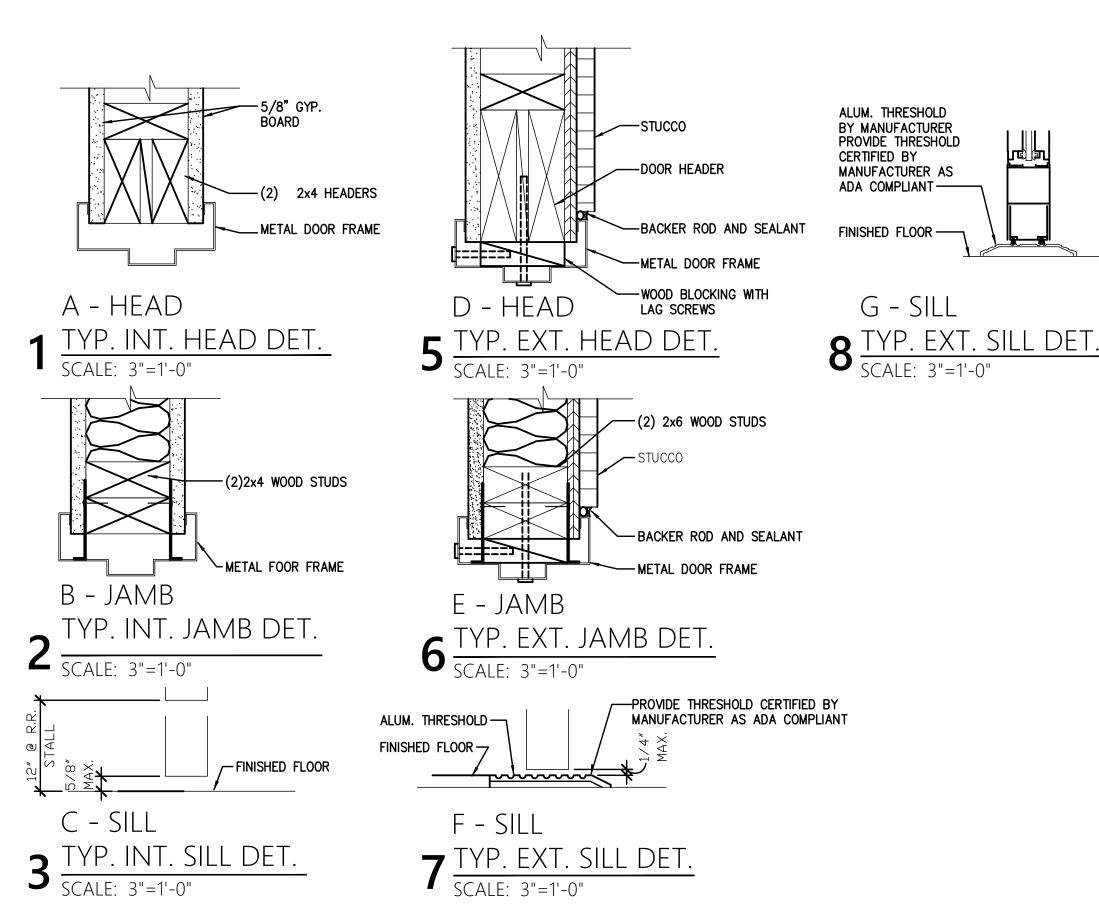

PERMIT DOCUMENTS

ARCHITECT OF RECORD:

Samantha Ciotti Falcone

DRAWN BY: MSR OWNER OF RECORD

BURGE


ARCHITECTURE

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DOOR & **WINDOWS**



<u>KEY</u>		KEY - CONTINUED		KEY - CONTINUED		KEY - CONTINUED	KEY - CONTINUED	
SYMBOL	DESCRIPTION	SYMBOL		SYMBOL	DESCRIPTION	SYMBOL	DESCRIPTION	
A —	SINGLE PENDANT. COORDINATE LOCATION AND QUANTITY WITH DECOR PLAN. BOTTOM OF FIXTURE @ 6'-6" A.F.F. NOTE: TABLES ARE FIXED	F	2x4 RECESSED LED (NIGHT LIGHT WHEN SHOWN HATCHED)	N 🗆	WALL MOUNTED SECURITY LIGHT		EMERGENCY LIGHT	
B ⇔	SINGLE PENDANT. COORDINATE LOCATION AND QUANTITY WITH DECOR PLAN. BOTTOM OF FIXTURE @ 6'-8" A.F.F. MIN./STAGGERED	G ×	2" DIAMETER DOWNLIGHT, SATIN NICKEL FINISH	\mathbf{P}	2X2 RECESSED LED		EXIT LIGHT	
B1	WALL SCONCE — COORDINATE LOCATION AND QUANTITY W/DECOR PLAN. BOTTOM OF FIXTURE @ 6'-8"	G1 💩	IN PRE-FABRICATED TRELLIS 2" DIAMETER WALLWASH, SATIN NICKEL FINISH	CF CF	CEILING FAN		DOUBLE EMERGENCY LIGHT REMOTE	
C1 O	4" DIAMETER, WHITE, RECESSED DOWN LIGHT IN DRYWALL SOFFITS & SUSPENDED CEILING	K	IN PRE-FINISHED TRELLIS 12x12 RECESSED SOFFIT LIGHT		CABLE/OUTLET FOR TV	EM	HEAD (EXTERIOR WEATHERPROOF)	
C2 •	4" DIAMETER, BLACK, RECESSED DOWN LIGHT		SURFACE MOUNTED EXTERIOR WALL		THUSTIAL DOV ESD CIONAGE		EXIT SIGN (W/ DIRECTIONAL ARROW WHERE APPLICABLE), CEILING MOUNT	
CZ •	IN DRYWALL SOFFITS & SUSPENDED CEILING	L \bigcirc	SCONCE UPLIGHT/DOWNLIGHT		JUNCTION BOX FOR SIGNAGE		SINGLE EMERGENCY LIGHT REMOTE	
D1 ₩	4" DIA. WHITE RECESSED DOWNLIGHT W/WALLWASHER	LD 🔘	SURFACE MOUNTED EXTERIOR WALL SCONCE DOWNLIGHT ONLY	T o	ADJUSTABLE TRACK LIGHTING FIXTURE,		HEAD (EXTERIOR WEATHERPROOF)	
E	1x4 RECESSED LED	M .	4'-0" LED SURFACE MOUNTED, FIXTURE SUPPLIED WITH CANOPY		4" DIAMETER MAX., SATIN NICKEL FINISH	0	EXISTING SPRIKLER HEADS	

06-14-21 REV1: 1/12/22
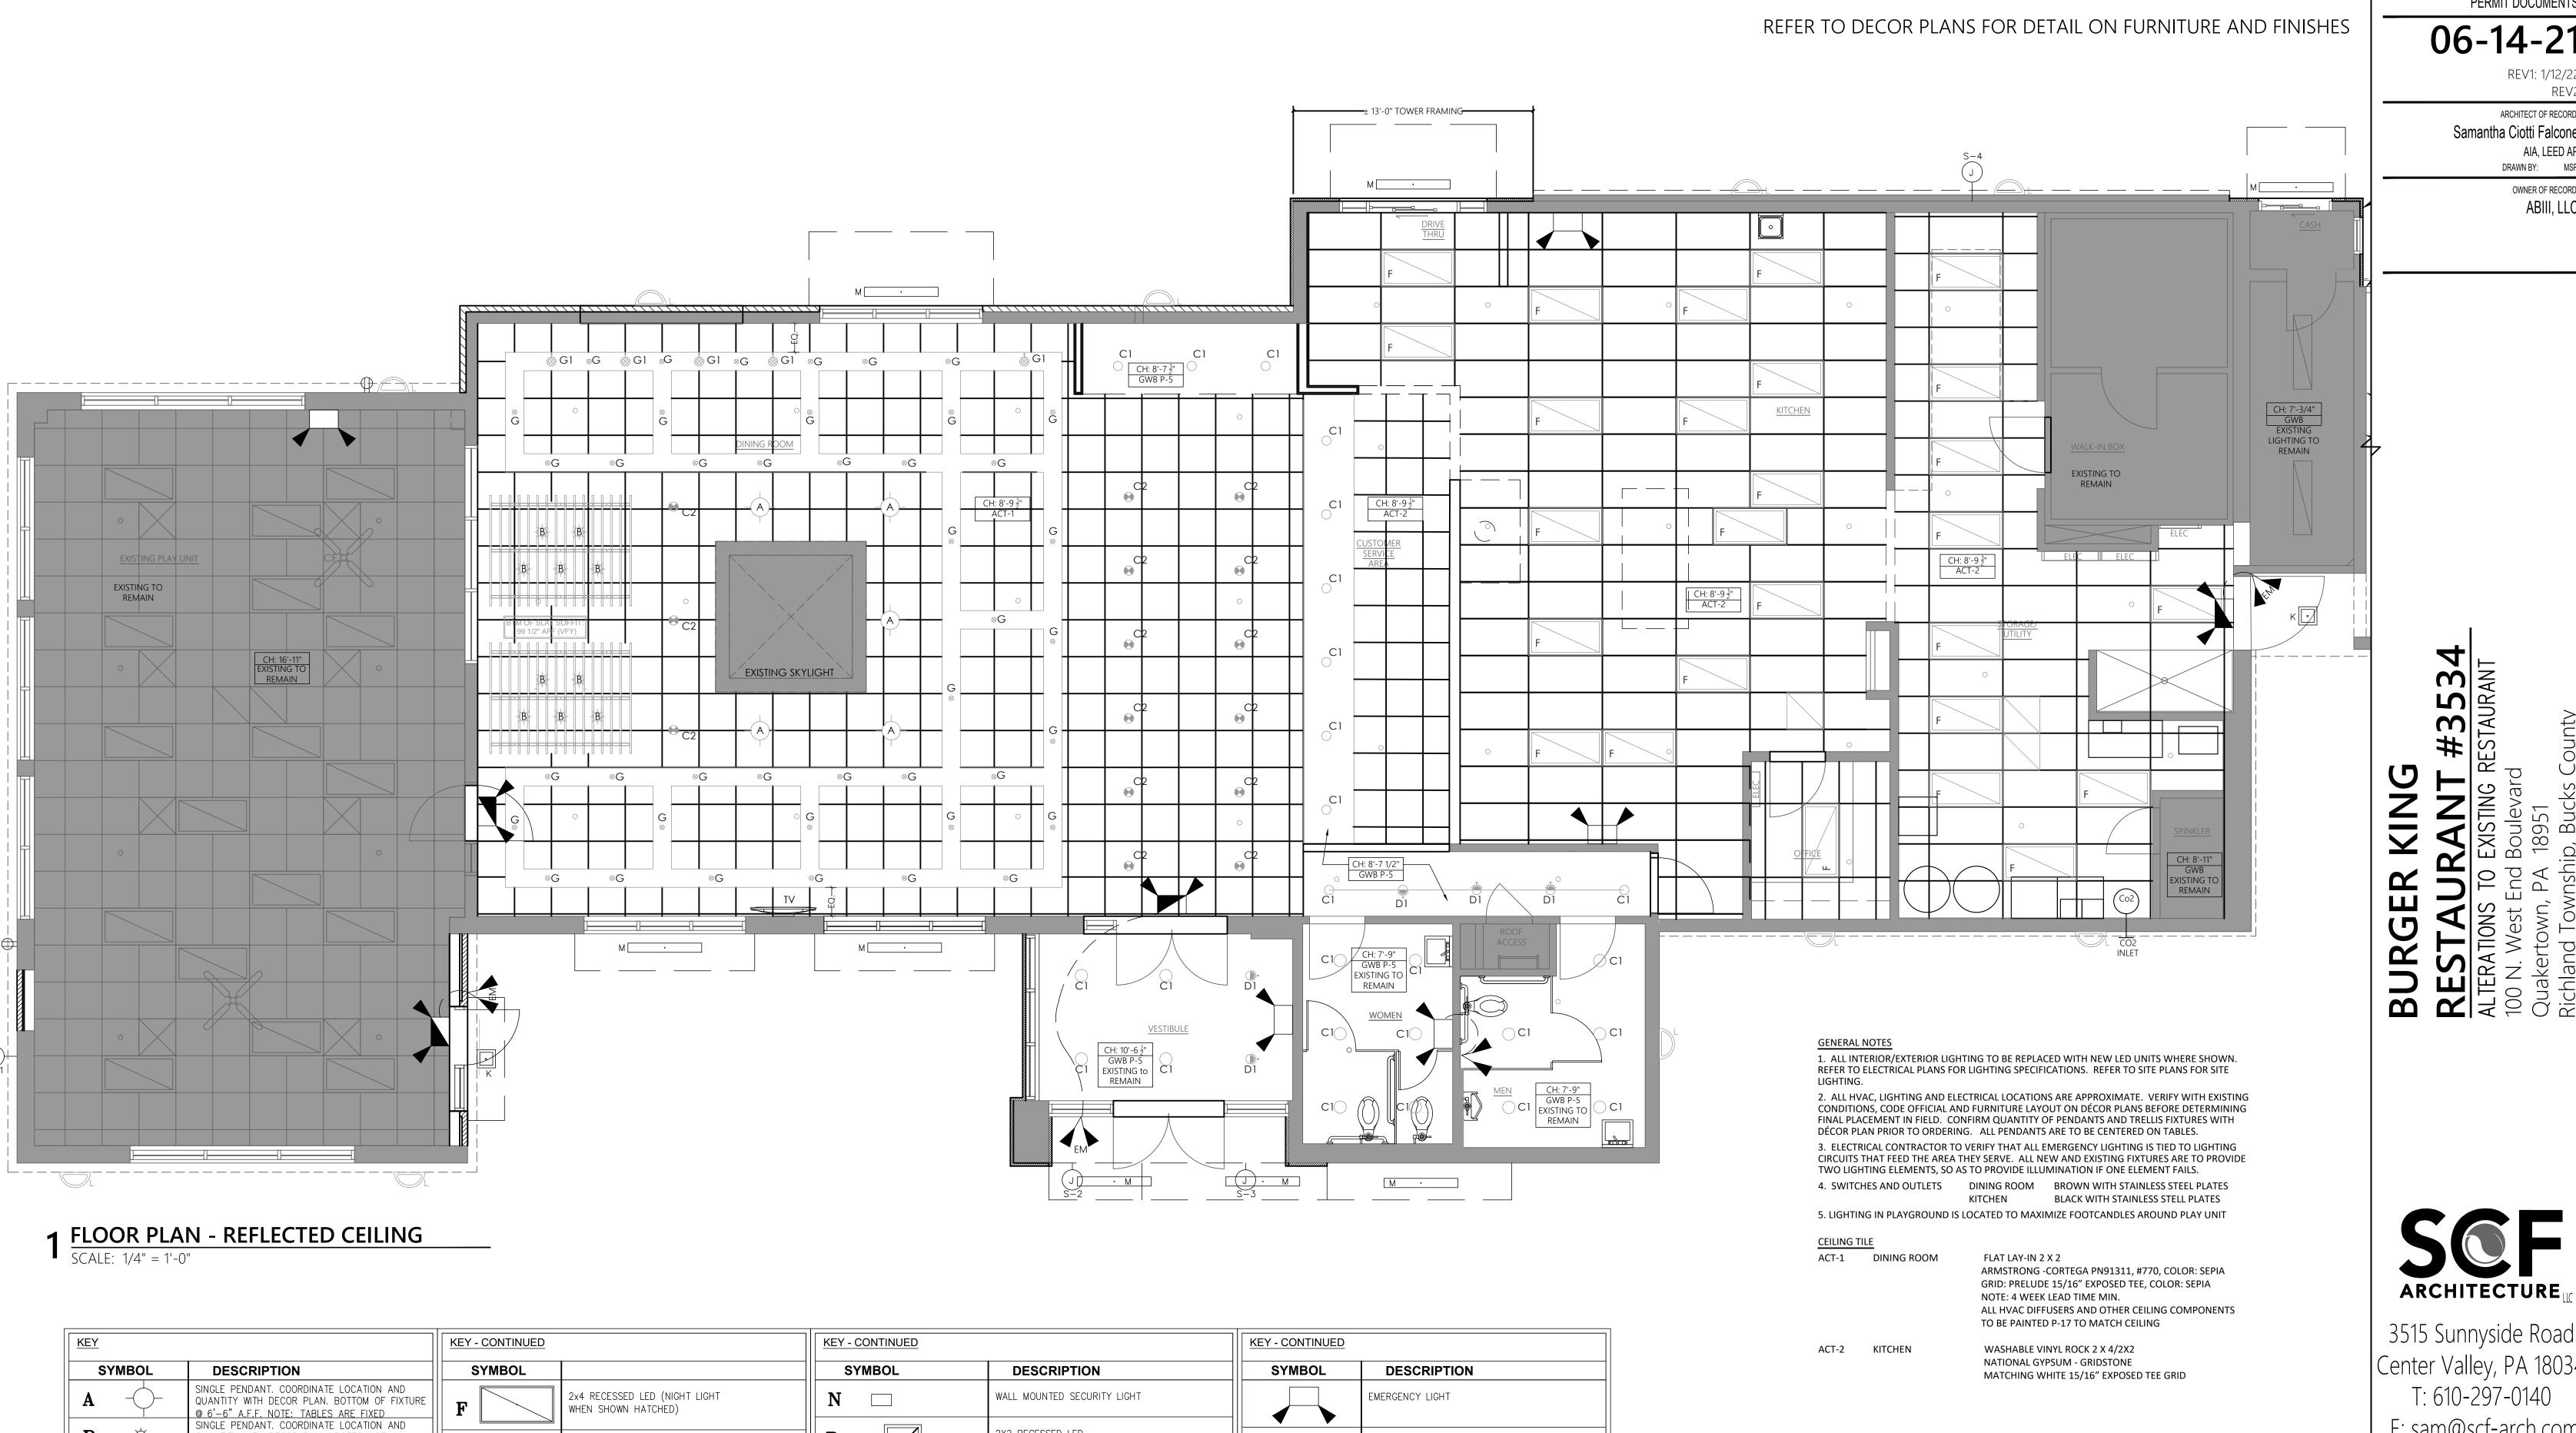
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REFLECTED **CEILING PLAN**

3. LED LIGHT BAND TO BE INSTALLED AT PARAPET. SEE ROOF PLAN SHEET A2.3 AND EXTERIOR ELEVATONS SHEETS A3.1/A3.2.

4. EXISTING FREESTANDING SIGNAGE (PYLON) TO RECEIVE NEW CABINETS, G.C. TO PAINT PYLON

1. ALL MP-3 CANOPIES WILL BE LIGHTED. CANOPY LIGHTING IS BEING SUPPLIED W/ CANOPIES &

2. INTERNALLY ILLUMINATED SIGNAGE AS SHOWN ON EXTERIOR ELEVATIONS SHEETS A3.1/A3.2.

EXTERIOR LIGHTING & SIGNAGE

S-1 6'-0" H. BUN LOGO

S-3 6' H. BUN LOGO

S-2 FG1954 (WHITE) CHANNEL LETTERING

S-4 BK CHANNEL LETTERING W/BUN LOGO (RED)

FIELD MOUNTED.