


RESTAURANT#


3840

1440 S NAPPANEE ST

ELKHART, IN 46516-1517

SHEET L	IST
SHEET NUM.	SHEET NAME
K0.0	KES COVER SHEET
K1.0	KES EQUIPMENT PLAN
K2.0	KES SCHEDULES
K3.0	KES ELEVATIONS
K4.0	KES NOTES AND DETAILS
K4.1	KES FRYER HOOD DETAILS
K4.2	KES BROILER HOOD DETAILS
KE1.0	KES ELECTRICAL PLAN
KM1.0	KES MECHANICAL PLAN
KP1.0	KES PLUMBING PLAN

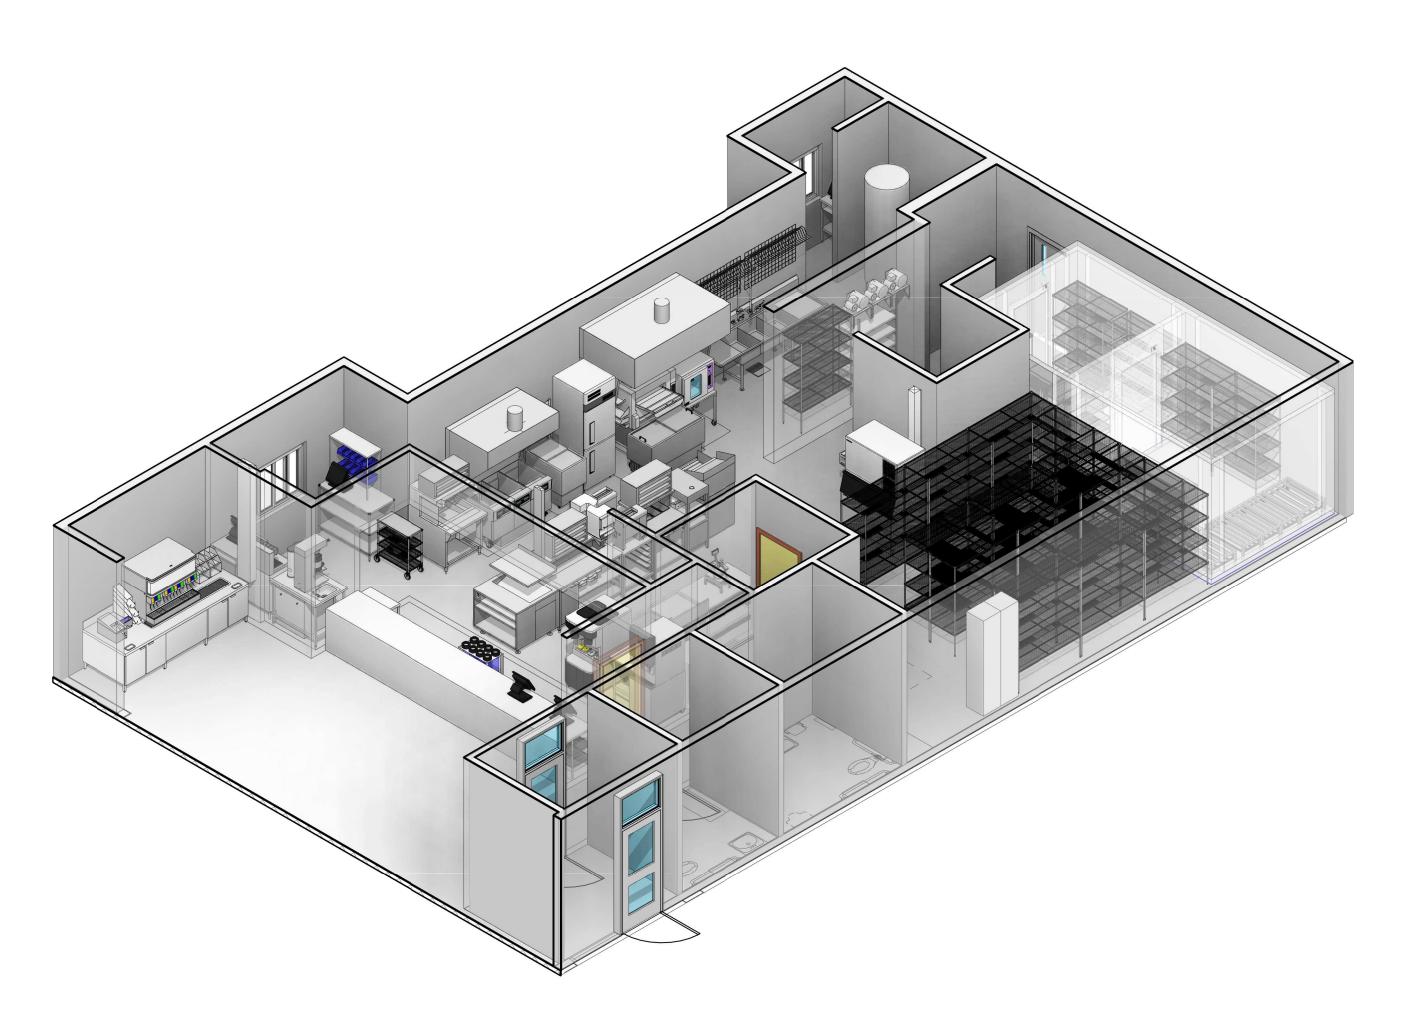

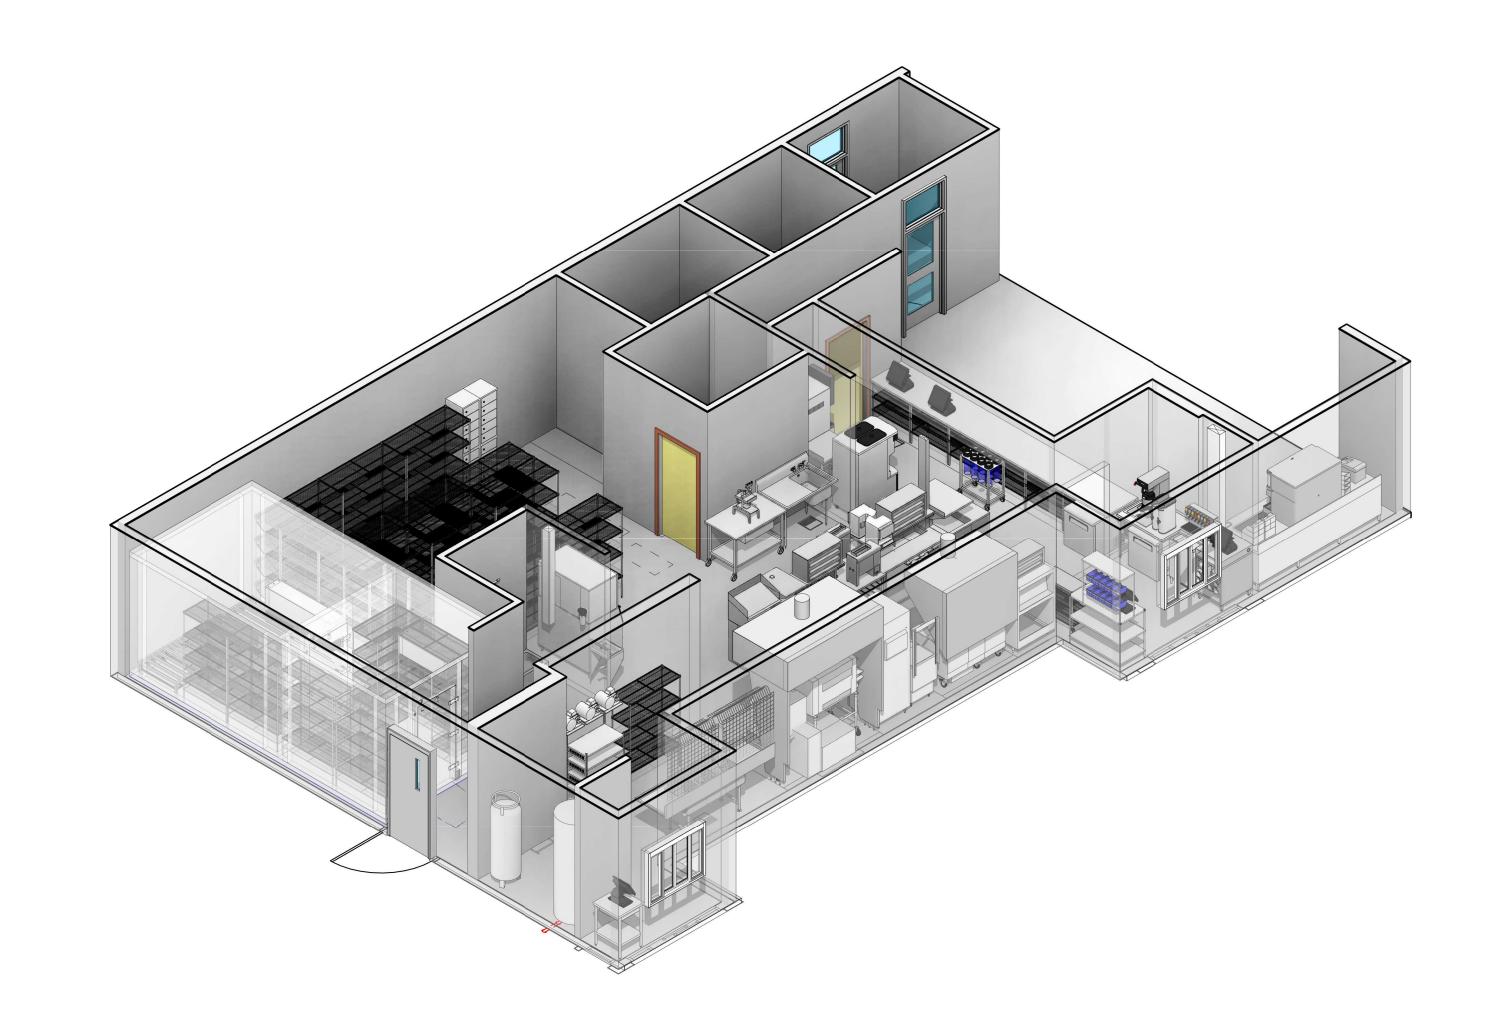



FRANKE CONTACT INFORMATION MYLES COUYOUMJIAN MARKET MANAGER MYLES.COUYOUMJIAN@FRANKE.COM 978-852-2959 PHONE PROJECT MANAGER STEPHANIE RIVERO STEPHANIE.RIVERO@FRANKE.COM PHONE 615-462-4588



ACCOUNT **BURGER KING**

RESTAURANT#

KES COVER SHEET

OPERATOR TRIA Company, LLC

1440 S NAPPANEE ST

ELKHART

STATE ZIP CODE 46516-1517 COUNTRY REGION

> BUILDING TYPE FREESTANDING ELECTRICAL SERVICE 208-230V/60Hz

N.AMERICA

GAS SERVICE NATURAL

MARKET MANAGER MYLES COUYOUMJIAN

FRANKE PROJECT NUMBER 1440649

FRANKE STORE NUMBER 5038036

CREATED BY DK996

DATE ISSUED 10/25/2021


MODIFIED BY DK996

DRAWING SCALE As Noted

UNITS INCH DRAWING NUMBER Elkhart, IN

K0.0

	EQUIPMENT KEYNOTES
KEY VALUE	KEYNOTE TEXT
K1.1	WALL BACKING BY G.C.
K1.2	WALL BACKING BY G.C. SEE DETAILS ON SHEET K4- G.C. TO EXTEND BACKING BEYOND END OF EQUIPMENT, EACH SIDE.
K1.3	ICE MACHINE REMOTE COND. UNIT ON ROOF BY G.C.(VERIFY LOCATION SEE NOTE GC7)
K1.4	WALK -IN BOX REMOTE COND. UNIT ON ROOF BY G.C.(VERIFY LOCATION SEE NOTE GC7)
K1.9	ALL P.O.S SYSTEM SUPPLIED & INSTALLED BY OWNER.

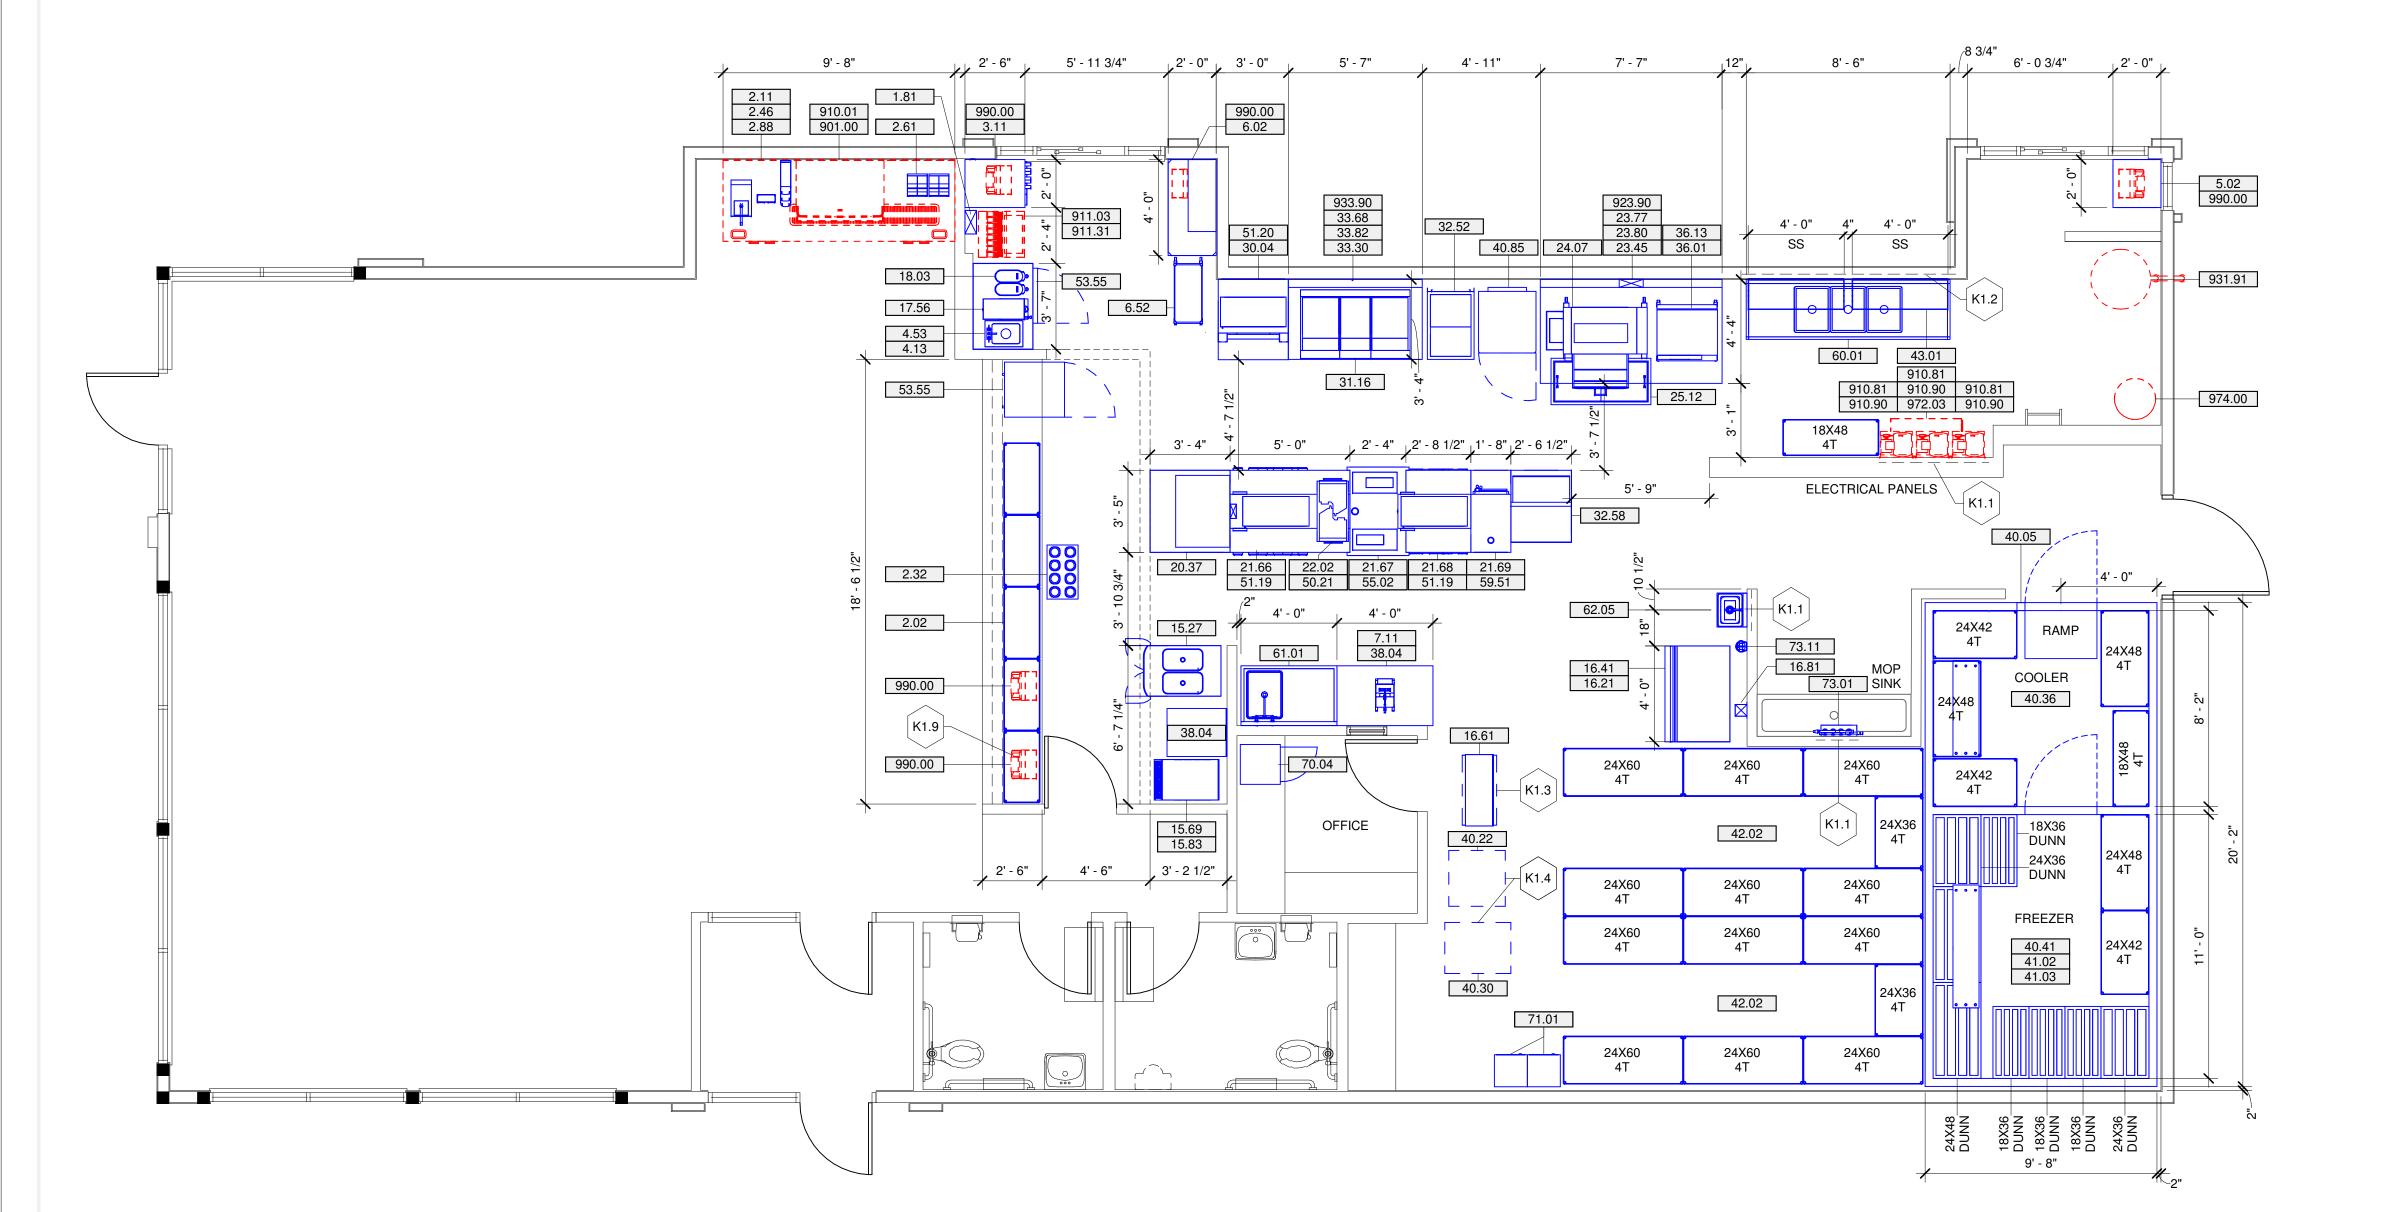

KES Equipment Plan 1/4" = 1'-0"

DRAWING NOTES

THIS DRAWING REFLECTS THE EQUIPMENT ORDERED AS OF THE DATE SHOWN. ADDITIONS OR DELETIONS MAY BEEN MADE TO THE ORDER, AND THESE CHANGES MAY NOT BE REFLECTED IN THIS DRAWING. PLEASE CONTACT FRANKE, INC. TO ADDRESS ANY QUESTIONS OR TO CONFIRM YOUR ORDER.

2 ANY DEVIATIONS FROM THESE PLANS, FOR ANY REASON, SHALL NOT BE DONE WITHOUT PRIOR WRITTEN NOTIFICATION TO FRANKE FOODSERVICE SYSTEMS, INC. FRANKE FOODSERVICE SYSTEMS, INC SHALL NOT BE HELD RESPONSIBLE FOR DEVIATIONS, CHANGES, ADDITIONS OR DELETIONS NOT REVIEWED AND APPROVED IN ADVANCE BY A FRANKE REPRESENTATIVE.

FRANKE FOODSERVICE SYSTEMS HAS PREPARED THESE PLANS AS ACCURATELY AS POSSIBLE WITH THE ARCHITECTURAL INFORMATION PROVIDED. FRANKE CANNOT BE HELD RESPONSIBLE FOR ADDITIONAL CONSTRUCTION COSTS DUE TO INACCURATE OR INCOMPLETE ARCHITECTURAL INFORMATION. ANY COSTS INCURRED DUE TO ADJUSTMENTS TO THESE PLANS BASED ON-SITE CONDITIONS, SHALL BE AT THE OWNER'S EXPENSE.

FOR ANY KITCHEN AREAS NOT SHOWING EQUIPMENT, NO WORK IS TO BE PERFORMED IN THAT AREA UNLESS SPECIFICALLY INSTRUCTED OTHERWISE ON THESE DRAWINGS OR BY A FRANKE REPRESENTATIVE IN A WRITTEN COMMUNICATION.

GENERAL CONTRACTOR NOTES

GC1 PRIOR TO CONSTRUCTION START, IT IS RECOMMENDED THAT THE GENERAL CONTRACTOR VERIFY ALL BUILDING DIMENSIONS, EQUIPMENT PLACEMENT, FURNITURE PLACEMENT, & UTILITY LOCATIONS. PLEASE NOTIFY A FRANKE REPRESENTATIVE IN WRITING IF ADJUSTMENTS TO THE DRAWINGS ARE

GC2 ALL WORK SHALL BE PERFORMED BY A QUALIFIED LICENSED CONTRACTOR IN ACCORDANCE WITH ALL COUNTRY, STATE, & LOCAL CODES.

GC3 ALL WORK SHALL BE COMPLETED IN A NEAT, PROFESSIONAL, & SAFE WORKMAN-LIKE MANNER. GC4 NOTIFY FRANKE IMMEDIATELY IF COMPLIANCE WITH ANY CODES IS IN

CONFLICT WITH THESE DRAWINGS.

GC5 NOTIFY FRANKE IMMEDIATELY IF THESES DRAWINGS DIFFER FROM THE ARCHITECTURAL OR MEP DRAWINGS.

THESE DRAWINGS ONLY INCLUDE THE REQUIREMENTS FOR THE ITEMS PROVIDED BY FRANKE. G.C. TO VERIFY THE REQUIREMENTS FOR ITEMS NOT PROVIDED BY FRANKE. REFER TO ARCHITECTURAL, STRUCTURAL, OR MEP DRAWING FOR OTHER REQUIREMENTS.

G.C. SHALL PROVIDE & INSTALL PLYWOOD WALL BACKING FOR EQUIPMENT WHERE IT IS REQUIRED.

G.C. TO DETERMINE THE LOCATION OF & SET REMOTE CONDENSERS ON ROOF.

G.C. TO PROVIDE & INSTALL EQUIPMENT STAND & PITCH PANS FOR ROOF MOUNTED CONDENSING UNITS.

G.C. SHALL PROVIDE ACCESS FOR THE EQUIPMENT TRUCK TO WITHIN 10'
(3m) OF THE BUILDING DOORS PRIOR TO THE ARRIVAL OF THE EQUIPMENT TRÚCK AT THE RESTAURANT.

GC11 BY OWNER EQUIPMENT WILL BE LISTED IN THE MAIN EQUIPMENT

SCHEDULE.

EXISTING EQUIPMENT DEMOLISHED EQUIPMENT RELOCATED EQUIPMENT NEW EQUIPMENT

FUTURE EQUIPMENT



FRANKE

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FRANKE takes no responsibility for the accuracy of the floor plans and constructional drawings. All dimensions and connections specified by FRANKE must be checked by the client prior to installation. Specifications for power consumption and connections are limited to equipment supplied by FRANKE. All third party accessories shown lie within the responsibility of the client. FRANKE reserves the right to change equipment without notice.

ACCOUNT

BURGER KING

RESTAURANT#

3840

KES EQUIPMENT PLAN

OPERATOR TRIA Company, LLC SITE ADDRESS

1440 S NAPPANEE ST ELKHART

STATE ZIP CODE IN 46516-1517 COUNTRY REGION USA N.AMERICA

BUILDING TYPE FREESTANDING ELECTRICAL SERVICE

208-230V/60Hz GAS SERVICE NATURAL MARKET MANAGER

MYLES COUYOUMJIAN FRANKE PROJECT NUMBER 1440649

FRANKE STORE NUMBER 5038036

CREATED BY

DK996 DATE ISSUED 10/25/2021

MODIFIED BY DK996

DRAWING SCALE As Noted

UNITS INCH DRAWING NUMBER

Elkhart, IN SHEET NAME

K1.0

				KE	S EQUIPMENT	SCHEDULE				
EM#	ST.	QTY.	DESCRIPTION	MANUFACTURER	MODEL#	FRANKE PART #	UL#	NSF	FURNISHED BY	REMARKS
.81	N	1	SERVICE CHASE	FRANKE	-	18000937	-	2	FRANKE	5-3/4" x 11-3/4"- FOR SODA LINES
2.02	N	10	DRY STORAGE SHELVING	INTERMETRO	-	-	-	2	FRANKE	-
2.04	N	20	UNDERCOUNTER POST	INTERMETRO	-	-	-	2	FRANKE	NOT SHOWN
2.11	N N	1	CUP LID HOLDER MOBILE CUP DISPENSER CART	FRANKE FRANKE	-	18006489 18006842	-	-	FRANKE FRANKE	- F/(8) CUP DISPENSERS
2.46	N	1	STRAW DISPENSER	VOLLRATH	3815-28	610896	-	2	FRANKE	F/(0) COP DISPENSENS
2.61	N	2	UNIVERSAL CONDIMENT HOLDER	FRANKE	-	18003659	-	2	FRANKE	-
2.88	N	1	EXTREME COUNTERTOP DISPENSER	SERVER PRODUCTS	ECD 07500	620754	-	-	FRANKE	-
3.11	N	1	24"W x 30"D DRIVE THRU TABLE W/CUP DISPENSER	FRANKE	-	18005294	-	2	FRANKE	-
4.13	N	1	DRIVE THRU TABLE W/ HAND SINK	FRANKE	18006428	FS01505	-	2	FRANKE	-
4.53	N	1	DROP-IN-SINK	ADVANCE TABCO	DI-1-5	19000444	-	2	FRANKE	-
5.02	N	1	POS TABLE	FFSUS	-	18006151	-	2	FRANKE	-
6.02	N	1	DRIVE THRU WORKSTATION	INTERMETRO	BKROC2448DT	70000517BK	-	2	FRANKE	-
6.52	N	1	14" X 30" ORDER ASSEMBLY CART	INTERMETRO	BKBC1430	70004322	-	-	FRANKE	-
/.11 15.97	IN N	1	SLICER, SABER KING HEAT TREAT COMBINATION SHAKE/SUNDAE MACHINE	PRINCE CASTLE, INC. TAYLOR	980-000-00 C606	622928 618877	SA2650	6	FRANKE FRANKE	- WITHOUT CORD & PLUG
15.69	N	1	FROZEN BEVERAGE DISPENSER	FBD	12-7361-0010	624559	3A2030	2	FRANKE	WITHOUT COND & FLOG
15.83	N	1	FROZEN BEVERAGE DISPENSER CART	FBD	12-2516-0003	621552	_	2	FRANKE	PRE-PLUMBED
16.21	N	1	ICE MACHINE	HOSHIZAKI	KM1301SRJ-BK	70003049-1	-	12	FRANKE	REMOTE AIR COOLED
16.41	N	1	ICE STORAGE BIN	HOSHIZAKI AMERICA, INC.	B-800SF-BK	70000535BK	-	2	FRANKE	-
16.61	N	1	ICE MACHINE REMOTE CONDENSING UNIT	HOSHIZAKI INC.	URC-14F	620714	-	2	FRANKE	SEE DETAIL ON K4.0
6.81	N	1	WALL SERVICE CHASE	FRANKE	-	0424201	-	2	FRANKE	6" x 6"
17.56	N	1	INFUSION TEA COFFEE BREWER	BUNN-O-MATIC	ITCB-DV	622290	-	2	FRANKE	-
18.03	N	2	ICED TEA DISPENSER - SLIM	BUNN-O-MATIC	-	619935	-	-	FRANKE	-
20.37	N	1	41" EXPEDITER STATION STD FLOW	FRANKE	EXPO5	18016254	E163328	2	FRANKE	-
21.66	N	1	60" PREP MODULE "A" - (ABCD/ACBD)	FRANKE	-	18015498	-	2	FRANKE	-
21.67	N	1	28" BUN TOASTER MODULE "B"	FRANKE	-	18008869	-	2	FRANKE	-
21.68	N	1	32.5" PREP MODULE "C"	FRANKE	•	18011951	-	2	FRANKE	-
21.69	N	1	20" PREP MODULE "D"	FRANKE	-	18011954	-	2	FRANKE	•
22.02 23.45	IN N	1	UNIVERSAL ONCUE MICROWAVE OVERSHELF 91" BROILER HOOD	FRANKE FRANKE	- 18022081	18004706 18022081	-	2	FRANKE FRANKE	W/ (3) L55 SERIES E26 CANOPY LIGHT FIXTURES
23.43	N	1	EXHAUST FAN	FRANKE	18020256	18022085	- III 762	2	FRANKE	W/ (3) E33 SERIES E20 CANOFT EIGHT FIXTURES
23.80	N	1	ROOF CURB	FRANKE	18018809	18022554	OL 702	2	FRANKE	ROOF CURB FOR BROILER HOOD
24.07	N	1	BROILER	DUKE	FBB-NO-120	619670	-	4	FRANKE	-
25.12	N	1	50" MEAT WELL FREEZER	FRANKE	-	18004405	-	2	FRANKE	-
30.04	N	1	35" FRY STATION - ROC	FRANKE	-	18021945	-	4	FRANKE	-
31.16	N	1	3 - BANK FRYER	PITCO	BK-SSH60W/55/60W-FD	70003678	-	4	FRANKE	-
32.52	N	1	PRODUCT HOLDING FREEZER	FRANKE	-	18007216	-	7	FRANKE	W/ PORTION PAN & FRY RACK
32.58	N	1	REFRIGERATED BATTER STATION	H&K	52976	626544	-	7	FRANKE	-
33.30	N	1	67" FRYER HOOD	FRANKE	18022081	18022081	-	2	FRANKE	W/ L55 SERIES E26 CANOPY LIGHT FIXTURES
33.68	N	1	EXHAUST FAN	FRANKE	18020256	18022085	UL 762	2	FRANKE	-
33.82	N	1	ROOF CURB	FRANKE	18018809	18022554	-	2	FRANKE	ROOF CURB FOR FRYER HOOD
36.01	N	1	CONVECTION OVEN	LANG MANUFACTORING	ECOH-PP2-08BK	616043	-	-	FRANKE	-
36.13	N	1	CONVECTION OVEN STAND	FRANKE	-	18004026	-	2	FRANKE	•
38.04 38.04	IN NI	1	30"W x 24"D x 36"H WORK TABLE W/ 4" BACKSPLASH 48"W x 30"D x 36"H WORK TABLE	FRANKE FRANKE	-	18003842 18006054	-	2	FRANKE FRANKE	- W/TOOL DRAWER
40.05	N	1	WALK-IN COOLER/FREEZER BOX	NORLAKE	_	-	_	7	FRANKE	SEE DETAIL ON K4
40.22	N	1	WALK-IN COOLER CONDENSING UNIT	NORLAKE	MHMD010AC	-	-	7	FRANKE	-
40.30	N	1	WALK-IN FREEZER CONDENSING UNIT	NORLAKE	MSLD020AC	-	-	7	FRANKE	-
40.36	N	1	WALK-IN COOLER EVAPORATOR	NORLAKE	E1MD0078A-TA2	-	-	7	FRANKE	-
40.41	N	1	WALK-IN FREEZER EVAPORATOR	NORLAKE	E1LD0056B-TE2	-	-	7	FRANKE	
40.85	N	1	REACH-IN FREEZER	TURBO AIR	M3F24-2-N	624280	-	7	FRANKE	-
41.02	N	28	COLD STORAGE SHELVING	INTERMETRO	-	-	-	2	FRANKE	-
41.03	N	8	RACK DUNNAGE - COLD	NEW AGE	-	-	-	2	FRANKE	-
42.02	N	60	DRY STORAGE SHELVING	INTERMETRO	-	-	-	2	FRANKE	
42.20	N	88	POST	INTERMETRO	-	-	-	2	FRANKE	NOT SHOWN
43.01	N	1	DOUBLE SMARTWALL SHELVING	INTERMETRO IND.	BKSWP8446DBL	70003536	-	3	FRANKE	SEE DETAIL ON K4
50.21	N	2	MICROWAVE	ACP	OC24HBK	626730	-	2	FRANKE	-
01.19	N	2	MULTI-PRODUCT HOLDING UNIT	DUKE	HS2-34-2086T2R	625171	-	4	FRANKE	-
51.20	IN	1	MULTI-PRODUCT HOLDING UNIT REACH-IN UNDERCOUNTER REFRIGERATOR - FIELD	DUKE	HS2-24-2084T1R	625163	-	4	FRANKE	·
53.55	N	2	REVERSIBLE DOOR	TURBO AIR	MUR-28-N-1C	626213	-	7	FRANKE	
55.02	N	2	RAPID VERTICAL TOASTER	ANTUNES	BKT-2V	624462	-	4	FRANKE	-
59.51	N	1	EGG COOKER	A.J. ANTUNES & CO.	ES-1200	620840-1	E49407	4	FRANKE	-
60.01	N	1	3 COMPARTMENT SINK	FRANKE	-	18003580	-	2	FRANKE	-
61.01	N	1	ONE COMPARTMENT SINK W/ LH DRAINBOARD	FRANKE	-	18008223	-	2	FRANKE	-
32.05	N	1	HANDS-FREE WASH STATION SINK	JOHN BOOS	PBHS-W-KVMB-1	617160	-	2	FRANKE	-
70.04	N	1	SAFE W/ ANCHORING	FIRE KING SECURITY	BSD2920	623932	-		FRANKE	•
71.01	N	2	LOCKER	PENCO PRODUCTS	EL/10/S/GRAY (GRAY)	EL 10	-	-	FRANKE	-
73.01	N	1	WATER FILTER	EVERPURE	CB20-312E	615543	-	2	FRANKE	SEE DETAIL ON K4
73.11	N	1	FILTER FEEDER SCALE INHIBITOR	EVERPURE	SR-X	70002482	-	2	FRANKE	-
01.00	R	1	9'-8" ROC MAIN BEVERAGE STATION	FRANKE	18023142	FS01846	-	2	OTHERS	VERIFY W/ OWNER
910.01	R	1	ICE/SODA DISPENSER	LANCER	IBD 4500-44	70002679	UL763	18	OTHERS	VERIFY W/ OWNER
910.81	К	3	CARBONATOR	LANCER	85-1923-00	617544	UL403	2	OTHERS	VERIFY W/ OWNER
10.90	К	3	SHELF CARBONATOR F/ LANCER ICE/SODA DISPENSER	LANCER	82-3876	822999 852278T124	-	2	OTHERS	VERIFY W/ OWNER
911.03	K D	1	ICE/SODA DISPENSER ICE/SODA CONVERSION STAND	LANCER LANCER	85-2378T-124 84-0058	852378T124 840058	-	18	OTHERS OTHERS	VERIFY W/ OWNER VERIFY W/ OWNER
911.31 923.90	K P	1	FIRE PROTECTION SYSTEM	LANGER VERIFY	84-0058 VERIFY	840058 VERIFY	-	2	OTHERS	VERIFY W/ OWNER VERIFY W/ OWNER
	R	1	SHORTENING DISPOSAL CADDY SYSTEM	DARLING INT.	1500-C	7000046	-	2		VERIFY W/ OWNER VERIFY W/ OWNER
33.90	R	1	FIRE PROTECTION SYSTEM	VERIFY	VERIFY	VERIFY		-	OTHERS	VERIFY W/ OWNER VERIFY W/ OWNER
972.03	R	1	BAG-N-BOX SYRUP RACK	CORNELIUS	621065776	623131		2	OTHERS	VERIFY W/ OWNER
974.00	R	1	CO2 BULK SYSTEM	VERIFY	VERIFY	VERIFY		-		VERIFY W/ OWNER
90.00	D	5	P.O.S. SYSTEM	VERIFY	VERIFY	VERIFY		-		VERIFY W/ OWNER

					I	KES ELI	ECTRIC	CAL SCHE	DULE				
ITEM#	TAG#	QTY	DESCRIPTION	VOLTS	PH	CYCLE	HP	BRKR SIZE	AMPS	ELEC CONN TYPE	PLUG TYPE	CONN RI HGHT	ELECTRICAL REMARKS
15.27	E1	1	HEAT TREAT COMBINATION SHAKE/SUNDAE MACHINE	208 V	3	60 Hz	2 1/2	45.00 A	35.00 A	PLUG & CORD	SEE RMKS	36"	E.C. TO SUPPLY & INSTALL 6FT. CORD & PLUG.
15.69	E1	1	FROZEN BEVERAGE DISPENSER	208 V	1	60 Hz	1/4	30.00 A	30.00 A	PLUG & CORD	NEMA L6-30P	36"	BEATER: (3)1/6 HP FAN: 1/4 HP
16.21	E1	1	ICE MACHINE	208 V	1	60 Hz	-	20.00 A	13.50 A	DIRECT WIRED	DIRECT WIRED	48"	-
16.61	E1	1	ICE MACHINE REMOTE CONDENSING UNIT	115 V	1	60 Hz	-	25.00 A	23.00 A	DIRECT WIRED	-	0"	E.C. TO CONNECT TO ICE MACHINE AS REQ'D- SEE DETAIL ON K3
17.56	E1	1	INFUSION TEA COFFEE BREWER	120 V	1	60 Hz	-	20.00 A	14.00 A	PLUG & CORD	NEMA 5-15P	24"	-
20.37	E1	1	41" EXPEDITER STATION STD FLOW	120 V	1	60 Hz	-	20.00 A	16.00 A	PLUG & CORD	NEMA 5-20P	0"	CONNECTS INTO RECEPTACLE ON PREP MODULE "A" VIA 6' POWER CORD
21.66	E1	1	60" PREP MODULE "A" - (ABCD/ACBD)	208 V	3	60 Hz	-	0.00 A	1.08 A	DIRECT WIRED	DIRECT	0"	DOWN THRU SERVICE CHASE; E.C. TO CONNECT TO LOAD CENTER PROVIDED, AS REQ'D FOR 150A- 5 WIRE W/106A FEEDER. AMPERAGE LOAD FOR LOAD CENTER IN THIS CABINET TO BE CALCULATED FROM COMBINED LOADS OF EQUIPMENT ATTACHED TO THIS CABINET.
21.67	E1	1	28" BUN TOASTER MODULE "B"										CONNECTS TO LOAD CENTER ON PREP MODULE "A"
21.68	E1	1	32.5" PREP MODULE "C"										CONNECTS TO LOAD CENTER ON PREP MODULE "A"
21.69	E1	1	20" PREP MODULE "D"										CONNECTS TO LOAD CENTER ON PREP MODULE "A"
23.45	E1	1	91" BROILER HOOD										E.C. TO CONNECT TO HOOD'S CHASE & JB FOR HOOD'S LIGHT
23.77	E1	1	EXHAUST FAN	120 V	1	60 Hz	1	20.00 A	11.60 A	DIRECT WIRED	REFER TO REMARKS	12"	E.C. TO INTERCONNECT CIRCUIT W/ SAFETY INTERLOCK AT BUILDING'S MAIN BREAKER PANEL. CONNECTION HEIGHT @ 12" B.F.R.
24.07	E1	1	BROILER	120 V	1	60 Hz		20.00 A	2.00 A	PLUG & CORD	NEMA 5-15P	0"	CONNECTS INTO RECEPTACLE ON HOOD'S CHASE
25.12	E1	1	50" MEAT WELL FREEZER	120 V	1	60 Hz	-	20.00 A	7.60 A	PLUG & CORD	NEMA 5-15P	0"	CONNECTS INTO RECEPTACLE ON HOOD'S CHASE
30.04	E1	1	35" FRY STATION - ROC	208 V	1	60 Hz	-	20.00 A	15.00 A	PLUG & CORD	NEMA L14-20P	24"	-
31.16	E1	1	3 - BANK FRYER	120 V	1	60 Hz	-	20.00 A	2.10 A	PLUG & CORD	NEMA 5-15P	0"	E.C. TO CONNECT INTO RECEPTACLE ON RACEWAY OF HOOD FOR FRYER
31.16	E2	1	3 - BANK FRYER	120 V	1	60 Hz	1/3	20.00 A	6.10 A	PLUG & CORD	NEMA 5-15P	0"	E.C. TO CONNECT INTO RECEPTACLE ON RACEWAY OF HOOD FOR FILTER
32.52	E1	1	PRODUCT HOLDING FREEZER	120 V	1	60 Hz	-	20.00 A	4.60 A	PLUG & CORD	NEMA 5-15P	24"	-
32.58	E1	1	REFRIGERATED BATTER STATION	120 V	1	60 Hz	-	20.00 A	3.00 A	PLUG & CORD	NEMA 5-20P	0"	CONNECTS INTO RECEPTACLE ON MODULE D
33.30	E1	1	67" FRYER HOOD										E.C. TO CONNECT TO HOOD'S RACEWAY & JB FOR HOOD'S LIGHT
33.68	E1	1	EXHAUST FAN	120 V	1	60 Hz	1	20.00 A	11.60 A	DIRECT WIRED	REFER TO REMARKS	12"	E.C. TO INTERCONNECT CIRCUIT W/ SAFETY INTERLOCK AT BUILDING'S MAIN BREAKER PANEL. CONNECTION HEIGHT @ 12" B.F.R.
36.01	E1	1	CONVECTION OVEN	208 V	1	60 Hz	-	40.00 A	37.50 A	PLUG & CORD	C&P	0"	MODEL IS BOTH COMPATIBLE IN SINGLE AND THREE PHASE
40.05	E1	1	WALK-IN COOLER/FREEZER BOX	120 V	1	60 Hz	-	20.00 A	1.00 A	DIRECT WIRED	DIRECT	0"	EC TO MAKE ALL CONNECTIONS AS REQD
40.22	E1	1	WALK-IN COOLER CONDENSING UNIT	208 V	3	60 Hz	1	20.00 A	5.00 A	DIRECT WIRED	DIRECT	0"	-
40.30	E1	1	WALK-IN FREEZER CONDENSING UNIT	208 V	3	60 Hz	2	20.00 A	9.00 A	DIRECT WIRED	DIRECT	0"	-
40.36	E1	1	WALK-IN COOLER EVAPORATOR	115 V	1	60 Hz	-	20.00 A	0.80 A	DIRECT WIRED	DIRECT	0"	E.C. TO WIRE UNIT FROM ELECTRICAL KNOCKOUTS IN TOP OR BACK OF UNIT
40.41	E1	1	WALK-IN FREEZER EVAPORATOR	208 V	1	60 Hz	-	0.00 A	5.40 A	DIRECT WIRED	DIRECT	0"	E.C. TO WIRE UNIT FROM ELECTRICAL KNOCKOUTS IN TOP OR BACK OF UNIT
40.85	E1	1	REACH-IN FREEZER	120 V	1	60 Hz	1/2	20.00 A	7.80 A	PLUG & CORD	NEMA 5-20P	24"	-
50.21	E1	2	MICROWAVE	230 V	1	60 Hz	-	20.00 A	14.90 A	DIRECT WIRED	NEMA 6-20P	0"	CONNECTS INTO RECEPTACLE IN MODULE A
51.19	E1	2	MULTI-PRODUCT HOLDING UNIT	208 V	1	60 Hz	-	20.00 A	16.00 A	PLUG & CORD	NEMA 6-20P	0"	CONNECTS INTO RECEPTACLES ON PREP MODULE A & C
51.20	E1	1	MULTI-PRODUCT HOLDING UNIT	208 V	1	60 Hz	-	20.00 A	12.00 A	PLUG & CORD	NEMA 6-15P	60"	-
53.55	E1	2	REACH-IN UNDERCOUNTER REFRIGERATOR - FIELD REVERSIBLE DOOR	115 V	1	60 Hz	1/5	20.00 A	3.30 A	PLUG & CORD	NEMA 5-15P	24"	-
55.02	E1	2	RAPID VERTICAL TOASTER	208 V	1	60 Hz	-	20.00 A	15.80 A	PLUG & CORD	NEMA L6-30P	0"	CONNECT INTO RECEPTACLE ON PREP MODULE "B"
59.51	E1	1	EGG COOKER	208 V	1	60 Hz	-	20.00 A	11.40 A	PLUG & CORD	NEMA L6-20P	0"	CONNECTS INTO RECEPTACLE ON PREP MODULE "D"
910.01	E1	1	ICE/SODA DISPENSER	115 V	1	60 Hz	-	20.00 A	6.00 A	PLUG & CORD	NEMA 5-20P	24"	VERIFY AND REWORK ALL EXISTING UTILITIES AS REQUIRED
910.81	E1	3	CARBONATOR	120 V	1	60 Hz	1/3	20.00 A	6.20 A	PLUG & CORD	NEMA 5-20P	78"	VERIFY AND REWORK ALL EXISTING UTILITIES AS REQUIRED
911.03	E1	1	ICE/SODA DISPENSER	115 V	1	60 Hz	-	20.00 A	5.00 A	PLUG & CORD	NEMA 5-20P	48"	VERIFY AND REWORK ALL EXISTING UTILITIES AS REQUIRED
931.91	E1	1	SHORTENING DISPOSAL CADDY SYSTEM	120 V	1	60 Hz	1/3	20.00 A	20.00 A	PLUG & CORD	NEMA 5-20	90"	VERIFY AND REWORK ALL EXISTING UTILITIES AS REQUIRED

				KES	S PLUMBII	NG POT	ABLE WA	ATER SCH	EDULE			
ITEM#	Tag #	QTY.	DESCRIPTION	CW SIZE	CW RI HGHT	HW SIZE	HW RI HGHT	FW TYPE	FW SIZE	FW RI HGHT	POT. WATER CONN TYPE	POT. WATER REMARKS
4.53	P1	1	DROP-IN-SINK	1/2"	18"	1/2"	18"				VIA SHUT OFF VALVE ON WALL	-
15.69	P1	1	FROZEN BEVERAGE DISPENSER					FILTER	3/8"	36"	MALE FLARE	P.C. TO RUN WATER THRU WATER FILTER AND SODA LINE
16.21	P1	1	ICE MACHINE					SCALE INHIBITOR	1/2"	48"	OD	P.C. TO RUN WATER THRU WATER FILTER
17.56	P1	1	INFUSION TEA COFFEE BREWER					FILTERED	1/4"	48"	MALE BARB	P.C. TO RUN WATER THRU WATER FILTER
60.01	P1	1	3 COMPARTMENT SINK	1/2"	12"	1/2"	12"				VIA SHUT OFF VALVE ON WALL	VERIFY REQ'MTS W/LOCAL CODES
61.01	P1	1	ONE COMPARTMENT SINK W/ LH DRAINBOARD	1/2"	12"	1/2"	12"				VIA SHUT OFF VALVE ON WALL	VERIFY REQ'MTS W/LOCAL CODES
62.05	P1	1	HANDS-FREE WASH STATION SINK	1/2"	12"	1/2"	12"				VIA SHUT OFF VALVE ON WALL	-
73.01	P1	1	WATER FILTER	1/4"	18"						FNPT	SEE DETAIL ON K4
73.11	P1	1	FILTER FEEDER SCALE INHIBITOR					FILTER	3/4"	48"	FNPT	P.C. TO RUN WATER THRU WATER FILTER AND CONNECT T Eco3ICE AS REQ'D.
910.01	P1	1	ICE/SODA DISPENSER					FILTERED	3/8"	18"	MALE BARB	VERIFY AND REWORK ALL EXISTING UTILITIES AS REQUIRE
910.81	P1	3	CARBONATOR					FILTERED	3/8"	60"	MALE FLARE	VERIFY AND REWORK ALL EXISTING UTILITIES AS REQUIRE

911.03 P1 1 ICE/SODA DISPENSER FILTERED 3/8" 18" MALE BARB VERIFY AND REWORK ALL EXISTING UTILITIES AS REQUIRED

				K	ES MECHA	NICAL SCH	EDULE				
ITEM#	TAG#	QTY.	DESCRIPTION	HOOD LENGTH	FILTER AREA	FILTER QUANTITY/SIZE	EXHAUST ACTUAL	DUCT SIZE	DUCT VELOCITY	STATIC PRESSURE	MECHANICAL REMARKS
23.45	M1	1	91" BROILER HOOD	91"	8.34 SF	(5)16X16-BK	1100 CFM	10"	2017 FPM	0.63 in-wg	FAN SPECS: 1100 CFM @ .80"SP
33.30	M1	1	67" FRYER HOOD	67"	6.67 SF	(4)1616-BK	885 CFM	10"	1623 FPM	0.49 in-wg	FAN SPECS: 885 CFM @ .80"SP

				KES P	LUMBING WAS	STE SCHEDUL	.E		
ITEM#	TAG#	QTY.	DESCRIPTION	DIRECT WASTE SIZE	DIRECT WASTE RI HGHT	INDIRECT WASTE SIZE	INDIRECT WASTE CONN HGHT	WASTE CONNECTION TYPE	WASTE REMARKS
4.53	P1	1	DROP-IN-SINK	2"	18"			DIRECT	-
16.21	P1	1	ICE MACHINE			3/4"	0"	INDIRECT	P.C. TO EXTEND DRAIN TO FLOOR SINK.
16.41	P1	1	ICE STORAGE BIN			3/4"	0"	INDIRECT	P.C. TO EXTEND DRAIN TO FLOOR SINK.
40.36	P1	1	WALK-IN COOLER EVAPORATOR			3"	3"	HUB	P.C. TO EXTEND DRAIN TO 3" HUB DRAIN
40.41	P1	1	WALK-IN FREEZER EVAPORATOR			3/4"	3"	HUB	P.C. TO EXTEND DRAIN TO 3" HUB DRAIN
60.01	P1	1	3 COMPARTMENT SINK			2"	0"	INDIRECT	VERIFY REQ'MTS W/LOCAL CODES
61.01	P1	1	ONE COMPARTMENT SINK W/ LH DRAINBOARD			2"	0"	INDIRECT	VERIFY REQ'MTS W/LOCAL CODES
62.05	P1	1	HANDS-FREE WASH STATION SINK	1 7/8"	12"			DIRECT	-
901.00	P1	1	9'-8" ROC MAIN BEVERAGE STATION			1"	0"	INDIRECT	VERIFY AND REWORK ALL EXISTING UTILITIES AS REQUIRED
910.01	P1	1	ICE/SODA DISPENSER			3/4"	0"	INDIRECT	VERIFY AND REWORK ALL EXISTING UTILITIES AS REQUIRED
911.03	P1	1	ICE/SODA DISPENSER			3/4"	0"	INDIRECT	VERIFY AND REWORK ALL EXISTING UTILITIES AS REQUIRED
931.91	P1	1	SHORTENING DISPOSAL CADDY SYSTEM	2 1/2"	60"			MNPT	VERIFY AND REWORK ALL EXISTING UTILITIES AS REQUIRED

				KE	S PLUMBIN	IG GAS SCH	EDULE			
ITEM#	TAG#	QTY.	DESCRIPTION	GAS INPUT	GAS SIZE	GAS TYPE	CO2 SIZE	CO2 RI HGHT	CO2 CONN TYPE	GAS REMARKS
15.69	P1	1	FROZEN BEVERAGE DISPENSER				1/4"	36"	MALE FLARE	-
24.07	P1	1	BROILER	110000.0 Btu/h	3/4"	N.G.				P.C. TO CONNECT TO GAS PIPING ON HOOD'S CHASE TO BROILER, AS REQ'D
31.16	P1	1	3 - BANK FRYER	280000.0 Btu/h	1"	N.G.				P.C. TO CONNECT TO GAS PIPING ON HOOD'S RACEWAY AND TO FRYERS AS REQ'D.
910.81	P1	3	CARBONATOR				1/4"	60"	MALE FLARE	

			KES PLUMB	ING MISCELLANEOUS SCHEDULE	
ITEM#	TAG#	QTY.	DESCRIPTION	MISC PLUMBING	MISC PLUMBING REMARKS
15.69	P1	1	FROZEN BEVERAGE DISPENSER	2 (1/4")	2 MALE FLARE LINES FOR SYRUP
15.83	P1	1	FROZEN BEVERAGE DISPENSER CART	-	NOT SHOWN; PRE-PLUMBED, SODA SUPPLIER TO MAKE ALL CONNECTIONS AS REQ'D



FR ANKE Franke Foodservice Systems Americas, Inc.

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BURGER KING

RESTAURANT#

KES SCHEDULES OPERATOR TRIA Company, LLC

1440 S NAPPANEE ST ELKHART

STATE ZIP CODE IN 46516-1517 COUNTRY REGION USA N.AMERICA BUILDING TYPE

FREESTANDING ELECTRICAL SERVICE 208-230V/60Hz GAS SERVICE NATURAL MARKET MANAGER MYLES COUYOUMJIAN FRANKE PROJECT NUMBER 1440649

FRANKE STORE NUMBER 5038036


CREATED BY DK996 DATE ISSUED 10/25/2021


MODIFIED BY DK996 DRAWING SCALE As Noted


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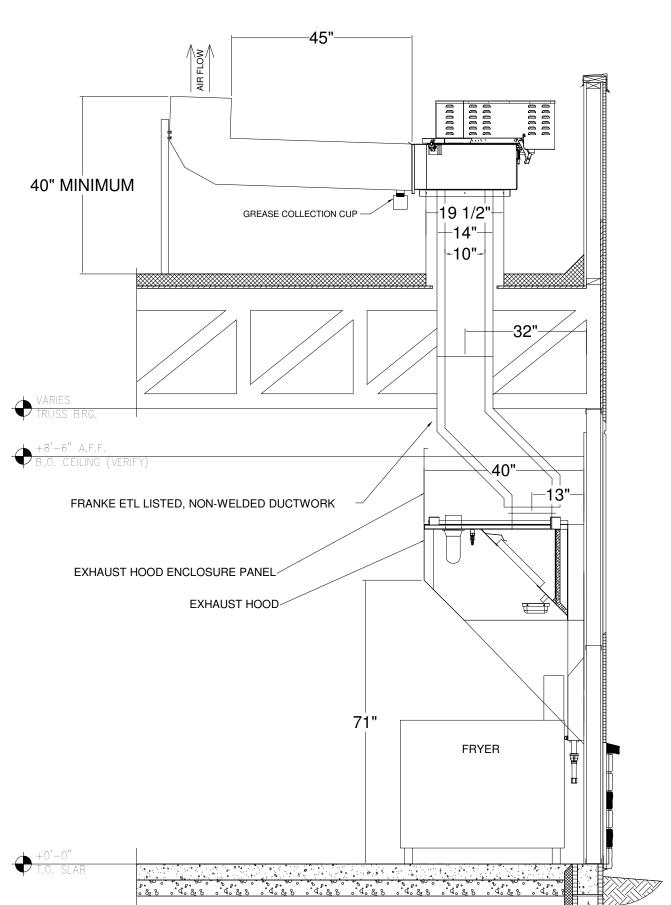
Elkhart, IN





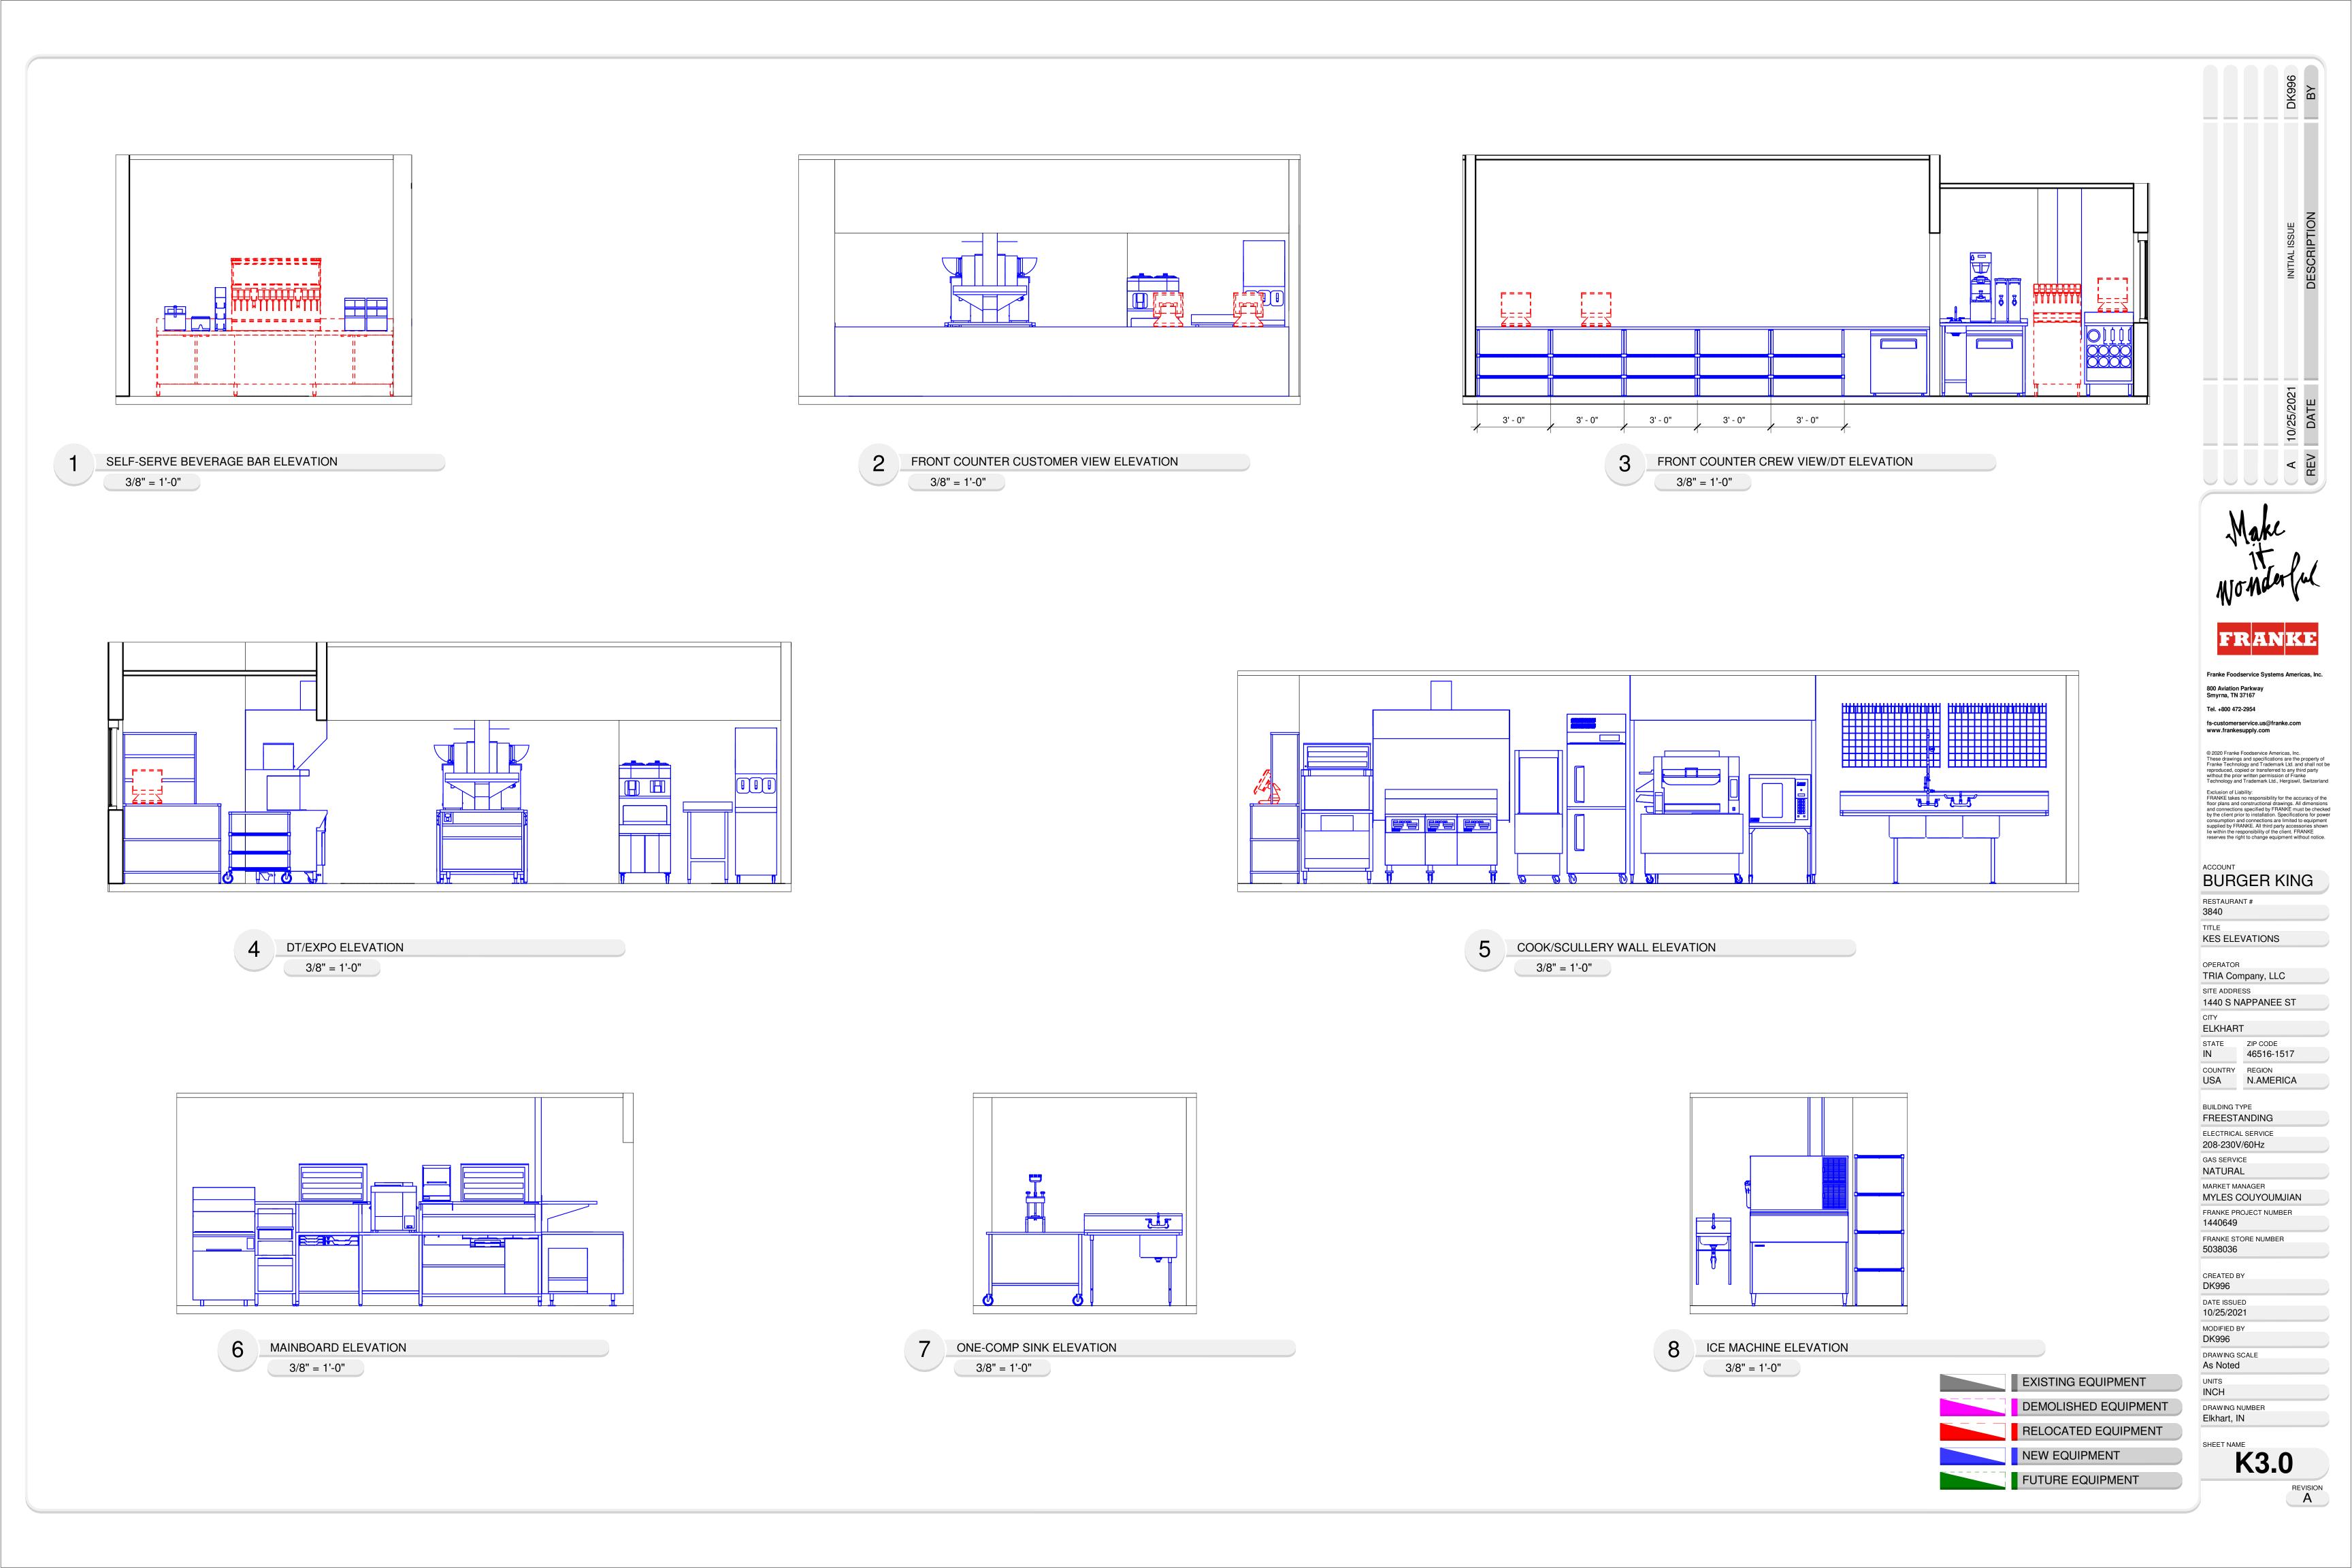

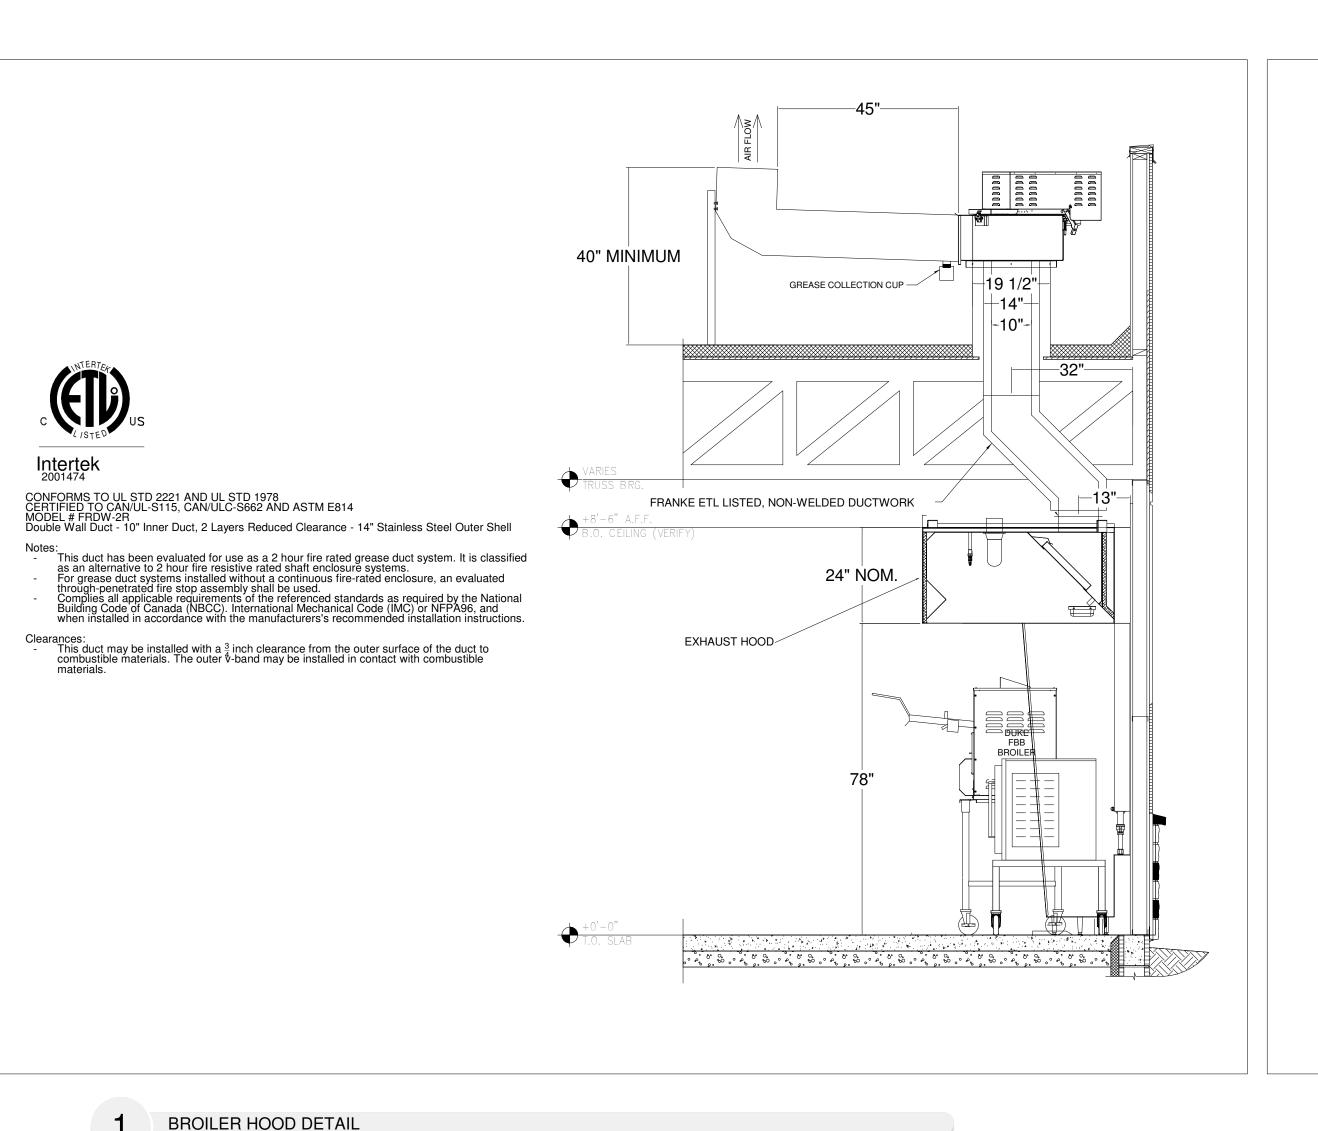

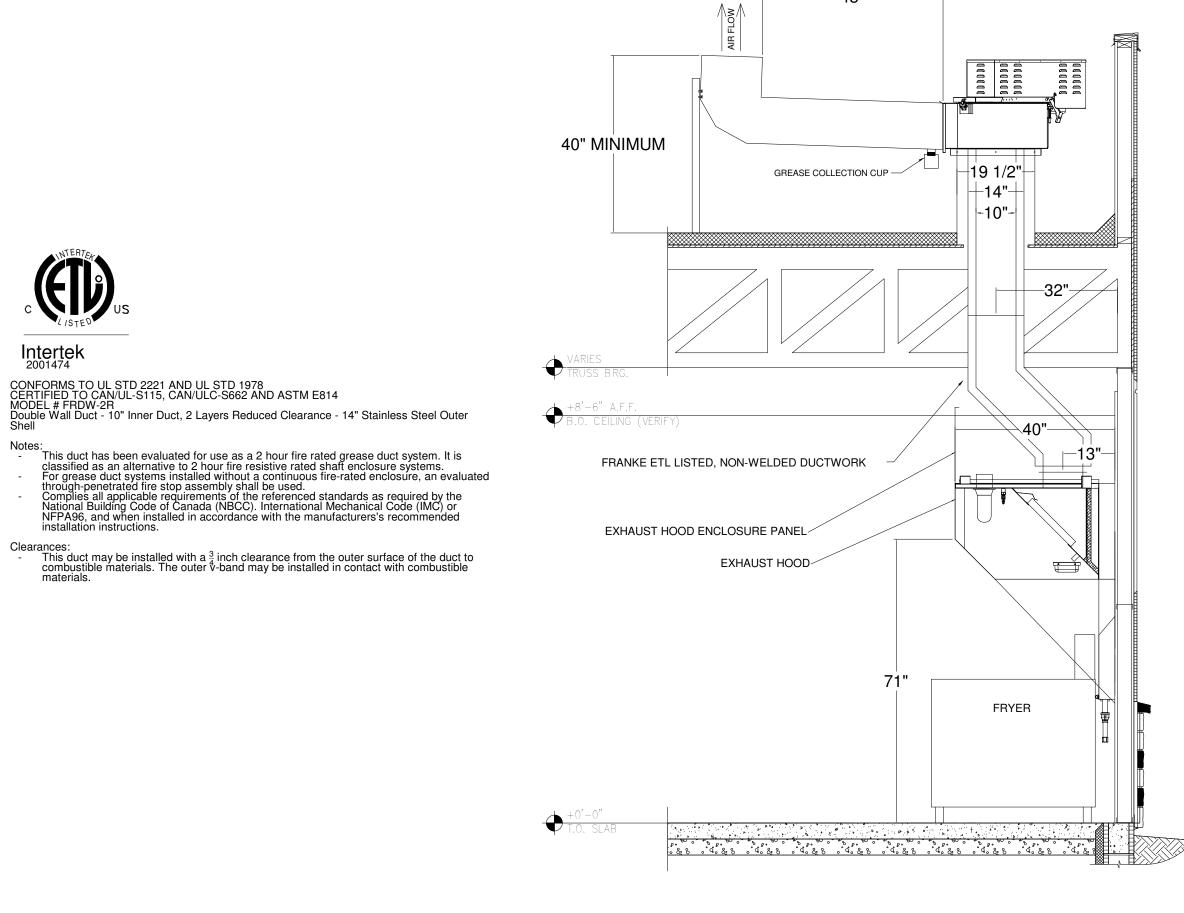

FRANKE HOOD CURB OPENING NOTE BROILER HOOD CURB OPENING LOCATION MAY DIFFERS FROM ARCHITECTURAL DRAWING. ARCHITECT MUST ENSURE THAT: A THE ROOF TRUSSES DO NOT INTERFERE WITH HOODS' CURB OPENING IN ROOF DECK B ROOF DECK HEIGHT IS BETWEEN 148" TO 151" AFF. THE LOCATION OF THE RTU AIR INTAKE IS CLEAR OF EXHAUST FANS DISCHARGE.

BEFORE CONSTRUCTION STARTS, ARCHITECT MUST ADVISE FRANKE

FOODSERVICE INC. IN WRITING IF ADJUSTMENTS ARE REQUIRED.

WOOD BACKING - FINISHED **FLOOR**

WOOD BACKING DETAIL 'B' NOT TO SCALE

CARBONATOR DETAIL - WALL BACKING BY G.C. **VERIFY W/ OWNER CARBONATORS** BOX STAND

NOT TO SCALE

CARBONATOR DETAIL

NOT TO SCALE

ICE MACHINE CONDENSING UNIT DETAIL NOT TO SCALE

WALK-IN BOX INTERIOR RAMP DETAIL NORLAKE - INDOOR BOX 19 1/2" SWEEP GASKET HEATER VIRE FLOOR PANEL THRESHOL FINISHED FLOOR MUST BE TRANSIT LEVEL AND -SMOTH

WALK-IN-BOX INTERIOR RAMP DETAIL

WATER FILTER PIPING SCHEMATIC **EVERPURE CB20-312** LINE PROVIDED 910.01 3/4" CW CONNECTED BY P.C. TO SODA SYSTEM.
911.03 INSTALLER TO CONNECT TO BUNDLED TUBING AND BY G.C. RUN TO SODA DISPENSER THRU CHASE (1.81) NOTE: WATER WORKING PRESSURE IS 20-100 PSI 17.56 15.69 - 73.11 16.21 73.01 3/4" C.W. @ 84" AFF SEE PC. NOTE# 1

WATER FILTER EVERPURE CB20-312 DETAIL

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Smyrna, TN 37167 Tel. +800 472-2954

supplied by FRANKE. All third party accessories shown lie within the responsibility of the client. FRANKE reserves the right to change equipment without notice.

ACCOUNT **BURGER KING**

RESTAURANT# KES NOTES AND DETAILS

OPERATOR TRIA Company, LLC 1440 S NAPPANEE ST

ELKHART STATE ZIP CODE 46516-1517 COUNTRY REGION N.AMERICA USA

BUILDING TYPE FREESTANDING ELECTRICAL SERVICE 208-230V/60Hz GAS SERVICE NATURAL MARKET MANAGER MYLES COUYOUMJIAN

FRANKE PROJECT NUMBER 1440649 FRANKE STORE NUMBER 5038036

CREATED BY DK996 DATE ISSUED

10/25/2021 MODIFIED BY DK996 DRAWING SCALE

As Noted UNITS INCH

DRAWING NUMBER Elkhart, IN

SHEET NAME K4.0

SET IN PLACE BY GC.

HOSHIZAKI URC-14F

- (JB) EC. TO PROVIDE DISCONNET & INTERWIRE CONDENSING UNIT & ICE MAKING HEAD AS REQUIRED.

ICE MACHINE CONDENSING UNIT DETAIL

2" W FOR ----CONDENSATE 2" PVC PIPE ----FOR REF. LINES 1"Ø ELEC. CONDUIT STU THRU ROOF INSTALLED BY GC. CAP STUB DOWN TO 18" ABOVE FIN.


PITCH PAN DETAIL

NOT TO SCALE

FRYER HOOD DETAIL

NOT TO SCALE

NOT TO SCALE

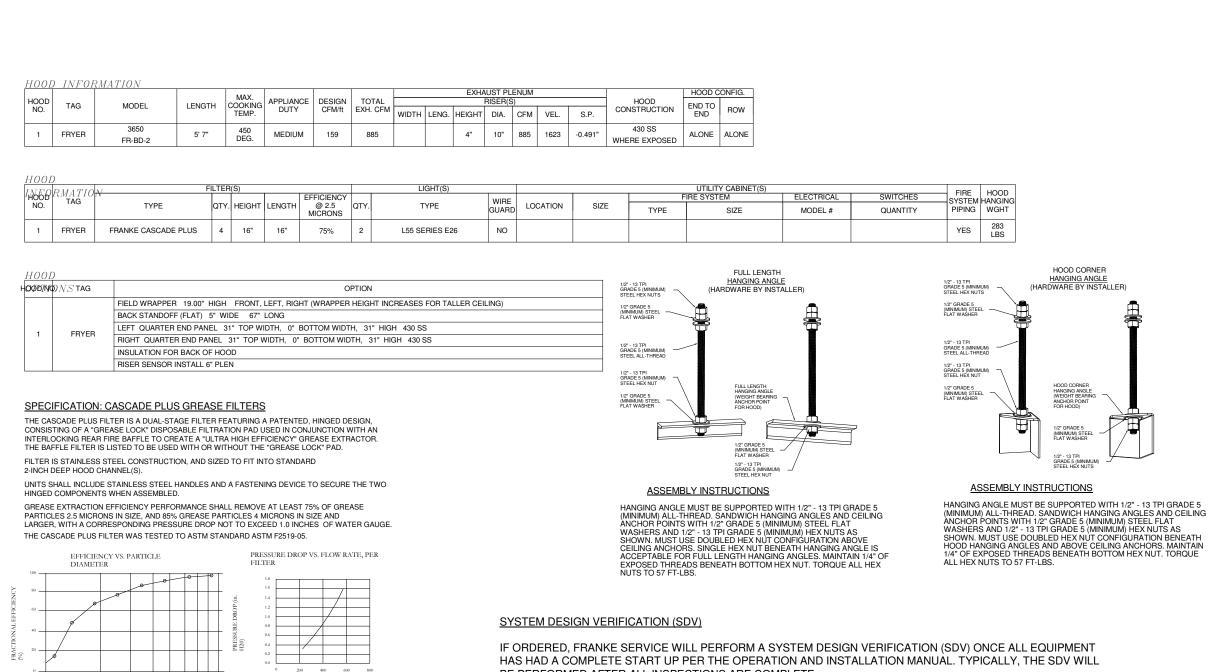



SYSTEM DESIGN VERIFICATION (SDV)

IF ORDERED, FRANKE SERVICE WILL PERFORM A SYSTEM DESIGN VERIFICATION (SDV) ONCE ALL EQUIPMENT HAS HAD A COMPLETE START UP PER THE OPERATION AND INSTALLATION MANUAL. TYPICALLY, THE SDV WILL BE PERFORMED AFTER ALL INSPECTIONS ARE COMPLETE.


ANY FIELD RELATED DISCREPANCIES THAT ARE DISCOVERED DURING THE SDV WILL BE BROUGHT TO THE ATTENTION OF THE GENERAL CONTRACTOR AND CORRESPONDING TRADES ON SITE. THESE ISSUES WILL BE DOCUMENTED AND FORWARDED TO THE APPROPRIATE SALES OFFICE. IF FRANKE SERVICE HAS TO RESOLVE A DISCREPANCY THAT IS A FIELD ISSUE, THE GENERAL CONTRACTOR WILL BE NOTIFIED AND BILLED FOR THE WORK. SHOULD A RETURN TRIP BE REQUIRED DUE TO ANY FIELD RELATED DISCREPANCY THAT CANNOT BE RESOLVED DURING THE SDV, THERE WILL BE ADDITIONAL TRIP CHARGES.

DURING THE SDV, FRANKE SERVICE WILL ADDRESS ANY DISCREPANCY THAT IS THE FAULT OF THE MANUFACTURER. SHOULD A RETURN TRIP BE REQUIRED, THE GENERAL CONTRACTOR AND APPROPRIATE SALES OFFICE WILL BE NOTIFIED. THERE WILL BE NO ADDITIONAL CHARGES FOR MANUFACTURER DISCREPANCIES.

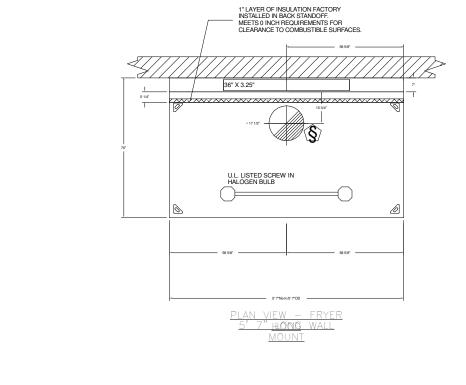

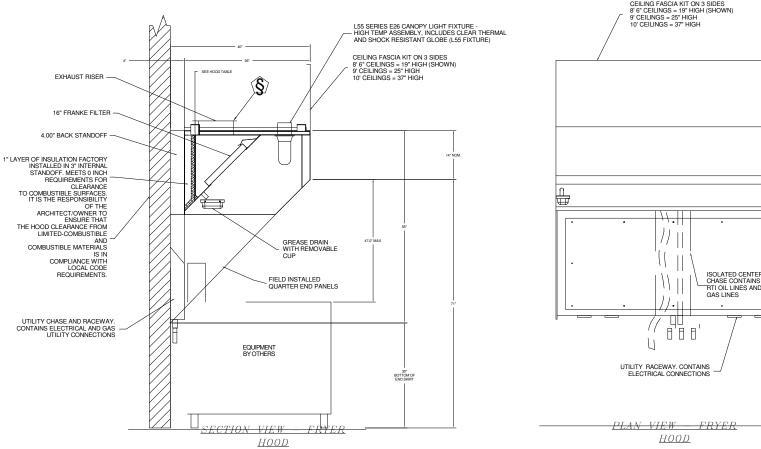

USED WHEN BOTH BROILER AND FRYER HOODS ARE ON THE SAME WALL

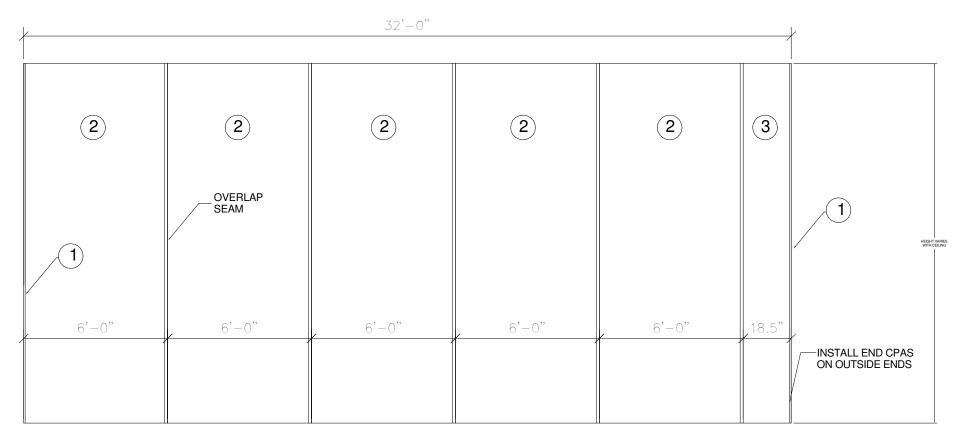

COVERS WALL BEHIND BROILER AND FRYER

ITEM	QTY	DESCRIPTION
1	2	S/S CAP STRIP
2	5	WALL FLASHING 48" WIDE
3	1	WALL FLASHING 18.5" WIDE

DuctWork #1 Parts - OFFSET DW

PARTICLE DIÀMETER

CASCADE PLUS FILTERS ARE BUILT IN COMPLIANCE WITH:.

NFPA #96
NSF STANDARD #2
UL STANDARD #1046
INT. MECH. CODE (IMC)
ULC-S649

VALUES ABOVE REFLECT FILTERS WITH CLEAN GREASE LOCK PAD INSTALLED. WHEN BAFFLE IS

USED WITHOUT GREASE LOCK PAD, EFFICIENCY AND PRESSURE IS APPROXIMATELY 25% LOWER.

WHEN GREASE LOCK PAD IS NEAR END OF LIFE, PRESSURE DROP IS APPROXIMATLEY 25% HIGHER.

Tag	Part #	CFM	SP	Weight	Velocity	QTY	Description
P1	FRDW1045DWASY-2R-S	885	-0.0438	13.60	1622.62	1	Double Wall Duct - 10" Inner 45 Duct - 2 Layers Reduced Clearance - 14" Stainless Steel Outer Shell.
P2	FRDW1027DWAJD-2R-S	885	-0.008	39.87	1622.62	1	Double Wall Adjustable Duct - 10" Inner Duct - 2 Layers Reduced Clearance - 14" Stainless Steel Outer Shell. Min Length = 11" / Max Length = 25.5" / Adjustment = 14.5" / Adjustable Section May Need To Be Cut. Includes single and double wall "V" Clamps.
P3	FRDW1045DWASY-2R-S	885	-0.0625	13.60	1622.62	1	Double Wall Duct - 10" Inner 45 Duct - 2 Layers Reduced Clearance - 14" Stainless Steel Outer Shell.
P4	FRDW1027DWAJD-2R-S	885	-0.01	39.87	1622.62	1	Double Wall Adjustable Duct - 10" Inner Duct - 2 Layers Reduced Clearance - 14" Stainless Steel Outer Shell. Min Length = 11" / Max Length = 25.5" / Adjustment = 14.5" / Adjustable Section May Need To Be Cut. Includes single and double wall "V" Clamps.
P5	FRDW1017DWLT-2R-S	885	-0.009	17.41	1622.62	1	Double Wall Duct - 10" Inner Duct, 17" long - 2 Layers Reduced Clearance - 14" Stainless Steel Outer Shell.
P6 Assembled w/P7	FRDW102150DWLTTP-2R-S	885	-0.012	22.43	1622.62	1	Double Wall Duct - 10" Inner Duct, 21.5" long - 2 Layers Reduced Clearance - 14" Stainless Steel Outer Shell - Used With Transition Plate.
P7 Assembled w/P6	FRDW1910TPDBEX	885	0	7.50	1622.62	1	Duct to Curb Transition 3/4" Down Turn, 19-1/2" Curb to 10" Duct, 16 GA Aluminized Steel. For Use With Exhaust Fans.
System at P7		885	-0.4723				
	FRDW14DWRISER-2R-S			6.45		1	Double Wall Riser Cover - Used On 10" Inner Riser, 4" long - 2 Layers Reduced Clearance - 14" Stainless Steel Outer Riser Shell Assembly. Includes Insulation & Single V Clamps For Inner & Outer Connections.
	3M-2000PLUS			0.80		2	Duct - 3M Fire Barrier 2000 Plus Silicone - Used as sealant to Seal Duct Joints.
	FRDW10DWCLASY-2R-S			5.67		1	Duct - 10" Duct - 14" Double "V" Clamp - 2R Insulation & Single "V" Clamp Included - Reduced Clearance.
Total Weight				168.00			

DuctWork #2 Parts - OFFSET EXT DW

Tag	Part #	CFM	SP	Weight	Velocity	QTY	Description
P1	FRDW1045DWASY-2R-S	1100	-0.0665	13.60	2016.81	1	Double Wall Duct - 10" Inner 45 Duct - 2 Layers Reduced Clearance - 14" Stainless Steel Outer Shell.
P2	FRDW1027DWAJD-2R-S	1100	-0.012	39.87	2016.81	1	Double Wall Adjustable Duct - 10" Inner Duct - 2 Layers Reduced Clearance - 14" Stainless Steel Outer Shell. Min Length - 11" / Max Length = 25.5" / Adjustment = 14.5" / Adjustable Section May Need To Be Cut. Includes single and double wall "V. Clamps.
P3	FRDW1045DWASY-2R-S	1100	-0.095	13.60	2016.81	1	Double Wall Duct - 10" Inner 45 Duct - 2 Layers Reduced Clearance - 14" Stainless Steel Outer Shell.
P4	FRDW1035DWLT-2R-S	1100	-0.0295	35.34	2016.81	1	Double Wall Duct - 10" Inner Duct, 35" long - 2 Layers Reduced Clearance - 14" Stainless Steel Outer Shell.
P5	FRDW1047DWAJD-2R-S	1100	-0.0265	72.54	2016.81	1	Double Wall Adjustable Duct - 10" Inner Duct - 2 Layers Reduced Clearance - 14" Stainless Steel Outer Shell. Min Length 11" / Max Length = 49.5" / Adjustment = 31.5" / Adjustable Section May Need To Be Cut. Includes single and double wall "\ Clamps.
P6 Assembled w/P7	FRDW102150DWLTTP-2R-S	1100	-0.018	22.43	2016.81	1	Double Wall Duct - 10" Inner Duct, 21.5" long - 2 Layers Reduced Clearance - 14" Stainless Steel Outer Shell - Used With Transition Plate.
P7 Assembled w/P6	FRDW1910TPDBEX	1100	0	7.50	2016.81	1	Duct to Curb Transition 3/4" Down Turn, 19-1/2" Curb to 10" Duct, 16 GA Aluminized Steel. For Use With Exhaust Fans.
System at P7		1100	-0.6665				
	FRDW14DWRISER-2R-S			6.45		1	Double Wall Riser Cover - Used On 10" Inner Riser, 4" long - 2 Layers Reduced Clearance - 14" Stainless Steel Outer Rise Shell Assembly. Includes Insulation & Single V Clamps For Inner & Outer Connections.
	3M-2000PLUS			0.80		2	Duct - 3M Fire Barrier 2000 Plus Silicone - Used as sealant to Seal Duct Joints.
	FRDW10DWCLASY-2R-S			5.67		1	Duct - 10" Duct - 14" Double "V" Clamp - 2R Insulation & Single "V" Clamp Included - Reduced Clearance.
Total Weight			İ	218.60			

CONFORMS TO UL STD 2221 AND UL STD 1978 CERTIFIED TO CAN/UL-S115, CAN/ULC-S662 AND ASTM E814 MODEL # FRDW-2R

FLOW RATE 600

Double Wall Duct - 10" Inner Duct, 2 Layers Reduced Clearance - 14" Stainless Steel Outer Shell

- This duct has been evaluated for use as a 2 hour fire rated grease duct system. It is classified as an alternative to 2 hour fire resistive rated shaft enclosure systems. For grease duct systems installed without a continuous fire-rated enclosure, an evaluated through-penetrated fire 2001474 stop assembly shall be used.

Complies all applicable requirements of the referenced standards as required by the National Building Code of Canada (NBCC). International Mechanical Code (IMC) or NFPA96, and when installed in accordance with the manufacturers's recommended installation instructions.

This duct may be installed with a $\frac{3}{4}$ inch clearance from the outer surface of the duct to combustible materials. The outer v-band may be installed in contact with combustible materials.

DOUBLE WALL FACTORY BUILT DUCTWORK


- ALL DUCTWORK IS REQUIRED TO BE INSTALLED WITH THE MAXIMUM SUPPORT SPACING LISTED BELOW. - FOR A COMPLETE LIST OF APPROVED SUPPORT METHODS, SEE THE ENTIRE INSTALLATION AND OPERATION MANUAL

- DUCTWORK SHALL SLOPE NOT LESS THAN 1/16" PER LINEAR FOOT TOWARDS THE HOOD OR AN APPROVED GREASE COLLECTION


- WHERE HORIZONTAL DUCTS EXCEED 75 FEET IN LENGTH, THE SLOPE SHALL NOT BE LESS THAN 3/16" PER LINEAR FOOT


HOR	ZONTAL		VER ⁻	ΓICAL	
DUCT DIAMETER	SUPPORT SPACING (ft)		WALL SUPPORT (ft)	CURB SUPPORT (ft)	FLOOR SUPPORT (ft)
8"	7'	TYPE			
10"	7'				
12"	7'	2R & 2R HT	20'	24'	24'
	<u> </u>	3R	10'	24'	24'
		3Z	10'	24'	24'

DUCTWORK #1 FRYER & BROILER DESIGNED FOR 14' ROOF DECK

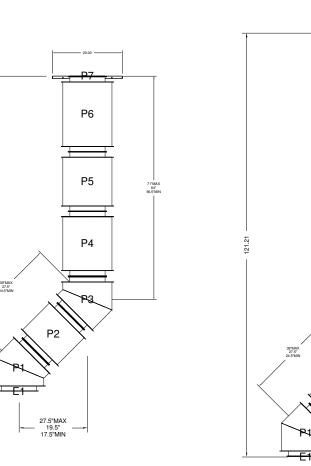

DUCTWORK #2 BROILER AND FRYER DESIGNED FOR 17' ROOF DECK

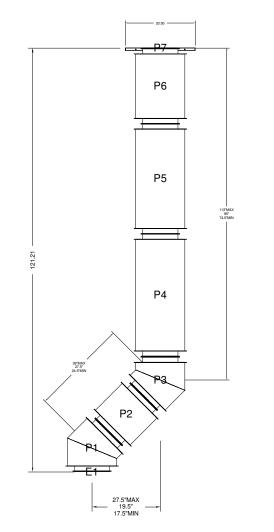

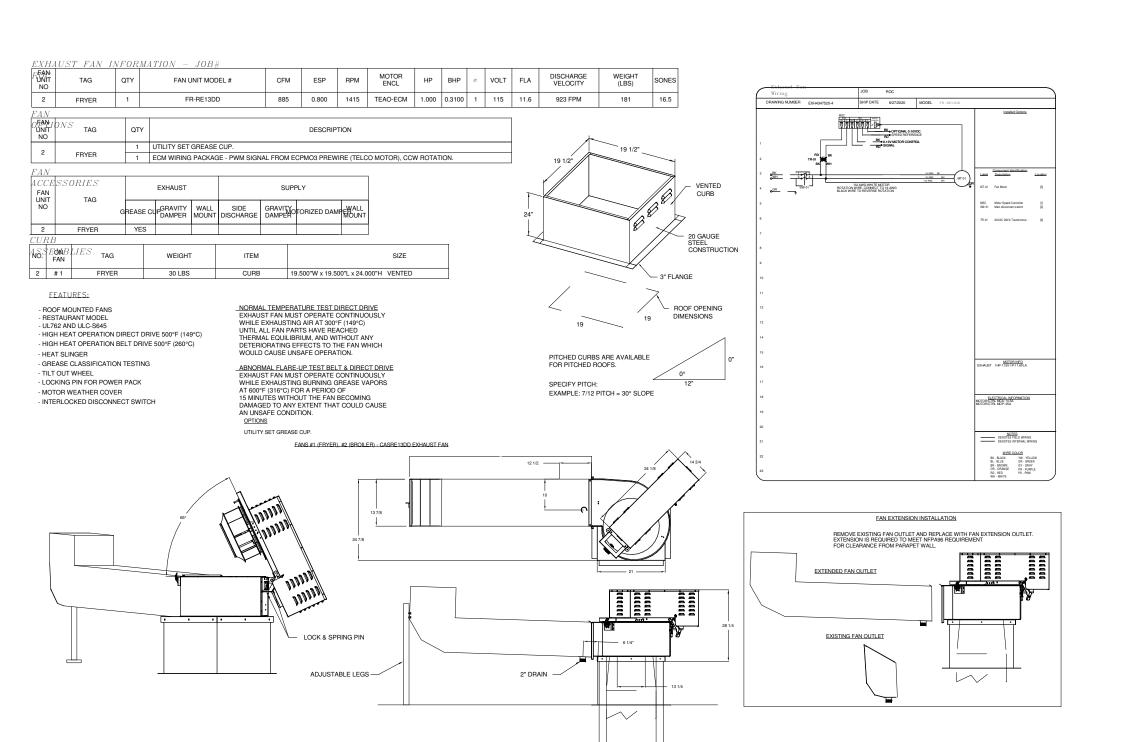

DRAWING SCALE As Noted UNITS INCH DRAWING NUMBER Elkhart, IN SHEET NAME K4.1

FRANKE

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BURGER KING

KES FRYER HOOD DETAILS

TRIA Company, LLC

1440 S NAPPANEE ST

ZIP CODE

46516-1517

N.AMERICA

Smyrna, TN 37167 Tel. +800 472-2954

ACCOUNT

3840 TITLE

OPERATOR

SITE ADDRESS

ELKHART

COUNTRY REGION

ELECTRICAL SERVICE

208-230V/60Hz

MARKET MANAGER

MYLES COUYOUMJIAN FRANKE PROJECT NUMBER

FRANKE STORE NUMBER

GAS SERVICE NATURAL

1440649

5038036

CREATED BY DK996 DATE ISSUED

10/25/2021

MODIFIED BY DK996

STATE


IN

USA

BUILDING TYPE FREESTANDING


CITY


RESTAURANT#

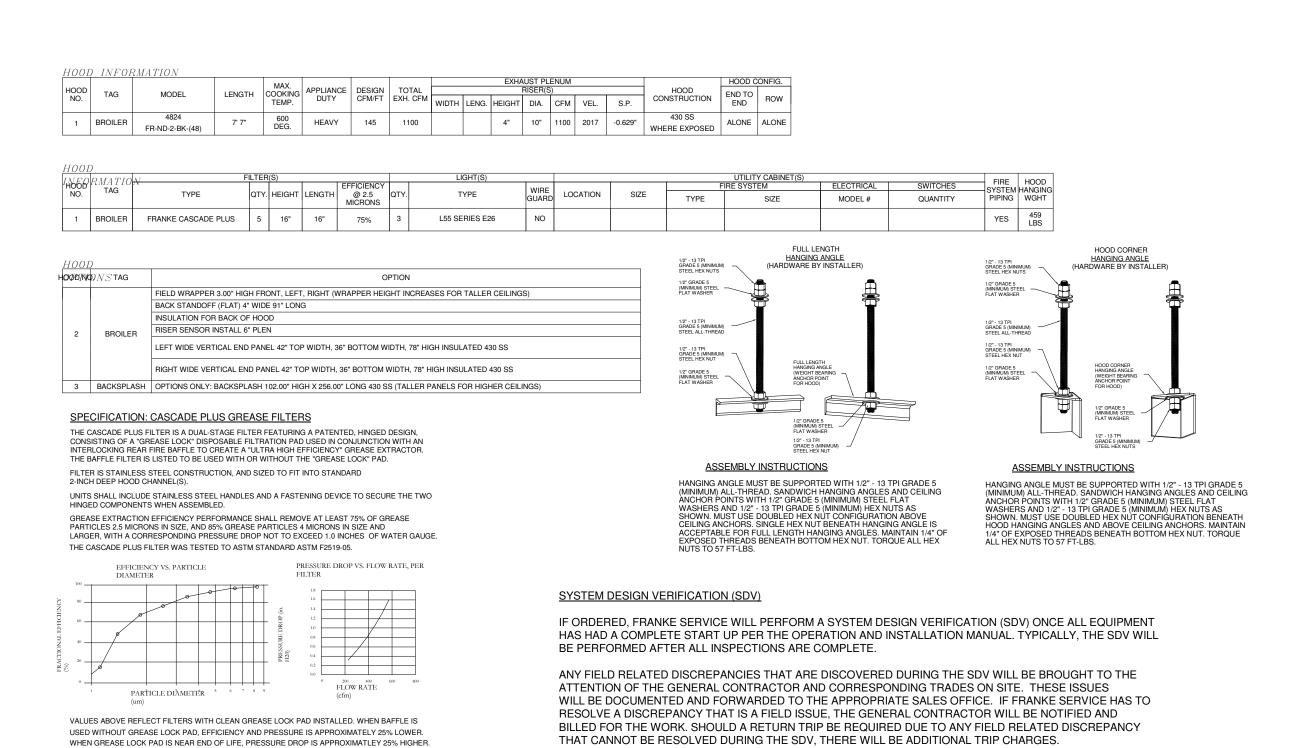



DURING THE SDV, FRANKE SERVICE WILL ADDRESS ANY DISCREPANCY THAT IS THE FAULT OF THE MANUFACTURER. SHOULD A RETURN TRIP BE REQUIRED, THE GENERAL CONTRACTOR AND APPROPRIATE SALES OFFICE WILL BE NOTIFIED. THERE WILL BE NO ADDITIONAL CHARGES FOR MANUFACTURER


CASCADE PLUS FILTERS ARE BUILT IN COMPLIANCE WITH:. NFPA #96 NSF STANDARD #2 UL STANDARD #1046 INT. MECH. CODE (IMC) ULC-S649

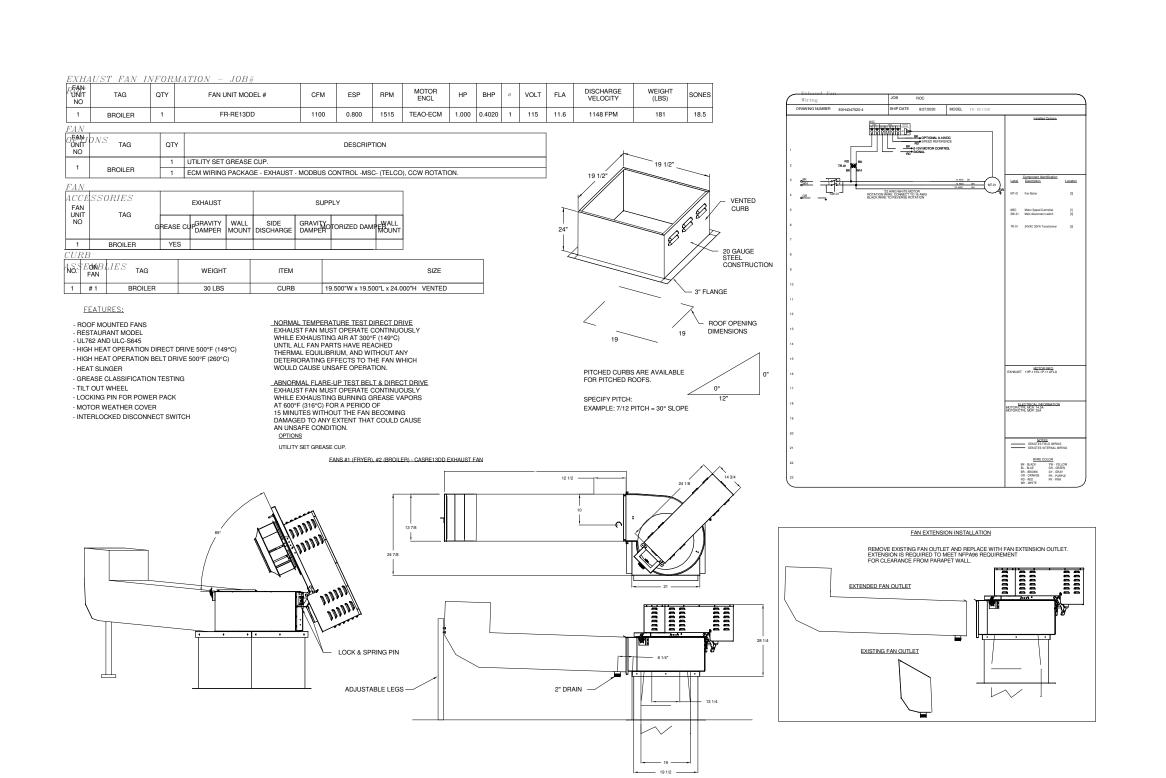

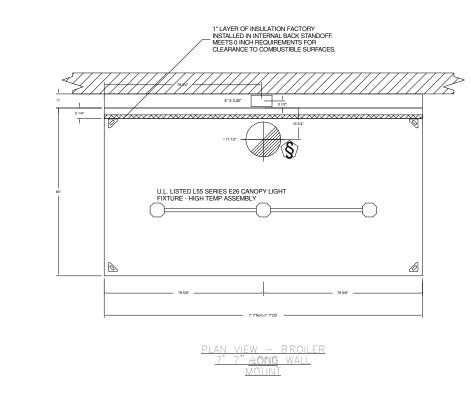

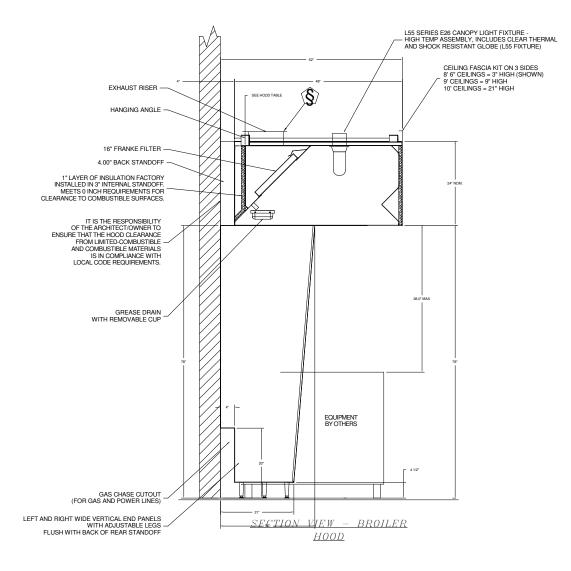

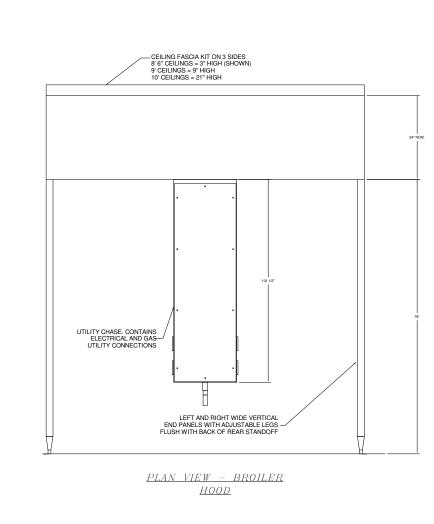

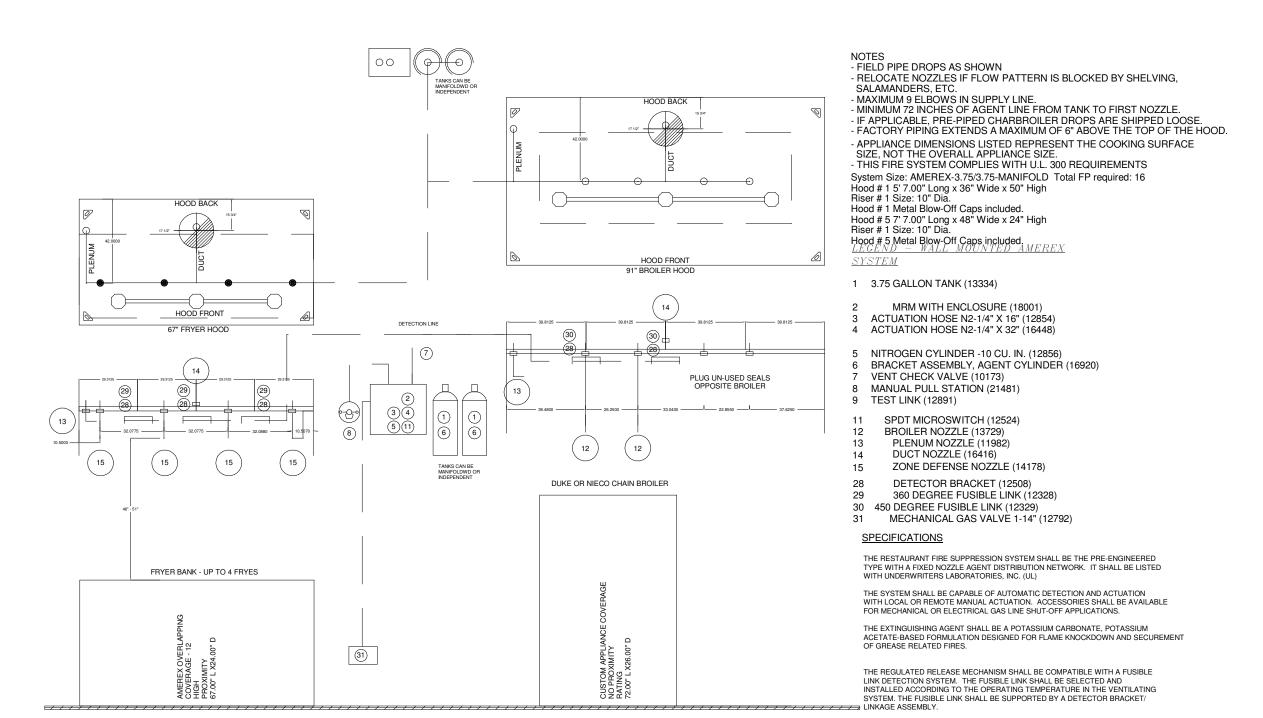



Franke Foodservice Systems Americas, Inc. 800 Aviation Parkway Smyrna, TN 37167 Tel. +800 472-2954

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supplied by FRANKE. All third party accessories shown
lie within the responsibility of the client. FRANKE
reserves the right to change equipment without notice.

BURGER KING
RESTAURANT #

3840
TITLE
KES BROILER HOOD DETAILS

OPERATOR
TRIA Company, LLC
SITE ADDRESS
1440 S NAPPANEE ST

CITY
ELKHART

STATE ZIP CODE
IN 46516-1517

N.AMERICA

BUILDING TYPE
FREESTANDING
ELECTRICAL SERVICE
208-230V/60Hz

COUNTRY REGION

USA

GAS SERVICE
NATURAL
MARKET MANAGER
MYLES COUYOUMJIAN

FRANKE PROJECT NUMBER 1440649
FRANKE STORE NUMBER 5038036

CREATED BY
DK996
DATE ISSUED


10/25/2021 MODIFIED BY DK996

DRAWING SCALE
As Noted
UNITS

DRAWING NUMBER Elkhart, IN

K4.2

REVISION

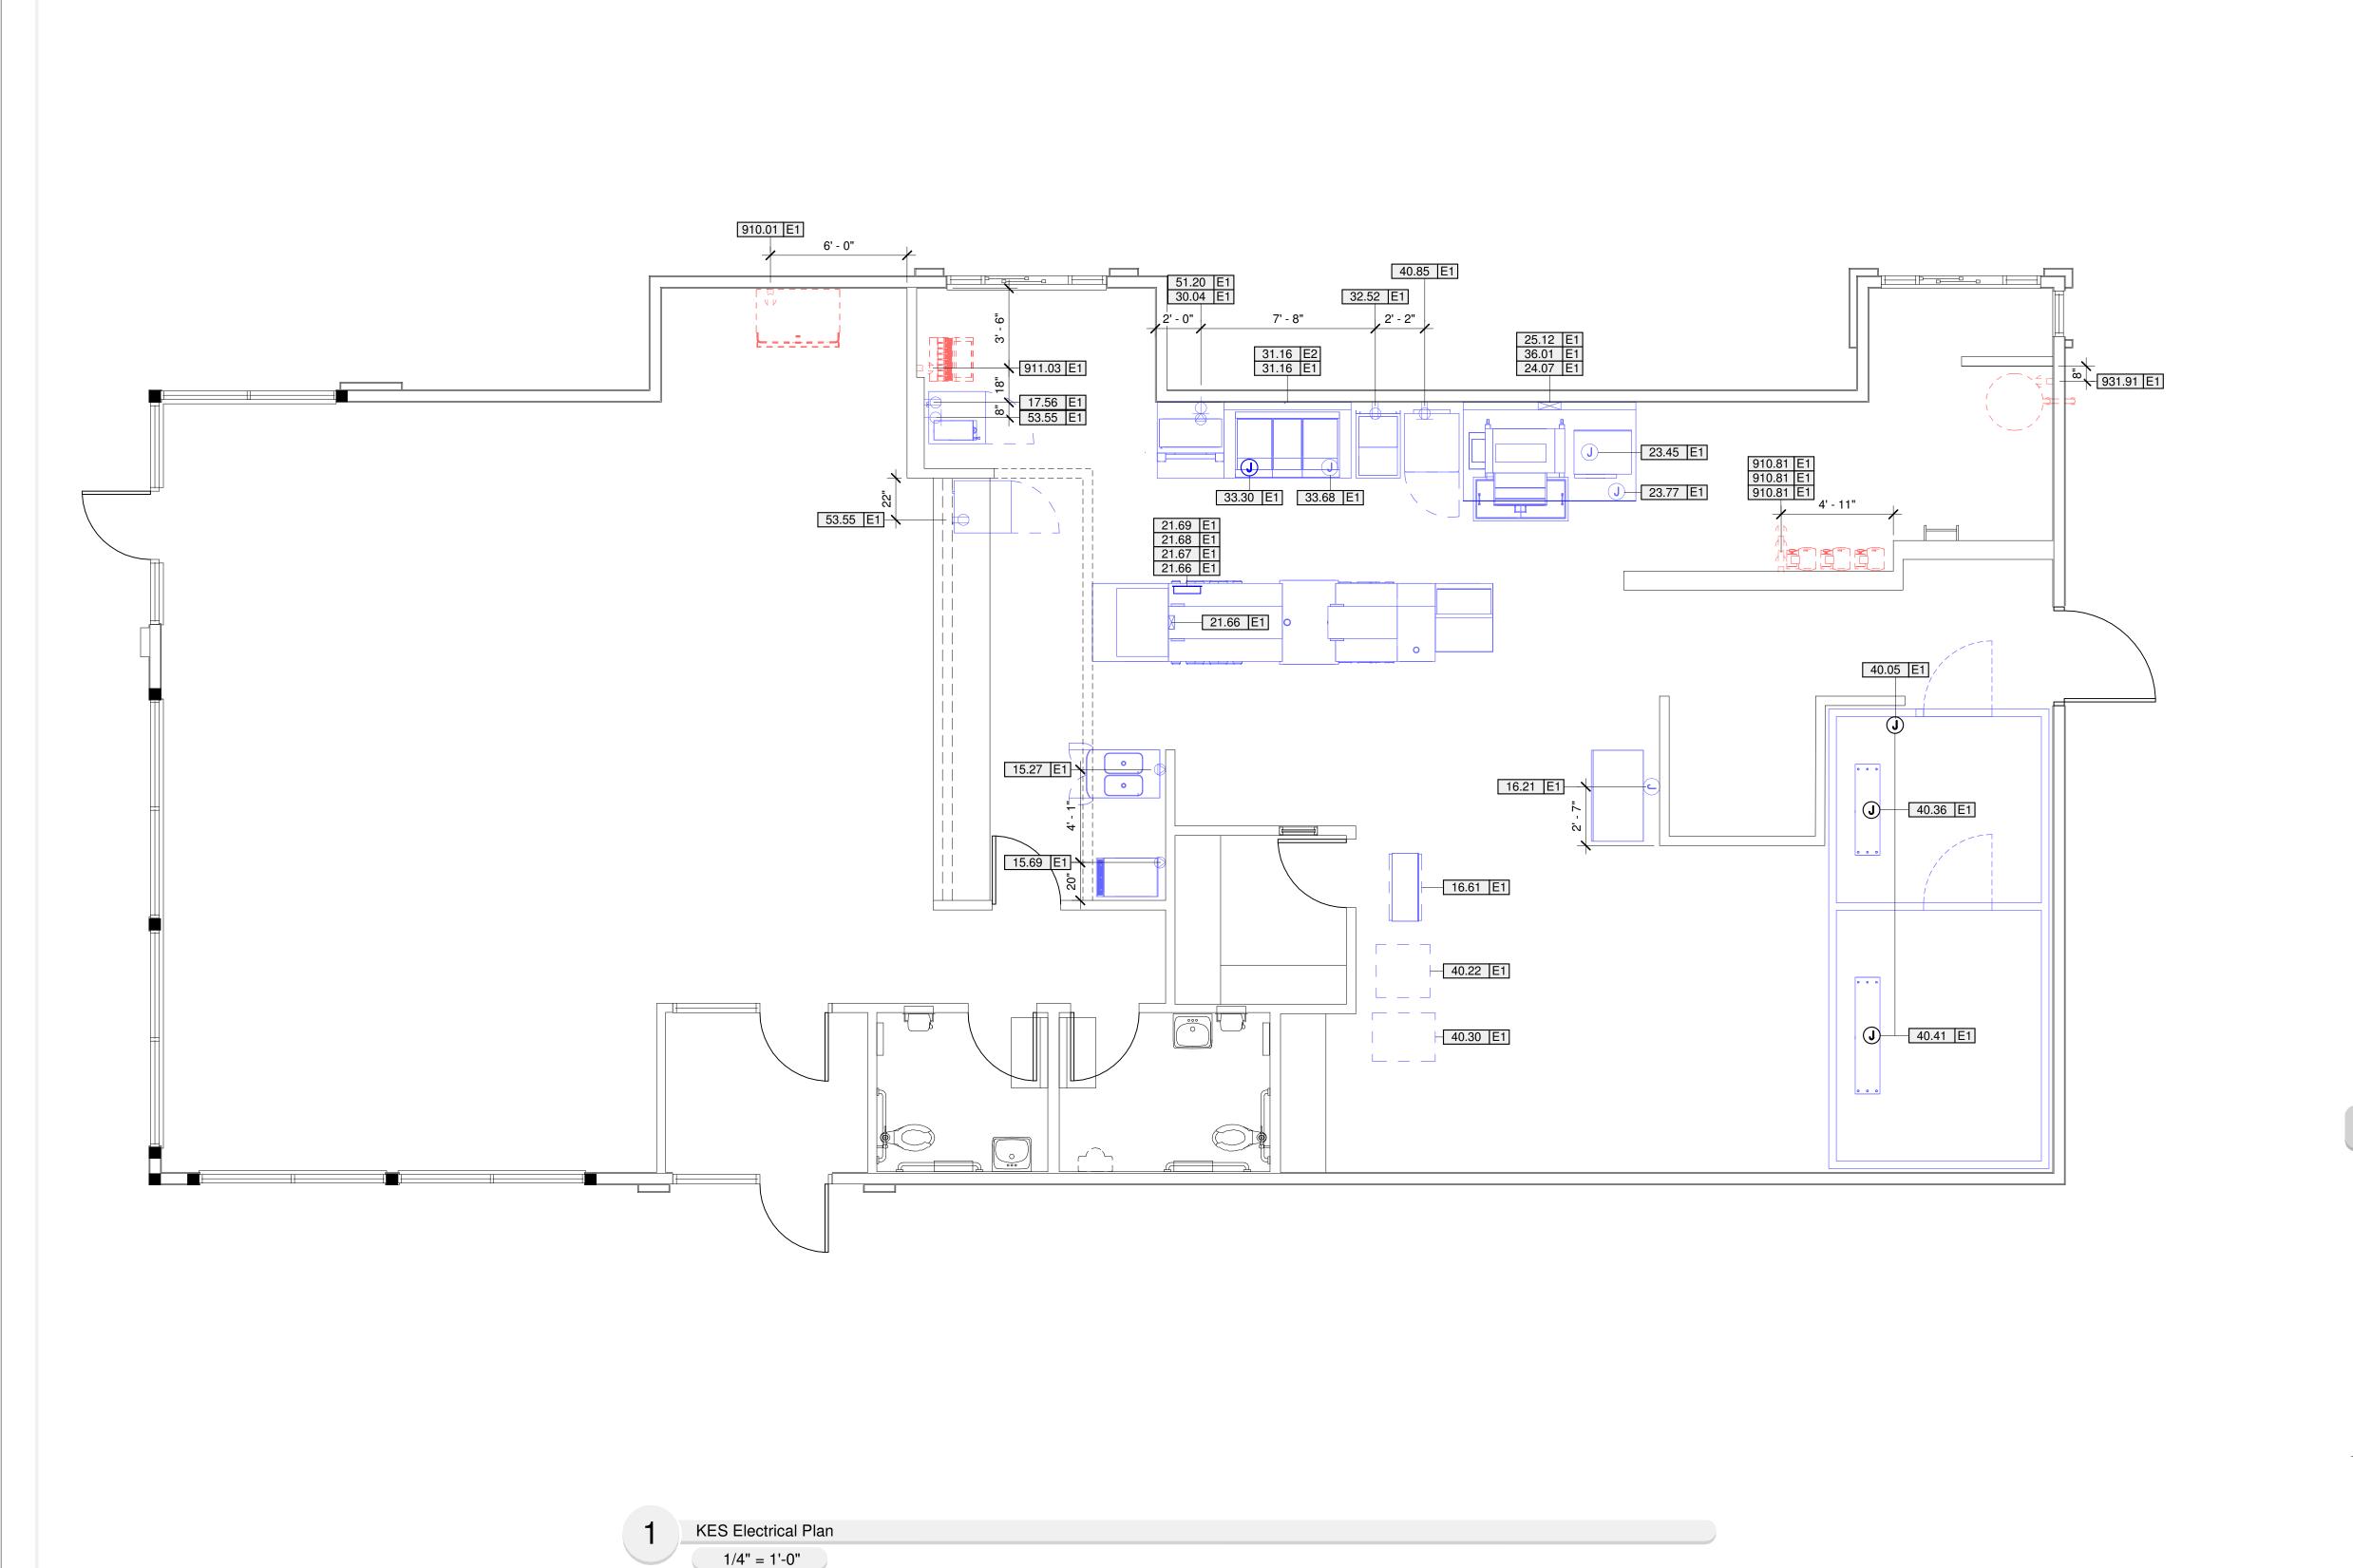

ELECTRICAL CONTRACTOR NOTES

- E.C. TO PROVIDE AND INSTALL RECEPTACLES, CAPS, AND CORDS AS REQUIRED. CAPS AND CORDS ARE TO BE INSTALLED ACCORDING TO THE MANUFACTURER'S INSTRUCTIONS AND COMPLY WITH ALL APPLICABLE
- 2 E.C. TO CONNECT ELECTRICAL SERVICE DIRECTLY TO EQUIPMENT ACCORDING TO THE MANUFACTURER'S INSTRUCTIONS. ELECTRICAL
- WHERE EQUIPMENT IS NOT PRE-WIRED, E.C. TO CONNECT THE ELECTRICAL SERVICE AND PROVIDE INTER-WIRING AS REQUIRED.

- E.C. TO VERIFY UTILITY REQUIREMENTS FOR ITEMS NOT PROVIDED BY
- NOTIFY FRANKE PROJECT MANAGER IMMEDIATELY IN WRITING IF THESE DRAWINGS ARE IN CONFLICT WITH ANY LOCAL, STATE OR NATIONAL

ABBREVIATIONS

AFC ABOVE FINISHED CEILING

AFR ABOVE FINISHED ROOF

BFC BELOW FINISHED CEILING

WIB WALK-IN BOX (COOLER/FREEZER)

SYMBOL LEGEND

SINGLE RECEPTACLE XXX.XX EQUIPMENT TAG

SPECIAL RECEPTACLE XXX.XX P1 PLUMBING ROUGH-IN TAG

XXX.XX M1 MECHANICAL ROUGH IN TAG JUNCTION BOX

CIRCUIT BREAKER PANELS WASTE DRAINS (FLOOR SINK)

HOT & COLD WATER

HOT & COLD POTABLE WATER/ DIRECT WASTE DRAIN COMBO

NEW EQUIPMENT

FUTURE EQUIPMENT

SHEET NAME **KE1.0** REVISION

FRANKE

Franke Foodservice Systems Americas, Inc

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BURGER KING

KES ELECTRICAL PLAN

TRIA Company, LLC

1440 S NAPPANEE ST

ZIP CODE 46516-1517

800 Aviation Parkway Smyrna, TN 37167

Tel. +800 472-2954

ACCOUNT

3840

OPERATOR

SITE ADDRESS

ELKHART

COUNTRY REGION

BUILDING TYPE FREESTANDING

GAS SERVICE NATURAL

1440649

5038036

CREATED BY DK996

DATE ISSUED

10/25/2021

MODIFIED BY DK996

UNITS INCH

DRAWING SCALE As Noted

DRAWING NUMBER Elkhart, IN

ELECTRICAL SERVICE 208-230V/60Hz

MARKET MANAGER

MYLES COUYOUMJIAN FRANKE PROJECT NUMBER

FRANKE STORE NUMBER

USA N.AMERICA

STATE

RESTAURANT#

CONNECTIONS SHALL COMPLY WITH ALL APPLICABLE CODES

E.C. TO RE-CONNECT ELECTRICAL CIRCUITS ON ALL PRE-WIRED EQUIPMENT DISASSEMBLED FOR SHIPMENT.

WHERE RECEPTACLES` PROVIDED WITH THE EQUIPMENT, E.C. TO EXTEND ELECTRICAL SERVICE AS REQUIRED TO PROVIDED RECEPTACLES

FRANKE KITCHEN DRAWINGS ONLY INCLUDE RECEPTACLES REQUIRED FOR SPECIFIC KITCHEN EQUIPMENT. REFER TO BUILDING FLOOR PLANS FOR THE LOCATIONS OF UTILITY AND GENERAL PURPOSE RECEPTACLES.

WALK-IN COOLER/FREEZER NOTES

E.C. TO PROVIDE AND INSTALL A HEATING ELEMENT ON THE COOLER AND FREEZER CONDENSATE DRAIN LINE.

E.C. TO CONNECT THE PRIMARY ELECTRICAL SERVICE TO THE CONDENSING UNITS, AND INTER-WIRE SERVICE TO THE EVAPORATOR COIL(S), CONTROLS, LIGHT FIXTURES AND DOOR PERIMETER HEATERS.

AFF ABOVE FINISHED FLOOR

XXX.XX E1 ELECTRICAL ROUGH-IN TAG DUPLEX RECEPTACLE

COLD WATER DIRECT WASTE DRAIN (HUB)

HOT WATER WASTE DRAINS (INDIRECT & DIRECT)

EXHAUST DUCT (BOILER OR FRY HOOD)


SERVICE CHASE

EXISTING EQUIPMENT

DEMOLISHED EQUIPMENT

RELOCATED EQUIPMENT

MECHANICAL KEYNOTES			
KEY VALUE	KEYNOTE TEXT		
M1.2	CUT OUT F/ROOF CURB BY G.C. SEE DETAIL ON K4.		
M1.4	THE DIMENSIONS SHOWN ARE HOOD TOP LOCATION OF EXHAUST DUCT COLLAR. G.C. TO VERIFY LOCATION OF ROOF CURB CUT OUT ON ROOF DECK, SEE DETAIL ON PAGE K4.0		

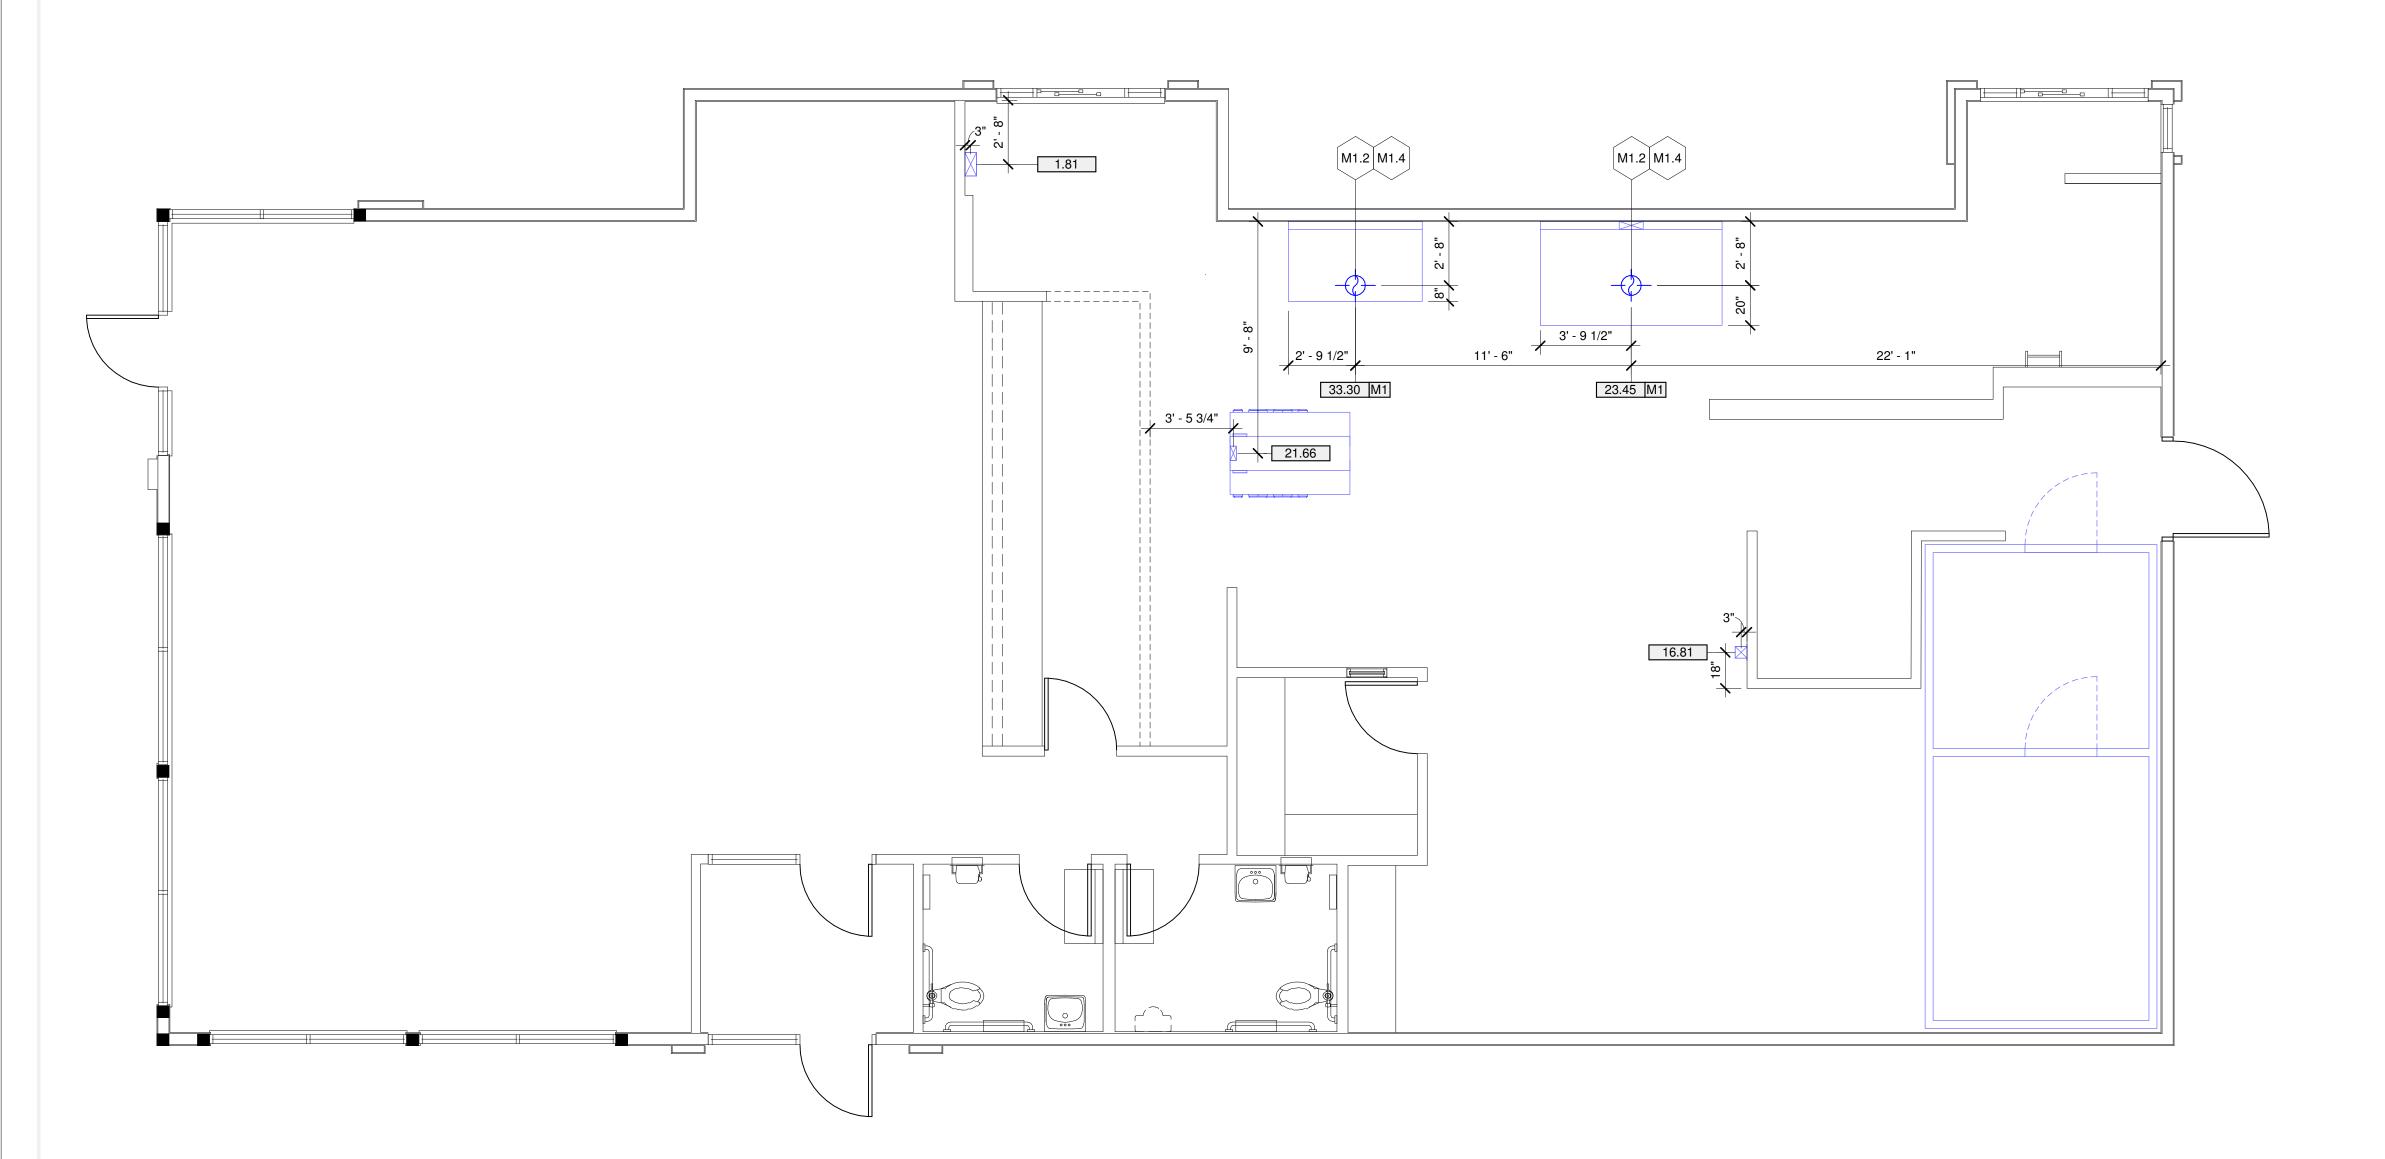

KES Mechanical Plan

1/4" = 1'-0"

1	ALL WORK SHALL BE PERFORMED BY A QUALIFIED LICENSED MECHANIC, CONTRACTOR IN ACCORDANCE WITH ALL COUNTRY, STATE AND LOCAL CODES.

ALL WORK SHALL BE COMPLETED IN A NEAT, SAFE, AND WORKMAN-LIKE

HVACR CONTRACTOR SHALL INSTALL CEILING SUSPENDED EXHAUST HOODS

HVACR CONTRACTOR SHALL INSTALL EXHAUST AND INDUCTION AIR DUCT WORK PROVIDED WITH THE EXHAUST HOOD(S). NOTE: THE EXHAUST DUCTS PROVIDED WITH THE HOODS ARE DESIGNED FOR INSTALLATION IN SINGLE STORY, STANDARD BK STRUCTURES. IN OTHER APPLICATIONS, HVACR CONTRACTOR SHALL PROVIDE AND INSTALL SUPPLEMENTAL DUCT WORK AS REQUIRED. THE PROVIDED SUPPLEMENTAL DUCT WORK SHALL MEET

6 ALL EXHAUST, MAKE-UP AND INDUCTION AIR QUANTITIES AND SPECIFICATIONS ARE AT THE DUCT COLLAR UNLESS SPECIFIED

THE FIRE SUPPRESSION SYSTEM IS TO BE INSTALLED BY AN INSTALLER CERTIFIED AND LICENSED BY THE SYSTEM MANUFACTURER. ALL SYSTEM COMPONENTS NOT INCLUDED WITH THE EXHAUST HOODS ARE TO BE PROVIDED AND INSTALLED BY THE SYSTEM INSTALLER.

PROVIDED BY FRANKE FOR THE WALK-IN COOLER/FREEZER. HVACR CONTRACTOR SHALL START UP AND ADJUST THE WALK-IN COOLER/FREEZER REFRIGERATION SYSTEM(S) AND ANY OTHER

REFRIGERATION SYSTEMS WITH REMOTE CONDENSING UNIT(S) FRANKE KITCHEN DRAWINGS INCLUDE ONLY THOSE REQUIREMENTS FOR

HVACR CONTRACTOR SHALL VERIFY THE REQUIRMENTS FOR ITEMS NOT

NOTIFY FRANKE PROJECT MANAGER IMMEDIATELY IN WRITING IF THESE

THE MAXIMUM STRAIGHT DUCT RUN FOR THE FANS SPECIFIED IS 60'-0" FROM THE TOP OF THE HOOD TO THE BOTTOM OF THE FAN (OR TOP OF THE

CFM CUBIC FEET PER MINUTE


FPM FEET PER MINUTE

SYMBOL LEGEND

\Diamond	SINGLE RECEPTACLE	XXX.XX	EQUIPMENT TAG
	DUPLEX RECEPTACLE	XXX.XX E1	ELECTRICAL ROUGH-IN TAG
\bigcirc	SPECIAL RECEPTACLE	XXX.XX P1	PLUMBING ROUGH-IN TAG
J	JUNCTION BOX	XXX.XX M1	MECHANICAL ROUGH IN TAI
	CIRCUIT BREAKER PANELS	W	/ASTE DRAINS (FLOOR SINK)
+	COLD WATER	D	IRECT WASTE DRAIN (HUB)
+	HOT WATER	→ W	/ASTE DRAINS (INDIRECT & DIRECT)

HOT & COLD POTABLE WATER/ DIRECT WASTE DRAIN COMBO

FUTURE EQUIPMENT

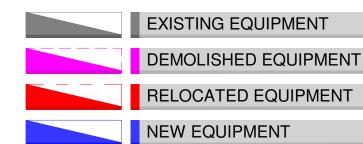

MECHANICAL CONTRACTOR NOTES

HVACR CONTRACTOR SHALL PROVIDE AND INSTALL EXHAUST FANS AND ROOF CURBS UNLESS OTHERWISE STATED IN THE EQUIPMENT SCHEDULE

ALL APPLICABLE CODES.

OTHERWISE.

HVACR CONTRACTOR TO INSTALL PRE-CHARGED REFRIGERATION LINES

THE SPECIFIC EQUIPMENT PROVIDED BY FRANKE. REFER TO OTHER BUILDING PLANS FOR LOCATIONS OF OTHER HVACR SERVICES.

DRAWINGS ARE IN CONFLICT WITH ANY LOCAL, STATE OR NATIONAL CODES

ROOF CURB), BEFORE IT IS NECESSARY TO CHANGE FAN REQUIREMENTS. IF THERE ARE ELBOWS IN THE DUCT RUN, ADD .2" SP FOR EVERY ELBOW (THIS MAY CHANGE THE REQUIREMENTS FOR THE FAN AS WELL). HVACR CONTRACTOR IS RESPONSIBLE FOR DETERMINING HVACR REQUIREMENTS

ABBREVIATIONS

EXHAUST DUCT (BOILER OR FRY HOOD) HOT & COLD WATER SERVICE CHASE

DK996 DRAWING SCALE As Noted UNITS INCH DRAWING NUMBER

FRANKE

Franke Foodservice Systems Americas, Inc

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BURGER KING

KES MECHANICAL PLAN

TRIA Company, LLC

1440 S NAPPANEE ST

46516-1517

STATE ZIP CODE

COUNTRY REGION USA N.AMERICA

BUILDING TYPE FREESTANDING ELECTRICAL SERVICE 208-230V/60Hz GAS SERVICE NATURAL

MARKET MANAGER

1440649

5038036

CREATED BY DK996

DATE ISSUED 10/25/2021

MODIFIED BY

MYLES COUYOUMJIAN FRANKE PROJECT NUMBER

FRANKE STORE NUMBER

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Tel. +800 472-2954

ACCOUNT

RESTAURANT# 3840

OPERATOR

SITE ADDRESS


CITY ELKHART

www.frankesupply.com

Elkhart, IN SHEET NAME



PLUMBING KEYNOTES			
KEY VALUE	KEYNOTE TEXT		
P1.1	P.C. TO EXTEND DRAIN TO FLOOR SINK.		
P2.2	2" DIA OUTLET PIPE STUB THROUGH WALL @ 20"-24" ABOVE GRADE. INSTALLER TO VERIFY HEIGTH AND LOCATION TO ENSURE NO OBSTRUCTIONS ON INSIDE OR OUTSIDE OF WALL. VERIFY REQ,MTS W/ OWNER.		
P3.2	HOLD HUB DRAIN TIGHT TO WALL GC TO MAKE CONNECTION THROUGH WALL. INCLUDE HUB STRAINER. GC TO VERIFY LOCATION OF HUB DRAIN WITH WIB MANUFACTURER.		
P3.3	G.C. TO PROVIDE & INSTALL 8"DIA PVC CHASE THRU WALL W/ CENTER LINE @ 14" AFF & 6" FROM INSIDE EDGE OF EXTERIOR WALL.		

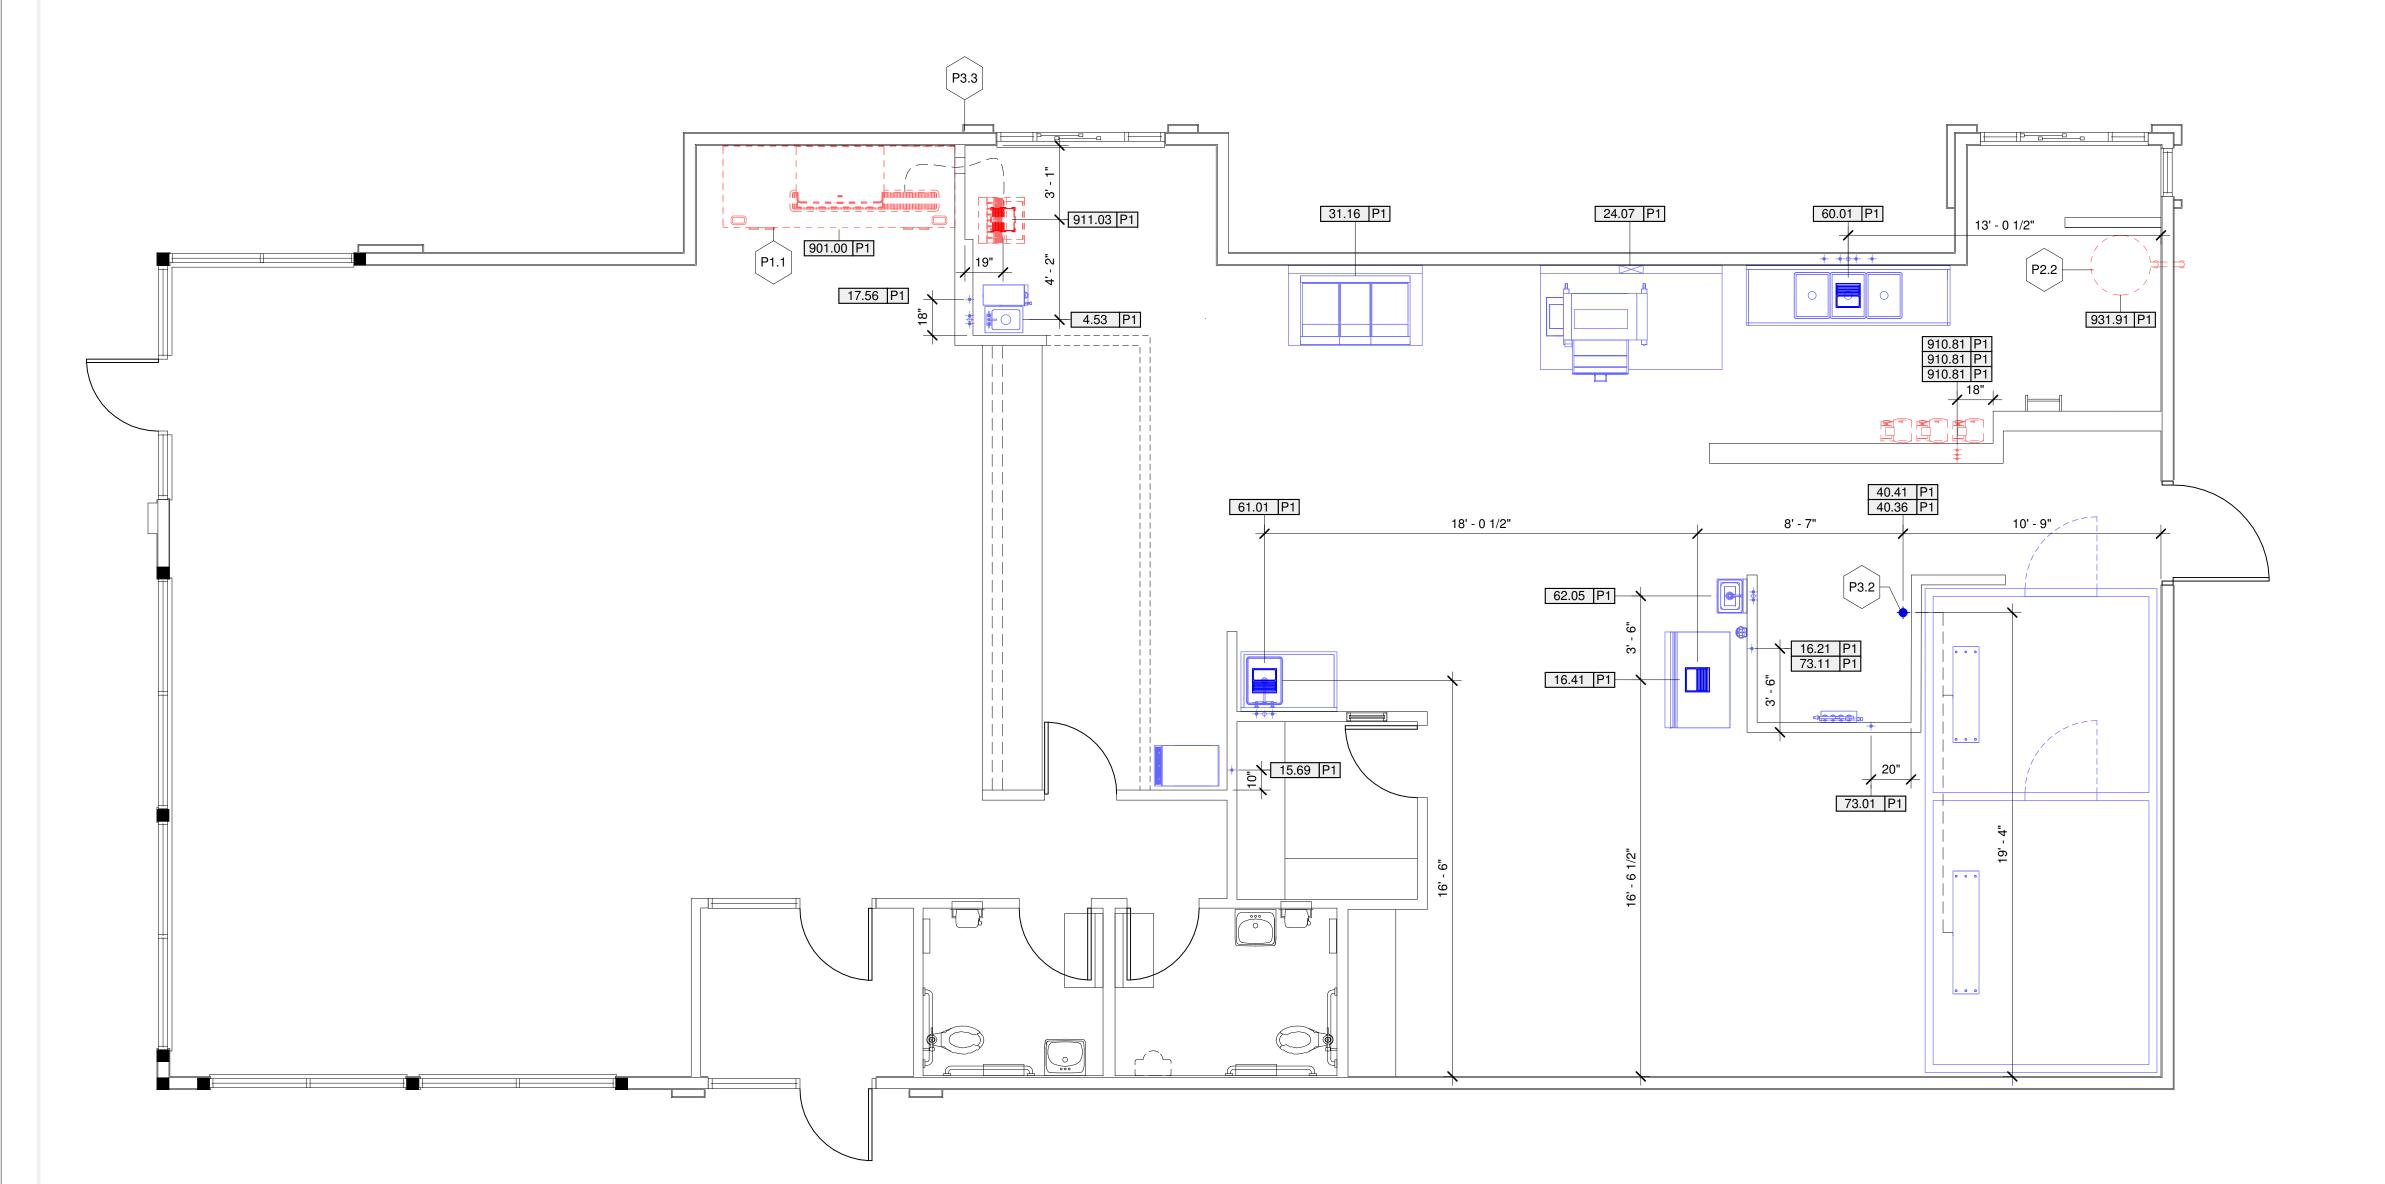

1 KES Plumbing Plan
1/4" = 1'-0"

PLUMBING CONTRACTOR NOTES

- P.C. SHALL PROVIDE AND INSTALL SHUT-OFF VALVES ON ALL POTABLE WATER AND GAS SUPPLY LINES AT EACH PIECE OF EQUIPMENT WHERE REQUIRED BY CODES. VALVES AND INSTALLATION SHALL MEET ALL APPLICABLE CODES.
- P.C. SHALL CONNECT POTABLE WATER AND GAS SERVICE DIRECTLY TO THE EQUIPMENT ACCORDING TO THE MANUFACTURER'S INSTRUCTIONS. CONNECTIONS SHALL MEET ALL APPLICABLE CODES.
- P.C. TO CONNECT EQUIPMENT TO THE BUILDING WASTE DRAINAGE SYSTEM ACCORDING TO THE MANUFACTURER'S INSTRUCTION. CONNECTIONS SHALL MEET ALL APPLICABLE CODES.
- 4 P.C. TO RECONNECT PLUMBING AND GAS PIPING ON PRE-PLUMBED
- EQUIPMENT DISASSEMBLED FOR SHIPMENT.
- WHERE EQUIPMENT IS NOT PRE-PLUMBED, P.C. SHALL CONNECT THE PLUMBING AND GAS SERVICE AND PROVIDE INTER-PIPING AS REQUIRED.

 P.C. TO INSTALL FAUCETS, DRAIN ASSEMBLIES AND ACCESSORIES
- PROVIDED WITH EQUIPMENT.

 7 WHERE A SERVICE CHASE IS PROVIDED WITH THE EQUIPMENT, THE F
- WHERE A SERVICE CHASE IS PROVIDED WITH THE EQUIPMENT, THE P.C. SHALL INSTALL THE PLUMBING AND/OR GAS SERVICE THROUGH THE SERVICE CHASE TO THE CONNECTION POINT(S) ON THE EQUIPMENT AS REQUIRED. ALL CONNECTIONS AND PIPING SHALL MEET ALL APPLICABLE CODES.
- P.C. SHALL PROVIDE AND INSTALL CONDENSATE DRAIN LINES FROM THE WALK-IN COOLER AND FREEZER EVAPORATOR COILS.
- 9 P.C. SHALL PROVIDE AND INSTALL BACK-FLOW PREVENTION DEVICES WHEN REQUIRED BY THE AUTHORITY HAVING JURISDICTION.
- P.C. SHALL PROVIDE AND INSTALL AUTOMATIC GAS SHUT-OFF VALVES WHEN REQUIRED BY THE AUTHORITY HAVING JURISDICTION.
- 1 FRANKE KITCHEN DRAWINGS INCLUDE ONLY THOSE REQUIREMENTS FOR SPECIFIC KITCHEN EQUIPMENT. REFER TO BUILDING FLOOR PLANS FOR OTHER PLUMBING REQUIREMENTS AND LOCATIONS.
- NOTIFY FRANKE PROJECT MANAGER IMMEDIATELY IN WRITING IF THESE DRAWINGS ARE IN CONFLICT WITH ANY LOCAL, STATE OR NATIONAL

ABBREVIATIONS

AFF ABOVE FINISHED FLOOR

FPM FEMALE PIPE THREAD

SYMBOL LEGEND

\Rightarrow	SINGLE RECEPTACLE	XXX.XX	EQUIPMENT TAG
	DUPLEX RECEPTACLE	XXX.XX E1	ELECTRICAL ROUGH-IN TAG
\bigcirc	SPECIAL RECEPTACLE	XXX.XX P1	PLUMBING ROUGH-IN TAG
J	JUNCTION BOX	XXX.XX M	MECHANICAL ROUGH IN TAG
	CIRCUIT BREAKER PANELS		WASTE DRAINS (FLOOR SINK)
+	COLD WATER	-	DIRECT WASTE DRAIN (HUB)
+	HOT WATER	-	WASTE DRAINS (INDIRECT & DIRECT)
	HOT & COLD WATER		EXHAUST DUCT (BOILER OR FRY HOOD)
<u></u>	HOT & COLD POTABLE WATER/ DIRECT WASTE DRAIN COMBO		SERVICE CHASE
1	040		

EXISTING EQUIPMENT

DEMOLISHED EQUIPMENT

RELOCATED EQUIPMENT

NEW EQUIPMENT

FUTURE EQUIPMENT



FR AN KE

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RESTAURANT#

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OPERATOR

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DK996
DRAWING SCALE
AS Noted

UNITS INCH

DRAWING NUMBER Elkhart, IN

